APRIL 2021 FEDERAL PROJECT STATE PROJECT STATE OF WISCONSIN CONTRACT PROJECT ORDER OF SHEETS 1020-00-79 Section No. **DEPARTMENT OF TRANSPORTATION** Section No. Typical Sections and Details Section No. Estimate of Quantities Section No. STATE HIGHWAY REHABILITATION - BRIDGE PREVENTIVE PROJECT Section No. Standard Detail Drawing NW REGION, IH94 BRIDGE DECK SEALING 020-00-79 **BRIDGE DECK SEALING (VAR) IH 94** TOTAL SHEETS = 44 ST. CROIX, DUNN, EAU CLAIRE, TREMPEALEAU, JACKSON COUNTIES STATE PROJECT NUMBER 1020-00-79 T-31-N T-30-N ST. CROIX T-29-N T-28-N DESIGN DESIGNATION AADT 2019 R-19-W R-18-W R-17-W R-16-W R-15-W A.A.D.T. D.H.V. DΩ DESIGN SPEED R-14-W R-13-W R-12-W R-11-W T-25-N JACKSON, **BEGIN PROJECT** CONVENTIONAL SYMBOLS GRADE LINE CORPORATE LIMITS ORIGINAL GROUND T-23-N PROPERTY LINE MARSH OR ROCK PROFILE **END PROJECT** LOTLINE (To be noted as such) T-22-N LIMITED HIGHWAY EASEMENT SPECIAL DITCH **JACKSON** STATE OF WISCONSIN EXISTING RIGHT OF WAY GRADE ELEVATION PROPOSED OR NEW R/W LINE DEPARTMENT OF TRANSPORTATION T-21-N SLOPE INTERCEPT CULVERT (Profile View) PREPARED BY UTILITIES REFERENCE LINE Surveyor ELECTRIC Designer EXISTING CULVERT FIBER OPTIC Project Manage PROPOSED CULVERT R-4-W R-3-W R-2-W R-1-W R-1-E SANITARY SEWER T-19-N COMBUSTIBLE FLUIDS STORM SEWER LAYOUT R-7-W PPROVED FOR THE DEPARTMENT MARSH AREA Philip S. Keppers ₫ TOTAL NET LENGTH OF CENTERLINE = Ø Ε WOODED OR SHRUB AREA TELEPHONE POLE FILE NAME: E:\PDS\C3D\10200009\SHEETSPLAN\010101_TI.DWG 12/17/2020 1:42 PM THYSSEN, NICHOLAS PA

GENERAL NOTES

- 1) THERE ARE UTILITY FACILITIES WITHIN THE PROJECT AREA THAT ARE NOT SHOWN ON THE PLANS. COORDINATE CONSTRUCTION ACTIVITIES WITH A CALL TO DIGGERS HOTLINE AND/OR A DIRECT CALL TO THE UTILITIES THAT HAVE FACILITIES IN THE AREA. NOT ALL UTILITIES ARE MEMBERS OF DIGGERS HOTLINE.
- 2) IH-94 SHALL BE KEPT OPEN TO A MINIMUM OF ONE LANE OF TRAFFIC IN EACH DIRECTION AT ALL TIMES.
- 3) THE EXACT NUMBER, LOCATION AND SPACING OF ALL SIGNS AND DEVICES SHALL BE ADJUSTED TO FIELD CONDITIONS AS DIRECTED BY THE ENGINEER.

AREA CONTACTS

WISDOT NW REGION CONTACTS

JESSE LARSON 718 W. CLAIREMONT AVE EAU CLAIRE, WI 54701 (715) 491-1470 JESSÉ.LARSON@DOT.WI.GOV

WI DNR CONTACT

LEAH NICOL DNR NORTHERN REGION HQ 1300 WEST CLAIREMONT STREET EAU CLAIRE, WI 54701 (715) 934-9014 LEAH.NICHOL@WISCONSIN.GOV

WISDOT NW REGION COUNTY CONTACTS

ST. CROIX & DUNN COUNTIES MIKE BURKE (715) 577-5395 MICHAEL.BURKE@DOT.WI.GOV

EAU CLAIRE COUNTY CHRIS MICHELS (715) 225-9318 CHRIS.MICHELS@DOT.WI.GOV

JACKSON COUNTY **ROSS KRAUSE** (715) 577-9544 ROSS.KRAUSE@DOT.WI.GOV

TREMPEALEAU County **BRENDA MCNALLAN** (715) 577-3540 BRENDA.MCNALLAN@DOT.WI.GOV


NW REGION MAINTENANCE SUPERVISOR

JEFF KERN (715) 579-0794 JEFFREY.KERN@DOT.WI.GOV

or (800)242-8511 www.DiggersHotline.com

DECK NOTES

-ENTIRE DECK SURFACE TO BE CLEANED AND SEALED. -INLET PROTECTION REQUIRED DURING CLEANING AND SEALING WORK IN THE STRUCTURES WITH FLOOR DRAINS. -USE TYPE FF FABRIC DURING CLEANING ACTIVITIES. -USE IMPERVIOUS FABRIC DURING SEALING ACTIVITIES

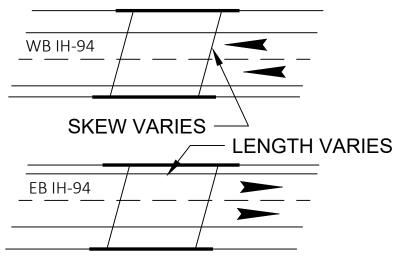

PIER COLUMN NOTES


-CLEAN AND SEAL ALL EXPOSED SURFACES OF ALL PIER COLUMNS FROM GROUND LEVEL TO 10-FOOT HEIGHT ABOVE GROUND LEVEL OR BOTTOM OF PIER CAP, WHICHEVER IS LOWER.

TYP. 12' LANE TYP. 12' LANE TYP. VARIES (6' TYP) TYP. 60' MEDIAN TYP. VARIES (6' TYP) TYP. 12' LANE TYP. 12' LANE TYP. 10' SHLDR

TYP. 10' SHLDR

PARAPET NOTES

- INSIDE FACE AND TOP TO BE CLEANED AND SEALED.
- TOP SURFACE TO BE ROLLED OR BRUSHED.
- PARAPET TYPE AND HEIGHT VARIES.
- SURFACE AREA INCLUDED IN QUANTITY SUMMARY.
- AVERAGE 2'-6" HEIGHT USED FOR QUANTITY ESTIMATE.

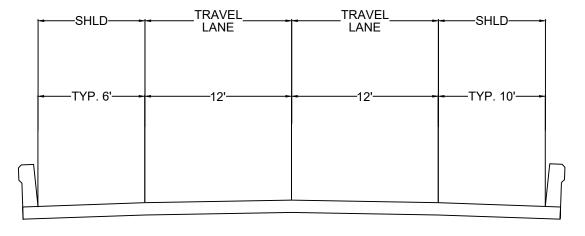

TYPICAL BRIDGE DECK CROSS SECTION

TYPICAL DECK PLAN VIEW 4 LANE DIVIDED HIGHWAY - IH 94 4 LANE DIVIDED HWY - TYPICAL IH-94

PLOT DATE :

Ε PROJECT NO: 1020-00-79 HWY: IH-94 COUNTY: NW REGION **GENERAL NOTES SHEET**

\\EAU31FP2\N3PUBLIC\PD\$\C3D\10200009\\$HEET\$PLAN\020101 GN.DW0


2/5/2021 9:29 AM

PLOT BY : PESOLA, GREGORY B

PLOT NAME


NOT TO SCALE PLOT SCALE:


WISDOT/CADDS SHEET 42

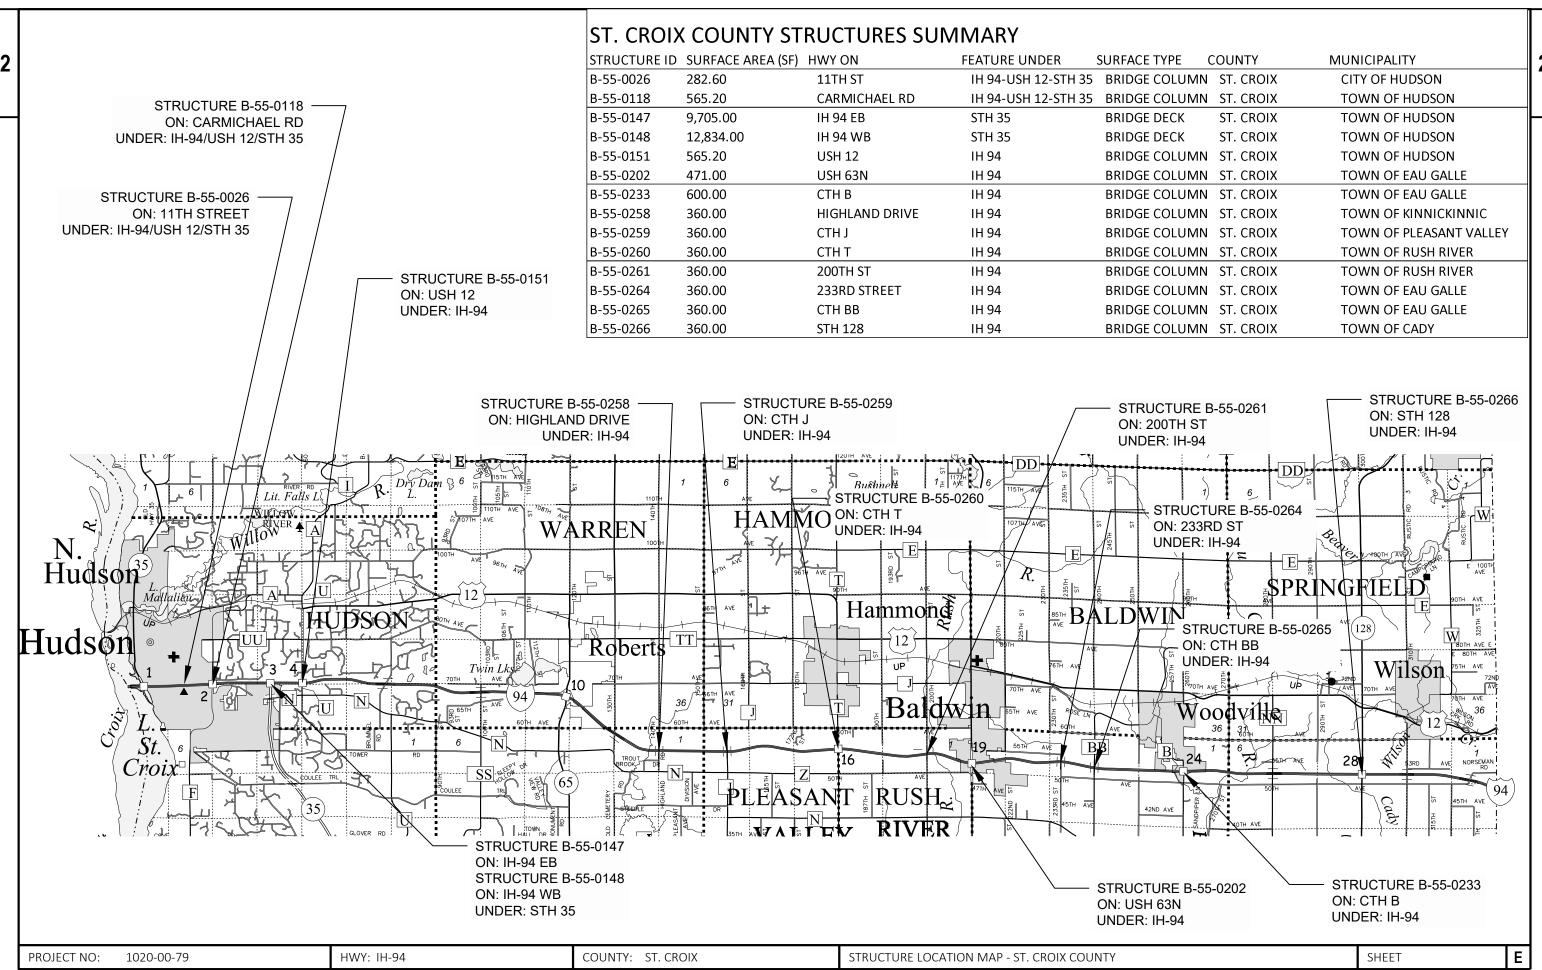


E NAME : C:\USERS\DOTAXJ\DOCUMENTS\7040-00-00,70\020101_GN.DWG PLOT BY : JENSCH, AHREN PLOT NAME : PLOT NAME : NOT TO SCALE WISDOT/CADDS SHEET 42

LAYOUT NAME - 02

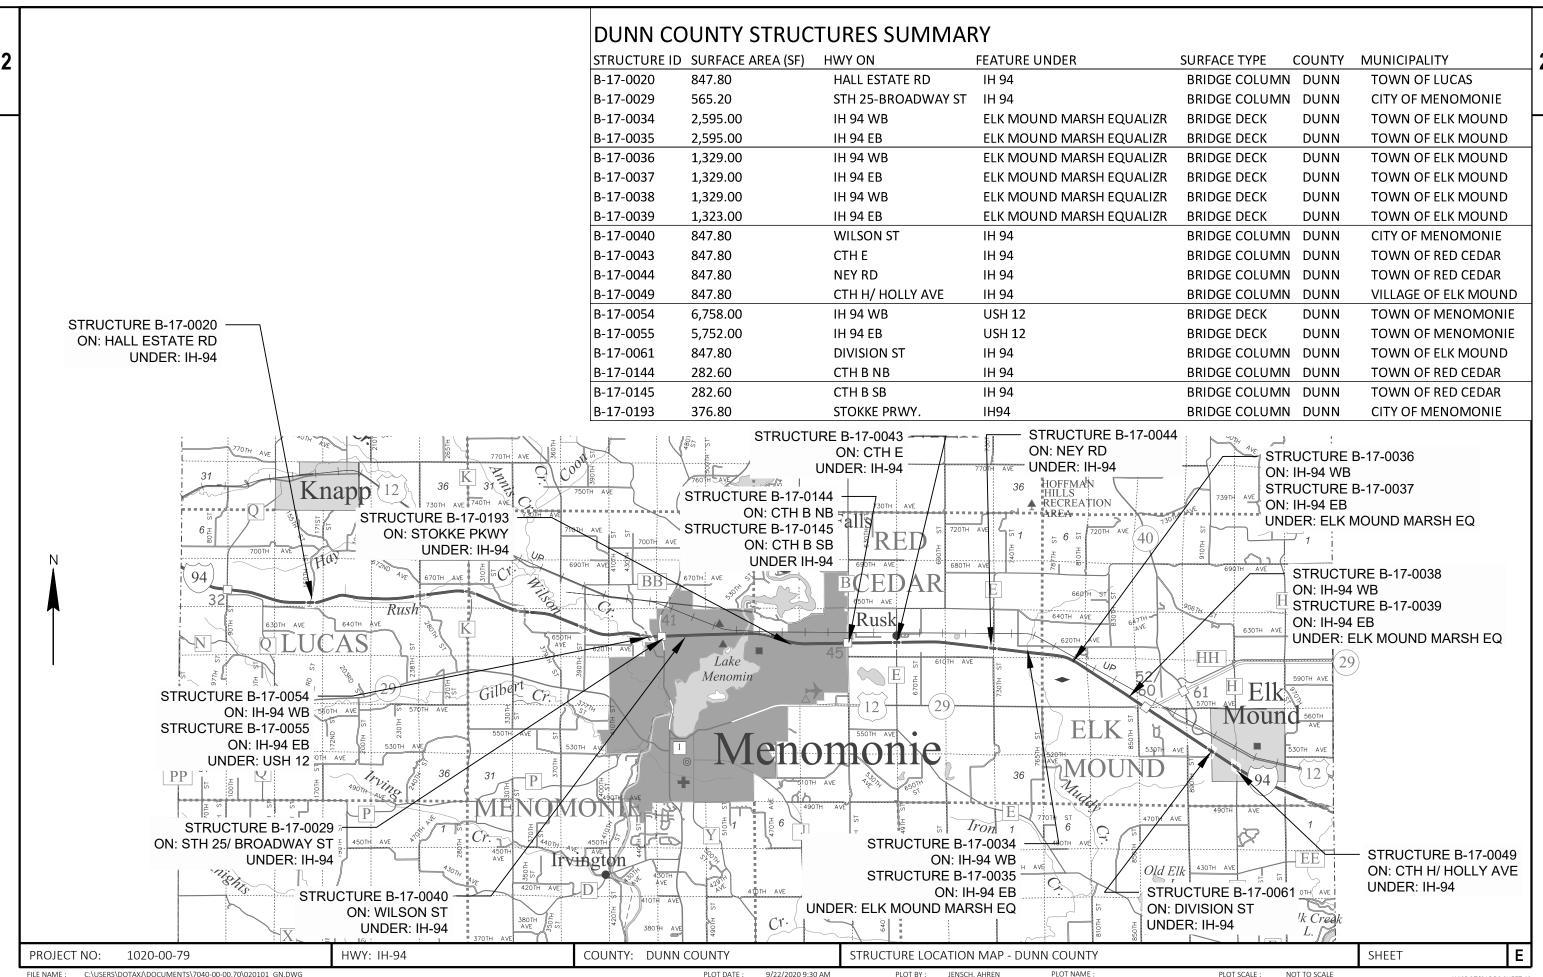


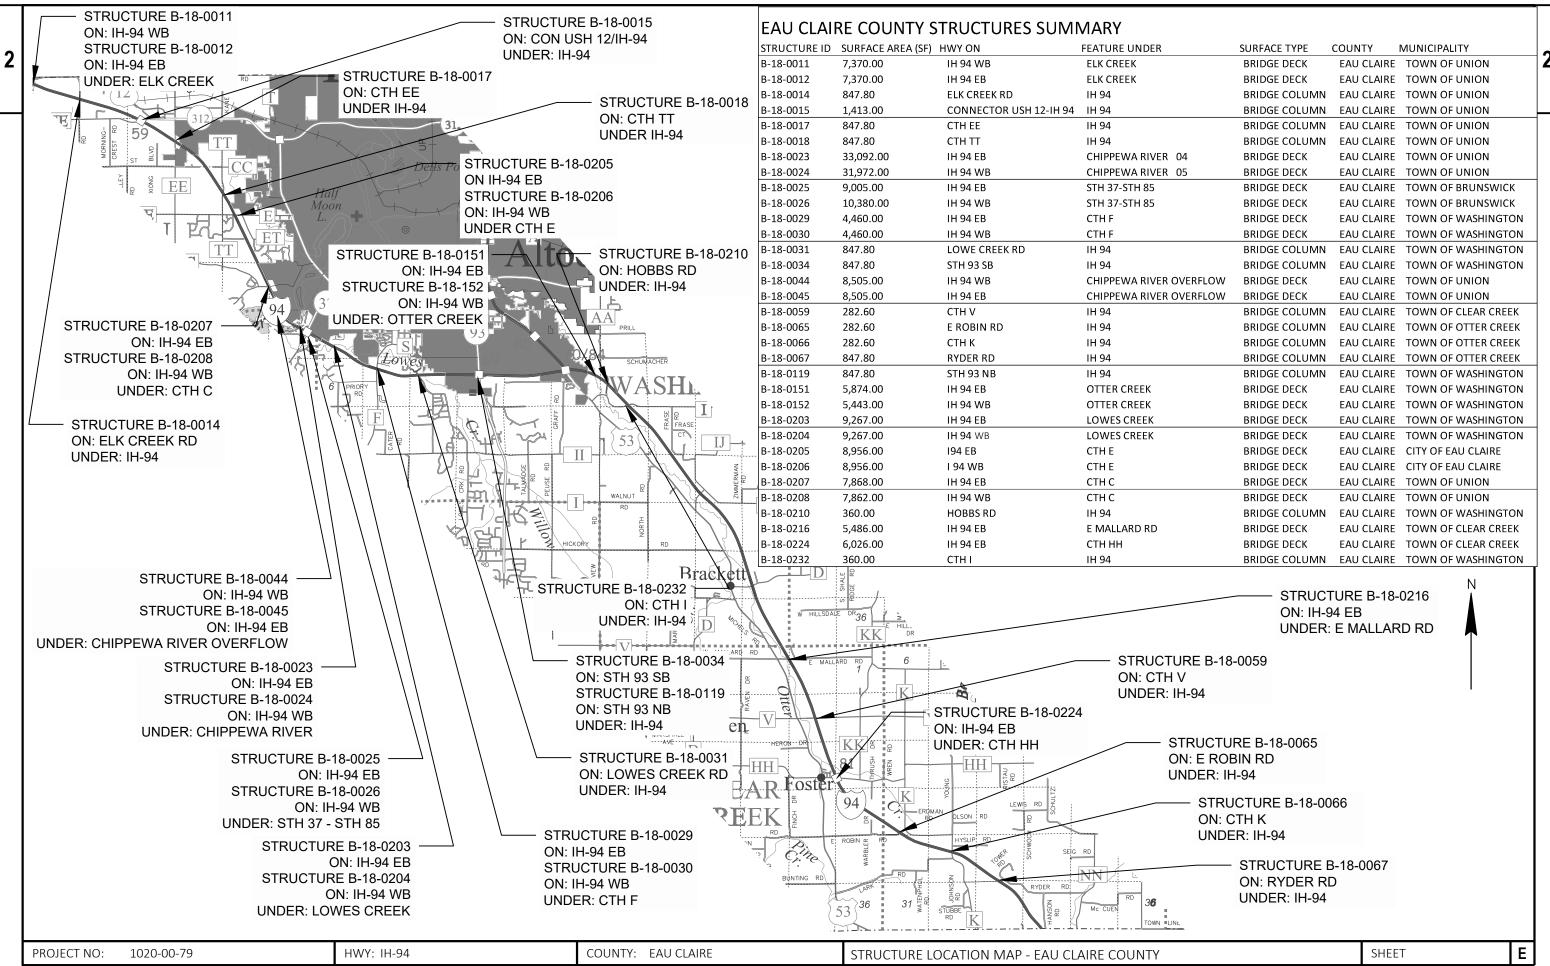


FILE NAME: N:\PDS\C3D\10200009\SHEETSPLAN\020101_GN.DWG PLOT DATE: 10/20/2020 10:20 AM PLOT BY: JENSCH, AHREN PLOT NAME: PLOT NAME: NOT TO SCALE: NOT TO SCALE: NOT TO SCALE WISDOT/CADDS SHEET 42 AVOUT NAME - 04

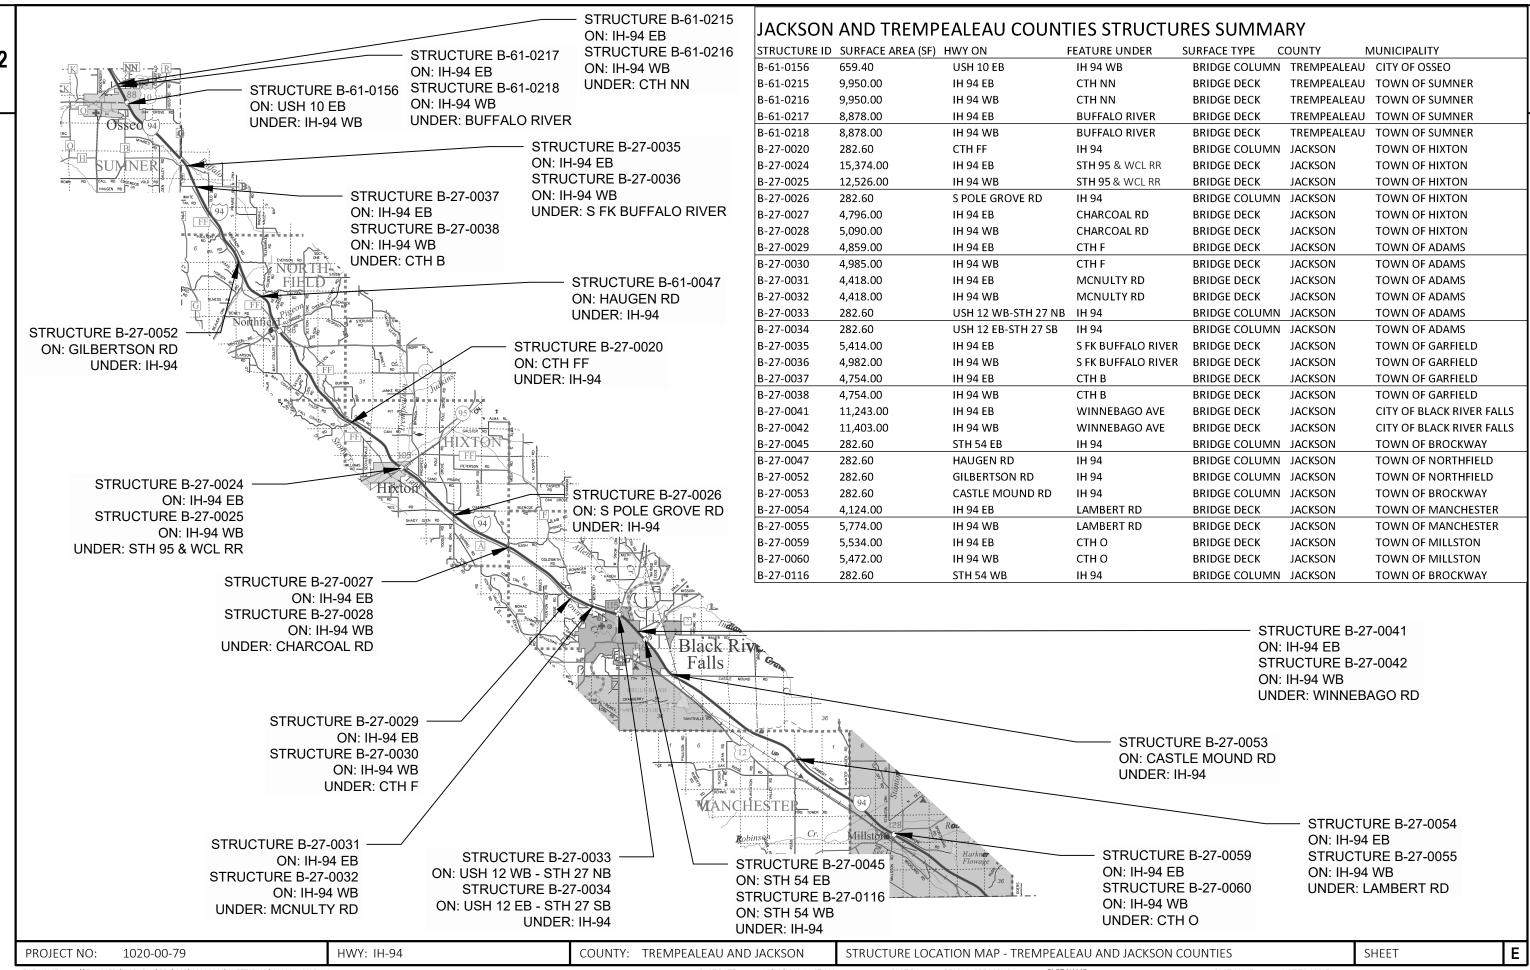

FILE NAME: \\EAU31FP2\N3PUBLIC\PDS\C3D\10200009\SHEETSPLAN\020101_GN.DWG \\PLOT DATE: \\10/28/2020 11:07 AM \\PLOT BY: \\PESOLA, GREGORY B \\PLOT NAME: \\PLOT NAME: \\PLOT SCALE: \\NOT TO SCALE: \\NOT TO SCALE \\WISDOT/CADDS SHEET 42 \\PLOT NAME = 05

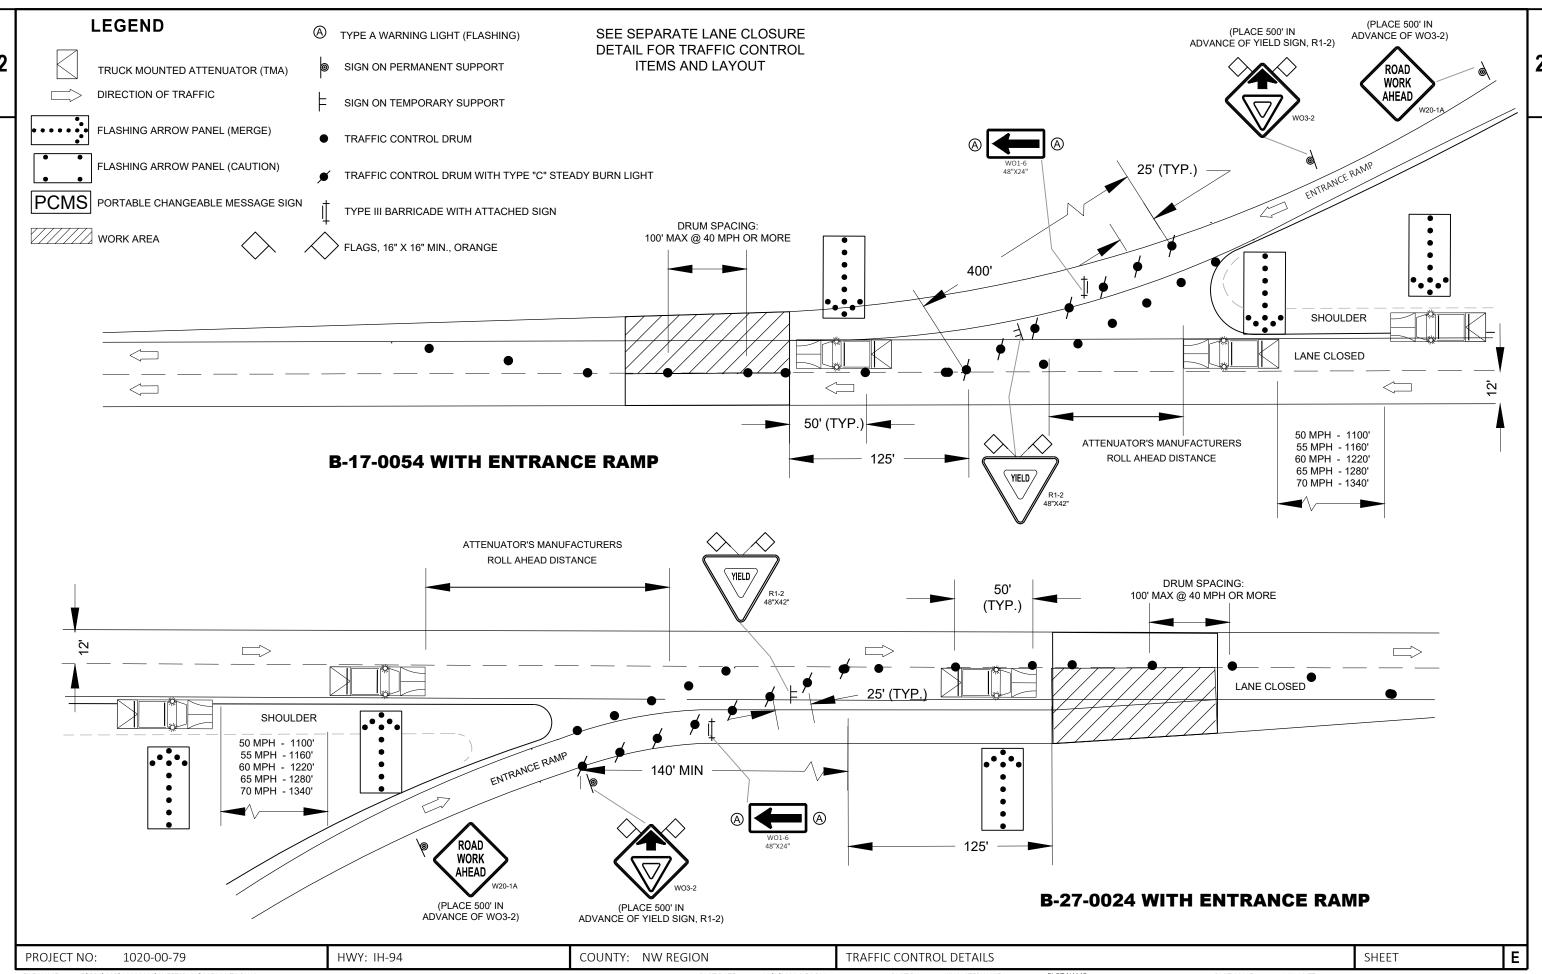

WISDOT/CADDS SHEET 42

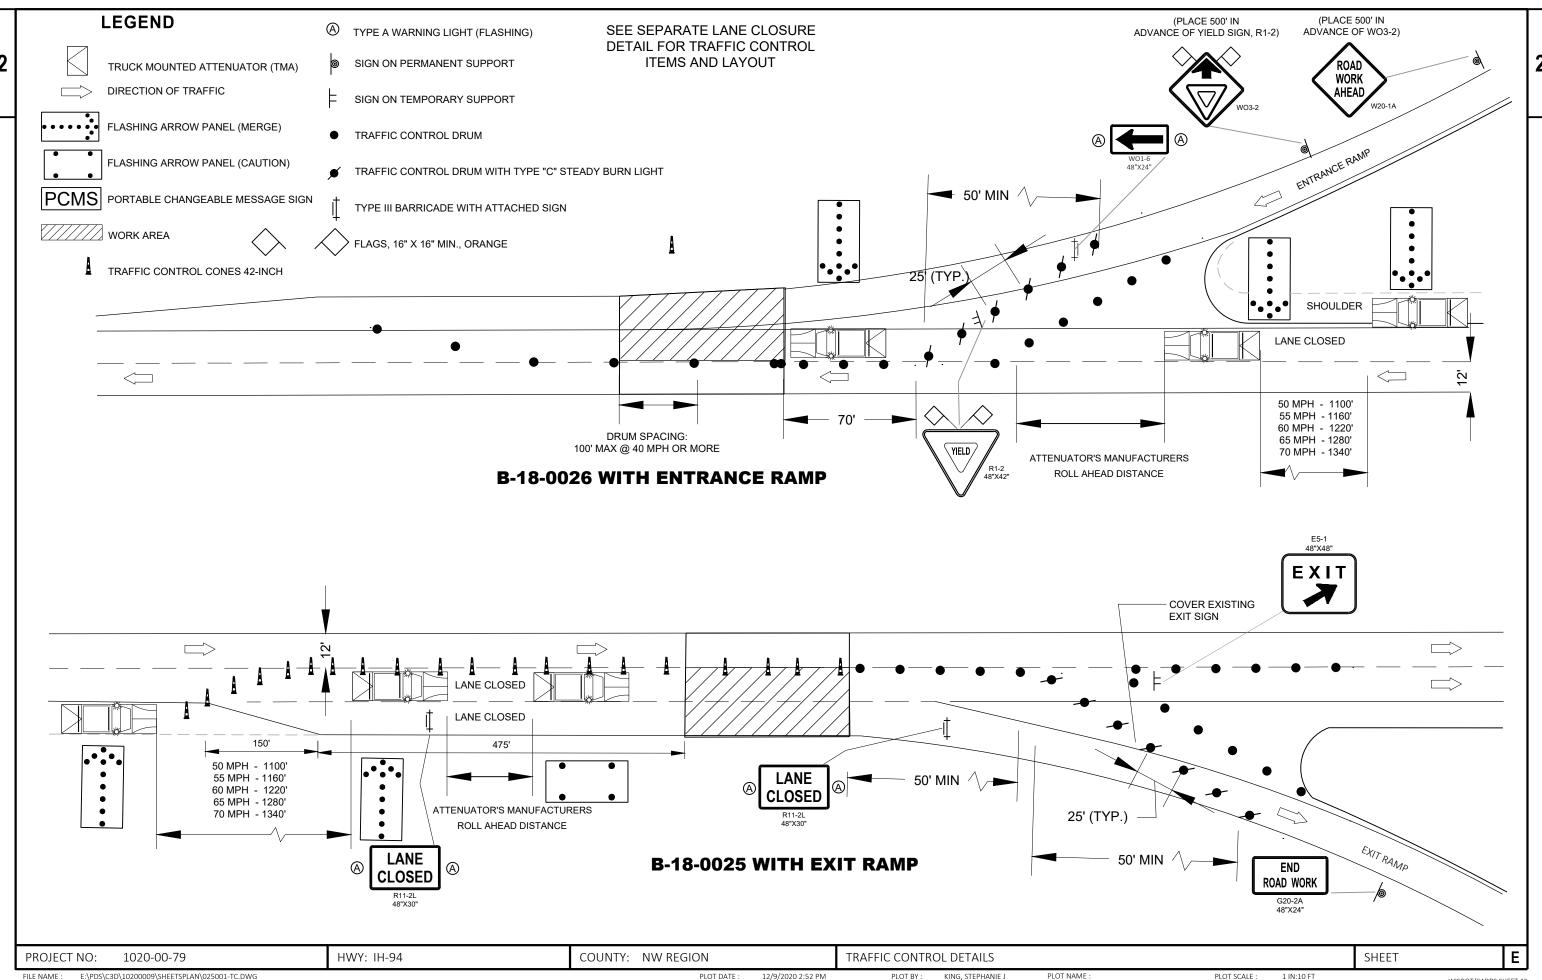

E:\PDS\C3D\10200009\SHEETSPLAN\025001-TC.DWG

Page 1

Estimate Of Quantities

					1020-00-79
Line	Item	Item Description	Unit	Total	Qty
0002	213.0100	Finishing Roadway (project) 01. 1020-00-79	EACH	1.000	1.000
0004	502.3215.S	Protective Surface Treatment Reseal	SY	47,483.000	47,483.000
0006	619.1000	Mobilization	EACH	1.000	1.000
8000	628.7010	Inlet Protection Type B	EACH	36.000	36.000
0010	643.0300	Traffic Control Drums	DAY	6,667.000	6,667.000
0012	643.0420	Traffic Control Barricades Type III	DAY	50.000	50.000
0014	643.0705	Traffic Control Warning Lights Type A	DAY	100.000	100.000
0016	643.0715	Traffic Control Warning Lights Type C	DAY	1,705.000	1,705.000
0018	643.0800	Traffic Control Arrow Boards	DAY	165.000	165.000
0020	643.0900	Traffic Control Signs	DAY	926.000	926.000
0022	643.1051	Traffic Control Signs PCMS with Cellular Communications	DAY	55.000	55.000
0024	643.1070	Traffic Control Cones 42-Inch	DAY	341.000	341.000
0026	643.5000	Traffic Control	EACH	1.000	1.000

							<u> </u>	<u>BRIDGES</u>				502.3215.S PROTECTIVE SURFACE	628.7010
								WILLAGE TOWAR				TREATMENT	INLET PROTECTION
3						CATEGORY	STRUCTURE ID	VILLAGE, TOWN OR CITY	FEATURE ON	FEATURE UNDER	SURFACE TYPE	RESEAL SY	TYPE B EACH
							ST CE	OLY COLINTY					
						0010	B-55-0026	C-HUDSON	11TH ST	IH 94-USH 12-STH 35	Bridge Column	32	
						0010	B-55-0118	T-HUDSON	CARMICHAEL RD	IH 94-USH 12-STH 35	Bridge Column	63	
						0010	B-55-0147	T-HUDSON	IH 94 EB	STH 35	Bridge Deck	1,079	4
						0010	B-55-0148	T-HUDSON	IH 94 WB	STH 35	Bridge Deck	1,426	4
						0010	B-55-0151	T-HUDSON	USH 12	IH 94	Bridge Column	63	
						0010 0010	B-55-0258 B-55-0259	T-KINNICKINNIC T-PLEASANT VALLEY	HIGHLAND DRIVE CTH J NB & SB	IH 94 IH 94	Bridge Column Bridge Column	40 40	
						0010	B-55-0260	T-RUSH RIVER	CTH T	IH 94	Bridge Column	40	
	DDOIL	CT LTENAC	212 0100 01	619 1000	643.5000	0010	B-55-0261	T-RUSH RIVER	200TH ST	IH 94	Bridge Column	40	
	PROJEC	CT ITEMS	213.0100.01	619.1000	643.5000	0010	B-55-0202	T-EAU GALLE	USH 63N	IH 94W	Bridge Column	53	
			FINISHING			0010	B-55-0264	T-EAU GALLE	233RD STREET	IH 94	Bridge Column	40	
			ROADWAY			0010	B-55-0265	T-EAU GALLE	СТН ВВ	IH 94 EB & WB	Bridge Column	40	
			(PROJECT) (01.		TRAFFIC	0010	B-55-0233	T-EAU GALLE	CTH B	IH 94	Bridge Column	67	
			1020-00-79)	MOBILIZATION	CONTROL	0010	B-55-0266	T-CADY	STH 128	IH 94	Bridge Column	40	
	CATEGORY	PROJECT	EACH	EACH	EACH					ST. C	ROIX COUNTY TOTAL	3,063	8
	0010	1020-00-79	1	1	1		DUN	IN COUNTY					
	0010					0010	B-17-0020	T-LUCAS	HALL ESTATE RD	IH 94	Bridge Column	95	
		TOTAL 0010	1	1	1	0010	B-17-0054	T-MENOMONIE	IH 94 WB	USH 12	Bridge Deck	751	
						0010	B-17-0055	T-MENOMONIE	IH 94 EB	USH 12	Bridge Deck	640	
						0010	B-17-0029	C-MENOMONIE	STH 25-BROADWAY ST	IH 94	Bridge Column	63	
						0010	B-17-0040	C-MENOMONIE	WILSON ST	IH 94	Bridge Column	95	
						0010	B-17-0193	C-MENOMONIE	STOKKE PRWY.	IH94WB	Bridge Column	42	
						0010	B-17-0144	T-RED CEDAR	CTH B NB	IH 94	Bridge Column	32	
						0010 0010	B-17-0145 B-17-0043	T-RED CEDAR T-RED CEDAR	CTH B SB CTH E	IH 94 IH 94	Bridge Column Bridge Column	32 95	
						0010	B-17-0043	T-RED CEDAR	NEY RD	IH 94	Bridge Column	95	
						0010	B-17-0034	T-ELK MOUND	IH 94 WB	ELK MOUND MARSH EQUALIZR	Bridge Deck	289	
						0010	B-17-0035	T-ELK MOUND	IH 94 EB	ELK MOUND MARSH EQUALIZR	Bridge Deck	289	
						0010	B-17-0036	T-ELK MOUND	IH 94 WB	ELK MOUND MARSH EQUALIZR	Bridge Deck	148	
						0010	B-17-0037	T-ELK MOUND	IH 94 EB	ELK MOUND MARSH EQUALIZR	Bridge Deck	148	
						0010	B-17-0038	T-ELK MOUND	IH 94 WB	ELK MOUND MARSH EQUALIZR	Bridge Deck	148	
						0010	B-17-0039	T-ELK MOUND	IH 94 EB	ELK MOUND MARSH EQUALIZR	Bridge Deck	147	
						0010	B-17-0061	T-ELK MOUND	DIVISION ST	IH 94	Bridge Column	95	
						0010	B-17-0049	V-ELK MOUND	CTH H HOLLY AVE	IH 94	Bridge Column	95 	
										С	OUNN COUNTY TOTAL	3,299	0

3

BRIDGES

502.3215.S 628.7010
PROTECTIVE
SURFACE

		VIII A CE TOVANI				TREATMENT	INLET PROTECTION
CATECORY	CTDLICTLIBE ID	VILLAGE, TOWN	FEATURE ON	CEATI IDE LINDED	CLIDE ACE TVDE	RESEAL	TYPE B
CATEGORY	STRUCTURE ID	OR CITY	FEATURE ON	FEATURE UNDER	SURFACE TYPE	SY	EACH
0010		AIRE COUNTY	HI O 4 M/D	ELV CDEEK	Drides Deel	010	
0010	B-18-0011	T-UNION	IH 94 WB	ELK CREEK	Bridge Deck	819	
0010	B-18-0012	T-UNION	IH 94 EB	ELK CREEK	Bridge Deck	819	
0010	B-18-0014	T-UNION	ELK CREEK RD	IH 94	Bridge Column	95	
0010	B-18-0015	T-UNION	CONNECTOR USH 12-IH 94	IH 94	Bridge Column	157	
0010	B-18-0017	T-UNION	CTH EE	IH 94	Bridge Column	95	
0010	B-18-0018	T-UNION	CTH TT	IH 94	Bridge Column	95	
0010	B-18-0205	C-EAU CLAIRE	194 EB	CTH E	Bridge Deck	996	
0010	B18-0206	C-EAU CLAIRE	I 94 WB	CTH E	Bridge Deck	996	
0010	B-18-0207	T-UNION	IH 94 EB	CTH C	Bridge Deck	875	
0010	B-18-0208	T-UNION	IH 94 WB	CTH C	Bridge Deck	874	
0010	B-18-0044	T-UNION	IH 94 WB	CHIPPEWA RIVER OVERFLOW	Bridge Deck	945	
0010	B-18-0045	T-UNION	IH 94 EB	CHIPPEWA RIVER OVERFLOW	Bridge Deck	945	
0010	B-18-0023	T-UNION	IH 94 EB	CHIPPEWA RIVER 04	Bridge Deck	3,677	10
0010	B-18-0024	T-UNION	IH 94 WB	CHIPPEWA RIVER 05	Bridge Deck	3,553	10
0010	B-18-0025	T-BRUNSWICK	IH 94 EB	STH 37-STH 85	Bridge Deck	1,001	2
0010	B-18-0026	T-BRUNSWICK	IH 94 WB	STH 37-STH 85	Bridge Deck	1,154	2
0010	B-18-0203	T-WASHINGTON	IH 94 EB	LOWES CREEK	Bridge Deck	1,030	
0010	B-18-0204	T-WASHINGTON	IH 94	LOWES CREEK	Bridge Deck	1,030	
0010	B-18-0029	T-WASHINGTON	IH 94 EB	F	Bridge Deck	496	
0010	B-18-0030	T-WASHINGTON	IH 94 WB	F	Bridge Deck	496	
0010	B-18-0031	T-WASHINGTON	LOWE CREEK RD	IH 94	Bridge Column	95	
0010	B-18-0034	T-WASHINGTON	STH 93 SB	IH 94	Bridge Column	95	
0010	B-18-0119	T-WASHINGTON	STH 93 NB	IH 94	Bridge Column	95	
0010	B-18-0151	T-WASHINGTON	IH 94 EB	OTTER CREEK	Bridge Deck	653	
0010	B-18-0152	T-WASHINGTON	IH 94 WB	OTTER CREEK	Bridge Deck	605	
0010	B-18-0210	T-WASHINGTON	HOBBS RD	IH 94	Bridge Column	40	
0010	B-18-0232	T-WASHINGTON	CTH I	IH 94	Bridge Column	40	
0010	B-18-0216	T-CLEAR CREEK	IH 94 EB	E MALLARD RD	Bridge Deck	610	
0010	B-18-0059	T-CLEAR CREEK	CTH V	IH 94	Bridge Column	32	
0010	B-18-0224	T-CLEAR CREEK	IH 94 EB	CTH HH	Bridge Deck	670	
0010	B-18-0065	T-OTTER CREEK	E ROBIN RD	IH 94	Bridge Column	32	
0010	B-18-0066	T-OTTER CREEK	CTH K	IH 94	Bridge Column	32	
0010	B-18-0067	T-OTTER CREEK	RYDER RD	IH 94		95	
				EAU CLA	AIRE COUNTY TOTAL	23,242	24

PROJECT NO: 1020-00-79 HWY: IH-94 COUNTY: NW REGION MISCELLANEOUS QUANTITIES SHEET: **E**

FILE NAME : N:\PDS\...\030200_mq.pptx PLOT BY : A.R.H. PLOT NAME : PLOT NAME : PLOT SCALE : 1:1

3

BRIDGES

502.3215.S

628.7010

PROTECTIVE SURFACE

TREATMENT	INLET PROTECTION

		VILLAGE, TOWN				TREATMENT	INLET PROTECTION
CATEGORY	STRUCTUREID	OR CITY	FEATURE ON	FEATURE UNDER	SURFACE TYPE	RESEAL SY	TYPE B EACH
CATEGORI		EALEAU COUNTY	FEATORE ON	FEATORE ONDER	JUNFACE TIPE	31	LACH
0010	B-61-0215	T-SUMNER	IH 94 EB	CTH NN	Bridge Deck	1 106	
0010	B-61-0216	T-SUMNER	IH 94 WB	CTH NN	Bridge Deck	1,106 1,106	
0010	B-61-0217	T-SUMNER	IH 94 EB	BUFFALO RIVER	Bridge Deck	987	
0010	B-61-0217	T-SUMNER	IH 94 WB	BUFFALO RIVER	Bridge Deck	987	
0010	B-61-0156	C-OSSEO	USH 10 EB	IH 94 WB	Bridge Column		
0010	D-01-0130	C-033L0	0311 10 Lb				
				TREM	PEALEAU COUNTY TO	OTAL 4,260	0
_	JACK	(SON COUNTY				_	
0010	B-27-0035	T-GARFIELD	IH 94 EB	S FK BUFFALO RIVER	Bridge Deck	602	
0010	B-27-0036	T-GARFIELD	IH 94 WB	S FK BUFFALO RIVER	Bridge Deck	554	
0010	B-27-0037	T-GARFIELD	IH 94 EB	СТН В	Bridge Deck	529	
0010	B-27-0038	T-GARFIELD	IH 94 WB	СТН В	Bridge Deck	529	
0010	B-27-0052	T-NORTHFIELD	GILBERTSON RD	IH 94	Bridge Column	32	
0010	B-27-0047	T-NORTHFIELD	HAUGEN RD	IH 94	Bridge Column	32	
0010	B-27-0020	T-HIXTON	FF	IH 94	Bridge Column		
0010	B-27-0024	T-HIXTON	IH 94 EB	STH 95	Bridge Deck	1,709	2
0010	B-27-0025	T-HIXTON	IH 94 WB	STH 95	Bridge Deck	1,392	2
0010	B-27-0026	T-HIXTON	S POLE GROVE RD	IH 94	Bridge Column		
0010	B-27-0027	T-HIXTON	IH 94 EB	CHARCOAL RD	Bridge Deck	533	
0010	B-27-0028	T-HIXTON	IH 94 WB	CHARCOAL RD	Bridge Deck	566	
0010	B-27-0029	T-ADAMS	IH 94 EB	CTH F	Bridge Deck	540	
0010	B-27-0030	T-ADAMS	IH 94 WB	CTH F	Bridge Deck	554	
0010	B-27-0031	T-ADAMS	IH 94 EB	MCNULTY RD	Bridge Deck	491	
. 0010	B-27-0032	T-ADAMS	IH 94 WB	MCNULTY RD	Bridge Deck	491	
0010	B-27-0033	T-ADAMS	USH 12 WB-STH 27 NB	IH 94	Bridge Column	_	
0010	B-27-0034	T-ADAMS	USH 12 EB-STH 27 SB	IH 94	Bridge Column	32	
0010	B-27-0041	C-BLACK RIVER FALLS	IH 94 EB	WINNEBAGO AVE	Bridge Deck	1,250	
0010	B-27-0042	C-BLACK RIVER FALLS	IH 94 WB	WINNEBAGO AVE	Bridge Deck	1,267	
0010	B-27-0116	T-BROCKWAY	STH 54 WB	IH 94 EW	Bridge Column		
0010	B-27-0045	T-BROCKWAY	STH 54 EB	IH 94	Bridge Column	32	
0010	B-27-0053	T-BROCKWAY	CASTLE MOUND RD	IH 94	Bridge Column	32	
0010	B-27-0054	T-MANCHESTER	IH 94 EB	LAMBERT RD	Bridge Deck	459	
0010	B-27-0055	T-MANCHESTER	IH 94 WB	LAMBERT RD	Bridge Deck	642	
0010	B-27-0059	T-MILLSTON	IH 94 EB	СТН О	Bridge Deck	615	
0010	B-27-0060	T-MILLSTON	IH 94 WB	CTH O	Bridge Deck	608	
				J	JACKSON COUNTY TO	TAL 13,619	4
					TOTAL 0010	47,483	36

PROJECT NO: 1020-00-79 HWY: IH-94 COUNTY: NW REGION MISCELLANEOUS QUANTITIES SHEET: **E**

۰	r	٠	۰
	1	۰	Ľ

								TRAFFIC	CONTOL						
						643.0300	643.0420	643.0705	643.0715	643.0800	643.0900	643.1051	643.1070		
						TRAFFIC	TRAFFIC	TRAFFIC CONTROL	TRAFFIC	TRAFFIC	TRAFFIC	TRAFFIC CONTROL SIGNS PCMS WITH	TRAFFIC	ACCEL	
						CONTROL	CONTROL BARRICADES	WARNING LIGHTS TYPE	CONTROL WARNING	CONTROL ARROW	CONTROL	CELLULAR COMMUNICATION	CONTROL CONES 42-	DECEL DRUM	
		STRUCTURE	VILLAGE, TOWN		FEATURE	DRUMS	TYPEIII	A	LIGHTS TYPE C		SIGNS	S	INCH	TAPER	
CATEGORY	COUNTY	ID	OR CITY	FEATURE ON	UNDER	DAY	DAY	DAY	DAY	DAY	DAY	DAY	DAY	FT	REMARKS
0010	ST. CROIX	VARIOUS	VARIOUS			860	0	0	200	20	117	7	0		
0010	ST. CROIX	B-55-0148	T-HUDSON	IH 94 WB	STH 35	94	6	12	39	3	13	1	79	350	EXIT LANE ACROSS BRIDGE DECK TO EXIT RAMP BEYOND BRIDGE
0010	DUNN	VARIOUS	VARIOUS			1,060	0	0	240	24	144	8	0		
0010	DUNN	B-17-0054	T-MENOMONIE	IH 94 WB	USH 12	107	2	4	41	3	13	1	0	400	❖ ENTRANCE RAMP TAPER FROM STH 25 INTERCHANGE ACROSS BRIDGE
0010	DUNN	B-17-0055	T-MENOMONIE	IH 94 EB	USH 12	82	6	12	33	3	13	1	79	200	EXIT RAMP TAPER TO STH 25 INTERCHANGE
0010	EALL OLAUDE		VARIOUS			1.000	^	•	110	<u> </u>	264	45			BEGINS AT EAST END OF DECK
0010	EAU CLAIRE	VARIOUS	VARIOUS			1,920	0	0	440	44	261	15	0		
0010	EAU CLAIRE	B-18-0015	T-UNION	CONNECTOR USH 12-IH 94	IH 94	48	12	24	50	6	26	1	•		
0010	EAU CLAIRE	B-18-0025	T-BRUNSWICK	IH 94 EB	STH 37-STH 85	70	10	20	27	3	13	1	79	50	❖ EXIT LANE ACROSS BRIDGE TO EXIT RAMP JUST BEYOND END OF DECK
0010	EAU CLAIRE	B-18-0026	T-BRUNSWICK	IH 94 WB	STH 37-STH 85	78	2	4	27	3	13	1	25	50	❖ ENTRANCE LANE ACROSS BRIDGE DECK
0010	EAU CLAIRE	B-18-0151	T-WASHINGTON	IH 94 EB	OTTER CREEK	148	2	4	61	3	13	1	0	900	ENTRANCE RAMP TAPER FROM USH 53 INTERCHANGE ENDS AT WEST END OF BRIDGE
0010	TREMPEALEAU	VARIOUS	VARIOUS			330	0	0	80	8	45	3	0		
0010	JACKSON	VARIOUS	VARIOUS			1,590	0	0	360	36	216	12	0		
0010	JACKSON	B-27-0024	T-HIXTON	IH 94 EB	STH 95	86	2	4	31	3	13	1	0	140	❖ ENTRANCE LANE ACROSS BRIDGE DECK
0010	JACKSON	B-27-0025	T-HIXTON	IH 94 WB	STH 95	78	6	12	31	3	13	1	79	150	EXIT LANE TAPER & EXIT LANE ACROSS BRIDGE DECK TO EXIT RAMP BEYOND BRIDGE
0010	JACKSON	B-27-0042	C-BLACK RIVER FALLS	E IH 94 WB	WINNEBAGO AVE	116	2	4	45	3	13	1	0	500	E E ENTRANCE RAMP TAPER FROM STH 54 INTERCHANGE ENDS AT EAST END OF BRIDGE DECK
					TOTAL 0010	6,667	50	100	1,705	165	926	55	341	•	

NOTE: QUANTITIES BASED OFF OF STANDARD DETAIL DRAWINGS LISTED BELOW AND IN NOTES TO THE RIGHT.

TRAFFIC CONTROL, LANE CLOSURE, SPEED REDUCTION

TRAFFIC CONTROL SHORT DURATION MOBILE OPERATIONS

- FOR MOVING OPERATIONS SIGNS CAN BE PLACED ON TEMPORARY SUPPORT RATHER THAN PERMANENT SUPPORT IF CLOSURE AND SPEED REDUCTION MOVE WITH CONSTRUCTION OPERATIONS.

- FOR MOVING OPERATIONS TEMPORARY PAVEMENT MARKING NOT REQUIRED.

- ❖ SEE PROJECT TRAFFIC CONTROL DETAIL
- USE TRAFFIC CONTROL, PARALLEL EXIT RAMP WITHIN LANE CLOSURE SDD WITH THE MODIFIED DECELERATION DRUM TAPER LENGTH SHOWN. THE DISTANCE BETWEEN THE END OF THE DRUM TAPER AND THE BEGINNING OF THE EXIT RAMP WILL VARY DEPENDING ON LOCATION.
- USE TRAFFIC CONTROL, TAPERED ENTRANCE RAMP WITHIN LANE CLOSURE SDD WITH THE MODIFIED ACCELERATION DRUM TAPER LENGTH SHOWN.

NOTE: THE ACCELERATION/DECELERATION DRUM TAPER LENGTHS SHOWN IN THE TABLE ARE FOR THE SITUATION WHERE THE RIGHT TRAFFIC LANE AND THE ENTRANCE/EXIT LANE AND/OR ENTRANCE/EXIT TAPER ARE CLOSED ON THE BRIDGE AND ITS APPROACHES. ADJUST THE ACCELERATION DRUM TAPERS AT ENTRANCE RAMPS AS NEEDED FOR THE SITUATION WHERE THE LEFT TRAFFIC LANE IS CLOSED ON THE BRIDGE AND ITS APPROACHES.

PROJECT NO: 1020-00-79 HWY: IH-94 COUNTY: NW REGION MISCELLANEOUS QUANTITIES SHEET: **E**

Standard Detail Drawing List

08E10-02	INLET PROTECTION TYPE A, B, C AND D
15C11-07B	CHANNELIZING DEVICES DRUMS, CONES, BARRICADES AND VERTICAL PANELS
15D12-09B	TRAFFIC CONTROL, LANE CLOSURE, SPEED REDUCTION
15D14-04	TRAFFIC CONTROL, TWO LANE CLOSURE ON FREEWAY OR EXPRESSWAY, SHORT-TERM (LESS THAN 24 HOURS)
15D15-05A	TRAFFIC CONTROL, PARALLEL ENTRANCE RAMP WITHIN LANE CLOSURE
15D15-05B	TRAFFIC CONTROL, ENTRANCE RAMP WITHIN LANE CLOSURE
15D15-05C	TRAFFIC CONTROL, TAPERED ENTRANCE RAMP WITHIN LANE CLOSURE
15D15-05D	TRAFFIC CONTROL, TAPERED ENTRANCE RAMP WITHIN LANE CLOSURE
15D15-05E	TRAFFIC CONTROL, PARALLEL EXIT RAMP WITHIN LANE CLOSURE
15D27-03	TRAFFIC CONTROL, SHOULDER CLOSURE ON DIVIDED ROADWAY, SPEEDS GREATER THAN 40 MPH
15D38-02A	TEMPORARY TRAFFIC CONTROL SIGN MOUNTING
15D38-02B	ATTACHMENT OF SIGNS TO POSTS
15D43-01	TRAFFIC CONTROL, SHORT DURATION MOBILE OPERATIONS





INLET PROTECTION, TYPE A

GENERAL NOTES

INLET PROTECTION DEVICES SHALL BE MAINTAINED OR REPLACED AT THE DIRECTION OF THE ENGINEER.

MANUFACTURED ALTERNATIVES APPROVED AND LISTED ON THE DEPARTMENT'S EROSION CONTROL PRODUCT ACCEPTABILITY LIST MAY BE

WHEN REMOVING OR MAINTAINING INLET PROTECTION, CARE SHALL BE TAKEN SO THAT THE SEDIMENT TRAPPED ON THE GEOTEXTILE FABRIC DOES NOT FALL INTO THE INLET. ANY MATERIAL FALLING INTO THE INLET SHALL BE REMOVED IMMEDIATELY.

- 1) FINISHED SIZE, INCLUDING FLAP POCKETS WHERE REQUIRED, SHALL EXTEND A MINIMUM OF 10" AROUND THE PERIMETER TO FACILITATE MAINTENANCE OR REMOVAL.
- (2) FOR INLET PROTECTION, TYPE C (WITH CURB BOX), AN ADDITIONAL 18" OF FABRIC IS WRAPPED AROUND THE WOOD AND SECURED WITH STAPLES. THE WOOD SHALL NOT BLOCK THE ENTIRE HEIGHT OF THE CURB BOX OPENING.
- (3) FLAP POCKETS SHALL BE LARGE ENOUGH TO ACCEPT WOOD 2X4.



INLET PROTECTION, TYPE C (WITH CURB BOX)

INSTALLATION NOTES

TYPE B & C

TRIM EXCESS FABRIC IN THE FLOW LINE TO WITHIN 3" OF THE GRATE.

THE CONTRACTOR SHALL DEMONSTRATE A METHOD OF MAINTENANCE, USING A SEWN FLAP, HAND HOLDS OR OTHER METHOD TO PREVENT ACCUMULATED SEDIMENT FROM ENTERING THE INLET.

TYPE D

DO NOT INSTALL INLET PROTECTION TYPE D IN INLETS SHALLOWER THAN 30", MEASURED FROM THE BOTTOM OF THE INLET TO THE TOP OF THE GRATE.

TRIM EXCESS FABRIC IN THE FLOW LINE TO WITHIN 3" OF THE GRATE.

THE INSTALLED BAG SHALL HAVE A MINIMUM SIDE CLEARANCE, BETWEEN THE INLET WALLS AND THE BAG, MEASURED AT THE BOTTOM OF THE OVERFLOW HOLES, OF 3". WHERE NECESSARY THE CONTRACTOR SHALL CINCH THE BAG, USING PLASTIC ZIP TIES, TO ACHIEVE THE 3" CLEARANCE, THE TIES SHALL BE PLACED AT A MAXIMUM OF 4" FROM THE BOTTOM OF THE BAG.

INLET PROTECTION TYPE A, B, C, AND D

STATE OF WISCONSIN DEPARTMENT OF TRANSPORTATION

APPROVED

10/16/02

/S/ Beth Cannestra CHIEF ROADWAY DEVELOPMENT ENGINEER 6

0


ш


 ∞

SDD 15C11

GENERAL NOTES

- (1) REFLECTIVE SHEETING SHALL FOLLOW THE REQUIREMENTS IN THE APPROVED PRODUCTS LISTING FOR SIGN SHEETING.
- (2) LOCATION OF WARNING LIGHTS WHEN SHOWN ON THE PLAN.

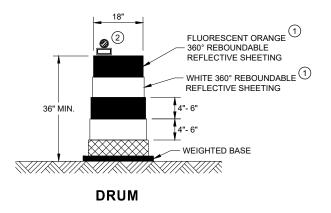

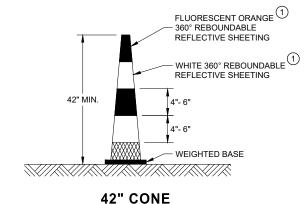





THE STRIPES SHALL SLOPE DOWNWARD TO

THE TRAFFIC SIDE FOR CHANNELIZATION.

DO NOT USE IN TAPERS ½ SPACING OF DRUMS

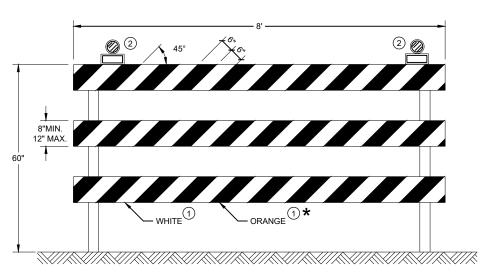

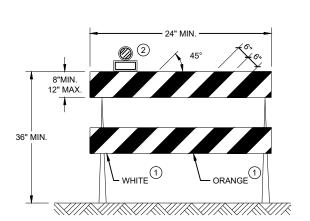

TYPE II BARRICADE

FOR RAILS LESS THAN 36" LONG, 4" WIDE STRIPES MAY BE USED. ALL STRIPES SHALL SLOPE DOWNWARD TO THE TRAFFIC SIDE FOR CHANNELIZATION.

TYPE III BARRICADE

IF SIGN MOUNTED, DO NOT COVER MORE THAN 50% OF THE TOP TWO RAILS OR 33% OF THE TOTAL AREA OF THE THREE RAILS.

* IF USED FOR A PERMANENT APPLICATION USE RED SHEETING.

CHANNELIZING DEVICES DRUMS, CONES, BARRICADES AND VERTICAL PANELS

STATE OF WISCONSIN DEPARTMENT OF TRANSPORTATION

APPROVED	
June 2017	/S/ Andrew Heidtke
DATE	WORK ZONE ENGINEER
FHWA	

07 Ŋ

SDD

GENERAL NOTES

THE EXACT NUMBER, LOCATION, AND SPACING OF ALL SIGNS AND DEVICES SHALL BE ADJUSTED TO FIT FIELD CONDITIONS AS APPROVED BY THE ENGINEER.

THE SPACING BETWEEN SIGNS SHOULD BE ADJUSTED TO NOT CONFLICT WITH AND TO PROVIDE A MINIMUM OF 200 FEET (500 FEET DESIRABLE) CLEARANCE TO EXISTING SIGNS.

THIS LANE CLOSURE IS TYPICAL FOR CLOSING RIGHT LANE - REVERSE FOR CLOSING LEFT LANE.

ALL SIGNS ARE 48" x 48" UNLESS OTHERWISE NOTED.

"WO" SIGNS ARE THE SAME AS "W" SIGNS EXCEPT THE BACKGROUND IS ORANGE.

ANY SIGNS TEMPORARY OR EXISTING, WHICH CONFLICT WITH TRAFFIC CONTROL "IN USE" SHALL BE REMOVED OR COVERED AS NEEDED OR AS APPROVED BY THE ENGINEER.

CONSIDER ROADWAY GEOMETRICS WHEN LOCATING SIGNS AND ARROW BOARD SO THE DRIVER HAS A CLEAR VIEW OF THE ARROW BOARD AND LANE CLOSURE DRUMS.

FOR A LANE CLOSURE THAT IS IN PLACE LESS THAN 7 CONTINUOUS DAYS AND NIGHTS, THE ADVANCED WARNING SIGNS MAY BE MOUNTED ON PORTABLE SUPPORTS.

REMOVE PAVEMENT MARKINGS IF LANE CLOSURE IS TO BE IN PLACE 4 OR MORE CONTINUOUS DAYS AND NIGHTS.

WARNING LIGHTS ARE NOT REQUIRED IF THE LANE CLOSURE IS A DAYTIME ONLY OPERATION.

IF THE HORIZONTAL ALIGNMENT IS SUCH THAT A CURVE MAY REQUIRE ADDITIONAL DELINEATION, THE DEVICE SPACING MAY BE DECREASED TO $50\,\mathrm{FEET}.$

ADJUSTMENTS IN BUFFER SPACE NEED TO BE INCORPORATED WHEN THE LANE CLOSURE OCCURS NEAR AN INTERCHANGE EXIT OR ENTRANCE RAMP OR INTERSECTION. THE LANE CLOSURE MUST TAKE PLACE FAR ENOUGH IN ADVANCE OF AN EXIT OR ENTRANCE RAMP TO STILL ALLOW FOR ADEQUATE BUFFER SPACE. THE MINIMUM LENGTH OF THE BUFFER SPACE BEFORE AN EXIT RAMP SHOULD BE ONE HALF THE LENGTH OF THE TRANSITION AREA. THE ENTRANCE RAMP SHOULD BE FOLLOWED BY THE ORIGINAL BUFFER SPACE LENGTH OF 800 FEET DESIRABLE PRIOR TO ANOTHER TRAFFIC CONTROL CHANGE SUCH AS A CROSSOVER MANEUVER.

★ A SPEED LIMIT SIGN SHALL BE LOCATED 1500 FEET BEYOND THE END OF THE ACCELERATION LANE OF EACH ENTRANCE RAMP. PLACE A SPEED LIMIT SIGN A MINIMUM OF EVERY 3 MILES. INCLUDE A RESUME SPEED LIMIT SIGN 200 FEET MINIMUM (500 FEET DESIRABLE) BEYOND THE "END OF ROADWORK" SIGN.

LEGEND

- SIGN ON PERMANENT SUPPORT
- TRAFFIC CONTROL DRUM
- ▼ TRAFFIC CONTROL DRUM WITH TYPE "C" STEADY BURN LIGHT


TYPE III BARRICADE WITH ATTACHED SIGN

TYPE "A" WARNING LIGHT (FLASHING)

DIRECTION OF TRAFFIC

WORK AREA

FLASHING ARROW BOARD

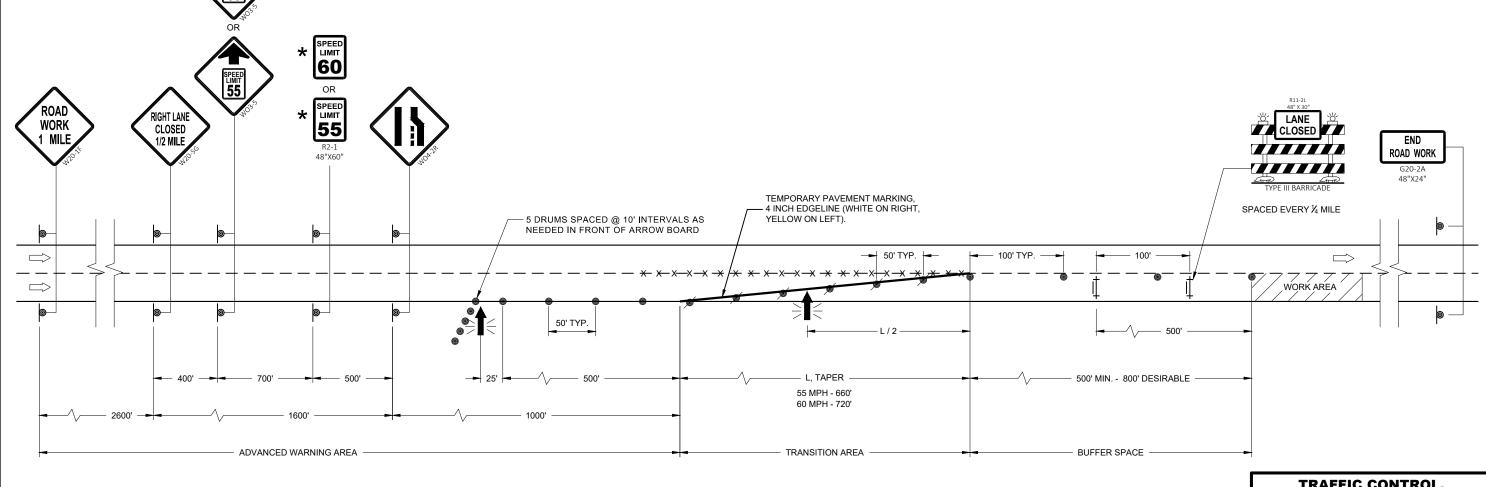

TRAFFIC CONTROL, LANE CLOSURE, SPEED REDUCTION

STATE OF WISCONSIN
DEPARTMENT OF TRANSPORTATION

APPROVED
August 2020
DATE


/S/ Andrew Heidtke
WORK ZONE ENGINEER

0

D12

<u>1</u>

SDD 15D12 - 09b

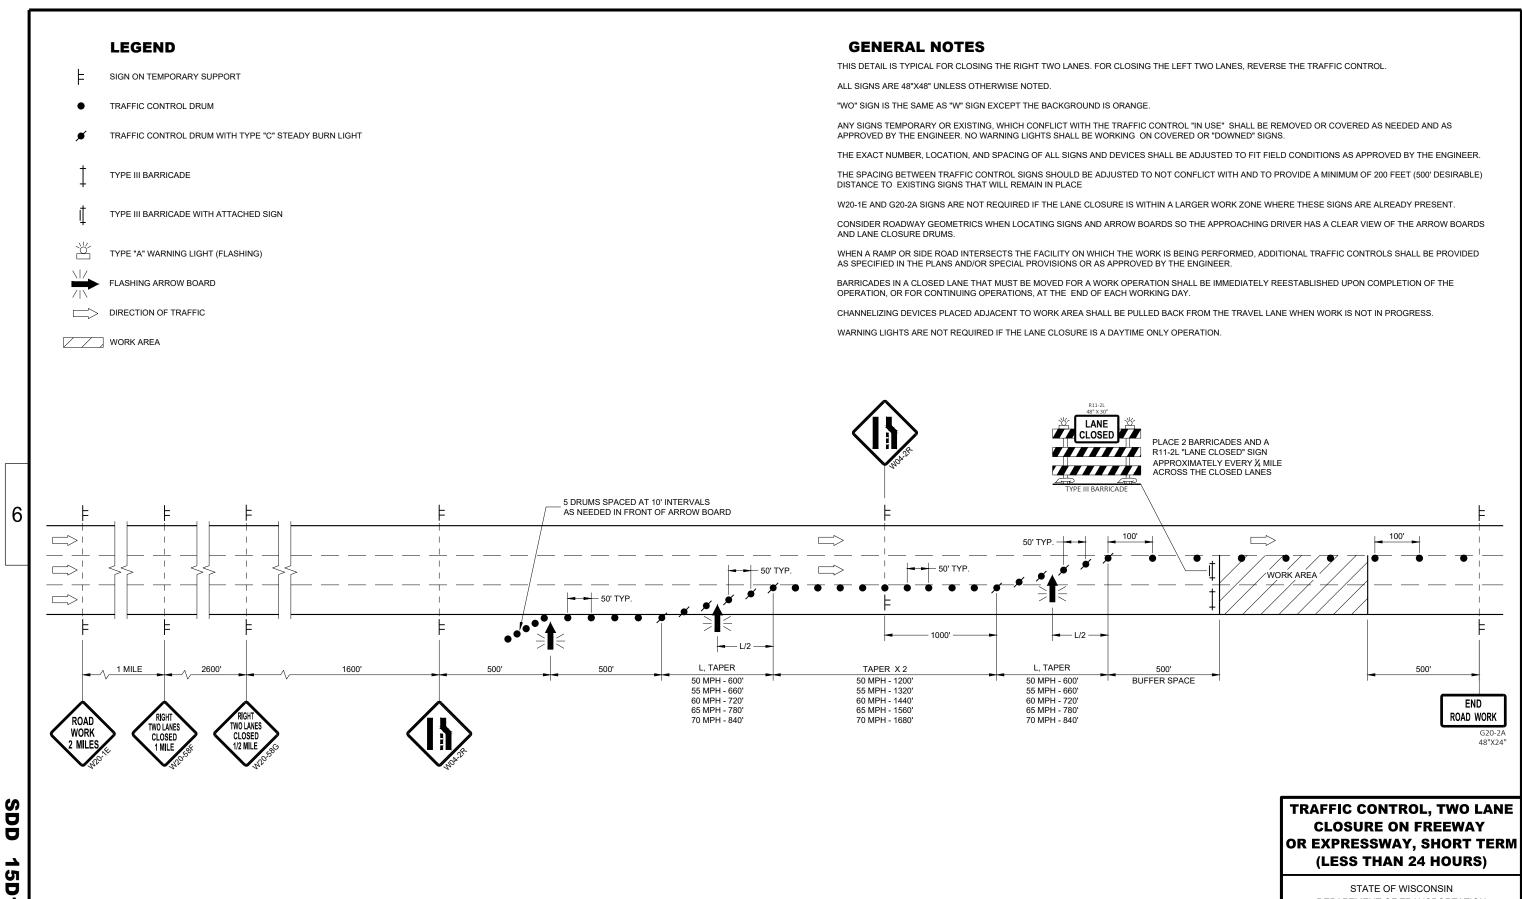

4

0

4 D

STATE OF WISCONSIN DEPARTMENT OF TRANSPORTATION

/S/ Andrew Heidtke

STATEWIDE WORK ZONE TRAFFIC SAFETY ENGINEER

APPROVED May 2020 DATE

(PLACE 500' IN

ADVANCE OF GORE)

(PLACE 1000' IN

ADVANCE OF GORE

PARALLEL EXIT RAMP

LANE CLOSED

0

S

S


STATE OF WISCONSIN DEPARTMENT OF TRANSPORTATION

APPROVED May 2019
DATE /S/ Andrew Heidtke WORK ZONE ENGINEER

100' (TYP.)

LANE CLOSED

SDD 15D15

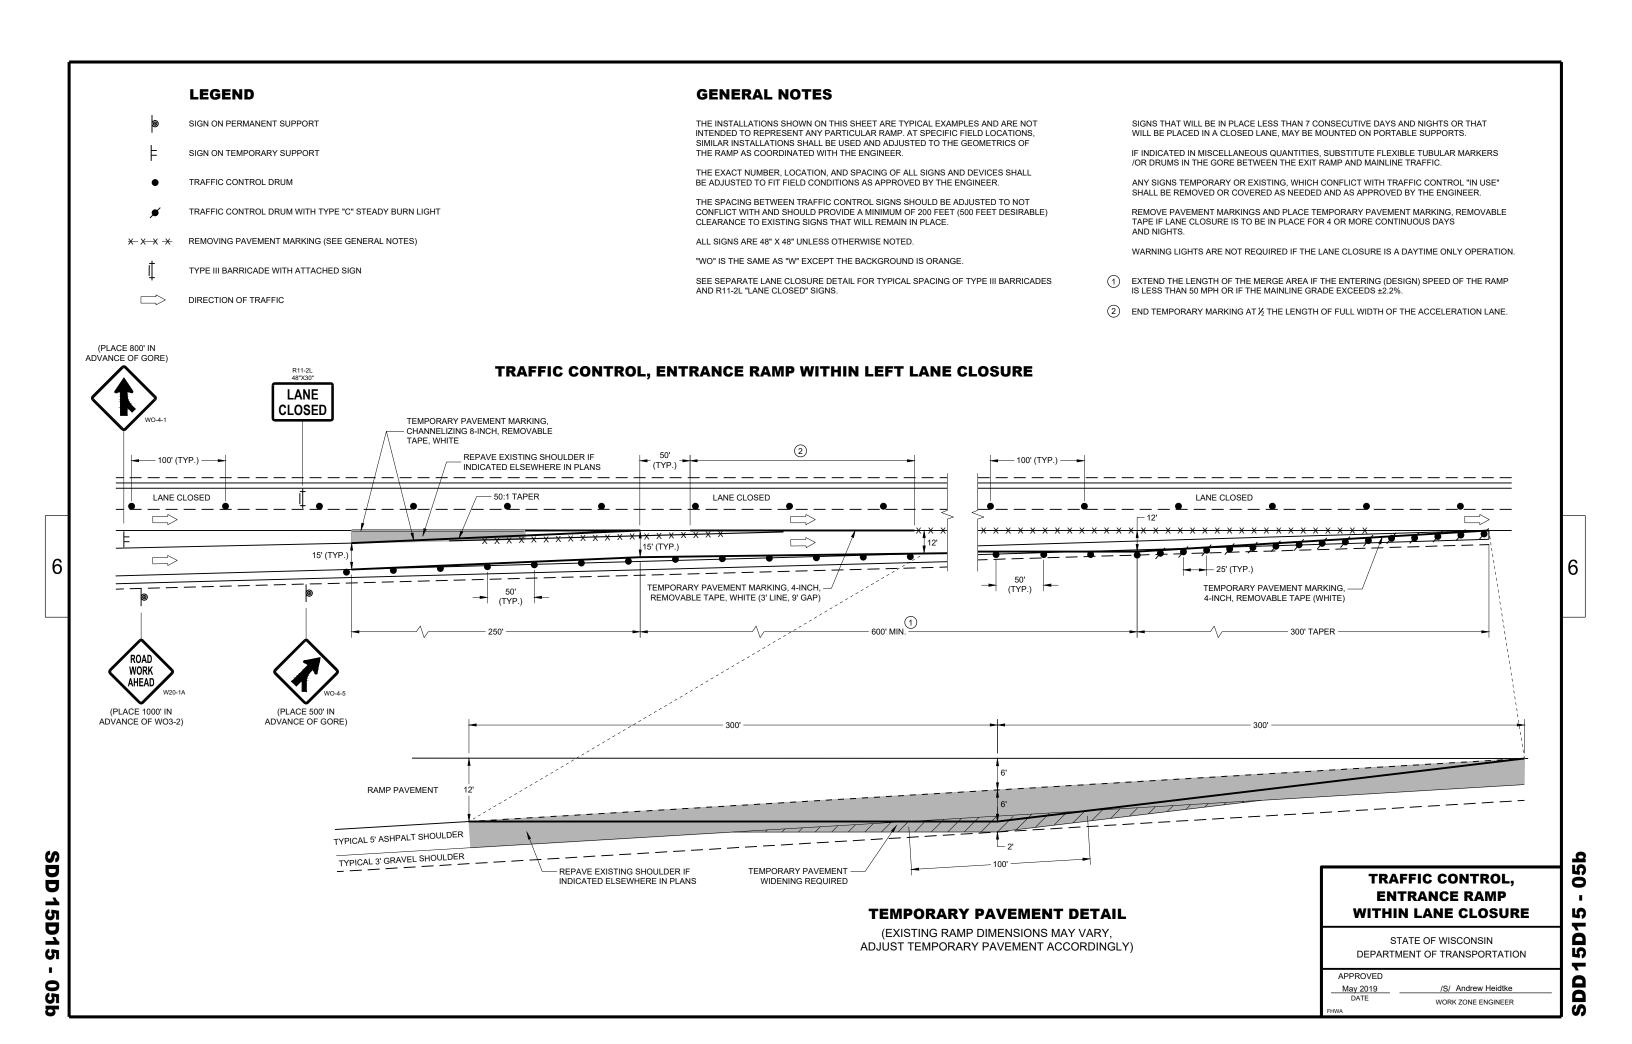

(PLACE 500' IN

ADVANCE OF WO3-2)

GENERAL NOTES

THE INSTALLATIONS SHOWN ON THIS SHEET ARE TYPICAL EXAMPLES AND ARE NOT INTENDED TO REPRESENT ANY PARTICULAR RAMP. AT SPECIFIC FIELD LOCATIONS, SIMILAR INSTALLATIONS SHALL BE USED AND ADJUSTED TO THE GEOMETRICS OF THE RAMP AS COORDINATED WITH THE ENGINEER.

THE EXACT NUMBER, LOCATION, AND SPACING OF ALL SIGNS AND DEVICES SHALL BE ADJUSTED TO FIT FIELD CONDITIONS AS APPROVED BY THE ENGINEER.

THE SPACING BETWEEN TRAFFIC CONTROL SIGNS SHOULD BE ADJUSTED TO NOT CONFLICT WITH AND SHOULD PROVIDE A MINIMUM OF 200 FEET (500 FEET DESIRABLE) CLEARANCE TO EXISTING SIGNS THAT WILL REMAIN IN PLACE.

ALL SIGNS ARE 48" X 48" UNLESS OTHERWISE NOTED.

"WO" IS THE SAME AS "W" EXCEPT THE BACKGROUND IS ORANGE.

SEE SEPARATE LANE CLOSURE DETAIL FOR TYPICAL SPACING OF TYPE III BARRICADES AND R11-2L "LANE CLOSED" SIGNS.

YIELD SIGN AND WARNING SIGNS ON ENTRANCE RAMP ARE ALSO APPROPRIATE FOR CLOSURE OF THE MAINLINE LEFT LANE. OMIT THE YIELD SIGN IF MORE THAN ONE LANE REMAINS OPEN ON THE MAINLINE AND THE RAMP TAPER IS AT LEAST AS LONG AS THE NORMAL ENTRANCE RAMP TAPER AT THE SITE.

SIGNS THAT WILL BE IN PLACE LESS THAN 7 CONSECUTIVE DAYS AND NIGHTS OR THAT WILL BE PLACED IN A CLOSED LANE, MAY BE MOUNTED ON PORTABLE SUPPORTS. USE SUPPORTS THAT PROVIDE A MINIMUM OF 5 FEET FROM THE BOTTOM OF THE SIGN TO THE PAVEMENT.


IF INDICATED IN MISCELLANEOUS QUANTITIES, SUBSTITUTE FLEXIBLE TUBULAR MARKERS FOR DRUMS IN THE GORE BETWEEN THE ENTRANCE RAMP AND MAINLINE TRAFFIC.

ANY SIGNS TEMPORARY OR EXISTING, WHICH CONFLICT WITH TRAFFIC CONTROL "IN USE" SHALL BE REMOVED OR COVERED AS NEEDED AND AS APPROVED BY THE ENGINEER.

REMOVE PAVEMENT MARKINGS AND PLACE TEMPORARY PAVEMENT MARKING, REMOVABLE TAPE IF LANE CLOSURE IS TO BE IN PLACE FOR 4 OR MORE CONTINUOUS DAYS AND NIGHTS.

WARNING LIGHTS ARE NOT REQUIRED IF THE LANE CLOSURE IS A DAYTIME ONLY OPERATION.

(1) CONSULT WITH REGIONAL WORK ZONE ENGINEER IF NEED TO REDUCE LENGTH EXISTS.

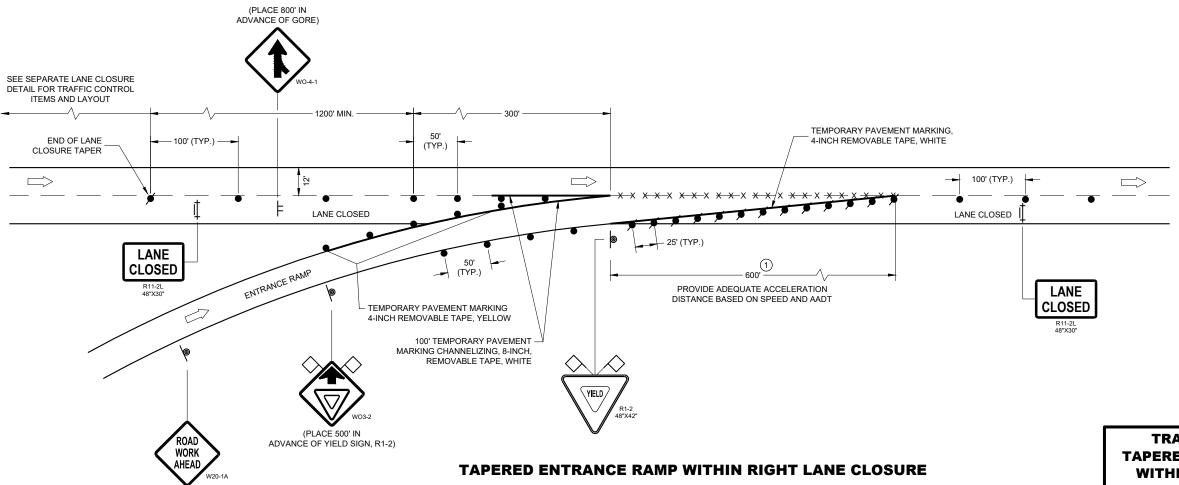

STATE OF WISCONSIN
DEPARTMENT OF TRANSPORTATION

APPROVED

May 2019

DATE

/S/ Andrew Heidtke
WORK ZONE ENGINEER

0

S

S

TAPERED ENTRANCE RAMP WITHIN LEFT LANE CLOSURE

(PLACE 500' IN

ADVANCE OF WO3-2)

TAPERED ENTRANCE RAMP

DEPARTMENT OF TRANSPORTATION APPROVED May 2019 DATE /S/ Andrew Heidtke WORK ZONE ENGINEER

TRAFFIC CONTROL,

WITHIN LANE CLOSURE

STATE OF WISCONSIN

SIGN ON TEMPORARY SUPPORT

TRAFFIC CONTROL DRUM

▼ TRAFFIC CONTROL DRUM WITH TYPE "C" STEADY BURN LIGHT

X-X-X REMOVING PAVEMENT MARKING (SEE GENERAL NOTES)

TYPE III BARRICADE WITH ATTACHED SIGN

DIRECTION OF TRAFFIC

GENERAL NOTES

THE INSTALLATIONS SHOWN ON THIS SHEET ARE TYPICAL EXAMPLES AND ARE NOT INTENDED TO REPRESENT ANY PARTICULAR RAMP. AT SPECIFIC FIELD LOCATIONS, SIMILAR INSTALLATIONS SHALL BE USED AND ADJUSTED TO THE GEOMETRICS OF THE RAMP AS COORDINATED WITH THE ENGINEER.

THE EXACT NUMBER, LOCATION, AND SPACING OF ALL SIGNS AND DEVICES SHALL BE ADJUSTED TO FIT FIELD CONDITIONS AS APPROVED BY THE ENGINEER.

THE SPACING BETWEEN TRAFFIC CONTROL SIGNS SHOULD BE ADJUSTED TO NOT CONFLICT WITH AND SHOULD PROVIDE A MINIMUM OF 200 FEET (500 FEET DESIRABLE) CLEARANCE TO EXISTING SIGNS THAT WILL REMAIN IN PLACE.

ALL SIGNS ARE 48" X 48" UNLESS OTHERWISE NOTED.

"WO" IS THE SAME AS "W" EXCEPT THE BACKGROUND IS ORANGE.

SEE SEPARATE LANE CLOSURE DETAIL FOR TYPICAL SPACING OF TYPE III BARRICADES AND R11-2L "LANE CLOSED" SIGNS.


SIGNS THAT WILL BE IN PLACE LESS THAN 7 CONSECUTIVE DAYS AND NIGHTS OR THAT WILL BE PLACED IN A CLOSED LANE, MAY BE MOUNTED ON PORTABLE SUPPORTS.

IF INDICATED IN MISCELLANEOUS QUANTITIES, SUBSTITUTE FLEXIBLE TUBULAR MARKERS FOR DRUMS IN THE GORE BETWEEN THE EXIT RAMP AND MAINLINE TRAFFIC.

REMOVE PAVEMENT MARKINGS AND PLACE TEMPORARY PAVEMENT MARKING, REMOVABLE TAPE IF LANE CLOSURE IS TO BE IN PLACE FOR 4 OR MORE CONTINUOUS DAYS AND NICELES.

ANY SIGNS TEMPORARY OR EXISTING, WHICH CONFLICT WITH TRAFFIC CONTROL "IN USE" SHALL BE REMOVED OR COVERED AS NEEDED AND AS APPROVED BY THE ENGINEER.

WARNING LIGHTS ARE NOT REQUIRED IF THE LANE CLOSURE IS A DAYTIME ONLY OPERATION.

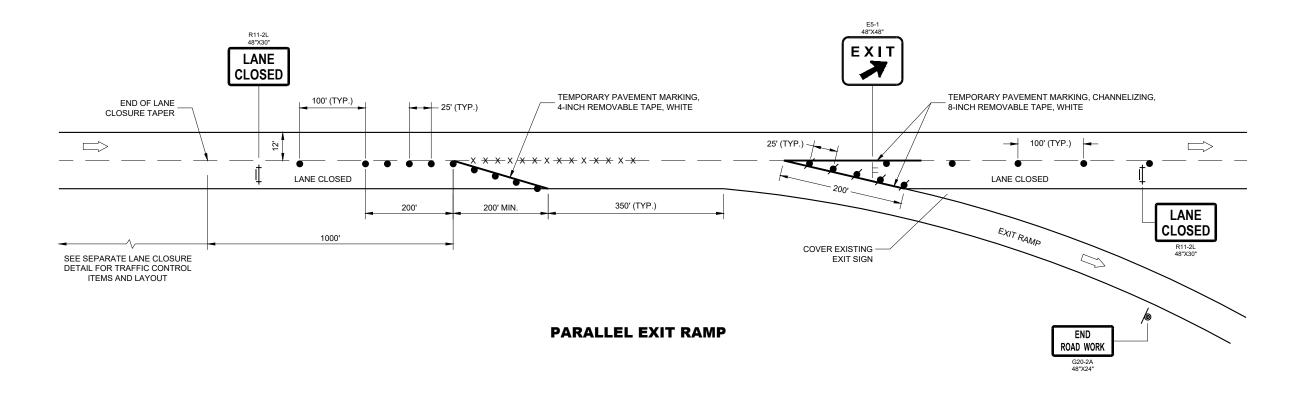

TRAFFIC CONTROL, PARALLEL EXIT RAMP WITHIN LANE CLOSURE

STATE OF WISCONSIN
DEPARTMENT OF TRANSPORTATION

APPROVED

May 2019

DATE

/S/ Andrew Heidtke
WORK ZONE ENGINEER


0

IJ

<u>1</u>

6

SDD 15D15 - 05

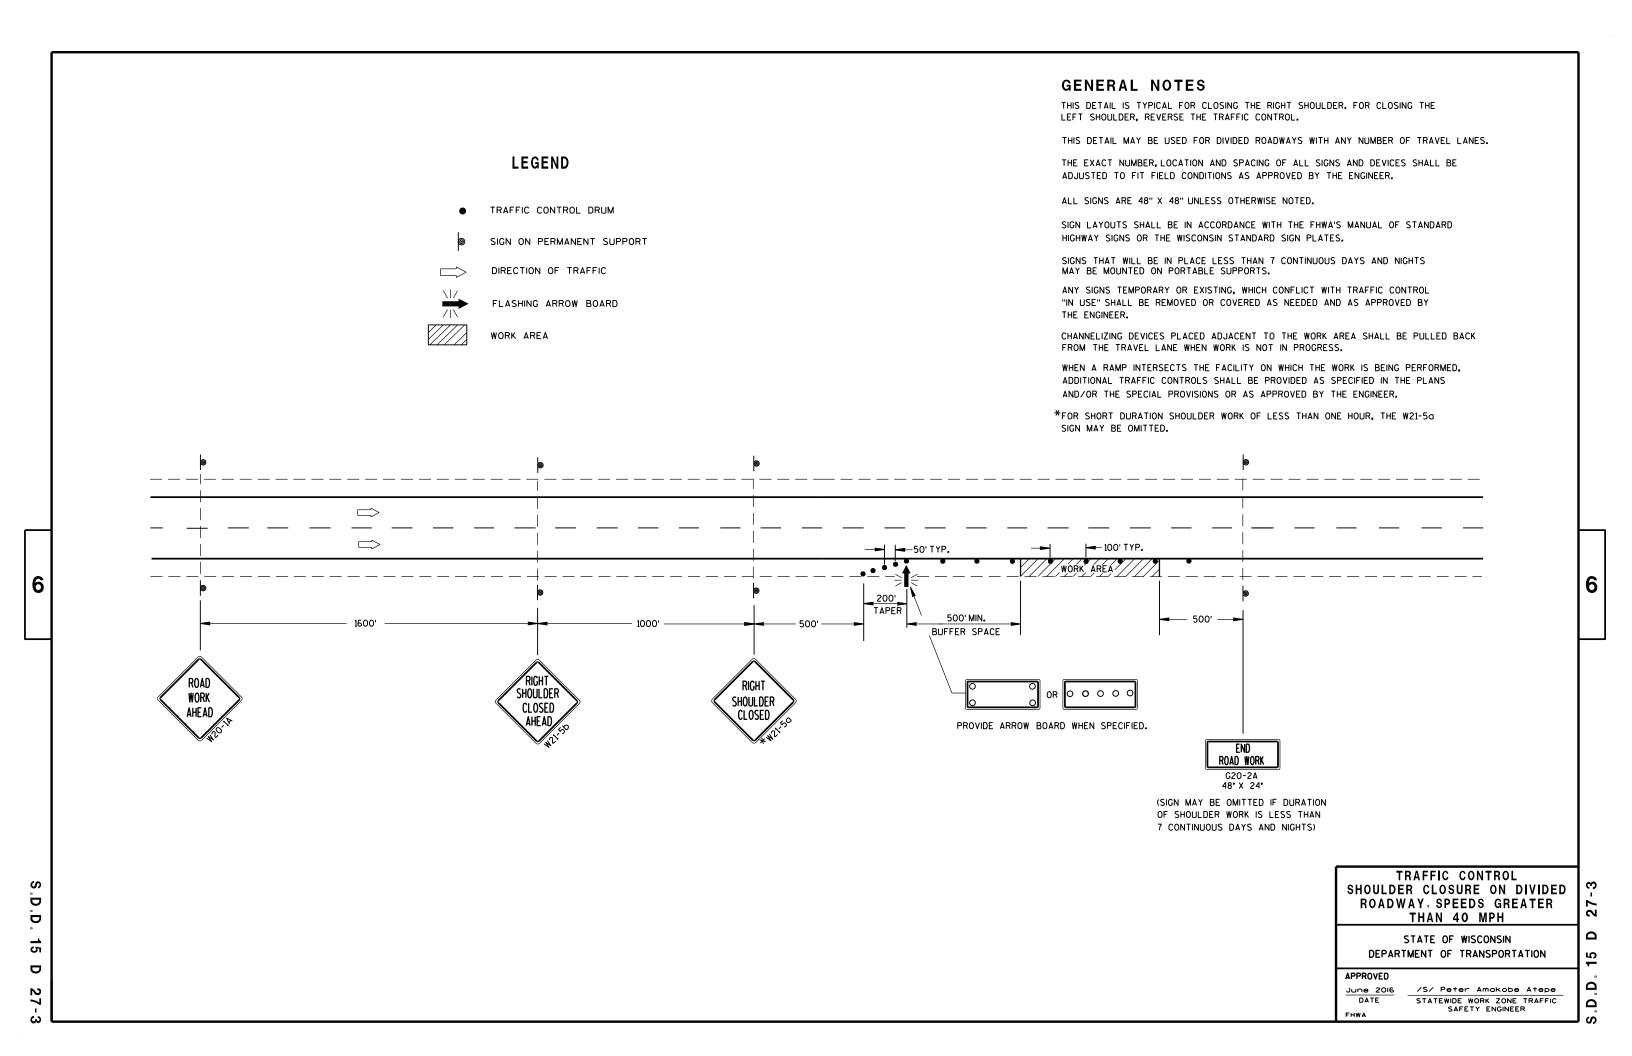



TUBULAR STEEL POSTS

AREA OF SIGN INSTALLATION (SO. FT.)	NUMBER OF REQUIRED TUBULAR STEEL POSTS
9 OR LESS	1
GREATER THAN 9 LESS THAN OR EQUAL TO 18	2
GREATER THAN 18 LESS THAN OR EQUAL TO 27	3

SIGNS WIDER THAN 3 FEET OR LARGER THAN 9 SO.FT. SHALL BE MOUNTED ON MULTIPLE POSTS (SEE ABOVE TABLE). SIGNS LARGER THAN 27 SO.FT. SHALL NOT BE MOUNTED ON TUBULAR STEEL POSTS.

URBAN AREA

POST MOUNTING DETAIL FOR TEMPORARY TRAFFIC CONTROL FIXED MESSAGE SIGNS

WOOD POST **EMBEDMENT DEPTH**

AREA OF SIGN INSTALLATION (SQ. FT.)	D (MIN)
20 OR LESS	4'
GREATER THAN 20	5'

4" X 6" WOOD POST

POST SPACING REQUIREM	POST SPACING REQUIREMENTS					
L	E	WOOD POSTS REQUIRED				
48" OR LESS AND LESS THAN 20 SO.FT.	-	1				
LESS THAN 60"	12"	2	٤			
60" TO 120"	L/5	2				
GREATER THAN 120" LESS THAN 168"	12"	3				
168" AND GREATER	12"	4				

SEE NOTE (3)

RURAL AREA

TEMPORARY TRAFFIC CONTROL SIGN MOUNTING

STATE OF WISCONSIN DEPARTMENT OF TRANSPORTATION

-11

D D 15 D ∞

6

Δ

 ∞

6

- 11/2" DIAMETER HOLES

Ω


Ω


STATE OF WISCONSIN DEPARTMENT OF TRANSPORTATION

> /S/ Andrew Heidtke WORK ZONE ENGINEER

APPROVED


June 2017
DATE

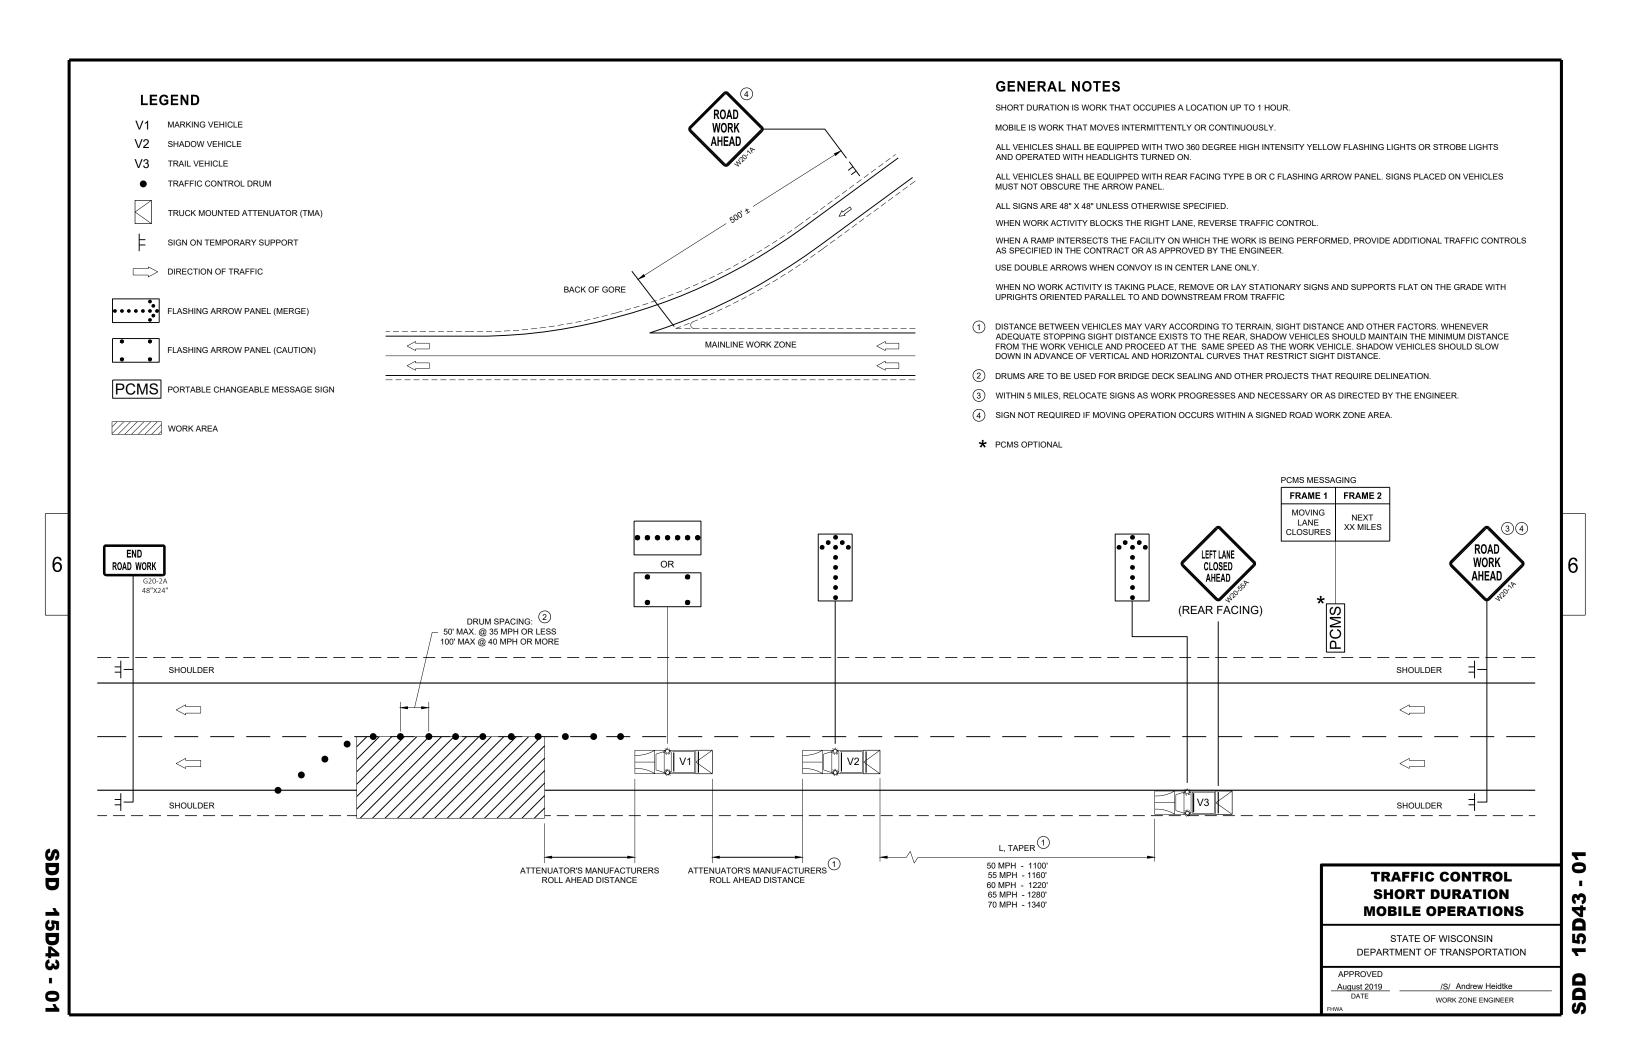

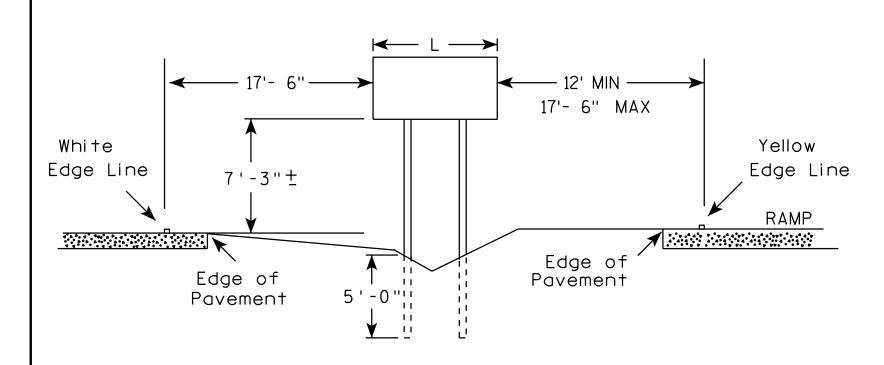

GENERAL NOTES

- 1. The 150 foot distance from the physical gore (where pavement ends) will normally provide the offsets as shown.
- 2. If roadway geometrics permit, the sign may be closer than the 150 foot distance as long as the offsets are maintained.
- 3. At no time shall the location be greater than 150 feet. If the normal offsets cannot be maintained, they can be reduced to 6 feet from the edge of the paved shoulder (both freeway and ramp).
- 4. The offset from edge of sign to the yellow edge line on the ramp is shown as a minimum of 12 feet and a maximum of 17 feet, 6 inches. Preference is adhering to the maximum rather than the minimum dimension.
- 5. When L is equal to or exceeds 10 feet, use 3 posts as per A4-4.
- 6. The $(\overline{+})$ tolerance for the mounting height is 3 inches.

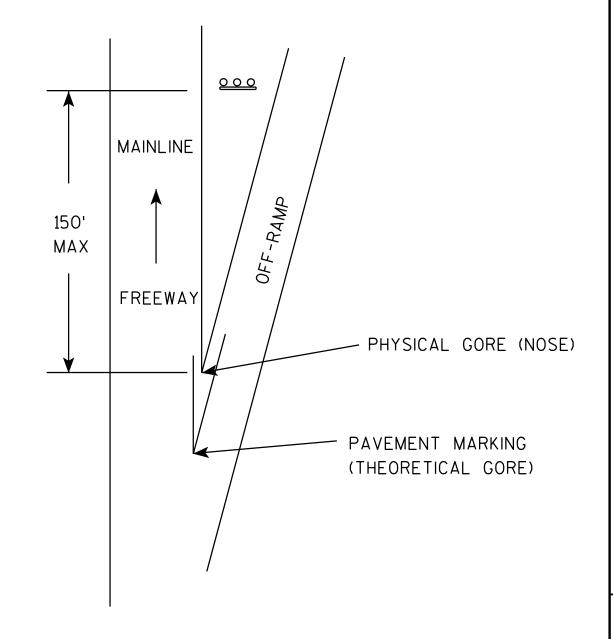

TYPICAL INSTALLATION OF TYPE II SIGNS ON WOOD POSTS IN GORE

WISCONSIN DEPT OF TRANSPORTATION

DATE 2/06/14


PLATE NO. 44-2.3

SHEET NO:

PROJECT NO:

PLOT DATE: 06-FEB-2014 12:36

PLOT BY: mscsja

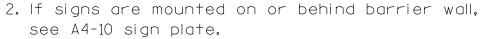

The Double Arrow sign (W12-1D) shall be mounted at a height of 2'-3" (\pm). The Chevron sign (W1-8), Roundabout Chevron panel (R6-4B), Enhanced Reference Markers, Clearance Markers (W5-52), Mile Markers (D10 series), In Road Object Markers (W5-54) & End of Road Markers (W5-56) shall be mounted at a height of 4'-3" (\pm).

- 3. For expressways and freeways, mounting height is 7'- 3" (±) or 6'-3" (±) depending upon existence of a sub-sign.
- 4. Minimum mounting height for signs mounted on traffic signal poles is $5'-3''(\frac{+}{2})$.
- 5. Offset distance shall be consistent with existing signs or consistent throughout length of project.
- 6. The (±) tolerance for mounting height is 3 inches.
- 7. Folding signs shall be mounted at a height of 5'-3'' (\pm) or as directd by the Engineer.

2' Min - 4' Max (See Note 6)

** Curb Flowline

D
White Edgeline Location

*

6'-3"(±)

D |

Outside Edge

of Gravel

White Edgeline
Location

Outside Edge
of Gravel

d.

POST EMBEDMENT DEPTH

Area of Sign
Installation
(Sq.Ft.)
(Min)
20 or Less
4'
Greater than 20
5'

The existence of curb and gutter does not in itself mandate the vertical clearance illustrated. That height is typically measured where there is sidewalk adjacent to the roadway or parking is permitted. In the absence of sidewalk vertical clearance is measured from the top of the curb. Offset of signs is measured from the flow line.

HWY:

* 6 feet from edge of a paved shoulder or 12 feet from the edge of pavement (edge line location) or 2 feet from outside edge of gravel, whichever is greater unless directed by project engineer.

TYPICAL INSTALLATION
OF PERMANENT TYPE II
SIGNS ON SINGLE POSTS

WISCONSIN DEPT OF TRANSPORTATION

Matther & Rawk For State Traffic Engineer

DATE 5/13/2020 PLATE NO. _A4-3.22

SHEET NO:

Ε

FILE NAME : C:\CAEfiles\Projects\tr_stdplate\A43.dgn

PROJECT NO:

PLOT DATE: 13-MAY 2020 1:04

COUNTY:

PLOT BY : mscj9h

PLOT NAME :

PLOT SCALE: \$\$.....plo†scale.....\$\$WISDOT/CADDS SHEET 42

APPROVED



NOTES: 1. ALL MATERIAL TO BE APPROVED

BY ENGINEER PRIOR TO INSTALLATION

- 2. SEE SIGN PLATE A4-8 FOR SIGN HARDWARE REQUIREMENTS
- 3. 18 INCH X 18 INCH SQUARE BOX-OUTS MAY BE USED FOR INSTALLATIONS IN EXISTING CONCRETE OR ASPHALT LOCATIONS.



ELEVATION VIEW

DETAIL OF STEEL 2 X 2 SIGN POST IN BOX-OUT



DETAIL OF WOOD 4 X 6 SIGN POST IN BOX-OUT

HWY:



PLAN VIEW

COUNTY:

FOR NEW CONCRETE/ASPHALT INSTALLATIONS

SIGN POST BOX-OUTS A4-3B

WISCONSIN DEPT OF TRANSPORTATION

For State Traffic Engineer

DATE 1/27/14 PLATE NO. A4-3B.1

SHEET NO:

FILE NAME : C:\CAEFiles\Projects\tr_stdplate\A43B.DGN

PROJECT NO:

PLOT DATE: 27-JAN-2014 09:48

PLOT NAME :

PLOT BY: mscsja

PLOT SCALE: 13.659812:1.000000

APPROVED

WISDOT/CADDS SHEET 42

GENERAL NOTES

- 1. For 3 or 4 post installations, individual post spacing shall be greater than 3'-6".
- 2. See tables below for required number of posts.
- 3. For expressways and freeways, mounting height is 7'-3'' (±) or 6'-3'' (±) depending upon existence of sub-sign.
- 4. The (±) tolerance for mounting height is 3 inches.
- 5. J-Assemblies are considered to be one sign for mounting height.
- 6. Offset distance shall be consistent with existing signs or consistent throughout length of project.
- 7. Folding signs shall be mounted at a height of 5'-3'' (\pm) or as directed by the engineer.
- 8. The Double Arrow sign (W12-1) shall be mounted at a height of 2'-3" (±). The Chevron sign (W1-8). Roundabout Chevron panel (R6-4B), Clearance Markers (W5-52), Mile Markers (D10 series), In Road Object Markers (W5-54) & End of Road Markers (W5-56) shall be mounted at a height of 4''-3'' (±).
- * 6 feet from edge of a paved shoulder or 12 feet from the edge of pavement (edge line location) or 2 feet from outside edge of gravel, whichever is greater unless directed by project engineer.
- ** The existence of curb and gutter does not in itself mandate the vertical clearance illustrated. That height is typically measured where there is sidewalk adjacent to the roadway or parking is permitted. In the absence of sidewalk vertical clearance is measured from the top of the curb. Offset of signs is measured from the flow line.
- ** See A4-3 sign plate for signs 4' or less in width and less than 20 S.F. in area.

POST EMBEDMENT DEPTH

D
(Min)
4'
5'

WISCONSIN DEPT OF TRANSPORTATION APPROVED For State Traffic Engineer DATE 8/21/17 PLATE NO. <u>A4-4.15</u>





	SIGN SHAPE OTHER THAN (TWO POSTS REQUIRED		
	L	E	
***	Greater than 48" Less than 60"	12"	
	60" to 108"	L/5	

HWY:

SIGN SHAPE OTHER THAN (THREE POSTS REQUIR	
L	E
Greater than 108" to 144"	12''

COUNTY:

FILE NAME : C:\CAEfiles\Projects\tr_stdplate\A44.DGN

PROJECT NO:

PLOT DATE: 21-AUG-2017 15:54

PLOT SCALE: 108.188297:1.000000


WISDOT/CADDS SHEET 42

OF TYPE II SIGNS ON MULTIPLE POSTS

TYPICAL INSTALLATION

SHEET NO:

PLOT BY: \$\$...plotuser...\$\$ PLOT NAME:

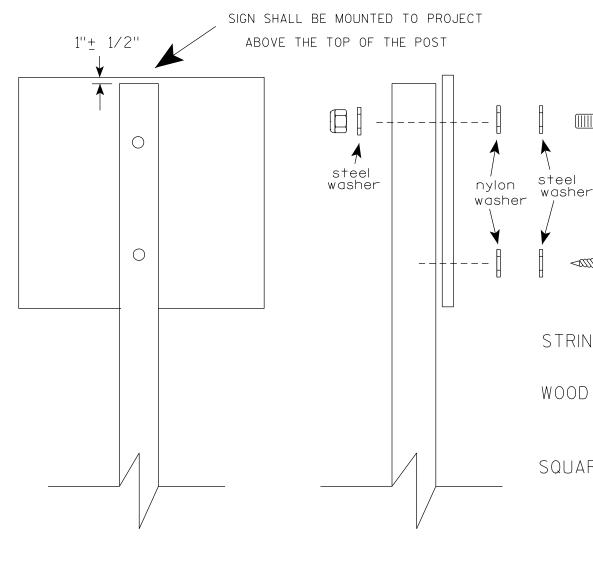

Nuts, bolts and lags used for mounting signs shall have hexagonal heads and shall be either:

- a. Hot dip galvanized in accordance with ASTM Designation: A 153, Class D, or SC 3
- b. Electro-galvanized in accordance with ASTM Designation: B 633, TYPE III, SC 3.

Threads on bolts and nuts shall be manufactured with sufficient allowance for the cadmium plate or galvanized coating to permit the nuts to run freely on the bolts.

STRINGER BOLTING TO ALUMINUM SIGNS (SEE SIGN PLATE A4-18)

MACHINE BOLTS - $\frac{5}{16}$ " X 1-3/4" Length w/ lock nuts

WOOD POSTS $(4" \times 6")$

LAG SCREWS - 3/8" X 3" (NO STRINGERS ON BACK OF SIGN)
3/8" X 4" (STRINGERS ON BACK OF SIGN)

SQUARE STEEL POSTS (2" x 2")

MACHINE BOLTS - 3/8" X 3-1/4" Length w/ nuts (NO STRINGER ON BACK OF SIGN) 3/8" X 5" Length w/ nuts (STRINGERS ON BACK OF SIGN)

RIVETS - $\frac{1}{32}$ " (6605-9-6) BULB-TITE, TRI-FOLD, ALUMINUM BODY/MANDREL O.D. FLANGE .720-.765 INCH, GRIP RANGE .042-.375 INCH

WASHERS (ALL POSTS) -

1-1/4" O.D. X $\frac{3}{8}$ " I.D. X $\frac{1}{16}$ " STEEL 1-1/4" O.D. X $\frac{3}{8}$ " I.D. X .080 NYLON

Two different fastening systems are shown for illustration purposes. On any individual sign, either one or the other system shall be used. Actual number of fasteners per sign varies with the sign area, but normally there are two. For a single post installation, all signs greater than 9 sq. ft. require the use of 3 fasteners.

ATTACHMENT OF SIGNS
TO POSTS

WISCONSIN DEPT OF TRANSPORTATION

APPROVED Matthew

For State Traffic Engineer

SHEET NO:

DATE <u>4/1/202</u>0

PLATE NO. <u>44-8.9</u>

PROJECT NO:

PLOT DATE: 01-APRIL-2020

PLOT BY : dotc4c

WISDOT/CADDS SHEET 42

Ε

FILE NAME : C:\CAEFiles\Projects\tr_stdplate\A48.DGN



PROJECT NO: HWY: COUNTY: SHEET NO: FILE NAME : C:\CAEFiles\Projects\tr_stdplate\A49.DGN PLOT DATE: 05-FEB-2015 17:09 PLOT BY: mscsja PLOT NAME : PLOT SCALE: 13.659812:1.000000


DATE 2/05/15

PLATE NO. <u>A4-9.9</u>


For State Traffic Engineer




BANDING

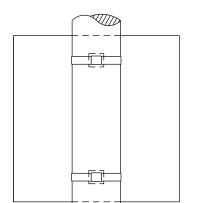


SINGLE SIGN

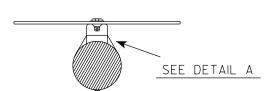

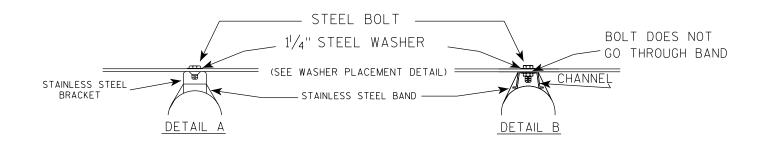

WASHER PLACEMENT

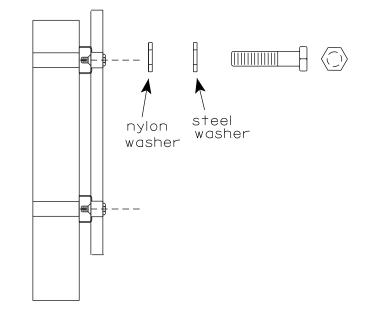

HWY:


WASHERS (ALL POSTS) -

1-1/4" O.D. X³/₈" I.D. X¹/₁₆" STEEL 1-1/4" O.D. $\times \frac{3}{8}$ " I.D. \times .080 NYLON FOR ALL TYPE H SIGNS

GENERAL NOTES

- 1. Any sign over 3 feet in width shall use the V-Block banding method. See A5-10 standard plate.
- 2. Signs 3 feet or greater in height shall have three bracket bands installed. Signs less than 3 feet in height shall have two bracket bands installed.
- 3. Banding and assembly bracket shall be stainless steel. All bands shall be $\frac{3}{4}$ " in width and 0.025" thickness.
- 4. ALL SIGN MOUNTING BOLTS AND WASHERS SHALL BE EITHER:
 - a. Hot dip or mechanically galvanized in accordance with ASTM Designation: A 153, Class D
 - b. Electro-galvanized in accordance with ASTM designation: B 633, Type III, SC 3

"J" ASSEMBLY

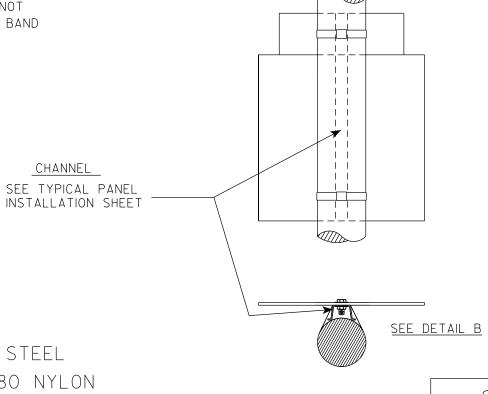

STANDARD SIGN SIGN BANDING DETAILS

WISCONSIN DEPT OF TRANSPORTATION

SHEET NO:

State Traffic Engineer

Ε

APPROVED

DATE 6/10/19 PLATE NO. A5-9.4

COUNTY:

PLOT DATE: 10-JUN 2019 4:10

PLOT NAME :


PLOT SCALE: \$\$.....plotscale.....\$\$ WISDOT/CADDS SHEET 42


FILE NAME : C:\CAEfiles\Projects\tr_stdplate\A59.dgn

PROJECT NO:

PLOT BY: mscj9h

CHANNEL

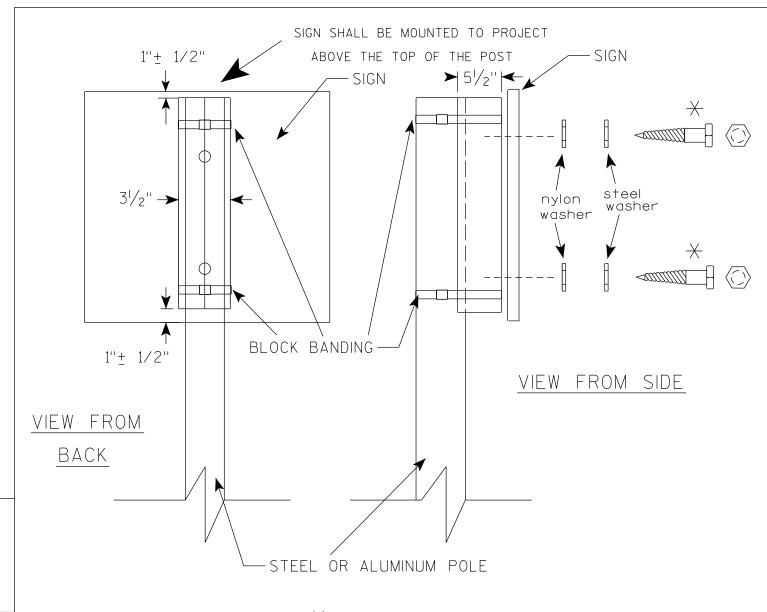

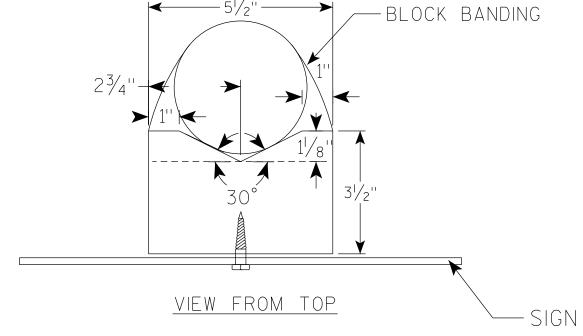

GENERAL NOTES

- 1. WOOD 4"X6" POST MATERIAL SHALL CONFORM TO 507.2.2 OF THE WISDOT STANDARD SPECIFICATIONS
- 2. BLOCK BANDING AND CLIPS SHALL BE STAINLESS STEEL, $\frac{3}{4}$ " WIDTH AND 0.025" THICKNESS
- 3. SIGNS 3' OR GREATER IN HEIGHT SHALL UTILIZE 3 BLOCK BANDS.

 SIGNS UNDER 3' IN HEIGHT SHALL UTILIZE 2 BLOCK BANDS
- 4. ACTUAL NUMBER OF FASTENERS PER SIGN VARIES WITH THE SIGN AREA, BUT NORNALLY THERE ARE TWO. FOR SIGNS GREATER THAN 9 S.F. 3 FASTENERS SHALL BE USED.
- 5. ALL SIGN MOUNTING BOLTS AND WASHERS SHALL BE EITHER:
 - a. Hot dip or mechanically galvanized in accordance with ASTM Designation: A 153, Class D
 - b. Electro-galvanized in accordance with ASTM Designation: B 633, TYPE III, SC 3
- 6. ALL BOLTS SHALL HAVE HEXAGONAL HEADS.
- 7. STEEL WASHERS SHALL BE $1\frac{1}{4}$ " O.D. X $\frac{3}{8}$ " I.D. X $\frac{1}{16}$ "
- 8. NYLON WASHERS SHALL BE $1^{1}/_{4}$ " O.D. X $\frac{3}{8}$ " I.D. X .080 FOR TYPE H OR TYPE F FACE SIGN

 \rightarrow LAG BOLTS SHALL BE $\frac{3}{8}$ " X $2\frac{1}{2}$ "

BLOCK BANDING DETAIL (V-BLOCK OPTION)

WISCONSIN DEPT OF TRANSPORTATION

| APPROVED

For State Traffic Engineer

SHEET NO:

Matthew R

DATE 6/10/19

PLATE NO. _A5-10.2

PROJECT NO:

FILE NAME: C:\CAEfiles\Projects\tr_stdplate\A510.dgn

PLOT DATE: 10-JUN 2019 4:15

PLOT BY: mscj9h

WISDOT/CADDS SHEET 42

- 1. Sign is Type II Type H reflective
- 2. Color:

Background - Green Message - White

- 3. Message Series E
- 4. Corners may be square or rounded when base material is plywood but borders shall be rounded as shown. When base material is metal, the corners and borders shall be rounded.
- 5. When Base material for this sign is plywood sign shall be split into two seperate pieces for the 72 x 60 size as shown on the detail by the dashed line (-----).
- 6. Arrow is Type "A" from sign plate A1-1.
- 7. As per the Standard Spec's, this sign shall not have a vertical joint.
- 8. Size 3 E5-1 shall only be used in a Work Zone application with a Temporary Sign Support

C + E					G F H	
						B
	N N	——————————————————————————————————————	*	← P —		

SIZE	А	В	C	ט	L L	F	G	Н	I	J	K	L	M	N	Ü	Р	u	R	S	T	U	V	l W	X	Y	Z	sq. ft.
1																											
2																											
3	48	48	6		1	10	6 1/8	5 1/8	18 1/2	6 3/4	8 1/2	31 1/8	8 3/8	11 1/2	27	9 1/2	30°	30									16.0
4	60	48	6		1	10	6 %	5 1/8	18 1/2	6 3/4	10 %	40 3/4	8 5/8	17 1/2	27	15 1/2	30°	30									20.0
5	72	60	6		1	12	9 3/4	10	18 1/2	9 3/4	13 1/4	48 1/2	10 1/4	23 1/2	27	21 1/2	30°	30									30.0

COUNTY:

STANDARD SIGN E5-1

WISCONSIN DEPT OF TRANSPORTATION

APPROVED

Matthew & Rauch

For State Traffic Engineer

DATE 7/26/18 PLATE NO. <u>E5-1.10</u>

SHEET NO:

Ε

FILE NAME : C:\CAEfiles\Projects\tr_stdplate\E51.dgn

HWY:

PROJECT NO:

PLOT DATE: 26-JUL-2018 12:37

PLOT BY: mscj9h

PLOT NAME :

PLOT SCALE: \$\$.....plotscale.....\$\$ WISDOT/CADDS SHEET 42

NOTES

1. Sign is Type II - Type F Reflective - reference WIS DOT Standard Specification for HIGHWAY and STRUCTURE CONSTRUCTION latest edition.

2. Color:

Background - Orange Message - Black

- 3. Message Series C
- 4. Corners may be square or rounded when base material is plywood but borders shall be rounded as shown. When base material is metal, the corners and borders shall be rounded.



Metric equivalent for this sign is:

SIZE	Α	В	С	D	E	F	G	Н	I	J	К	L	М	N	0	Р	Q	R	S	T	U	٧	W	Х	Y	Z	Area sq. ft.	Area m2
1	36	18	1 1/8	3/8	1/2	4	3 3/4	2 1/2	4 1/8	4 1/8	11 1/8	2	1	12 1/8													4.5	0.41
2	48	24	1 1/2	1/2	5/8	6	4 1/2	3 3/4	5 %	6 3/4	16 ¾	2 1/2	1 3/4	18 ½													8.0	0.72
3	48	24	1 1/2	1/2	5/8	6	4 1/2	3 3/4	5 %	6 3/4	16 ¾	2 1/2	1 3/4	18 ½													8.0	0.72
4	48	24	1 1/2	1/2	5/8	6	4 1/2	3 3/4	5 %	6 3/4	16 ¾	2 1/2	1 3/4	18 ½													8.0	0.72
5	48	24	1 1/2	1/2	5/8	6	4 1/2	3 3/4	5 1/8	6 3/4	16 ¾	2 1/2	1 3/4	18 ½													8.0	0.72

COUNTY:

STANDARD SIGN G20-2A

WISCONSIN DEPT OF TRANSPORTATION

APPROVED 400 110 00 00 110

For State Traffic Engineer

DATE 9/30/09 PLATE NO. G20-2A.8

SHEET NO:

FILE NAME : C:\Users\PROJECTS\tr_stdplate\G202A.DGN

HWY:

PROJECT NO:

PLOT DATE: 30-SEP-2009 09:31

PLOT BY : ditjph

PLOT NAME :

PLOT SCALE : 5.561773:1.000000

5.561773:1.000000 WISDOT/CADDS SHEET 42

NOTES

- 1. Sign is Type II Type H Reflective reference WIS DOT Standard Specification for HIGHWAY and STRUCTURE CONSTRUCTION latest edition.
- 2. Color:

Background - White Message - See note 5

3. Message Series - C

PLOT NAME :

- 4. Corners may be square or rounded when base material is plywood but borders shall be rounded as shown. When base material is metal, the corners and borders shall be rounded.
- 5. The border strip and word message are reflectorized red.

A	
	G
	\\\\\\\\\\\\\\\\\\\\\\\\\\\\\\\\\\\\\
E	 B
D D	
R1-2	

SIZE	Α	В	С	D	E	F	G	н	I	J	K	L	М	N	0	Р	0	R	S	Т	U	V	W	Х	Y	Z	Area sq. ft.
1	30	26	1 1/2	5/8	4	2 1/2	6 3/8	7 ⁄8	4	3 %																	2.71
25	36	31	2	3/4	5	3	7 3/4	1 1/4	4 3/4	4 3/8																	3.88
2M	48	42	3	1	6	4	9 3/4	2	6 1/4	5 %																	7.00
3	48	42	3	1	6	4	9 3/4	2	6 1/4	5 %																	7.00
4	48	42	3	1	6	4	9 3/4	2	6 1/4	5 %																	7.00
5	60	52	3	1 1/2	8	5	13	2 1/2	7 1/8	7 1/4																	10.83
6																											
7	18	15 1/2	1	3/8	2 1/2	1 1/2	3 1/8	5/8	2 3/8	2 1/4																	0.97

COUNTY:

STANDARD SIGN R1-2

WISCONSIN DEPT OF TRANSPORTATION

APPROVED

Matthew & Rauch

 f_{or} State Traffic Engineer

3/14 PLATE NO. R1-2.12


DATE 10/13/14 PLA

SHEET NO:

311221

PROJECT NO:

HWY:

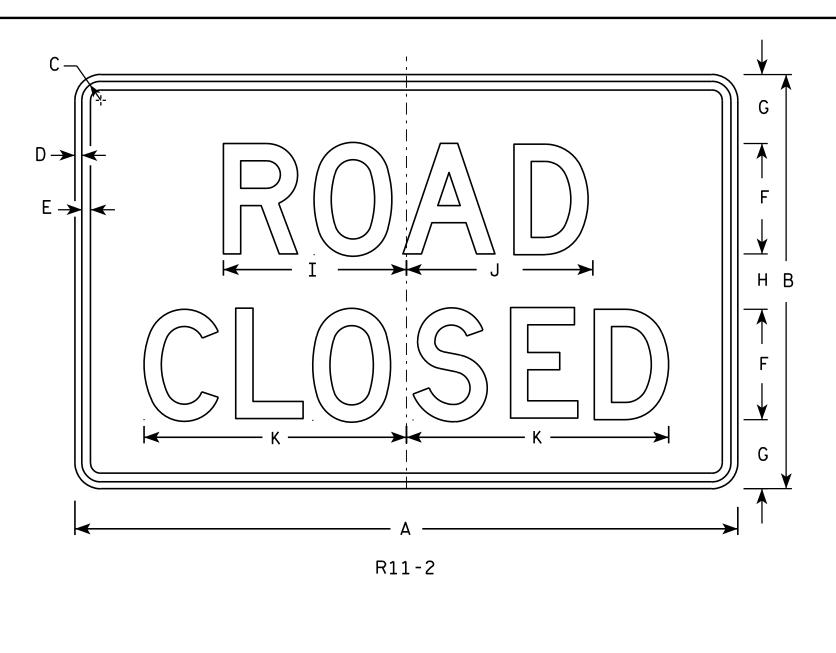



<u>NOTES</u>

- 1. Sign is Type II Type H Reflective reference WIS DOT Standard Specification for HIGHWAY and STRUCTURE CONSTRUCTION latest edition.
- 2. Color:

Background - White Message - Black

- 3. Message Series D
- 4. Corners may be square or rounded when base material is plywood but borders shall be rounded as shown. When base material is metal, the corners and borders shall be rounded.
- 5. Modify the message as required.

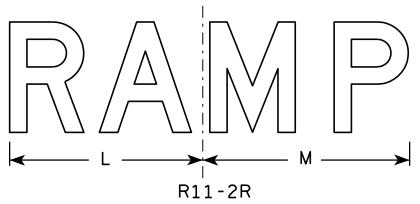

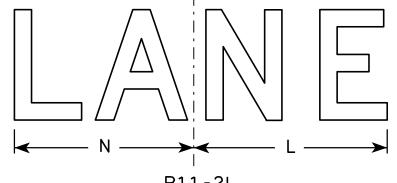

R	1	1	-	2	L

PLOT NAME :

SIZ	Έ	A	В	С	D	Ε	F	G	Н	I	J	K	L	M	N	0	Р	0	R	S	T	U	v	W	X	Y	Z	Area sq. ft.
1																												
2	S	48	30	1 3/8	1/2	5/8	8	5	4	13 1/4	13 1/2	19	14	15	13													10.0
21	I	48	30	1 3/8	1/2	5/8	8	5	4	13 1/4	13 ½	19	14	15	13													10.0
3		48	30	1 3/8	1/2	5/8	8	5	4	13 1/4	13 1/2	19	14	15	13													10.0
4		48	30	1 3/8	1/2	5/8	8	5	4	13 1/4	13 1/2	19	14	15	13													10.0
5		48	30	1 3/8	1/2	5/8	8	5	4	13 1/4	13 ½	19	14	15	13													10.0

COUNTY:

STANDARD SIGN R11-2

WISCONSIN DEPT OF TRANSPORTATION

DATE 4/1/11 PLATE NO. R11-2.10

SHEET NO:

HWY:


PROJECT NO:


NOTES

- 1. Sign is Type II Type F Reflective
- 2. Color:

Background – Orange Message – Black

- 3. Message Series C
- 4. Corners may be square or rounded when base material is plywood but borders shall be rounded as shown. When base material is metal, the corners and borders shall be rounded.

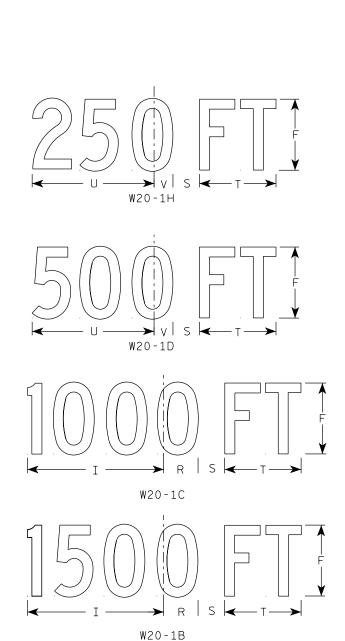

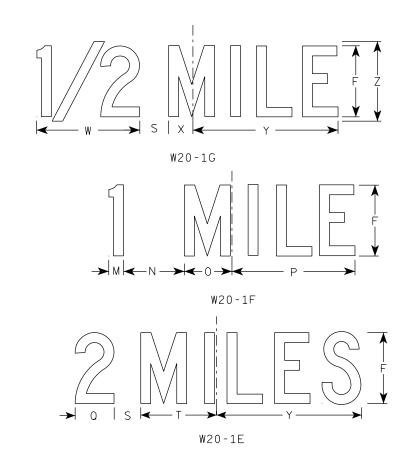

SIZE	А	В	С	D	E	F	G	H I	J	K	_ M	N	0	Р	Q	R	S	Т	U	٧	W	X	Y	Z	Area sq. ft.
1	36		1 5/8	5/8	3/4	5	2 5/8	3 1/4 10 1/8	7	7 % 8	7/8 1 1/8	4 1/2	3 1/2	9	3 1/4	2 1/2	2 1/4	5 %	9	$1 \frac{3}{8}$	8	1 3/4	10 3/4	6	9.0
25	48		2 1/4	3/4	1	8	3 3/4	5 1/8 15 3/8	11 1/8	12 1/8 14	3/8 1 5/8	6 1/8	5 3/8	13 1/8	4 3/8	3 1/8	3	8 %	13 ¾	2 1/8	11 1/8	2 3/4	16 3/8	9	16.0
2M	48		2 1/4	3/4	1	8	3 3/4	5 1/8 15 3/8	11 1/8	12 1/8 14	3/8 1 5/8	6 1/8	5 3/8	13 1/8	4 3/8	3 1/8	3	8 %	13 3/4	2 1/8	11 1/8	2 3/4	16 3/8	9	16.0
3	48		2 1/4	3/4	1	8	3 3/4	5 1/8 15 3/8	11 1/8	12 1/8 14	3/8 1 5/8	6 1/8	5 3/8	13 1/8	4 3/8	3 1/8	3	8 %	13 ¾	2 1/8	11 1/8	2 3/4	16 3/8	9	16.0
4	48		2 1/4	3/4	1	8	3 3/4	5 1/8 15 3/8	11 1/8	12 1/8 14	3/8 1 5/8	6 1/8	5 3/8	13 1/8	4 3/8	3 1/8	3	8	13 3/4	2 1/8	11 1/8	2 3/4	16 3/8	9	16.0
5	48		2 1/4	3/4	1	8	3 3/4	5 1/8 15 3/8	11 1/8	12 1/8 14	3/8 1 5/8	6 1/8	5 3/8	13 1/8	4 3/8	3 1/8	3	8 5/8	13 ¾	2 1/8	11 1/8	2 3/4	16 3/8	9	16.0

STANDARD SIGN W20-1A, B, C, D, E, F, G & H

WISCONSIN DEPT OF TRANSPORTATION

APPROVED Matthew R Rauch

 f_{or} State Traffic Engineer
DATE 3/25/2020 PLATE NO. W20-1.11

SHEET NO:

FILE NAME : C:\CAEfiles\Projects\tr_stdplate\W201.DGN

PROJECT NO:

W20-1A

PLOT DATE: 25-MARCH-2020

PLOT BY : dotc4c

WISDOT/CADDS SHEET 42

NOTES

- 1. Sign is Type II Type F Reflective reference WIS DOT Standard Specification for HIGHWAY and STRUCTURE CONSTRUCTION latest edition.
- 2. Color:

Background - Orange Message - Black

3. Corners may be square or rounded when base material is plywood but borders shall be rounded as shown. When base material is metal, the corners and borders shall be rounded.

	G
	¥ B
W01-6	

SIZE	Α	В	С	D	E	F	G	Н	I	J	К	L	M	N	0	Р	0	R	S	Т	U	٧	W	Х	Y	Z	Areg sq. ft.
1																											
2S	48	24	1 3/8	1/2	5/8		12	13 1/4	1	7 1/2	6 1/2	3 1/4	19 1/2	39													8.0
2M	48	24	1 3/8	1/2	5/8		12	13 1/4	1	7 1/2	6 1/2	3 1/4	19 1/2	39													8.0
3	60	30	1 3/8	1/2	5/8		15	16 1/4	1 1/4	9 1/4	8	4	24 3/8	48 3/4													12.5
4	60	30	1 3/8	1/2	5/8		15	16 1/4	1 1/4	9 1/4	8	4	24 3/8	48 ¾													12.5
5	60	30	1 3/8	1/2	5/8		15	16 1/4	1 1/4	9 1/4	8	4	24 3/8	48 ¾													12.5

COUNTY:

STANDARD SIGN WO1-6

WISCONSIN DEPT OF TRANSPORTATION

APPROVED

Matther R Rauch
For State Traffic Engineer

For State Traffic Engineer

13 PLATE NO. <u>W01-6.1</u>

DATE <u>11/18/13</u>

SHEET NO:

FILE NAME : C:\CAEfiles\Projects\tr_stdplate\W016.DGN

HWY:

PROJECT NO:


PLOT DATE: 28-FEB-2014 11:37

PLOT NAME :

PLOT BY: mscj9h

PLOT SCALE: 5.837526:1.000000

WISDOT/CADDS SHEET 42

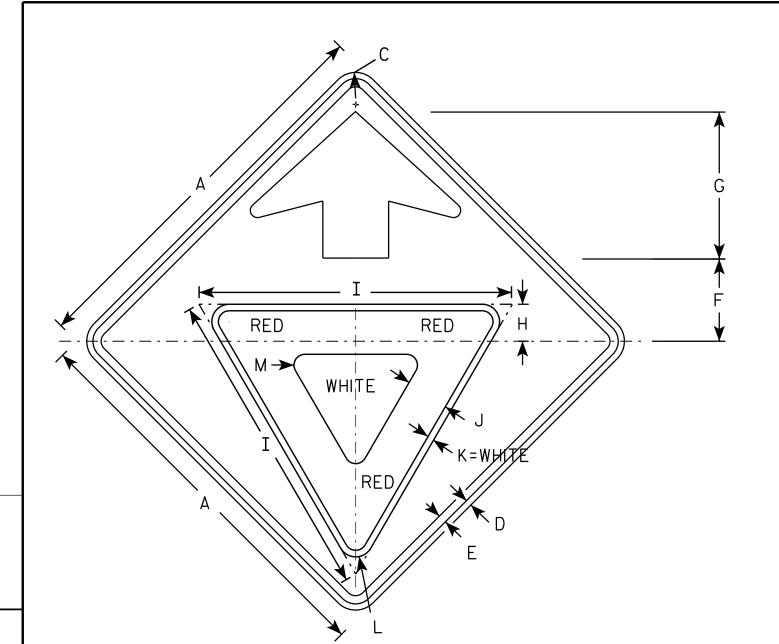


W03-2

NOTES

- 1. All Signs Type II Type F Reflective reference WIS DOT Standard Specification for HIGHWAY and STRUCTURE CONSTRUCTION latest edition.
- 2. Color:

Background - ORANGE Arrow & Border - BLACK Yield Symbol - WHITE BORDER ON RED BACKGROUND

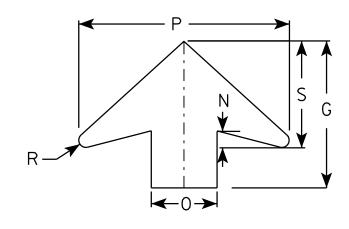

ARROW DETAIL

PLOT BY: mscsja

SIZE	Α	В	С	D	Ε	F	G	Н	I	J	K	L	M	N	0	Р	0	R	S	Т	U	V	W	Х	Y	Z	Area sq. ft.
1	36		1 5/8	5/8	3/4	7 1/2	13 1/2	3 3/8	28	3 3/4	5/8	1 1/2	1	1 %	6	19 1/4		5/8	9 3/4								9.0
2S	48		2 1/4	3/4	1	10	17 1/8	4 1/2	38	5	3/4	2 1/8	1 3/8	2	8	25 %		7 /8	13								16.0
2M	48		2 1/4	3/4	1	10	17 1/8	4 1/2	38	5	3/4	2 1/8	1 3/8	2	8	25 %		7 /8	13								16.0
3	48		2 1/4	3/4	1	10	17 1/8	4 1/2	38	5	3/4	2 1/8	1 3/8	2	8	25 %		<i>7</i> ⁄8	13								16.0
4	48		2 1/4	3/4	1	10	17 1/8	4 1/2	38	5	3/4	2 1/8	1 3/8	2	8	25 %		<i>7</i> ⁄8	13								16.0
5	48		2 1/4	3∕4	1	10	17 1/8	4 1/2	38	5	3/4	2 1/8	1 3/8	2	8	25 %		7 /8	13								16.0

STANDARD SIGN WO3-2

WISCONSIN DEPT OF TRANSPORTATION

APPROVE

For State Traffic Engineer

DATE 11/20/13

SHEET NO:

FILE NAME : C:\CAEFiles\Projects\tr_stdplate\W032.DGN

PROJECT NO:

PLATE NO. W03-2.1



Wisconsin Department of Transportation

Dedicated people creating transportation solutions through innovation and exceptional service.

http://www.dot.wisconsin.gov