	COUNTY:
TRE	CLARK,
TREMPEALEAL	PIERCE
	AND

MAR 2017 ORDER OF SHEETS

Section No. 7

Section No. 8

Section No. 1 Title

Typical Sections and Details Section No. 2 Estimate of Quantities Section No. 3 Miscellaneous Quantities Section No. 3 Right of Way Plat Section No. 4 Plan and Profile Section No. 5 Section No. 6 Standard Detail Drawings

Sign Plates

Section No. 9 Computer Earthwork Data

Structure Plans

STATE OF WISCONSIN DEPARTMENT OF TRANSPORTATION

STATE HIGHWAY REHABILITATION-MAINTENANCE PROJECT

CTATE DDO IFCT	FEDERAL PR	OJECT
STATE PROJECT	PROJECT	CONTRACT
1520-05-60		
1530-05-60		
1630-00-60		
7150-00-60		
7210-00-60		

TOTAL SHEETS = 212

Section No. 9 Cross Sections

PITTSVILLE - NEILLSVILLE

(EAST COUNTY LINE TO STH 95)

STH 73 CLARK COUNTY

> STATE PROJECT NUMBER 1520-05-60

ELLSWORTH - DURAND

(CTH A TO CTH P)

USH 10 PIERCE COUNTY

> STATE PROJECT NUMBER 1530-05-60

GALESVILLE - WHITEHALL

(CTH C TO NORTH JUNCTION STH 95)

USH 53 TREMPEALEAU COUNTY

> STATE PROJECT NUMBER 1630-00-60

ELLSWORTH - BALDWIN

(USH 10 TO SOUTH JUNCTION STH 29)

USH 63 PIERCE COUNTY

> STATE PROJECT NUMBER 7210-00-60



= N/A

= N/A

= N/A

= N/A = N/A

= N/A

= N/A

DESIGN DESIGNATION

A.A.D.T.

A.A.D.T.

DESIGN SPEED

D.H.V.

ESALS


D.D.


TREMPEALEAU - FOUNTAIN CITY

(STH 93 TO WEST COUNTY LINE)

STH 35 TREMPEALEAU COUNTY

> STATE PROJECT NUMBER 7150-00-60

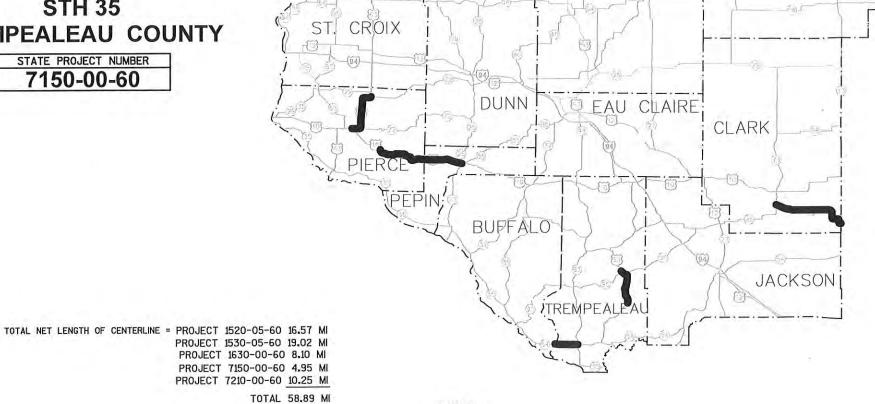

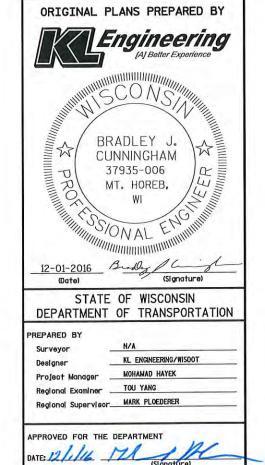

LAYOUT

PLOT DATE: 12/1/2016 9:41 AM

PLOT BY : BRAD CUNNINGHAM

2

GENERAL NOTES

THE ENGINEER WILL DETERMINE ANY DETAILS OF CONSTRUCTION NOT SHOWN ON THE PLAN.

ALL WASTE MATERIAL RESULTING FROM THE VARIOUS OPERATIONS UNDER THIS CONTRACT SHALL BE COLLECTED TO BE PROPERLY DISPOSED OF PRIOR TO REOPENING LANES TO TRAFFIC.

THE LOCATION OF EXISTING AND PROPOSED UTILITY INSTALLATIONS AS SHOWN ON THE PLANS ARE APPROXIMATE. THERE MAY BE OTHER UTILITY INSTALLATIONS WITHIN THE PROJECT AREA THAT ARE NOT SHOWN.

WHEN AN EXISTING STOP SIGN/SUPPORT IS TO BE REMOVED AND A NEW STOP SIGN/SUPPORT ERECTED, THE WORK SHALL BE DONE CONCURRENTLY. FOR ALL OTHER SIGNS THE REMOVAL OF THE EXISTING SIGN/SUPPORT AND ERECTION OF THE NEW SIGN/SUPPORT SHOULD BE DONE AS CONCURRENTLY AS POSSIBLE. IN NO CASE SHALL A NEW SIGN/SUPPORT BE DOWN FOR MORE THAN 24 HOURS AND THERE SHALL NOT BE MORE THAN ONE SIGN OF THE SAME LEGEND MISSING IN A ROW.

WOOD POST SIZES, FOR TYPE II SIGNING, ARE ESTIMATED LENGTHS AND THE ACTUAL LENGTH WILL BE DETERMINED IN THE FIELD.

THE NUMBER OF "NO PASSING ZONE" SIGNS (W-14-3) ARE ESTIMATED AND THE ACTUAL NUMBER WILL BE DETERMINED AFTER THE ROADWAYS HAVE BEEN SPOTTED.

NORTHWEST REGION TRAFFIC CONTACT

CHLOE ANDERSON
WISCONSIN DEPARTMENT OF TRANSPORTATION
5009 USH 53 SOUTH
EAU CLAIRE, WI 54701
PHONE: (715) 855-7672
CELL: (715) 577-4493

NORTHWEST REGION DNR CONTACTS

(CLARK, PEPIN AND PIERCE COUNTY) CHRIS WILLGER DNR WEST CENTRAL REGION HQ 1300 W. CLAIREMONT STREET EAU CLAIRE, WI 54702 PHONE: (715) 839-1609

(TREMPEALEAU COUNTY)
KAREN KALVELAGE
DNR SERVICE CENTRAL
3550 MORMON COULEE ROAD
LA CROSSE, WI 54601
PHONE: (608) 785-9115



PROJECT NO:VARIOUS HWY:VARIOUS COUNTY:VARIOUS GENERAL NOTES SHEET E


* EXISTING CENTER RUMBLE STRIPS VARIES 12' VARIES SHLD DRIVING DRIVING LANE LANE 2.0% 2.0% 4.0% .==== ==== EXISTING BASE COURSE * (USH 53 ONLY) EXISITING BASE AGGREGATE (SHOULDER) EXISTING ASPHALT PAVEMENT IN FILL IN CUT **EXISTING TYPICAL SECTION** USH 10 STH 73 STH 35 USH 53 USH 63 LIMITS OF FOG SEAL (SEE NOTE) NOTE: SCRUB OR CHIP SEAL FROM 6-INCH BEYOND SCRUB OR CHIP SEAL (SEE NOTE) DRIVING LANE TO 6-INCH BEYOND DRIVING LANE, WITH EXCEPTION OF CENTERLINE RUMBLE STRIPS. **VARIES** VARIES FOG SEAL FROM OUTSIDE EDGE OF ASPHALTIC SHLD DRIVING DRIVING SHLD LANE LANE SHOULDER TO OUTSIDE EDGE OF ASHALTIC SHOULDER, INCLUDING CENTERLINE RUMBLE STRIPS. 2.0% 2.0% 4.0% ─ EXISTING BASE COURSE PROPOSED CHIP OR SCRUB SEAL EXISITING BASE AGGREGATE (SHOULDER) ** (USH 53 ONLY) EXISTING ASPHALT PAVEMENT IN FILL IN CUT PROPOSED TYPICAL SECTION USH 10 STA 111+00 - STA 1115+15 STH 73 STA 100+00 - STA 973+94 EXISTING CENTERLINE RUMBLE STRIPS. STH 35 STA 100+60 - STA 362+10 FOG SEAL ONLY USH 53 STA 111+42 - STA 539+09 USH 63 STA 110+55 - STA 651+52

PROJECT NO: VARIOUS

HWY: VARIOUS

COUNTY: VARIOUS

TYPICAL SECTIONS

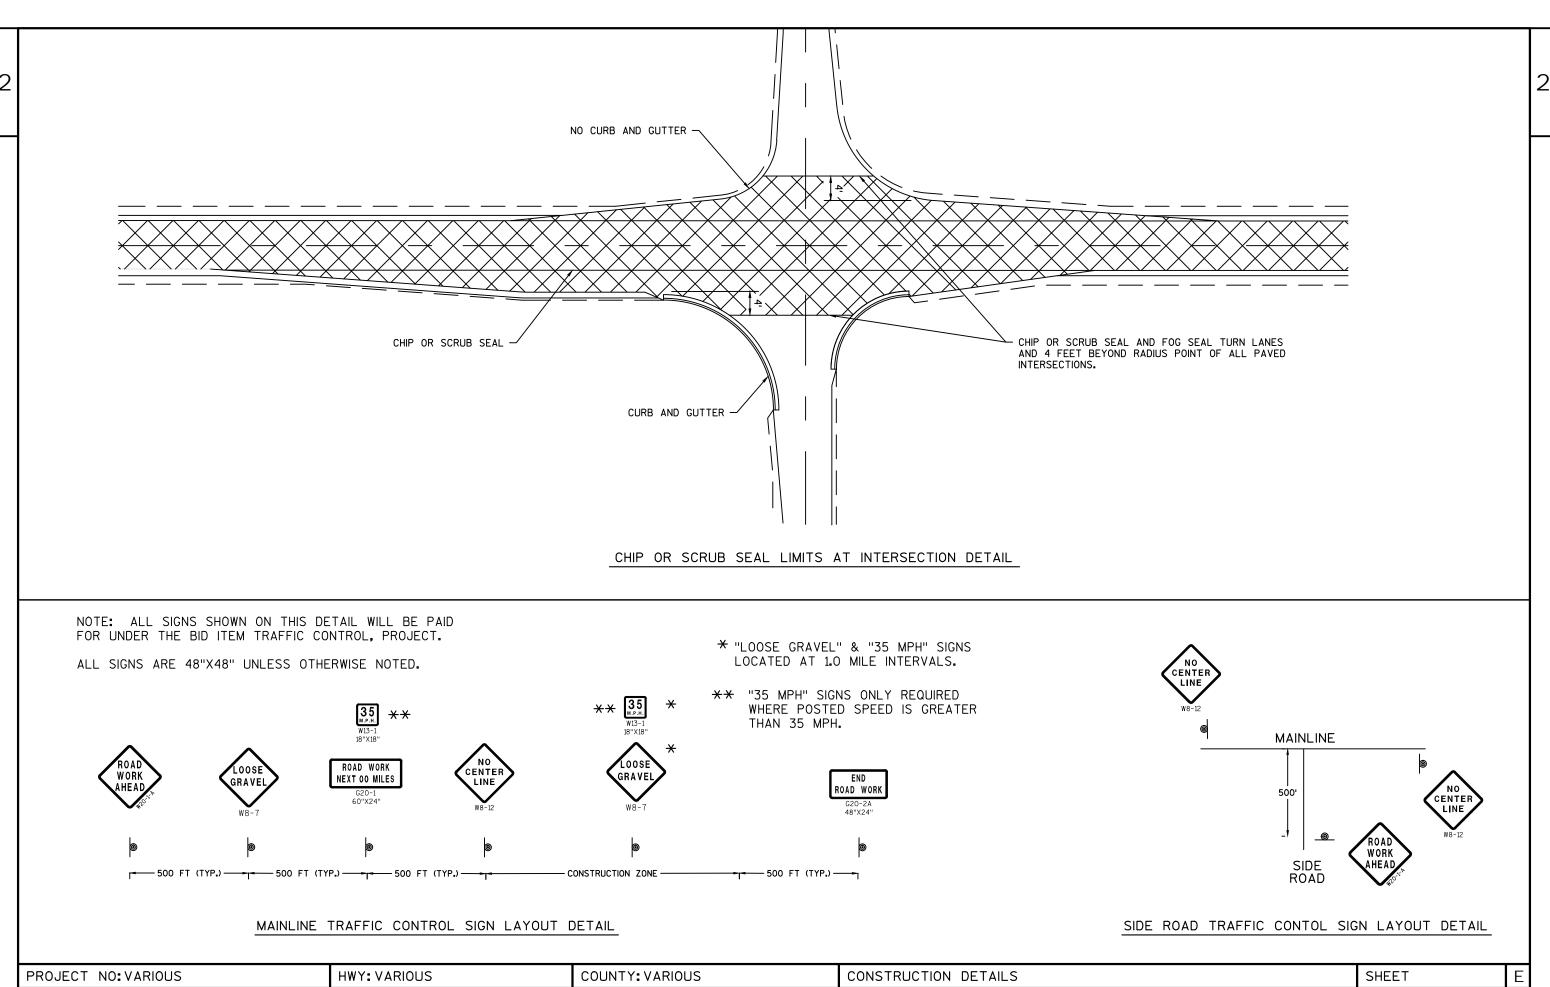

FILE NAME : G:\WDOTCO\14023 (2014 - 2016 DESIGN WORK ORDERS)\14023-019\CIVIL 3D\SHEETSPLAN\PLAN DETAILS\021001-CD.DWG

PLOT DATE: 10/24/2016 3:55 PM

PLOT BY : KL ENGINEERING

PLOT SCALE : 1" = 1'

3

1520-05-60 1530-05-60 1630-00-60 7210-00-60 7150-00-60 Line **Item Description** Unit Total Qty Qty Item Qty Qty Qty 0010 213.0100 Finishing Roadway (project) 01. 1520-05-60 **EACH** 1.000 1.000 0020 213.0100 Finishing Roadway (project) 02. 1530-05-60 EACH 1.000 1.000 0030 213.0100 EACH 1.000 1.000 Finishing Roadway (project) 03. 1630-00-60 EACH 1.000 0040 213.0100 Finishing Roadway (project) 04. 7150-00-60 1.000 0050 213.0100 Finishing Roadway (project) 05. 7210-00-60 EACH 1.000 1.000 0060 618.0100 Maintenance And Repair of Haul Roads (project) 01. EACH 1.000 1.000 0070 618.0100 Maintenance And Repair of Haul Roads (project) 02. EACH 1.000 1.000 0080 618.0100 Maintenance And Repair of Haul Roads (project) 03. EACH 1.000 1.000 1.000 0090 618.0100 Maintenance And Repair of Haul Roads (project) 04. **EACH** 1.000 1.000 0100 618.0100 Maintenance And Repair of Haul Roads (project) 05. **EACH** 1.000 7210-00-60 EACH 0.320 0.340 0.130 0.080 0.130 0110 619.1000 Mobilization 1.000 5.000 5.000 5.000 0120 628.7015 Inlet Protection Type C **EACH** 25.000 5.000 5.000 0130 634.0612 Posts Wood 4x6-Inch X 12-FT EACH 8.000 8.000 0140 634.0614 Posts Wood 4x6-Inch X 14-FT **EACH** 264.000 46.000 119.000 31.000 68.000 91.000 225.000 52.000 90.000 0150 634.0616 Posts Wood 4x6-Inch X 16-FT **EACH** 458.000 0160 634.0618 Posts Wood 4x6-Inch X 18-FT **EACH** 49.000 1.000 19.000 11.000 18.000 0170 634.0620 Posts Wood 4x6-Inch X 20-FT EACH 6.000 6.000 SF 1,550.510 553.570 0180 637.2210 Signs Type II Reflective H 3,514.230 437.240 972.910 0190 637.2230 Signs Type II Reflective F 1,508.750 377.250 672.750 119.000 339.750 0200 638.2602 EACH 703.000 133.000 296.000 86.000 188.000 Removing Signs Type II **EACH** 0210 638.3000 Removing Small Sign Supports 698.000 135.000 298.000 85.000 180.000 0220 643.0100 Traffic Control (project) 01. 1520-05-60 **EACH** 1.000 1.000 643.0100 0230 Traffic Control (project) 02. 1530-05-60 EACH 1.000 1.000 1.000 0240 643.0100 Traffic Control (project) 03. 1630-00-60 **EACH** 1.000 643.0100 Traffic Control (project) 04. 7150-00-60 **EACH** 1.000 1.000 0250 EACH 1.000 0260 643.0100 Traffic Control (project) 05. 7210-00-60 1.000 0270 646.0103 Pavement Marking Paint 4-Inch LF 947,300.000 242,500.000 339,600.000 134,700.000 70,400.000 160,100.000 Pavement Marking Paint 8-Inch 0280 646.0123 LF 2,580.000 730.000 615.000 950.000 285.000 0290 Removing Pavement Markings LF 952,800.000 242,700.000 341,100.000 136,000.000 160,700.000 646.0600 72,300.000 0300 647.0166 Pavement Marking Arrows Epoxy Type 2 EACH 1.000 1.000 0310 647.0196 Pavement Marking Arrows Epoxy Type 5 **EACH** 2.000 2.000 0320 647.0356 Pavement Marking Words Epoxy EACH 1.000 1.000 LF 22.000 0330 647.0566 Pavement Marking Stop Line Epoxy 18-Inch 67.000 45.000 LF 45.000 0340 647.0726 Pavement Marking Diagonal Epoxy 12-Inch 45.000 0350 647.0955 Removing Pavement Markings Arrows **EACH** 3.000 2.000 1.000 0360 647.0965 Removing Pavement Markings Words EACH 1.000 1.000

3

					1520-05-60	1530-05-60	1630-00-60	7150-00-60	7210-00-60
Line	Item	Item Description	Unit	Total	Qty	Qty	Qty	Qty	Qty
0370	648.0100	Locating No-Passing Zones	MI	61.820	19.500	19.020	8.100	4.950	10.250
0380	649.0402	Temporary Pavement Marking Paint 4-Inch	LF	75,895.000		6,175.000	50,500.000	19,220.000	
0390	649.2102	Temporary Raised Pavement Markers Type II	EACH	82,100.000	21,400.000	29,000.000	11,800.000	5,500.000	14,400.000
0400	SPV.0180	Special 01. Chip Seal	SY	225,500.000				74,600.000	150,900.000
0410	SPV.0180	Special 02. Scrub Seal	SY	699,900.000	243,000.000	326,100.000	130,800.000		
0420	SPV.0180	Special 03. Fog Seal	SY	1,104,300.000	291,500.000	379,400.000	154,400.000	98,500.000	180,500.000

		FINISHING ROADWAY (1520-05-	<u>60)</u>			MAINTENANCE	E AND REPAIR OF H	IAUL ROADS (1	<u>520-05-60)</u>				TRAFFIC CON	TROL (1520-05-60)		
_	CAT	STATION TO STATION LOCATION	643.0100 EACH	REMARKS	CAT	STATION TO	STATION LC	OCATION	643.0100 EACH	REMARKS	CAT	STATION	TO STATION	LOCATION	643.0100 EACH	REMARKS
	0010	100+00 - 973+94 STH 73 TOTAL PROJECT ID 1520-05-60	1	=	0010	100+00 - TOTAL PRO	973+94 S	STH 73 ==	1	=	0010	100+00 TO	- 973+94 TAL PROJECT ID 1520	STH 73 =	1	=
		FINISHING ROADWAY (1530-05-	<u>60)</u>			MAINTENANCE	E AND REPAIR OF H	IAUL ROADS (1	530-05-60)				TRAFFIC CON	TROL (1530-05-60)		
_	CAT	STATION TO STATION LOCATION	643.0100 EACH	REMARKS	CAT	STATION TO	STATION LC	OCATION	643.0100 EACH	REMARKS	CAT	STATION	TO STATION	LOCATION	643.0100 EACH	REMARKS
	0010	111+00 - 1115+15 USH 10	1	_	0010	111+00 -	1115+15 l	USH 10	1		0010	111+00	- 1115+15	USH 10	1	
		TOTAL PROJECT ID 1530-05-60	1	=		TOTAL PRO	DJECT ID 1530-05-60	_	1	=		ТО	TAL PROJECT ID 1530	-05-60	1	=
		FINISHING ROADWAY (1630-00-	<u>60)</u>			MAINTENANCE	E AND REPAIR OF H	IAUL ROADS (1	630-00-60)				TRAFFIC CON	FROL (1630-00-60)		
_	CAT	STATION TO STATION LOCATION	643.0100 EACH	REMARKS	CAT	STATION TO	STATION LC	OCATION	643.0100 EACH	REMARKS	CAT	STATION	TO STATION	LOCATION	643.0100 EACH	REMARKS
	0010	111+42 - 539+09 USH 53	1		0010	111+42 -	539+09 l	USH 53	1		0010	111+42	- 539+09	USH 53	1	
•		TOTAL PROJECT ID 1630-00-60	1	=		TOTAL PRO	DJECT ID 1630-00-60		1	=		ТО	TAL PROJECT ID 1630	-00-60	1	=
		FINISHING ROADWAY (7150-00-	60)			MAINTENANCE	E AND REPAIR OF H	IAUL ROADS (7	<u>150-00-60)</u>				TRAFFIC CON	TROL (7150-00-60)		
_	CAT	STATION TO STATION LOCATION	643.0100 EACH	REMARKS	CAT	STATION TO	STATION LC	OCATION	643.0100 EACH	REMARKS	CAT	STATION	TO STATION	LOCATION	643.0100 EACH	REMARKS
	0010	100+60 - 362+10 STH 35	1		0010	100+60 -	362+10	STH 35	1		0010	100+60	- 362+10	STH 35	1	
		TOTAL PROJECT ID 7150-00-60	1	=		TOTAL PRO	DJECT ID 7150-00-60	_	1	=		то	TAL PROJECT ID 7150	-00-60	1	=
		FINISHING ROADWAY (7210-00-	<u>60)</u>			MAINTENANCE	E AND REPAIR OF H	IAUL ROADS (7	210-00-60)				TRAFFIC CON	FROL (7210-00-60)		
_	CAT	STATION TO STATION LOCATION	643.0100 EACH	REMARKS	CAT	STATION TO	STATION LC	OCATION	643.0100 EACH	REMARKS	CAT	STATION	TO STATION	LOCATION	643.0100 EACH	REMARKS
	0010	110+55 - 651+52 USH 63	1		0010	110+55 -	651+52 l	USH 63	1		0010	110+55	- 651+52	USH 63	1	
		TOTAL PROJECT ID 7210-00-60	1	=		TOTAL PRO	DJECT ID 7210-00-60	_	1	=		то	TAL PROJECT ID 7210	-00-60	1	=
											1					

FILE NAME : G:\WDOTCO\14023 (2014 - 2016 DESIGN WORK ORDERS)\14023-019\CIVIL 3D\SHEETSPLAN\MQ\030201-MQ.DWG

HWY: VARIES

PROJECT NO: VARIES

COUNTY: VARIES PLOT DATE : 12/7/2016 MISCELLANEOUS QUANTITIES

PLOT BY : KL ENGINEERING PLOT NAME :PLOT SCALE : 1:1.185

WISDOT/CADDS SHEET 42

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PAVEMENT	MARKING PAINT	

					646.0103 PAVEMENT MARKING PAINT 4-INCH (YELLOW)	646.0103 PAVEMENT MARKING PAINT 4-INCH (WHITE)	646.0123 PAVEMENT MARKING PAINT 8-INCH (WHITE)
CAT	STATION	ТО	STATION	LOCATION	LF	LF	LF
0010	100+00	-	973+94 TOTAL PRO	STH 73 JECT ID 1520-05-60	69,500	173,000	
0010	111+00	-	1115+15 TOTAL PRO	USH 10 JECT ID 1530-05-60	134,100	205,500	730 730
0010	111+42	-	539+09 TOTAL PRO	USH 53 JECT ID 1630-00-60	48,700	86,000 ,700	615 615
0010	100+60	-	362+10 TOTAL PRO	STH 35 JECT ID 7150-00-60	19,100	51,300 400	950 950
0010	110+55	-	651+52 TOTAL PRO	USH 63 JECT ID 7210-00-60	54,300	105,800	285 285
				GRAND TOTAL	947	,300	2,580

REMOVING PAVEMENT MARKING

					646.0600	647.0955	647.0965	
						REMOVING	REMOVING	
					REMOVING	PAVEMENT	PAVEMENT	
					PAVEMENT	MARKING	MARKING	
					MARKING	ARROWS	WORDS	
CAT	STATION	ТО	STATION	LOCATION	LF	EACH	EACH	REMARK
0010	100+00	_	973+94	STH 73	242,700			
0010	100+00	-			242,700			=
			TOTAL PROJ	IECT ID 1520-05-60				
0010	111+00	-	1115+15	USH 10	341,100	2		_
			TOTAL PROJ	IECT ID 1530-05-60				_
0010	111+42	-	539+09	USH 53	136,000			_
			TOTAL PROJ	IECT ID 1630-00-60				=
0010	100+60	-	362+10	STH 35	72,300			
			TOTAL PROJ	IECT ID 7150-00-60				=
0010	110+55	-	651+52	USH 63	160,700	1	1	_
			TOTAL PROJ	IECT ID 7210-00-60				=
				GRAND TOTAL	952,800	3	1	

INLET PROTECTION TYPE C

			628.7015	
CAT		LOCATION	EACH	REMARKS
0010	UNDISTRIBUTED	STH 73	5	PROJECT ID 1520-05-60
0010	UNDISTRIBUTED	USH 10	5	PROJECT ID 1530-05-60
0010	UNDISTRIBUTED	USH 53	5	PROJECT ID 1630-00-60
0010	UNDISTRIBUTED	STH 35	5	PROJECT ID 7150-00-60
0010	UNDISTRIBUTED	USH 63	5	PROJECT ID 7210-00-60
		TOTAL	25	

TEMPORARY PAVEMENT MARKING PAINT 4-INCH

					649.0402 (YELLOW)	649.0402 (WHITE)	
CAT	STATION	TO	STATION	LOCATION	LF	LF	REMARKS
0010	100+00	-	973+94	STH 73**			CENTERLINE & BYPASS LANE SKIPS
			TOTAL PRO	JECT ID 1520-05-60	0		DIFAGS LAINE SKIFS
0010	111+00	-	1045+00	USH 10**			CENTERLINE &
	1045+00		1115+15	USH 10*	6,000	175	BYPASS LANE SKIPS
			TOTAL PRO	JECT ID 1530-05-60	6,17	75	
0010	111+42	-	539+09	USH 53*	48,700	1,800	CENTERLINE & BYPASS LANE SKIPS
			TOTAL PRO	JECT ID 1630-00-60	50,5	00	BYPASS LAINE SKIPS
0010	100+60	-	362+10	STH 35*	19,100	120	CENTERLINE & BYPASS LANE SKIPS
			TOTAL PRO	JECT ID 7150-00-60	19,2	20	, ,
0010	110+55	-	651+52	USH 63**			
			TOTAL PRO	JECT ID 7210-00-60	0		
				GRAND TOTAL	75,8	95	

^{*} TEMPORARY RAISED PAVEMENT MARKERS ARE ACCEPTABLE FOR A MAXIUM OF 3 DAYS AFTER THE SEAL COAT IS PLACED. UNTIL THE PERMANENT MARKINGS ARE PLACED, TEMPORARY PAVEMENT MARKINGS ARE REQUIRED FOR CENTERLINES, LANE LINES AND EDGE LINES. (DUE TO AADT OVER 3,500)

PROJECT NO: VARIES HWY: VARIES FILE NAME : G:\WDOTCO\14023 (2014 - 2016 DESIGN WORK ORDERS)\14023-019\CIVIL 3D\SHEETSPLAN\MQ\030201-MQ.DWG

COUNTY: VARIES

MISCELLANEOUS QUANTITIES

SHEET

PLOT BY : KL ENGINEERING PLOT NAME : _____PLOT SCALE : 1:1.185

^{**} TEMPORARY PAVEMENT MARKINGS NOT REQUIRED UNTIL PERMENENT PAVEMENT MARKINGS ARE PLACED. (DUE TO AADT LESS THAN 3,500)

COUNTY	PAVEMENT M CLARK	MARKING (SPECIAL MARKINGS)							:	EMPORARY	RAISED PAVEMEN	NT MARKERS		
PROJECT ID	1520-05-60											649.210	00	
MAP REFERENCE HWY	STH 73						CAT	STATION	TO STA	TION	LOCATION	EACH	I	REMARKS
MAP REFERENCE SITE ID	STH 95 - STH 73 INTERSECTION			STH 73	STH 73	TOTAL	0010	100+00		3+94	STH 73	14,500		YELLOW
BID ITEM #	DESCRIPTION	MARKING LOCATION	UNIT	NB	SB	QUANTITY	0010	100+00		3+94	STH 73	6,900	ı	WHITE
647.0566	PAVEMENT MARKING, STOP LINE, EPOXY, 18-INCH	MAINLINE	L.F.	45		45		.00.00			CT ID 1520-05-60	21,400		******
									•	JIMET ROOL	01 10 1020 00 00			
			TOTAL	PROJECT ID 1	520-05-60	45	0010	111+00	- 111	5+15	USH 10	19,000)	YELLOW
												10,000		
COUNTY	PIERCE						0010	111+00		5+15	USH 10			WHITE
PROJECT ID	1530-05-06								11	JIAL PROJE	CT ID 1530-05-60	29,000	J	
MAP REFERENCE HWY	USH 10													
MAP REFERENCE SITE ID	10TH STREET - END OF CLIMBING LANE			USH 10	USH 10	TOTAL	0010	111+42		9+09	USH 53	8,300		YELLOW
BID ITEM #	DESCRIPTION	MARKING LOCATION	UNIT	EB	WB	QUANTITY	0010	111+42	- 53	9+09	USH 53	3,500		WHITE
647.0196	PAVEMENT MARKING ARROWS, EPOXY, TYPE 5	LANE REDUCTION	EACH	2	***5	2			T	OTAL PROJEC	CT ID 1630-00-60	11,800)	
7-7-10-100	17WEMENT WANTED FRANCE ON THE CO	ENIVE REBOOTION	27.011	-		-								
							0010	100+60	- 36	2+10	STH 35	4,500		YELLOW
			IOTAL	PROJECT ID 1	530-05-60	2	0010	100+60	- 36	2+10	STH 35	1,000		WHITE
COUNTY	TREMPEALEAL								T	OTAL PROJEC	CT ID 7150-00-60	5,500		
COUNTY	TREMPEALEAU													
PROJECT ID	7150-00-60						0010	110+55	- 65	+52	USH 63	10,100)	YELLOW
MAP REFERENCE HWY	STH 35						0010	110+55		1+52	USH 63	4,300		WHITE
MAP REFERENCE SITE ID	STH 93 - STH 35 INTERSECTION			STH 35	STH 35	TOTAL					CT ID 7210-00-60	14,400		
BID ITEM #	DESCRIPTION	MARKING LOCATION	UNIT	NB	SB	QUANTITY			,	I NOUL	J. ID 1210-00-00	,400		
647.0566	PAVEMENT MARKING, STOP LINE, EPOXY, 18-INCH	MAINLINE	L.F.	22		22					GRAND TOTAL	82,100	1	
											GRAND TOTAL	02,100	,	
			TOTAL	PROJECT ID 7	150-00-60	22								
COUNTY	PIERCE													
COUNTY PROJECT ID	PIERCE 7210-00-60									LOCATIN	10 NO DACOINO 70	ONEO.		
PROJECT ID	7210-00-60									LOCATIN	IG NO-PASSING ZO	<u>ONES</u>		
PROJECT ID MAP REFERENCE HWY	7210-00-60 USH 63			STH 62	27U 62	TOTAL				LOCATIN	IG NO-PASSING ZO	<u>DNES</u>		
PROJECT ID MAP REFERENCE HWY MAP REFERENCE SITE ID	7210-00-60 USH 63 USH 10 - STH 63 INTERSECTION			STH 63	STH 63	TOTAL				LOCATIN	IG NO-PASSING ZO	ONES 648.0100		
PROJECT ID MAP REFERENCE HWY MAP REFERENCE SITE ID SID ITEM #	7210-00-60 USH 63 USH 10 - STH 63 INTERSECTION DESCRIPTION	MARKING LOCATION	UNIT	NB	STH 63 SB	TOTAL QUANTITY	CAT	STATION	TO STAT		IG NO-PASSING ZO			REMARKS
PROJECT ID MAP REFERENCE HWY MAP REFERENCE SITE ID SID ITEM # 647.0166	7210-00-60 USH 63 USH 10 - STH 63 INTERSECTION DESCRIPTION PAVEMENT MARKING, ARROWS, EPOXY, TYPE 2	LEFT TURN LANE	EACH	NB 1			CAT		TO STAT	ON		648.0100		REMARKS
PROJECT ID MAP REFERENCE HWY MAP REFERENCE SITE ID SID ITEM # 647.0166 647.0356	7210-00-60 USH 63 USH 10 - STH 63 INTERSECTION DESCRIPTION PAVEMENT MARKING, ARROWS, EPOXY, TYPE 2 PAVEMENT MARKING, WORDS, EPOXY, "ONLY"	LEFT TURN LANE LEFT TURN LANE	EACH EACH	NB 1 1		QUANTITY 1 1			- 973+	ON 94	LOCATION	648.0100 MI		REMARKS
PROJECT ID MAP REFERENCE HWY MAP REFERENCE SITE ID SID ITEM # 647.0166	7210-00-60 USH 63 USH 10 - STH 63 INTERSECTION DESCRIPTION PAVEMENT MARKING, ARROWS, EPOXY, TYPE 2	LEFT TURN LANE	EACH	NB 1					- 973+	ON 94	LOCATION STH 73	648.0100 MI 16.55		REMARKS
PROJECT ID MAP REFERENCE HWY MAP REFERENCE SITE ID SID ITEM # 647.0166 647.0356	7210-00-60 USH 63 USH 10 - STH 63 INTERSECTION DESCRIPTION PAVEMENT MARKING, ARROWS, EPOXY, TYPE 2 PAVEMENT MARKING, WORDS, EPOXY, "ONLY"	LEFT TURN LANE LEFT TURN LANE	EACH EACH	NB 1 1		QUANTITY 1 1		100+00	- 973+	ON 94 'AL PROJECT	LOCATION STH 73	648.0100 MI 16.55		REMARKS
PROJECT ID MAP REFERENCE HWY MAP REFERENCE SITE ID SID ITEM # 647.0166 647.0356	7210-00-60 USH 63 USH 10 - STH 63 INTERSECTION DESCRIPTION PAVEMENT MARKING, ARROWS, EPOXY, TYPE 2 PAVEMENT MARKING, WORDS, EPOXY, "ONLY"	LEFT TURN LANE LEFT TURN LANE	EACH EACH L.F.	NB 1 1	SB	QUANTITY 1 1	0010	100+00	- 973+ TO	ON 94 FAL PROJECT	LOCATION STH 73 TID 1520-05-60 USH 10	648.0100 MI 16.55 16.55		REMARKS
PROJECT ID MAP REFERENCE HWY MAP REFERENCE SITE ID SID ITEM # 647.0166 647.0356	7210-00-60 USH 63 USH 10 - STH 63 INTERSECTION DESCRIPTION PAVEMENT MARKING, ARROWS, EPOXY, TYPE 2 PAVEMENT MARKING, WORDS, EPOXY, "ONLY"	LEFT TURN LANE LEFT TURN LANE	EACH EACH L.F.	NB 1 1 45	SB	QUANTITY 1 1	0010	100+00	- 973+ TO	ON 94 FAL PROJECT	LOCATION STH 73 T ID 1520-05-60	648.0100 MI 16.55 16.55		REMARKS
PROJECT ID MAP REFERENCE HWY MAP REFERENCE SITE ID SID ITEM # 647.0166 647.0356	7210-00-60 USH 63 USH 10 - STH 63 INTERSECTION DESCRIPTION PAVEMENT MARKING, ARROWS, EPOXY, TYPE 2 PAVEMENT MARKING, WORDS, EPOXY, "ONLY"	LEFT TURN LANE LEFT TURN LANE	EACH EACH L.F.	NB 1 1 45	SB	QUANTITY 1 1	0010	100+00	- 973+ TO' - 1115- TO'	ON 94 'AL PROJECT -15 'AL PROJECT	LOCATION STH 73 T ID 1520-05-60 USH 10 T ID 1530-05-60	648.0100 MI 16.55 16.55 19.02		REMARKS
PROJECT ID MAP REFERENCE HWY MAP REFERENCE SITE ID SID ITEM # 647.0166 647.0356	7210-00-60 USH 63 USH 10 - STH 63 INTERSECTION DESCRIPTION PAVEMENT MARKING, ARROWS, EPOXY, TYPE 2 PAVEMENT MARKING, WORDS, EPOXY, "ONLY"	LEFT TURN LANE LEFT TURN LANE	EACH EACH L.F.	NB 1 1 45	SB	QUANTITY 1 1	0010	100+00	- 9734 TO' - 1115- TO' - 5394	ON 94	LOCATION STH 73 TID 1520-05-60 USH 10 TID 1530-05-60 USH 53	648.0100 MI 16.55 16.55 19.02 19.02		REMARKS
PROJECT ID MAP REFERENCE HWY MAP REFERENCE SITE ID SID ITEM # 647.0166 647.0356	7210-00-60 USH 63 USH 10 - STH 63 INTERSECTION DESCRIPTION PAVEMENT MARKING, ARROWS, EPOXY, TYPE 2 PAVEMENT MARKING, WORDS, EPOXY, "ONLY" PAVEMENT MARKING, DIAGONAL, EPOXY, 12-INCH	LEFT TURN LANE LEFT TURN LANE MEDIAN	EACH EACH L.F.	NB 1 1 45	SB	QUANTITY 1 1	0010	100+00	- 9734 TO' - 1115- TO' - 5394	ON 94	LOCATION STH 73 T ID 1520-05-60 USH 10 T ID 1530-05-60	648.0100 MI 16.55 16.55 19.02		REMARKS
PROJECT ID MAP REFERENCE HWY MAP REFERENCE SITE ID SID ITEM # 647.0166 647.0356	7210-00-60 USH 63 USH 10 - STH 63 INTERSECTION DESCRIPTION PAVEMENT MARKING, ARROWS, EPOXY, TYPE 2 PAVEMENT MARKING, WORDS, EPOXY, "ONLY"	LEFT TURN LANE LEFT TURN LANE MEDIAN	EACH EACH L.F.	NB 1 1 45	SB	QUANTITY 1 1	0010	111+00	- 9734 TO' - 1115- TO' - 5394	ON 94	USH 10 USH 10 USH 53 USH 53 USH 53	648.0100 MI 16.55 16.55 19.02 19.02 8.10 8.10		REMARKS
PROJECT ID MAP REFERENCE HWY MAP REFERENCE SITE ID SID ITEM # 647.0166 647.0356	7210-00-60 USH 63 USH 10 - STH 63 INTERSECTION DESCRIPTION PAVEMENT MARKING, ARROWS, EPOXY, TYPE 2 PAVEMENT MARKING, WORDS, EPOXY, "ONLY" PAVEMENT MARKING, DIAGONAL, EPOXY, 12-INCH	LEFT TURN LANE LEFT TURN LANE MEDIAN	EACH EACH L.F.	NB 1 1 45	SB	QUANTITY 1 1	0010	100+00	- 9734 TO* - 1115 TO* - 5394 TO*	ON 94	USH 10 USH 10 USH 53 USH 53 USH 53 USH 53 USH 53	648.0100 MI 16.55 16.55 19.02 19.02 8.10 8.10 4.95		REMARKS
PROJECT ID MAP REFERENCE HWY MAP REFERENCE SITE ID SID ITEM # 647.0166 647.0356	7210-00-60 USH 63 USH 10 - STH 63 INTERSECTION DESCRIPTION PAVEMENT MARKING, ARROWS, EPOXY, TYPE 2 PAVEMENT MARKING, WORDS, EPOXY, "ONLY" PAVEMENT MARKING, DIAGONAL, EPOXY, 12-INCH	LEFT TURN LANE LEFT TURN LANE MEDIAN	EACH EACH L.F.	NB 1 1 45	SB	QUANTITY 1 1	0010	111+00	- 9734 TO* - 1115 TO* - 5394 TO*	ON 94	USH 10 USH 10 USH 53 USH 53 USH 53	648.0100 MI 16.55 16.55 19.02 19.02 8.10 8.10		REMARKS
PROJECT ID MAP REFERENCE HWY MAP REFERENCE SITE ID SID ITEM # 647.0166 647.0356	7210-00-60 USH 63 USH 10 - STH 63 INTERSECTION DESCRIPTION PAVEMENT MARKING, ARROWS, EPOXY, TYPE 2 PAVEMENT MARKING, WORDS, EPOXY, "ONLY" PAVEMENT MARKING, DIAGONAL, EPOXY, 12-INCH	LEFT TURN LANE LEFT TURN LANE MEDIAN	EACH EACH L.F. TOTAI	NB 1 1 45	SB	QUANTITY 1 1	0010	111+00	- 9734 TO* - 1115 TO* - 5394 TO*	ON 94	USH 10 USH 10 USH 53 USH 53 USH 53 USH 53 USH 53	648.0100 MI 16.55 16.55 19.02 19.02 8.10 8.10 4.95		REMARKS
PROJECT ID MAP REFERENCE HWY MAP REFERENCE SITE ID SID ITEM # 647.0166 647.0356	7210-00-60 USH 63 USH 10 - STH 63 INTERSECTION DESCRIPTION PAVEMENT MARKING, ARROWS, EPOXY, TYPE 2 PAVEMENT MARKING, WORDS, EPOXY, "ONLY" PAVEMENT MARKING, DIAGONAL, EPOXY, 12-INCH	LEFT TURN LANE LEFT TURN LANE MEDIAN //FOG SEAL SPV.0180.01 SPV.0180.02	EACH EACH L.F. TOTAI	NB 1 1 45	SB 210-00-60	QUANTITY 1 1	0010	100+00 111+00 111+42 100+60	- 9734 TO* - 1115- TO* - 5394 TO*	ON 94	USH 10 USH 10 USH 53 USH 53 USH 53 USH 53 USH 53	648.0100 MI 16.55 16.55 19.02 19.02 8.10 8.10 4.95		REMARKS
PROJECT ID MAP REFERENCE HWY MAP REFERENCE SITE ID BID ITEM # 647.0166 647.0356 647.0726	7210-00-60 USH 63 USH 10 - STH 63 INTERSECTION DESCRIPTION PAVEMENT MARKING, ARROWS, EPOXY, TYPE 2 PAVEMENT MARKING, WORDS, EPOXY, "ONLY" PAVEMENT MARKING, DIAGONAL, EPOXY, 12-INCH CHIP/SCRUB/F	LEFT TURN LANE LEFT TURN LANE MEDIAN /FOG SEAL SPV.0180.01 SPV.0180.02 CHIP SEAL SCRUB SEAL	EACH EACH L.F. TOTAI SPV.0180.03 FOG SEAL	NB 1 1 45 - PROJECT ID 72	SB 210-00-60	QUANTITY 1 1	0010	100+00 111+00 111+42 100+60	- 9734 TO' - 1115- TO' - 5394 TO' - 3624 TO'	ON 94	USH 10 USH 10 USH 53 USH 53 USH 35 USH 35 USH 35	648.0100 MI 16.55 16.55 19.02 19.02 8.10 8.10 4.95		REMARKS
PROJECT ID MAP REFERENCE HWY MAP REFERENCE SITE ID BID ITEM # 647.0166 647.0726 CAT STATE	7210-00-60 USH 63 USH 10 - STH 63 INTERSECTION DESCRIPTION PAVEMENT MARKING, ARROWS, EPOXY, TYPE 2 PAVEMENT MARKING, WORDS, EPOXY, "ONLY" PAVEMENT MARKING, DIAGONAL, EPOXY, 12-INCH CHIP/SCRUB/F	LEFT TURN LANE LEFT TURN LANE MEDIAN /FOG SEAL SPV.0180.01 SPV.0180.02 CHIP SEAL SCRUB SEAL SY SY	EACH EACH L.F. TOTAI SPV.0180.03 FOG SEAL SY	NB 1 1 45 - PROJECT ID 72	SB 210-00-60	QUANTITY 1 1	0010	100+00 111+00 111+42 100+60	- 9734 TO' - 1115- TO' - 5394 TO' - 3624 TO'	ON 94	USH 10 USH 10 USH 53 USH 53 USH 35 USH 35 USH 35 USH 35 USH 35 USH 35	648.0100 MI 16.55 16.55 19.02 19.02 8.10 8.10 4.95 4.95		REMARKS
PROJECT ID MAP REFERENCE HWY MAP REFERENCE SITE ID BID ITEM # 647.0166 647.0726 CAT STATE	7210-00-60 USH 63 USH 10 - STH 63 INTERSECTION DESCRIPTION PAVEMENT MARKING, ARROWS, EPOXY, TYPE 2 PAVEMENT MARKING, WORDS, EPOXY, "ONLY" PAVEMENT MARKING, DIAGONAL, EPOXY, 12-INCH CHIP/SCRUB/F	LEFT TURN LANE LEFT TURN LANE MEDIAN /FOG SEAL SPV.0180.01 SPV.0180.02 CHIP SEAL SCRUB SEAL SY SY	EACH EACH L.F. TOTAI SPV.0180.03 FOG SEAL SY	NB 1 1 45 - PROJECT ID 72	SB 210-00-60	QUANTITY 1 1	0010	100+00 111+00 111+42 100+60	- 9734 TO' - 1115- TO' - 5394 TO' - 3624 TO'	ON 94 FAL PROJECT FAL PROJECT 10 FAL PROJECT 10 FAL PROJECT 52 FAL PROJECT	USH 10 USH 10 USH 53 USH 53 USH 35 USH 35 USH 35 USH 35 USH 35 USH 35	648.0100 MI 16.55 16.55 19.02 19.02 8.10 8.10 4.95 4.95		REMARKS
PROJECT ID MAP REFERENCE HWY MAP REFERENCE SITE ID BID ITEM # 647.0166 647.0726 CAT STATI 0010 100+	7210-00-60 USH 63 USH 10 - STH 63 INTERSECTION DESCRIPTION PAVEMENT MARKING, ARROWS, EPOXY, TYPE 2 PAVEMENT MARKING, WORDS, EPOXY, "ONLY" PAVEMENT MARKING, DIAGONAL, EPOXY, 12-INCH CHIP/SCRUB/F TION TO STATION LOCATION +00 - 973+94 STH 73 TOTAL PROJECT ID 1520-05-60	LEFT TURN LANE LEFT TURN LANE MEDIAN /FOG SEAL SPV.0180.01 SPV.0180.02 CHIP SEAL SCRUB SEAL SY SY	EACH EACH L.F. TOTAI SPV.0180.03 FOG SEAL SY	NB 1 1 45 - PROJECT ID 72	SB 210-00-60	QUANTITY 1 1	0010	100+00 111+00 111+42 100+60	- 9734 TO' - 1115- TO' - 5394 TO' - 3624 TO'	ON 94 FAL PROJECT FAL PROJECT 10 FAL PROJECT 10 FAL PROJECT 52 FAL PROJECT	USH 53 T ID 7150-00-60 USH 35 T ID 1630-00-60 USH 63 T ID 7210-00-60	648.0100 MI 16.55 16.55 19.02 19.02 8.10 8.10 4.95 4.95 10.25		REMARKS
PROJECT ID MAP REFERENCE HWY MAP REFERENCE SITE ID BID ITEM # 647.0166 647.0726 CAT STATE	7210-00-60 USH 63 USH 10 - STH 63 INTERSECTION DESCRIPTION PAVEMENT MARKING, ARROWS, EPOXY, TYPE 2 PAVEMENT MARKING, WORDS, EPOXY, "ONLY" PAVEMENT MARKING, DIAGONAL, EPOXY, 12-INCH CHIP/SCRUB/F TION TO STATION LOCATION +00 - 973+94 STH 73 TOTAL PROJECT ID 1520-05-60	LEFT TURN LANE LEFT TURN LANE MEDIAN /FOG SEAL SPV.0180.01 SPV.0180.02 CHIP SEAL SCRUB SEAL SY SY 243,000	EACH EACH L.F. TOTAI SPV.0180.03 FOG SEAL SY 291,500	NB 1 1 45 - PROJECT ID 72	SB 210-00-60	QUANTITY 1 1	0010	100+00 111+00 111+42 100+60	- 9734 TO' - 1115- TO' - 5394 TO' - 3624 TO'	ON 94 FAL PROJECT FAL PROJECT 10 FAL PROJECT 10 FAL PROJECT 52 FAL PROJECT	USH 53 T ID 7150-00-60 USH 35 T ID 1630-00-60 USH 63 T ID 7210-00-60	648.0100 MI 16.55 16.55 19.02 19.02 8.10 8.10 4.95 4.95 10.25		REMARKS
PROJECT ID MAP REFERENCE HWY MAP REFERENCE SITE ID BID ITEM # 647.0166 647.0726 CAT STATI 0010 100+	7210-00-60 USH 63 USH 10 - STH 63 INTERSECTION DESCRIPTION PAVEMENT MARKING, ARROWS, EPOXY, TYPE 2 PAVEMENT MARKING, WORDS, EPOXY, "ONLY" PAVEMENT MARKING, DIAGONAL, EPOXY, 12-INCH CHIP/SCRUB/F TION TO STATION LOCATION +00 - 973+94 STH 73 TOTAL PROJECT ID 1520-05-60	LEFT TURN LANE LEFT TURN LANE MEDIAN /FOG SEAL SPV.0180.01 SPV.0180.02 CHIP SEAL SCRUB SEAL SY SY 243,000	EACH EACH L.F. TOTAI SPV.0180.03 FOG SEAL SY 291,500	NB 1 1 45 - PROJECT ID 72	SB 210-00-60	QUANTITY 1 1	0010	100+00 111+00 111+42 100+60	- 9734 TO' - 1115- TO' - 5394 TO' - 3624 TO'	ON 94 FAL PROJECT FAL PROJECT 10 FAL PROJECT 10 FAL PROJECT 52 FAL PROJECT	USH 53 T ID 7150-00-60 USH 35 T ID 1630-00-60 USH 63 T ID 7210-00-60	648.0100 MI 16.55 16.55 19.02 19.02 8.10 8.10 4.95 4.95 10.25		REMARKS
PROJECT ID MAP REFERENCE HWY MAP REFERENCE SITE ID BID ITEM # 647.0166 647.0356 647.0726 CAT STATI 0010 100+ 0010 111+	7210-00-60 USH 63 USH 10 - STH 63 INTERSECTION DESCRIPTION PAVEMENT MARKING, ARROWS, EPOXY, TYPE 2 PAVEMENT MARKING, WORDS, EPOXY, "ONLY" PAVEMENT MARKING, DIAGONAL, EPOXY, 12-INCH CHIP/SCRUB/F TION TO STATION LOCATION +00 - 973+94 STH 73 TOTAL PROJECT ID 1520-05-60 +00 - 1115+15 USH 10 TOTAL PROJECT ID 1530-05-60	LEFT TURN LANE LEFT TURN LANE MEDIAN /FOG SEAL SPV.0180.01 SPV.0180.02 CHIP SEAL SCRUB SEAL SY SY 243,000 326,100	EACH EACH L.F. TOTAI SPV.0180.03 FOG SEAL SY 291,500	NB 1 1 45 - PROJECT ID 72	SB 210-00-60	QUANTITY 1 1	0010	100+00 111+00 111+42 100+60	- 9734 TO' - 1115- TO' - 5394 TO' - 3624 TO'	ON 94 FAL PROJECT FAL PROJECT 10 FAL PROJECT 10 FAL PROJECT 52 FAL PROJECT	USH 53 T ID 7150-00-60 USH 35 T ID 1630-00-60 USH 63 T ID 7210-00-60	648.0100 MI 16.55 16.55 19.02 19.02 8.10 8.10 4.95 4.95 10.25		REMARKS
PROJECT ID MAP REFERENCE HWY MAP REFERENCE SITE ID BID ITEM # 647.0166 647.0726 CAT STATI 0010 100+	7210-00-60 USH 63 USH 10 - STH 63 INTERSECTION DESCRIPTION PAVEMENT MARKING, ARROWS, EPOXY, TYPE 2 PAVEMENT MARKING, WORDS, EPOXY, "ONLY" PAVEMENT MARKING, DIAGONAL, EPOXY, 12-INCH CHIP/SCRUB/F TION TO STATION LOCATION +00 - 973+94 STH 73 TOTAL PROJECT ID 1520-05-60 +00 - 1115+15 USH 10 TOTAL PROJECT ID 1530-05-60 +42 - 539+09 USH 53	LEFT TURN LANE LEFT TURN LANE MEDIAN /FOG SEAL SPV.0180.01 SPV.0180.02 CHIP SEAL SCRUB SEAL SY SY 243,000	EACH EACH L.F. TOTAI SPV.0180.03 FOG SEAL SY 291,500	NB 1 1 45 - PROJECT ID 72	SB 210-00-60	QUANTITY 1 1	0010	100+00 111+00 111+42 100+60	- 9734 TO' - 1115- TO' - 5394 TO' - 3624 TO'	ON 94 FAL PROJECT FAL PROJECT 10 FAL PROJECT 10 FAL PROJECT 52 FAL PROJECT	USH 53 T ID 7150-00-60 USH 35 T ID 1630-00-60 USH 63 T ID 7210-00-60	648.0100 MI 16.55 16.55 19.02 19.02 8.10 8.10 4.95 4.95 10.25		REMARKS
PROJECT ID MAP REFERENCE HWY MAP REFERENCE SITE ID BID ITEM # 647.0166 647.0356 647.0726 CAT STATI 0010 100+ 0010 111+	7210-00-60 USH 63 USH 10 - STH 63 INTERSECTION DESCRIPTION PAVEMENT MARKING, ARROWS, EPOXY, TYPE 2 PAVEMENT MARKING, WORDS, EPOXY, "ONLY" PAVEMENT MARKING, DIAGONAL, EPOXY, 12-INCH CHIP/SCRUB/F TION TO STATION LOCATION +00 - 973+94 STH 73 TOTAL PROJECT ID 1520-05-60 +00 - 1115+15 USH 10 TOTAL PROJECT ID 1530-05-60	LEFT TURN LANE LEFT TURN LANE MEDIAN /FOG SEAL SPV.0180.01 SPV.0180.02 CHIP SEAL SCRUB SEAL SY SY 243,000 326,100	EACH EACH L.F. TOTAI SPV.0180.03 FOG SEAL SY 291,500	NB 1 1 45 - PROJECT ID 72	SB 210-00-60	QUANTITY 1 1	0010	100+00 111+00 111+42 100+60	- 9734 TO' - 1115 TO' - 5394 TO' - 3624 TO' - 6514	ON 94 FAL PROJECT FAL PROJECT 10 FAL PROJECT 10 FAL PROJECT 10 FAL PROJECT	USH 53 T ID 7150-00-60 USH 35 T ID 1630-00-60 USH 63 T ID 7210-00-60	648.0100 MI 16.55 16.55 19.02 19.02 8.10 8.10 4.95 4.95 10.25 10.25 58.87		REMARKS
CAT STATI 0010 111+ 0010 111+	7210-00-60 USH 63 USH 10 - STH 63 INTERSECTION DESCRIPTION PAVEMENT MARKING, ARROWS, EPOXY, TYPE 2 PAVEMENT MARKING, WORDS, EPOXY, "ONLY" PAVEMENT MARKING, DIAGONAL, EPOXY, 12-INCH CHIP/SCRUB/F TION TO STATION LOCATION +00 - 973+94 STH 73 TOTAL PROJECT ID 1520-05-60 +00 - 1115+15 USH 10 TOTAL PROJECT ID 1530-05-60 +42 - 539+09 USH 53 TOTAL PROJECT ID 1630-00-60	LEFT TURN LANE LEFT TURN LANE LEFT TURN LANE MEDIAN	EACH EACH L.F. TOTAI SPV.0180.03 FOG SEAL SY 291,500 379,400	NB 1 1 45 - PROJECT ID 72	SB 210-00-60	QUANTITY 1 1	0010	100+00 111+00 111+42 100+60	- 9734 TO' - 1115 TO' - 5394 TO' - 3624 TO' - 6514	ON 94 FAL PROJECT FAL PROJECT 10 FAL PROJECT 10 FAL PROJECT 10 FAL PROJECT	LOCATION STH 73 T ID 1520-05-60 USH 10 T ID 1530-05-60 USH 53 T ID 1630-00-60 STH 35 T ID 7150-00-60 USH 63 T ID 7210-00-60 GRAND TOTAL	648.0100 MI 16.55 16.55 19.02 19.02 8.10 8.10 4.95 4.95 10.25 10.25 58.87		REMARKS
PROJECT ID MAP REFERENCE HWY MAP REFERENCE SITE ID BID ITEM # 647.0166 647.0356 647.0726 CAT STATI 0010 100+ 0010 111+	7210-00-60 USH 63 USH 10 - STH 63 INTERSECTION DESCRIPTION PAVEMENT MARKING, ARROWS, EPOXY, TYPE 2 PAVEMENT MARKING, WORDS, EPOXY, "ONLY" PAVEMENT MARKING, DIAGONAL, EPOXY, 12-INCH CHIP/SCRUB/F TION TO STATION LOCATION +00 - 973+94 STH 73 TOTAL PROJECT ID 1520-05-60 +00 - 1115+15 USH 10 TOTAL PROJECT ID 1530-05-60 +42 - 539+09 USH 53 TOTAL PROJECT ID 1630-00-60 +60 - 362+10 STH 35	LEFT TURN LANE LEFT TURN LANE MEDIAN /FOG SEAL SPV.0180.01 SPV.0180.02 CHIP SEAL SCRUB SEAL SY SY 243,000 326,100	EACH EACH L.F. TOTAI SPV.0180.03 FOG SEAL SY 291,500	NB 1 1 45 - PROJECT ID 72	SB 210-00-60	QUANTITY 1 1	0010 0010 0010 0010	100+00 111+00 111+42 100+60 110+55	- 9734 TO' - 1115 TO' - 5394 TO' - 3624 TO' - 6514 TO'	ON 94	LOCATION STH 73 T ID 1520-05-60 USH 10 T ID 1530-05-60 USH 53 T ID 1630-00-60 STH 35 T ID 7150-00-60 USH 63 T ID 7210-00-60 GRAND TOTAL	648.0100 MI 16.55 16.55 19.02 19.02 8.10 8.10 4.95 4.95 10.25 10.25 58.87		
CAT STATI 0010 111+ 0010 111+	7210-00-60 USH 63 USH 10 - STH 63 INTERSECTION DESCRIPTION PAVEMENT MARKING, ARROWS, EPOXY, TYPE 2 PAVEMENT MARKING, WORDS, EPOXY, "ONLY" PAVEMENT MARKING, DIAGONAL, EPOXY, 12-INCH CHIP/SCRUB/F TION TO STATION LOCATION +00 - 973+94 STH 73 TOTAL PROJECT ID 1520-05-60 +00 - 1115+15 USH 10 TOTAL PROJECT ID 1530-05-60 +42 - 539+09 USH 53 TOTAL PROJECT ID 1630-00-60	LEFT TURN LANE LEFT TURN LANE LEFT TURN LANE MEDIAN	EACH EACH L.F. TOTAI SPV.0180.03 FOG SEAL SY 291,500 379,400	NB 1 1 45 - PROJECT ID 72	SB 210-00-60	QUANTITY 1 1	0010 0010 0010 0010 0010	100+00 111+00 111+42 100+60 110+55	- 9734 TO' - 1115 TO' - 5394 TO' - 3624 TO' - 6514 TO'	ON 94 FAL PROJECT FAL PROJECT 10 FAL PROJECT 10 FAL PROJECT 11 FAL	LOCATION STH 73 TID 1520-05-60 USH 10 TID 1530-05-60 USH 53 TID 1630-00-60 STH 35 TID 7150-00-60 USH 63 TID 7210-00-60 GRAND TOTAL	648.0100 MI 16.55 16.55 19.02 19.02 8.10 8.10 4.95 4.95 10.25 10.25 58.87	UNIT	TOTALS
CAT STATI 0010 111+ 0010 111+	7210-00-60 USH 63 USH 10 - STH 63 INTERSECTION DESCRIPTION PAVEMENT MARKING, ARROWS, EPOXY, TYPE 2 PAVEMENT MARKING, WORDS, EPOXY, "ONLY" PAVEMENT MARKING, DIAGONAL, EPOXY, 12-INCH CHIP/SCRUB/F TION TO STATION LOCATION +00 - 973+94 STH 73 TOTAL PROJECT ID 1520-05-60 +00 - 1115+15 USH 10 TOTAL PROJECT ID 1530-05-60 +42 - 539+09 USH 53 TOTAL PROJECT ID 1630-00-60 +60 - 362+10 STH 35	LEFT TURN LANE LEFT TURN LANE LEFT TURN LANE MEDIAN MEDIAN	EACH EACH L.F. TOTAI SPV.0180.03 FOG SEAL SY 291,500 379,400 154,400	NB 1 1 45 - PROJECT ID 72	SB 210-00-60	QUANTITY 1 1	0010 0010 0010 0010 CAT 0010	100+00 111+00 111+42 100+60 110+55	- 9734 TO' - 1115 TO' - 5394 TO' - 3624 TO' - 6514 TO'	ON 94	LOCATION STH 73 TID 1520-05-60 USH 10 TID 1530-05-60 USH 53 TID 1630-00-60 STH 35 TID 7150-00-60 USH 63 TID 7210-00-60 GRAND TOTAL G SUMMARY (SPE	648.0100 MI 16.55 16.55 19.02 19.02 8.10 8.10 4.95 4.95 10.25 10.25 58.87	UNIT	TOTALS 2
CAT STATI 0010 111+ 0010 111+	7210-00-60 USH 63 USH 10 - STH 63 INTERSECTION DESCRIPTION PAVEMENT MARKING, ARROWS, EPOXY, TYPE 2 PAVEMENT MARKING, WORDS, EPOXY, "ONLY" PAVEMENT MARKING, DIAGONAL, EPOXY, 12-INCH CHIP/SCRUB/F TION TO STATION LOCATION +00 - 973+94 STH 73 TOTAL PROJECT ID 1520-05-60 +00 - 1115+15 USH 10 TOTAL PROJECT ID 1530-05-60 +42 - 539+09 USH 53 TOTAL PROJECT ID 1630-00-60 +60 - 362+10 STH 35 TOTAL PROJECT ID 7150-00-60	LEFT TURN LANE LEFT TURN LANE LEFT TURN LANE MEDIAN	EACH EACH L.F. TOTAI SPV.0180.03 FOG SEAL SY 291,500 379,400	NB 1 1 45 - PROJECT ID 72	SB 210-00-60	QUANTITY 1 1	0010 0010 0010 0010 CAT 0010 0010	100+00 111+00 111+42 100+60 110+55	- 9734 TO' - 1115 TO' - 5394 TO' - 3624 TO' - 6514 TO'	ON 94	LOCATION STH 73 TID 1520-05-60 USH 10 TID 1530-05-60 USH 53 TID 1630-00-60 STH 35 TID 7150-00-60 USH 63 TID 7210-00-60 GRAND TOTAL G SUMMARY (SPE RKING, ARROW, ERRING, ARROW, ERRI	648.0100 MI 16.55 16.55 19.02 19.02 8.10 8.10 4.95 4.95 10.25 10.25 58.87 CIAL MARKINGS) IN POXY, TYPE 5 POXY, TYPE 2	UNIT EACH EACH	TOTALS 2 1
CAT STATI 0010 111+ 0010 100+	7210-00-60 USH 63 USH 10 - STH 63 INTERSECTION DESCRIPTION PAVEMENT MARKING, ARROWS, EPOXY, TYPE 2 PAVEMENT MARKING, WORDS, EPOXY, "ONLY" PAVEMENT MARKING, DIAGONAL, EPOXY, 12-INCH CHIP/SCRUB/F TION TO STATION LOCATION +00 - 973+94 STH 73 TOTAL PROJECT ID 1520-05-60 +00 - 1115+15 USH 10 TOTAL PROJECT ID 1530-05-60 +42 - 539+09 USH 53 TOTAL PROJECT ID 1630-00-60 +60 - 362+10 STH 35 TOTAL PROJECT ID 7150-00-60	LEFT TURN LANE LEFT TURN LANE LEFT TURN LANE MEDIAN MEDIAN	EACH EACH L.F. TOTAI SPV.0180.03 FOG SEAL SY 291,500 379,400 154,400	NB 1 1 45 - PROJECT ID 72	SB 210-00-60	QUANTITY 1 1	0010 0010 0010 0010 CAT 0010 0010 0010	100+00 111+00 111+42 100+60 110+55 ITEM NUMBER 647.0196 647.0166 647.0356	- 9734 TO' - 1115 TO' - 5394 TO' - 3624 TO' - 6514 TO'	ON 94	LOCATION STH 73 TID 1520-05-60 USH 10 TID 1530-05-60 USH 53 TID 1630-00-60 STH 35 TID 7150-00-60 USH 63 TID 7210-00-60 GRAND TOTAL G SUMMARY (SPE RKING, ARROW, EF RKING, ARROW, EF RKING, ARROW, EF RKING, WORDS, EF	648.0100 MI 16.55 16.55 19.02 19.02 8.10 8.10 4.95 4.95 10.25 10.25 58.87 CIAL MARKINGS) POXY, TYPE 5 POXY, TYPE 2 POXY, "ONLY"	UNIT EACH EACH EACH	TOTALS 2 1 1
CAT STATI 0010 111+ 0010 100+	7210-00-60 USH 63 USH 10 - STH 63 INTERSECTION DESCRIPTION PAVEMENT MARKING, ARROWS, EPOXY, TYPE 2 PAVEMENT MARKING, WORDS, EPOXY, "ONLY" PAVEMENT MARKING, DIAGONAL, EPOXY, 12-INCH CHIP/SCRUB/F TION TO STATION LOCATION +00 - 973+94 STH 73 TOTAL PROJECT ID 1520-05-60 +00 - 1115+15 USH 10 TOTAL PROJECT ID 1530-05-60 +42 - 539+09 USH 53 TOTAL PROJECT ID 1630-00-60 +60 - 362+10 STH 35 TOTAL PROJECT ID 7150-00-60 +55 - 651+52 USH 63	LEFT TURN LANE LEFT TURN LANE LEFT TURN LANE MEDIAN MEDIAN	EACH EACH L.F. TOTAI SPV.0180.03 FOG SEAL SY 291,500 379,400 154,400	NB 1 1 45 - PROJECT ID 72	SB 210-00-60	QUANTITY 1 1	0010 0010 0010 0010 0010 CAT 0010 0010 0010 0010 0010	100+00 111+00 111+42 100+60 110+55 ITEM NUMBER 647.0196 647.0166 647.0356 647.0566	- 9734 TO' - 1115 TO' - 5394 TO' - 3624 TO' - 6514 TO'	ON 94	LOCATION STH 73 TID 1520-05-60 USH 10 TID 1530-05-60 USH 53 TID 1630-00-60 STH 35 TID 7150-00-60 USH 63 TID 7210-00-60 GRAND TOTAL G SUMMARY (SPE RKING, ARROW, EF RKING, ARROW, EF RKING, WORDS, EF RING, STOP LINE, E	648.0100 MI 16.55 16.55 19.02 19.02 8.10 8.10 4.95 4.95 10.25 10.25 58.87 CIAL MARKINGS) IN POXY, TYPE 5 POXY, TYPE 2 POXY, "ONLY" POXY, 18-INCH	UNIT EACH EACH	TOTALS 2 1 1 67
CAT STATI 0010 111+ 0010 100+	7210-00-60 USH 63 USH 10 - STH 63 INTERSECTION DESCRIPTION PAVEMENT MARKING, ARROWS, EPOXY, TYPE 2 PAVEMENT MARKING, WORDS, EPOXY, "ONLY" PAVEMENT MARKING, DIAGONAL, EPOXY, 12-INCH CHIP/SCRUB/F TION TO STATION LOCATION +00 - 973+94 STH 73 TOTAL PROJECT ID 1520-05-60 +00 - 1115+15 USH 10 TOTAL PROJECT ID 1530-05-60 +42 - 539+09 USH 53 TOTAL PROJECT ID 1630-00-60 +60 - 362+10 STH 35 TOTAL PROJECT ID 7150-00-60 +55 - 651+52 USH 63	LEFT TURN LANE LEFT TURN LANE LEFT TURN LANE MEDIAN MEDIAN	EACH EACH L.F. TOTAI SPV.0180.03 FOG SEAL SY 291,500 379,400 154,400	NB 1 1 45 - PROJECT ID 72	SB 210-00-60	QUANTITY 1 1	0010 0010 0010 0010 CAT 0010 0010 0010	100+00 111+00 111+42 100+60 110+55 ITEM NUMBER 647.0196 647.0166 647.0356	- 9734 TO' - 1115 TO' - 5394 TO' - 3624 TO' - 6514 TO'	ON 94	LOCATION STH 73 TID 1520-05-60 USH 10 TID 1530-05-60 USH 53 TID 1630-00-60 STH 35 TID 7150-00-60 USH 63 TID 7210-00-60 GRAND TOTAL G SUMMARY (SPE RKING, ARROW, EF RKING, ARROW, EF RKING, ARROW, EF RKING, WORDS, EF	648.0100 MI 16.55 16.55 19.02 19.02 8.10 8.10 4.95 4.95 10.25 10.25 58.87 CIAL MARKINGS) IN POXY, TYPE 5 POXY, TYPE 2 POXY, "ONLY" POXY, 18-INCH	UNIT EACH EACH EACH	TOTALS 2 1 1

HWY: VARIES

PROJECT NO: VARIES

COUNTY: VARIES

SHEET

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Ή	73	PFRMA	NENT	SIGNING	TYPF II

				SIGN	I	637.2210 SIGNS TYPE II	637.2230 SIGNS TYPE II	634.0614	634.0616	634.0618	638.2602 REMOVING	638.3000 REMOVING	SIGN	
				SIZE		REFLECTIVE	REFLECTIVE	POST	S WOOD 4X6	INCH	SIGNS	SMALL SIGN	MOUNTED	
	SIGN	SIGN	W	Х	Н	Н	F	14 FT	16 FT	18 FT	TYPE II	SUPPORTS	ON SAME	
ATEGORY	#	CODE	IN		IN	SF	SF	EACH	EACH	EACH	EACH	EACH	POST AS	REMARKS
0010														
	1-01	W14-3	48	Х	36		6.00		1		1	1		NO PASSING ZONE
	1-02	W1-2R	30	Х	30		6.25		1		1	1		RIGHT CURVE
	1-03	W14-3	48	Х	36		6.00		1		1	1		NO PASSING ZONE
	1-04	W1-6	48	Х	24		8.00	1			1	1		NIGHT ARROW (SINGLE)
	1-05	R1-1	30	Х	30	5.18		1			1	1		STOP SIGN
-	1-06	R1-1	30	Х	30	5.18		1			1	1		STOP SIGN
	1-07	S3-1	36	Х	36		9.00		2		1	1		SCHOOL BUS STOP AHEAD
	2-01	W1-6	48	Х	24		8.00	1			1	1		NIGHT ARROW (SINGLE)
	2-02	W1-2L	30	Х	30		6.25		1		1	1		LEFT CURVE
	2-03	W14-3	48	Х	36		6.00		1		1	1		NO PASSING ZONE
-	2-04	W14-3	48	Х	36		6.00		1		1	1		NO PASSING ZONE
	2-05	R1-1	30	Х	30	5.18		1			1	1		STOP SIGN
	2-06	W1-2L	30	Х	30		6.25		1		1	1		LEFT CURVE
	3-01	R1-1	30	Х	30	5.18		1			1	1		STOP SIGN
	3-02	R1-1	30	Х	30	5.18		1			1	1		STOP SIGN
•	3-03	W14-3	48	Х	36		6.00		1		1	1		NO PASSING ZONE
	3-04	W1-2R	30	Х	30		6.25		1		1	1		RIGHT CURVE
	4-01	R1-1	30	Х	30	5.18		1			1	1		STOP SIGN
	4-02	W14-3	48	Х	36		6.00		1		1	1		NO PASSING ZONE
	4-03	D7-68	F	REMO\	VΕ						1	1		ROAD TO SHERWOOD COUNTY PARK 1 M
-	4-04	W14-3	48	Х	36		6.00		1		1	1		NO PASSING ZONE
	5-01	W14-3	48	Х	36		6.00		1		1	1		NO PASSING ZONE
	5-02	J4-1	24	Х	36	6.00			1		1	1		REASSURANCE ASSEMBLY
	5-03	R1-1	30	Х	30	5.18		1			1	1		STOP SIGN
	5-04	W1-2R	30	Х	30		6.25		1		1	1		RIGHT CURVE
	5-05	W1-6	48	Х	24		8.00	1			1	1		NIGHT ARROW (SINGLE)
-	5-06	W54-58	30	Х	30		6.25		1		1	1		CHURCH ENTRANCE
	5-07	J12-1	24	Х	45	7.50			1		1	1		ROUTE TURN WITHOUT CARDINAL
	5-08	R1-1	30	Х	30	5.18		1			1	1		STOP SIGN
	5-09	R1-2	36	Х	31	3.88			1		1	1		YIELD
	5-10	J1-1	24	Х	39	6.50			1		1	1		JUNCTION OR END ASSEMBLY
-	5-11	D7-68L	60	Х	36	15.00			2		1	1		SHERWOOD COUNTY PARK (LEFT ARRO
	5-12	J12-1	24	Х	45	7.50			1		1	1		ROUTE TURN WITHOUT CARDINAL
	5-13	W1-6	48	Х	24		8.00	1			1	1		NIGHT ARROW (SINGLE)
	5-14	W1-6	48	Х	24		8.00	1			1	1		NIGHT ARROW (SINGLE)
	5-15	J12-1	24	Х	45	7.50			1		1	1		ROUTE TURN WITHOUT CARDINAL
-	6-01	D7-68R	60	Х	36	15.00			2		1	1		SHERWOOD COUNTY PARK (RIGHT ARR
	6-02	J1-1	24	Х	39	6.50			1		1	1		JUNCTION OR END ASSEMBLY
	6-03	R1-1	30	Х	30	5.18		1			1	1		STOP SIGN
	6-04	W1-2L	30	Х	30		6.25		1		1	1		LEFT CURVE
	6-05	J4-1	24	Х	36	6.00			1		1	1		REASSURANCE ASSEMBLY
-	6-06	W14-3	48	Х	36		6.00		1		1	1		NO PASSING ZONE
	6-07	R1-1	30	Х	30	5.18		1			1	1		STOP SIGN
	6-08	W14-3	48	Х	36		6.00		1		1	1		NO PASSING ZONE
	7-01	W14-3	48	Х	36		6.00		1		1	1		NO PASSING ZONE
	7-02	W5-52L	12	Х	36		3.00		1		1	1		CLEARANCE STRIPER DOWN RIGHT
•	7-03	W5-52R	12	Х	36		3.00		1		1	1		CLEARANCE STRIPER DOWN LEFT
	7-04	W5-52R	12	Х	36		3.00		1		1	1		CLEARANCE STRIPER DOWN LEFT
	7-05	I3-1	36	Х	24	6.00		1			1	2		LAKE OR RIVER NAME
	7-06	W5-52L	12	Х	36		3.00		1		1	1		CLEARANCE STRIPER DOWN RIGHT
	7-07	D7-68		REMO\							1	1		ROAD TO SHERWOOD COUNTY PARK 1 M
-		TOTAL				139.18	170.75	16	36		51	52		

FILE NAME : G:\WDOTCO\14023 (2014 - 2016 DESIGN WORK ORDERS)\14023-019\CIVIL 3D\SHEETSPLAN\MQ\030201-MQ.DWG

PROJECT NO: 1520-05-60

HWY: STH 73

COUNTY: CLARK PLOT DATE : 12/7/2016 MISCELLANEOUS QUANTITIES

PLOT BY : KL ENGINEERING PLOT NAME :PLOT SCALE : 1:1.185

WISDOT/CADDS SHEET 42

				SIGN		637.2210 SIGNS TYPE II	637.2230 SIGNS TYPE II	634.0614	634.0616	634.0618	638.2602 REMOVING	638.3000 REMOVING	SIGN	
	CICN	CION	14/	SIZE		REFLECTIVE	REFLECTIVE	-	rs wood 4x6		SIGNS	SMALL SIGN SUPPORTS	MOUNTED	
CATEGORY	SIGN #	SIGN CODE	W IN	Х	H IN	H SF	F SF	14 FT EACH	16 FT EACH	18 FT EACH	TYPE II EACH	EACH	ON SAME POST AS	REMARKS
0010		TOTAL	111		111	139.18	170.75	16	36		51	52	100170	KEWAKKO
55.5	002					.000		.0	00		0.	02		
•	7-08	W14-3	48	Х	36		6.00		1		1	1		NO PASSING ZONE
	8-01	R1-1	30	Х	30	5.18		1			1	1		STOP SIGN
	8-02	R1-1	30	Х	30	5.18		1			1	1		STOP SIGN
	9-01	W14-3	48	Х	36		6.00		1		1	1		NO PASSING ZONE
	9-02	W5-52L	12	Х	36		3.00		1		1	1		CLEARANCE STRIPER DOWN RIGHT
	9-03	I3-1	36	Х	24	6.00		1			1	2		LAKE OR RIVER NAME
	9-04	W5-52R	12	Х	36		3.00		1		1	1		CLEARANCE STRIPER DOWN LEFT
	9-05	W1-2L	30	Χ	30		6.25		1		1	1		LEFT CURVE
	9-06	W5-52R	12	Χ	36		3.00		1		1	1		CLEARANCE STRIPER DOWN LEFT
	9-07	W14-3	48	Х	36		6.00		1		1	1		NO PASSING ZONE
	9-08	W5-52L	12	Х	36		3.00		1		1	1		CLEARANCE STRIPER DOWN RIGHT
	10-01	W1-2R	30	Χ	30		6.25		1		1	1		RIGHT CURVE
	10-02	W14-3	48	Χ	36		6.00		1		1	1		NO PASSING ZONE
	11-01	W14-3	48	Χ	36		6.00		1		1	1		NO PASSING ZONE
	11-02	J1-1	24	Х	39	6.50			1		1	1		JUNCTION OR END ASSEMBLY
	11-03	W11-12	36	Х	36		9.00		2		1	1		HORSE DRAWN VEHICLE SYMBOL
	11-04	W14-3	48	Χ	36		6.00		1		1	1		NO PASSING ZONE
	12-01	J4-1	24	X	36	6.00			1		1	1		REASSURANCE ASSEMBLY
	12-02	R1-1	30	X	30	5.18		1			1	1		STOP SIGN
	12-03	J12-1	24	Χ	45	7.50			1		1	1		ROUTE TURN WITHOUT CARDINAL
•	12-04	J1-1	24	Х	39	6.50			1		1	1		JUNCTION OR END ASSEMBLY
	12-05	J12-1	24	Х	45	7.50			1		1	1		ROUTE TURN WITHOUT CARDINAL
	12-06	R1-1	30	Х	30	5.18		1			1	1		STOP SIGN
	12-07	J12-1	24	Х	45	7.50			1		1	1		ROUTE TURN WITHOUT CARDINAL
	12-08	J4-1	24	Х	36	6.00			1		1	1		REASSURANCE ASSEMBLY
•	12-09	R1-1	30	Х	30	5.18		1			1	1		STOP SIGN
	15-01	W14-3	48	Х	36		6.00		1		1	1		NO PASSING ZONE
	15-02	R1-1	30	Х	30	5.18		1			1	1		STOP SIGN
	15-03	R1-1	30	Х	30	5.18		1			1	1		STOP SIGN
	15-04	W14-3	48	Х	36		6.00		1		1	1		NO PASSING ZONE
•	16-01	W14-3	48	Х	36		6.00		1		1	1		NO PASSING ZONE
	16-02	R1-1	30	Х	30	5.18		1			1	1		STOP SIGN
	16-03	W14-3	48	Х	36		6.00		1		1	1		NO PASSING ZONE
	16-04	W14-3	48	Х	36		6.00		1		1	1		NO PASSING ZONE
	17-01	W14-3	48	Х	36		6.00		1		1	1		NO PASSING ZONE
•	17-02	J1-1	24	Х	39	6.50			1		1	1		JUNCTION OR END ASSEMBLY
	18-01	J4-1	24	Х	36	6.00			1		1	1		REASSURANCE ASSEMBLY
	18-02	R1-1	30	Х	30	5.18		1			1	1		STOP SIGN
	18-03	J12-1	24	Х	45	7.50			1		1	1		ROUTE TURN WITHOUT CARDINAL
	18-04	W11-12	36	Х	36		9.00		2		1	1		HORSE DRAWN VEHICLE SYMBOL
	18-05	J12-1	24	X	45	7.50			1		1	1		ROUTE TURN WITHOUT CARDINAL
	18-06	R1-1	30	Х	30	5.18		1			1	1		STOP SIGN
	18-07	J12-1	24	X	45	7.50			1		1	1		ROUTE TURN WITHOUT CARDINAL
	18-08	J4-1	24	X	36	6.00			1		1	1		REASSURANCE ASSEMBLY
	18-09	J4-1 J1-1	24	X	39	6.50			1		1	1		
	18-10	W14-3	48	X	36		6.00		1		1	1		JUNCTION OR END ASSEMBLY
		W 14-3 R1-1	30	X	30	5.18		1			1	•		NO PASSING ZONE
	19-01 19-02	R1-1 R1-1		X	30			1			1	1		STOP SIGN
			30			5.18						1		STOP SIGN
	19-03	W14-3	48	X	36	 5.40	6.00		1		1	1		NO PASSING ZONE
	20-01	R1-1	30	Х	30	5.18	207.25	1 20	74		1 101	1 102		STOP SIGN
	SUB	TOTAL				307.52	297.25	30	74		101	103		

FILE NAME : G:\WDOTCO\14023 (2014 - 2016 DESIGN WORK ORDERS)\14023-019\CIVIL 3D\SHEETSPLAN\MQ\030201-MQ.DWG

PROJECT NO: 1520-05-60

HWY: STH 73

PLOT DATE : 12/7/2016

MISCELLANEOUS QUANTITIES

PLOT BY : KL ENGINEERING PLOT NAME :PLOT SCALE : 1:1.185

WISDOT/CADDS SHEET 42

SHEET

COUNTY: CLARK

				SIGN		637.2210 SIGNS TYPE II	637.2230 SIGNS TYPE II	634.0614	634.0616	634.0618	638.2602 REMOVING	638.3000 REMOVING	SIGN	
				SIZE		REFLECTIVE	REFLECTIVE	POST	TS WOOD 4X6	-INCH	SIGNS	SMALL SIGN	MOUNTED	
	SIGN	SIGN	W	X	Н	Н	F	14 FT	16 FT	18 FT	TYPE II	SUPPORTS	ON SAME	
CATEGORY	#	CODE	IN		IN	SF	SF	EACH	EACH	EACH	EACH	EACH	POST AS	REMARKS
0010	SUB	TOTAL				307.52	297.25	30	74		101	103		
	20-02	R1-1	30	Х	30	5.18		1			1	1		STOP SIGN
	21-01	W14-3	48	Χ	36		6.00		1		1	1		NO PASSING ZONE
	21-02	W14-3	48	Χ	36		6.00		1		1	1		NO PASSING ZONE
	22-01	J4-1	24	Χ	36	6.00			1		1	1		REASSURANCE ASSEMBLY
	22-02	R1-1	30	Χ	30	5.18		1			1	1		STOP SIGN
	22-03	R1-1	30	Х	30	5.18		1			1	1		STOP SIGN
	22-04	J4-1	24	Χ	36	6.00			1		1	1		REASSURANCE ASSEMBLY
	23-01	W14-3	48	Χ	36		6.00		1		1	1		NO PASSING ZONE
	23-02	W1-4R	30	Χ	30		6.25		1		1	1		RIGHT REVERSE CURVE
	24-01	R1-1	30	Χ	30	5.18		1			1	1		STOP SIGN
	24-02	R1-1	30	Х	30	5.18		1			1	1		STOP SIGN
	25-01	W1-4R	30	Χ	30		6.25		1		1	1		RIGHT REVERSE CURVE
	25-02	W14-3	48	Х	36		6.00		1		1	1		NO PASSING ZONE
	25-03	W14-3	48	Χ	36		6.00		1		1	1		NO PASSING ZONE
	26-01	R1-1	30	Х	30	5.18		1			1	1		STOP SIGN
	26-02	R1-1	30	Х	30	5.18		1			1	1		STOP SIGN
	26-03	R1-1	30	Х	30	5.18		1			1	1		STOP SIGN
	26-04	W14-3	48	Χ	36		6.00		1		1	1		NO PASSING ZONE
	26-05	R1-1	30	Х	30	5.18		1			1	1		STOP SIGN
	27-01	R1-1	30	Χ	30	5.18		1			1	1		STOP SIGN
	29-01	W14-3	48	Х	36		6.00		1		1	1		NO PASSING ZONE
	29-02	J1-1	24	Χ	39	6.50			1		1	1		JUNCTION OR END ASSEMBLY
	29-03	W1-2L	30	Χ	30		6.25		1		1	1	29-04	LEFT CURVE
	29-04	W13-1	18	Χ	18		2.25				1		29-03	ADVISORY SPEED (YELLOW BACK)
	29-05	W3-1	36	Χ	36		9.00		2		1	1		STOP AHEAD
	29-06	J2-1	24	Х	57	9.50				1	1	1		ROUTE TURN ASSEMBLY
	30-01	D2-2	84	Χ	24	14.00		2			1	2		DESTINATION/DISTANCE (TWO DESTINATION)
	30-02	J4-1	24	Χ	36	6.00			1		1			REASSURANCE ASSEMBLY
	30-03	D1-2	72	Χ	30	15.00		2			1	2		TWO DESTINATION (ARROWS)
	30-04	W1-6	48	Х	24		8.00	2			1	2		NIGHT ARROW (SINGLE)
	30-05	R1-1	36	Х	36	7.46					1		POLE	STOP SIGN
	30-06	R1-1	36	Х	36	7.46			1		1	1		STOP SIGN
	PROJECT 15	520-05-60 TOT	AL			437.24	377.25	46	91	1	133	135		

HWY: STH 73 COUNTY: CLARK MISCELLANEOUS QUANTITIES SHEET PROJECT NO: 1520-05-60

USH 10 PERMANENT SIGNING TYPE II

				SIGN SIZE		637.2210 SIGNS TYPE II REFLECTIVE	637.2230 SIGNS TYPE II REFLECTIVE	634.0614	634.0616 TS WOOD 4X6	634.0618 -INCH	638.2602 REMOVING SIGNS	638.3000 REMOVING SMALL SIGN	SIGN MOUNTED	
	SIGN	SIGN	W	Х	Н	Н	F	14 FT	16 FT	18 FT	TYPE II	SUPPORTS	ON SAME	
CATEGORY	#	CODE	IN		IN	SF	SF	EACH	EACH	EACH	EACH	EACH	POST AS	REMARKS
	1-01	J4-1		ESTR										REASSURANCE ASSEMBLY
	1-02	J12-1		ESTR										ROUTE TURN WITHOUT CARDINAL
	1-03	155-56	30	Х	36	7.50			1		1	1		ADOPT A HIGHWAY SPONSOR
	1-04	J12-1		ESTR										ROUTE TURN WITHOUT CARDINAL
	1-05	R1-1		ESTR										STOP SIGN
	1-06	J13-1		ESTR										DIRECTIONAL WITHOUT CARDINAL
	1-07	W1-2L		ESTR										LEFT CURVE
	1-08	155-56	30	Х	36	7.50			1		1	1		ADOPT A HIGHWAY SPONSOR
	1-09	J4-1	24	Х	36	6.00			1		1	1		REASSURANCE ASSEMBLY
	1-10	W5-52L	12	Х	36		3.00		1		1	1		CLEARANCE STRIPER DOWN RIGHT
	1-11	I3-1	36	Х	24	6.00		1			1	1		LAKE OR RIVER NAME
	1-12	W5-52R	12	Х	36		3.00		1		1	1		CLEARANCE STRIPER DOWN LEFT
	1-13	J1-1	24	Х	39	6.50			1		1	1		JUNCTION OR END ASSEMBLY
	1-14	R1-1	30	Х	30	5.18		1			1	1		STOP SIGN
	1-15	W5-52R	12	X	36		3.00		1		1	1		CLEARANCE STRIPER DOWN LEFT
	1-16	I3-1	36	Х	24	6.00		1			1	1		LAKE OR RIVER NAME
	1-17	W5-52L	12	Х	36		3.00		1		1	1		CLEARANCE STRIPER DOWN RIGHT
	1-18	R4-51	36	Х	48	12.00				1				PASSING LANE AHEAD 1/2 MILE
	2-01	W1-2R	30	X	30		6.25		1		1	1		RIGHT CURVE
	2-02	W5-52L	12	X	36		3.00		1		1	1		CLEARANCE STRIPER DOWN RIGHT
	2-03	W14-3	48	X	36		6.00		1		1	1		NO PASSING ZONE
	2-04	W5-52R	12	X	36		3.00		1		1	1		CLEARANCE STRIPER DOWN LEFT
	2-05	W5-52L	12	X	36		3.00		1		1	1		CLEARANCE STRIPER DOWN RIGHT
	2-06	W5-52R	12	X	36		3.00		1		1	1		CLEARANCE STRIPER DOWN LEFT
	2-07	R1-1	30	X	30	5.18		1			1	1		STOP SIGN
	2-08	R1-1	30	X	30	5.18		1			1	1		STOP SIGN
	2-09	R4-3	24	X	30	5.00		1			1	1		SLOWER TRAFFIC KEEP RIGHT
	3-01	W8-14	30	X	30		6.25		4		1	1	3-02	FALLEN ROCKS
	3-02	W14-3	48	X	36	 5.00	6.00		1		1		3-01	NO PASSING ZONE
	3-03	R4-1 R4-53	24 54	X	30 54	5.00 20.25			1 	2				DO NOT PASS DO NOT PASS WHEN ONCOMING TRAFFIC IN EITHER LANE
		R4-53 R3-72	30	X	36	7.50			1		1			ONCOMING TRAFFIC USES CENTER LANE
	4-01 4-02	R3-72 R1-1	30	X	30						1	1		STOP SIGN
	4-02	W9-1R	36	X	36	5.18	9.00	1	2		1	1		RIGHT LANE ENDS
	4-03 5-01	W7-1	30	X	30		6.25		1		1	1		HILL
	5-02	W4-2R	36	X	36		9.00		2					LANE REDUCTION TRANSITION SYMBOL (RIGHT)
	5-02	W4-2R W1-2R	30	X	30		6.25		1		1	1		RIGHT CURVE
	5-04	R1-1	30	X	30	5.18		1			1	1		STOP SIGN
	5-05	W4-2R	36	X	36		9.00		2		1	1		LANE REDUCTION TRANSITION SYMBOL (RIGHT)
	5-06	R1-1	30	X	30	5.18		1			1	1		STOP SIGN
	5-07	R3-72	30	X	36	7.50			1					ONCOMING TRAFFIC USES CENTER LANE
	5-08	W14-3	48	X	36		6.00		1		1	1		NO PASSING ZONE
	5-09	W7-3	24	X	18		3.00		1				5-01	6% GRADE
	6-01	R1-1	30	X	30	5.18		1			1	1		STOP SIGN
	6-02	W14-3	48	X	36		6.00		1		1	1		NO PASSING ZONE
	6-03	155-56	30	X	36	7.50			1		1	1		ADOPT A HIGHWAY SPONSOR
	6-04	W1-2L	30	X	30		6.25		1		1	1		LEFT CURVE
	7-01	R1-1	30	X	30	5.18		1			1	1		STOP SIGN
	7-02	R1-1	30	X	30	5.18		1			1	1		STOP SIGN
	7-03	W1-2R	30	Х	30		6.25		1		1	1		RIGHT CURVE
	7-04	W14-3	48	Х	36		6.00		1		1	1		NO PASSING ZONE
		STOTAL				150.87	121.50	12	33	3	39	38		

COUNTY: PIERCE HWY: USH 10 MISCELLANEOUS QUANTITIES SHEET PROJECT NO: 1530-05-60

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	9/91/		SIGN #			SIGN SIZE		637.2210 SIGNS TYPE II REFLECTIVE	637.2230 SIGNS TYPE II REFLECTIVE	634.0614 POST	634.0616 S WOOD 4X6		638.2602 REMOVING SIGNS	638.3000 REMOVING SMALL SIGN	SIGN MOUNTED	
		SIGN	W	Х	Н	Н	F	14 FT	16 FT	18 FT	TYPE II	SUPPORTS	ON SAME			
CATEGORY		CODE	IN		IN	SF 450.07	SF 404.50	EACH	EACH	EACH	EACH	EACH	POST AS	REMARKS		
0010	50B1	TOTAL				150.87	121.50	12	33	3	39	38				
-	7-05	W14-3	48	Х	36		6.00		1		1	1		NO PASSING ZONE		
	7-06	W1-2R	30	X	30		6.25		1		1	1		RIGHT CURVE		
	7-07	W3-5	36	Χ	36		9.00		2		1	1		SPEED LIMIT 50 AHEAD (ARROW)		
	8-01	R1-1	30	Χ	30	5.18		1			1	1		STOP SIGN		
_	8-02	W1-6	48	Χ	24		8.00	1			1	1		NIGHT ARROW (SINGLE)		
	8-03	R2-1	24	Χ	30	5.00		1			1	1		SPEED LIMIT 55 MPH		
	8-04	J4-1	24	Χ	36	6.00		1			1			REASSURANCE ASSEMBLY		
	8-05	D2-1	78	Χ	15	8.13		2			1	2		DESTINATION/DISTANCE (ONE DESTINATION)		
	8-06	W1-2L	30	Χ	30		6.25		1		1	1		LEFT CURVE		
-	8-07	R2-1	24	Х	30	5.00		1			1	1		SPEED LIMIT 50 MPH		
	8-08	J13-1	24	Х	45	7.50			1		1	1		DIRECTIONAL WITHOUT CARDINAL		
	8-09	R1-1	36	Х	36	7.46			1		1	1		STOP SIGN		
	8-10	D4-2L	36	Х	48	12.00			1		1	1		PARK AND RIDE SYMBOLS LEFT ARROW		
	8-11	J12-1	24	X	45	7.50			1		1	1		ROUTE TURN WITHOUT CARDINAL		
-	8-12	J1-1	24	X	39	6.50			1		1	1		JUNCTION OR END ASSEMBLY		
	8-13	R2-1	24	X	30	5.00		1			1	1		SPEED LIMIT 50 MPH		
	8-14	J12-1	24	X	45	7.50			1		1	1		ROUTE TURN WITHOUT CARDINAL		
	8-15	R1-1	36	X	36	7.46			1		1	1		STOP SIGN		
	8-16	J13-1	24	X	45	7.50			1		1	1		DIRECTIONAL WITHOUT CARDINAL		
-	8-17	J4-1 R2-1	24	X	36 30	5.00		1			1 1	1		REASSURANCE ASSEMBLY		
	8-18				30			1			1	1		SPEED LIMIT 50 MPH		
	8-19 8-20	R2-1 J1-1	24 24	X X	39	5.00 6.50					1	1		SPEED LIMIT 50 MPH		
	8-21	W3-5	36	X	36	6.50	9.00		2		1	1		JUNCTION OR END ASSEMBLY SPEED LIMIT 50 AHEAD (ARROW)		
	8-22	D2-2	78	X	24	13.00	9.00	2			1	2		DESTINATION/DISTANCE (TWO DESTINATION)		
-	8-23	R2-1	24	X	30	5.00		1			1	1		SPEED LIMIT 55 MPH		
	8-24	W14-3	48	X	36		6.00		1		1	1		NO PASSING ZONE		
	9-01	W14-3	48	X	36		6.00		1		1	1		NO PASSING ZONE		
	9-02	R1-1	30	X	30	5.18		1			1	1		STOP SIGN		
	9-03	R1-1	30	X	30	5.18		1			1	1		STOP SIGN		
-	10-01	W14-3	48	X	36		6.00		1		1	1		NO PASSING ZONE		
	10-02	155-56	30	Х	36	7.50			1		1	1		ADOPT A HIGHWAY SPONSOR		
	10-03	W14-3	48	Х	36		6.00		1		1	1		NO PASSING ZONE		
	11-01	R1-1	30	X	30	5.18		1			1	1		STOP SIGN		
	11-02	W1-6	48	Χ	24		8.00	1			1	1		NIGHT ARROW (SINGLE)		
-	11-03	W2-2	30	Х	30		6.25		1		1	1		SIDE ROAD (90 DEGREES)		
	11-04	R1-1	30	Χ	30	5.18		1			1	1		STOP SIGN		
	11-05	W1-2R	30	Χ	30		6.25		1		1	1		RIGHT CURVE		
	11-06	R3-72	30	Х	36	7.50				1				ONCOMING TRAFFIC USES CENTER LANE		
	11-07	W4-2R	36	Х	36		9.00		2					LANE REDUCTION TRANSITION SYMBOL (RIGHT)		
_	11-08	W9-1R	36	Х	36		9.00		2		1	1		RIGHT LANE ENDS		
	11-09	W1-2L	30	Χ	30		6.25		1		1	1		LEFT CURVE		
	11-10	W4-2R	36	Χ	36		9.00		2		1	1		LANE REDUCTION TRANSITION SYMBOL (RIGHT)		
	11-11	W7-1	30	Χ	30		6.25		1		1	1		HILL		
_	11-12	W7-3	24	Х	18		3.00	1					11-11	6% GRADE		
_	12-01	R1-1	30	Χ	30	5.18		1			1	1		STOP SIGN		
	12-02	R1-1	30	Χ	30	5.18		1			1	1		STOP SIGN		
	12-03	W1-4R	30	Χ	30		6.25		1		1	1	12-04	RIGHT REVERSE CURVE		
	12-04	W13-1	18	Χ	18		2.25				1		12-03	ADVISORY SPEED (YELLOW BACK)		
_	12-05	W7-1	30	Χ	30		6.25		1		1	1		HILL		
	12-06	R3-72	30	Χ	36	7.50			1					ONCOMING TRAFFIC USES CENTER LANE		
	12-07	155-56	30	Χ	36	7.50			1		1	1		ADOPT A HIGHWAY SPONSOR		
	12-08	W7-3	24	Χ	18		3.00	1					12-05	6% GRADE		
	13-01	W1-4R	30	Χ	30		6.25		1		1	1	13-02	RIGHT REVERSE CURVE		
	13-02	W13-1	18	Х	18		2.25				1		13-01	ADVISORY SPEED (YELLOW BACK)		

FILE NAME : G:\WDOTCO\14023 (2014 - 2016 DESIGN WORK ORDERS)\14023-019\CIVIL 3D\SHEETSPLAN\MQ\030201-MQ.DWG

HWY: USH 10

PROJECT NO: 1530-05-60

PLOT DATE : 12/**7**/2016

COUNTY: PIERCE

MISCELLANEOUS QUANTITIES

PLOT BY : KL ENGINEERING PLOT NAME :PLOT SCALE : 1:1.185

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				SIGN SIZE		637.2210 SIGNS TYPE II REFLECTIVE	637.2230 SIGNS TYPE II REFLECTIVE	634.0614 POST	634.0616 TS WOOD 4X6	634.0618 -INCH	638.2602 REMOVING SIGNS	638.3000 REMOVING SMALL SIGN	SIGN MOUNTED	
	SIGN	SIGN	W	X	Н	н	F	14 FT	16 FT	18 FT	TYPE II	SUPPORTS	ON SAME	
regory	#	CODE	IN		IN	SF	SF	EACH	EACH	EACH	EACH	EACH	POST AS	REMARKS
0010	SUB	ΓΟΤΑL				350.18	279.25	35	69	4	89	86		
-	13-03	R4-51A	36	Х	48	12.00			1					PASSING LANE AHEAD 2 MILES
	14-01	R4-3	36	X	48	12.00			1		1	1		SLOWER TRAFFIC KEEP RIGHT
	14-02	J4-1	24	X	36	6.00		1			1			REASSURANCE ASSEMBLY
	14-03	D2-1	78	X	15	8.13			2		1	2		DESTINATION/DISTANCE (ONE DESTINATION
	14-04	J1-1	24	X	39	6.50			1		1	1		JUNCTION OR END ASSEMBLY
	14-05	12-3	72	X	24	12.00		2			1	2		MUNICIPALITY SIGN-POP OR UNINC
	14-06	D1-56SL	42	Х	21	6.13		2			1	2		BUSINESS DISTRICT (STAKED, AHEAD ARROV
	14-07	J12-1	24	Х	45	7.50			1		1	1		ROUTE TURN WITHOUT CARDINAL
	15-01	R3-1	24	Х	24	4.00		1			1	1		NO RIGHT TURN SYMBOL
-	15-02	R1-2	36	Х	31	3.88			1		1	1		YIELD
	15-03	J12-1	24	Х	45	7.50			1		1	1		ROUTE TURN WITHOUT CARDINAL
	15-04	J1-1	24	Х	39	6.50			1		1	1		JUNCTION OR END ASSEMBLY
	15-05	J13-1	24	Х	45	7.50			1		1	1		DIRECTIONAL WITHOUT CARDINAL
	15-06	R1-1	30	Х	30	5.18		1			1	1		STOP SIGN
	15-07	J12-1	24	X	45	7.50			1		1	1		ROUTE TURN WITHOUT CARDINAL
	15-08	W1-6	48	Х	24		8.00	1			1	1		NIGHT ARROW (SINGLE)
	15-09	W1-6	48	Х	24		8.00	1			1	1		NIGHT ARROW (SINGLE)
	15-10	R1-1	30	Х	30	5.18		1			1	1		STOP SIGN
	15-11	J13-1	24	Х	45	7.50			1		1	1		DIRECTIONAL WITHOUT CARDINAL
-	15-12	J1-1	24	X	39	6.50			1		1	1		JUNCTION OR END ASSEMBLY
	15-13	W11-6	30	Х	30		6.25		1		1	1		SNOWMOBILE CROSSING SYMBOL
	15-14	J12-1	24	Х	45	7.50			1		1	1		ROUTE TURN WITHOUT CARDINAL
	15-15	R1-1	30	X	30	5.18		1			1	1		STOP SIGN
	15-16	J13-1	24	Х	45	7.50			1		1	1		DIRECTIONAL WITHOUT CARDINAL
-	15-17	D1-56SL	42	Х	21	6.13		2			1	2		BUSINESS DISTRICT (STAKED, AHEAD ARROV
	15-18	W5-52L	12	Х	36		3.00		1		1	1		CLEARANCE STRIPER DOWN RIGHT
	15-19	I3-1	36	X	24	6.00		1			1	1		LAKE OR RIVER NAME
	15-20	W5-52R	12	X	36		3.00		1		1	1		CLEARANCE STRIPER DOWN LEFT
	15-21	12-3	72	Х	24	12.00		2			1	2		MUNICIPALITY SIGN-POP OR UNINC
-	15-22	J1-1	24	Х	39	6.50			1		1	1		JUNCTION OR END ASSEMBLY
	15-23	W11-6	30	Х	30		6.25		1		1	1		SNOWMOBILE CROSSING SYMBOL
	15-24	R1-1	30	X	30	5.18		1			1	1		STOP SIGN
	15-25	J4-1	24	Х	36	6.00		1			1			REASSURANCE ASSEMBLY
	15-26	D2-1	66	Х	15	6.88			2		1	2		DESTINATION/DISTANCE (ONE DESTINATION
	15-27	I3-1	36	X	24	6.00		1			1	1		LAKE OR RIVER NAME
	15-28	W5-52R	12	Х	36		3.00		1		1	1		CLEARANCE STRIPER DOWN LEFT
	15-29	W5-52L	12	Х	36		3.00		1		1	1		CLEARANCE STRIPER DOWN RIGHT
	15-30	R1-1	30	X	30	5.18		1			1	1		STOP SIGN
	15-31	W14-3	48	X	36		6.00		1		1	1		NO PASSING ZONE
-	15-32	R4-51	36	X	48	12.00				1				PASSING LANE AHEAD 1/2 MILE
	16-01	R4-51	36	X	48	12.00				1				PASSING LANE AHEAD 1/2 MILE
	17-01	W14-3	48	X	36		6.00		1		1	1		NO PASSING ZONE
	17-02	R4-3	36	X	48	12.00			1		1	1		SLOWER TRAFFIC KEEP RIGHT
	17-03	155-56	30	X	36	7.50			1		1	1		ADOPT A HIGHWAY SPONSOR
-	17-04	R4-51A	36	X	48	12.00			1					PASSING LANE AHEAD 2 MILES
	17-05	R3-72	30	X	36	7.50			1		1	1		ONCOMING TRAFFIC USES CENTER LANE
	17-06	155-56	30	X	36	7.50			1		1	1		ADOPT A HIGHWAY SPONSOR
	17-07	W8-14	30	X	30		6.25		1		1	1		FALLEN ROCKS
	18-01	R1-1	30	X	30	5.18		1			1	1		STOP SIGN
-	18-02	W8-14	30	X	30	 5.40	6.25		1		1	1		FALLEN ROCKS
	18-03	R1-1	30	X	30	5.18		1			1	1		STOP SIGN
	19-01	W7-1	30	X	30		6.25		1		1	1		HILL
	19-02	W11-6	30	X	30		6.25		1		1	1		SNOWMOBILE CROSSING SYMBOL
	19-03	J13-1	24	X	45	7.50			1		1	1		DIRECTIONAL WITHOUT CARDINAL
-	19-04	R1-1	30	Х	30	5.18		1			1	1		STOP SIGN

FILE NAME : G:\WDOTCO\14023 (2014 - 2016 DESIGN WORK ORDERS)\14023-019\CIVIL 3D\SHEETSPLAN\MQ\030201-MQ.DWG

HWY: USH 10

PROJECT NO: 1530-05-60

PLOT DATE : 12/7/2016

COUNTY: PIERCE

MISCELLANEOUS QUANTITIES

PLOT BY: KL ENGINEERING P

PLOT BY : KL ENGINEERING PLOT NAME :PLOT SCALE : 1:1.185

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				SIGN		637.2210 SIGNS TYPE II	637.2230 SIGNS TYPE II	634.0614	634.0616	634.0618	638.2602 REMOVING	638.3000 REMOVING	SIGN	
	SIGN	SIGN	W	SIZE X	н	REFLECTIVE H	REFLECTIVE F	POS [*]	TS WOOD 4X6 16 FT	-INCH 18 FT	SIGNS TYPE II	SMALL SIGN SUPPORTS	MOUNTED ON SAME	
CATEGORY	#	CODE	IN	^	IN	SF	SF	EACH	EACH	EACH	EACH	EACH	POST AS	REMARKS
0010	SUB	TOTAL				655.24	356.75	58	105	6	140	141		
	40.05	140.4	0.1		45	7.50								DOUTE TUDA WITHOUT CARDINAL
	19-05	J12-1	24	X	45 20	7.50			1		1 1	1		ROUTE TURN WITHOUT CARDINAL JUNCTION OR END ASSEMBLY
	19-06	J1-1	24	X	39	6.50			1			1		
	19-07	J12-1	24	X	45	7.50		4	1		1	1		ROUTE TURN WITHOUT CARDINAL NIGHT ARROW (DOUBLE)
	19-08	W1-7 R4-1	48	X X	24 30	 F 00	8.00	1			ı			DO NOT PASS
	19-09	W14-3	24 48	X	36	5.00	6.00		1		1	1		NO PASSING ZONE
	19-10	J1-1	24	X	39	6.50			1		1	1		JUNCTION OR END ASSEMBLY
	19-12	R4-53	54	X	54	20.25				2				DO NOT PASS WHEN ONCOMING TRAFFIC IN EITHER L.
	19-13	W9-1R	36	X	36		9.00		2		1	1		RIGHT LANE ENDS
	19-14	W7-3	24	Х	18		3.00	1					19-01	6% GRADE
	20-01	W4-2R	36	Х	36		9.00		2					LANE REDUCTION TRANSITION SYMBOL (RIGHT)
	20-02	155-56	30	Х	36	7.50			1		1	1		ADOPT A HIGHWAY SPONSOR
	20-03	R3-72	30	Х	36	7.50			1					ONCOMING TRAFFIC USES CENTER LANE
	20-04	12-2	54	Х	15	5.63		2			1	2		(NAME) COUNTY
	20-05	W4-2R	36	Х	36		9.00		2		1	1		LANE REDUCTION TRANSITION SYMBOL (RIGHT)
	20-06	12-2	54	Х	15	5.63		2			1	1		(NAME) COUNTY
	20-07	R1-1	30	Х	30	5.18		1			1	1		HILL
	20-08	155-56	30	X	36	7.50			1		1	1		ADOPT A HIGHWAY SPONSOR
	20-09	R1-1	30	X	30	5.18		1			1	1		STOP SIGN
	21-01	W14-3	48	Х	36		6.00		1		1	1		NO PASSING ZONE
	21-02	W4-2R	36	Х	36		9.00		2		1	1		LANE REDUCTION TRANSITION SYMBOL (RIGHT)
	21-03	W4-2R	36	X	36		9.00		2					LANE REDUCTION TRANSITION SYMBOL (RIGHT)
	21-04	R3-72	30	X	36	7.50			1					ONCOMING TRAFFIC USES CENTER LANE
	21-05	R1-1	30	X	30	5.18		1			1	1		STOP SIGN
	21-06	W9-1R	36	X	36		9.00		2		1	1		RIGHT LANE ENDS
	21-07	W7-1	30	Х	30		6.25		1		1	1		HILL
	21-08	W7-3	24	X	18		3.00	1					21-07	6% GRADE
	22-01	R1-1	30	Χ	30	5.18		1			1	1		STOP SIGN
	22-02	W1-2R	30	Х	30		6.25		1		1	1		RIGHT CURVE
	22-03	R1-1	30	X	30	5.18		1			1	1		STOP SIGN
	22-04	W1-4R	30	Х	30		6.25		1		1	1		RIGHT REVERSE CURVE
	22-05	W1-4R	30	Χ	30		6.25		1		1	1		RIGHT REVERSE CURVE
	22-06	R3-72	30	Χ	36	7.50			1		1	1		ONCOMING TRAFFIC USES CENTER LANE
	23-01	R4-53	54	X	54	20.25				2				DO NOT PASS WHEN ONCOMING TRAFFIC IN EITHER L
	23-02	W8-14	30	Х	30		6.25		1		1	1		FALLEN ROCKS
	23-03	R4-3	36	Х	48	12.00			1		1	1		SLOWER TRAFFIC KEEP RIGHT
	23-04	R1-1	30	Х	30	5.18		1			1	1		STOP SIGN
	24-01	W14-3	48	X	36		6.00		1		1	1		NO PASSING ZONE
	24-02	R4-51	36	X	48	12.00				1				PASSING LANE AHEAD 1/2 MILE
	25-01	155-56	30	Х	36	7.50			1		1	1		ADOPT A HIGHWAY SPONSOR
	25-02	R1-1	30	X	30	5.18		1			1	1		STOP SIGN
	25-03	155-56	30	X	36	7.50			1		1	1		ADOPT A HIGHWAY SPONSOR
	26-01	J4-1	24	X	36	6.00			1		1	1		REASSURANCE ASSEMBLY
	26-02	J13-1	24	X	45	7.50			1		1	1		DIRECTIONAL WITHOUT CARDINAL
	26-03	R1-1	36	X	36	7.46			1		1	1		STOP SIGN
	26-04	R1-1	30	X	30	5.18		1			1	1		STOP SIGN
	26-05	J1-1	24	X	39	6.50			1		1	1		JUNCTION OR END ASSEMBLY
	26-06	J12-1	24 24	X X	45 45	7.50			1		1	1		ROUTE TURN WITHOUT CARDINAL ROUTE TURN WITHOUT CARDINAL
	26-07	J12-1			45 39	7.50 6.50			1		1	1		
	26-08 26-09	J1-1 W1-7	24 48	X	24	6.50	8.00	1			1	1		JUNCTION OR END ASSEMBLY NIGHT ARROW (DOUBLE)
	26-09 26-10	VV1-7 J4-1	48 24	X	36	6.00	8.00	1 	1		1	1		REASSURANCE ASSEMBLY
	27-01	R1-1	30	X	30	5.18					1	1		STOP SIGN
	27-01	R1-1	30	X	30	5.18		1			1	1		STOP SIGN
	27-02	R4-51A	36	X	48	12.00				1				PASSING LANE AHEAD 2 MILES
	27-03	W14-3	48	X	36		6.00		1		1	1		NO PASSING ZONE
	27-04	D7-68		REMOV			6.00				1	1		ROAD TO PEPIN COUNTY PARK 1 MILE
	27-05	W1-4L	30	X	30		6.25		1		1	1		LEFT REVERSE CURVE

FILE NAME : G:\WDOTCO\14023 (2014 - 2016 DESIGN WORK ORDERS)\14023-019\CIVIL 3D\SHEETSPLAN\MQ\030201-MQ.DWG

PROJECT NO: 1530-05-60

HWY: USH 10

PLOT DATE : 12/7/2016

COUNTY: PIERCE

MISCELLANEOUS QUANTITIES

PLOT BY: KL ENGINEERING P

PLOT BY : KL ENGINEERING PLOT NAME :PLOT SCALE : 1:1.185

SHEET

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				SIGN SIZE		637.2210 SIGNS TYPE II REFLECTIVE	637.2230 SIGNS TYPE II REFLECTIVE	634.0614 POST	634.0616 FS WOOD 4X6	634.0618 -INCH	638.2602 REMOVING SIGNS	638.3000 REMOVING SMALL SIGN	SIGN MOUNTED	
	SIGN	SIGN	W	Х	Н	Н	F	14 FT	16 FT	18 FT	TYPE II	SUPPORTS	ON SAME	
CATEGORY	#	CODE	IN		IN	SF	SF	EACH	EACH	EACH	EACH	EACH	POST AS	REMARKS
0010	SUB	TOTAL				935.25	494.25	77	147	12	187	189		
-	27-07	S3-1	36	Х	36		9.00		2		1	1		SCHOOL BUS STOP AHEAD
	28-01	S3-1	36	Х	36		9.00		2		1	1		SCHOOL BUS STOP AHEAD
	28-02	W5-52L	12	Х	36		3.00		1		1	1		CLEARANCE STRIPER DOWN RIGHT
	28-03	I3-1	60	Х	24	10.00		2			1	1		LAKE OR RIVER NAME
	28-04	W5-52R	12	X	36		3.00		1		1	1		CLEARANCE STRIPER DOWN LEFT
-	28-05	155-56	30	Х	36	7.50			1		1	1		ADOPT A HIGHWAY SPONSOR
	28-06	J4-1	24	X	36	6.00			1		1	1		REASSURANCE ASSEMBLY
	28-07	J13-1	24	X	45	7.50			1		1	1		DIRECTIONAL WITHOUT CARDINAL
	28-08	R1-1	30	X	30	5.18		1			1	1		STOP SIGN
_	28-09	J1-1	24	Х	39	6.50			1		1	1		JUNCTION OR END ASSEMBLY
	28-10	W5-52R	12	X	36		3.00		1		1	1		CLEARANCE STRIPER DOWN LEFT
	28-11	I3-1	60	X	24	10.00		2			1	1		LAKE OR RIVER NAME
	28-12	W5-52L	12	Χ	36		3.00		1		1	1		CLEARANCE STRIPER DOWN RIGHT
	28-13	J12-1	24	Χ	45	7.50			1		1	1		ROUTE TURN WITHOUT CARDINAL
_	28-14	W1-7	48	Х	24		8.00	1			1	1		NIGHT ARROW (DOUBLE)
	29-01	J12-1	24	Х	45	7.50			1		1	1		ROUTE TURN WITHOUT CARDINAL
	29-02	W1-4L	30	Х	30		6.25		1		1	1		LEFT REVERSE CURVE
	29-03	W14-3	48	Х	36		6.00				1		29-04	NO PASSING ZONE
	29-04	J1-1	24	X	39	6.50			1		1	1	29-03	JUNCTION OR END ASSEMBLY
-	29-05	W5-52L	12	X	36		3.00		1		1	1		CLEARANCE STRIPER DOWN RIGHT
	29-06	I3-1	36	X	24	6.00		1			1	1		LAKE OR RIVER NAME
	29-07	W5-52R	12	Х	36		3.00		1		1	1		CLEARANCE STRIPER DOWN LEFT
	29-08	J12-1	24	X	45	7.50			1		1	1		ROUTE TURN WITHOUT CARDINAL
	29-09	J1-1	24	X	39	6.50			1		1	1		JUNCTION OR END ASSEMBLY
-	29-10	D7-68R	60	X	36	15.00			2		1	1		PEPIN COUNTY PARK (RIGHT ARROW) ONE DESTINATION (ARROW)
	29-11	D1-1	72	X	15	7.50			2		1		29-12	
	29-12	W14-3	48	X	36		6.00				1		29-11	NO PASSING ZONE LAKE OR RIVER NAME
	29-13 29-14	I3-1 W5-52R	36 12	X X	24 36	6.00	3.00	1	 1		1	1 1		CLEARANCE STRIPER DOWN LEFT
	29-14	W5-52K W5-52L	12	X	36		3.00 3.00		1		1	1		CLEARANCE STRIPER DOWN LEFT
-	29-16	J12-1	24	X	45	7.50			1		<u>'</u> 1	1		ROUTE TURN WITHOUT CARDINAL
	29-17	R1-1	30	X	30	5.18		1			1	1		STOP SIGN
	29-18	J13-1	24	X	45	7.50			1		1	1		DIRECTIONAL WITHOUT CARDINAL
	29-19	J1-1	24	X	39	6.50			1		1	1		JUNCTION OR END ASSEMBLY
	29-20	D7-68L	60	Х	36	15.00			2		1	1		PEPIN COUNTY PARK (LEFT ARROW)
-	29-21	J4-1	24	Х	36	6.00			1		1	1		REASSURANCE ASSEMBLY
	29-22	J13-1	24	Х	45	7.50			1		1	1		DIRECTIONAL WITHOUT CARDINAL
	29-23	R1-1	30	Х	30	5.18		1			1	1		STOP SIGN
	29-24	J12-1	24	Х	45	7.50			1		1	1		ROUTE TURN WITHOUT CARDINAL
	29-25	D1-2	84	Х	24	14.00		2			1	1		TWO DESTINATION (ARROW)
-	29-26	D1-1	72	Х	15	7.50		2			1	1		ONE DESTINATION (ARROW)
	29-27	D1-2	84	Х	24	14.00		2			1	1		TWO DESTINATION (ARROW)
	29-28	J12-1	24	Х	45	7.50			1		1	1		ROUTE TURN WITHOUT CARDINAL
	29-29	R1-1	30	Х	30	5.18		1			1	1		STOP SIGN
_	29-30	J13-1	24	Х	45	7.50			1		1	1		DIRECTIONAL WITHOUT CARDINAL
	29-31	J4-1	24	Χ	36	6.00			1		1	1		REASSURANCE ASSEMBLY
	29-32	S3-1	36	Χ	36		9.00		2		1	1		SCHOOL BUS STOP AHEAD
	30-01	J1-1	24	Χ	39	6.50			1		1	1		JUNCTION OR END ASSEMBLY
	30-02	W14-3	48	Χ	36		6.00		1		1	1		ROAD TO PEPIN COUNTY PARK 1 MILE
_	30-03	W5-52L	12	Х	36		3.00		1		1	1		CLEARANCE STRIPER DOWN RIGHT
	30-04	I3-1	54	Х	24	9.00		2			1	1		LAKE OR RIVER NAME
	30-05	W5-52R	12	Χ	36		3.00		1		1	1		CLEARANCE STRIPER DOWN LEFT
	30-06	W14-3	48	Χ	36		6.00		1		1	1		NO PASSING ZONE
	30-07	W5-52R	12	Х	36		3.00		1		1	1		CLEARANCE STRIPER DOWN LEFT
-	30-08	I3-1	54	Х	24	9.00		2			11	1		LAKE OR RIVER NAME

FILE NAME : G:\WDOTCO\14023 (2014 - 2016 DESIGN WORK ORDERS)\14023-019\CIVIL 3D\SHEETSPLAN\MQ\030201-MQ.DWG

HWY: USH 10

PROJECT NO: 1530-05-60

PLOT DATE : 12/7/2016

COUNTY: PIERCE

MISCELLANEOUS QUANTITIES

WISDOT/CADDS SHEET 42

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				SIGN			637.2230 SIGNS TYPE II	634.0614	634.0616	634.0618	REMOVING SIGNS	638.3000 REMOVING	SIGN	
				SIZE		REFLECTIVE	REFLECTIVE	POST	S WOOD 4X6-	INCH		SMALL SIGN	MOUNTED	
	SIGN	SIGN	W	Х	Н	Н	F	14 FT	16 FT	18 FT	TYPE II	SUPPORTS	ON SAME	
CATEGORY	#	CODE	IN		IN	SF	SF	EACH	EACH	EACH	EACH	EACH	POST AS	REMARKS
0010	SUB	TOTAL				1211.97	592.50	98	192	12	242	241		
-		WE 501	40				0.00							OLEADANOE OTRIBER ROWALRICHT
	30-09	W5-52L	12	X	36		3.00		1		1	1		CLEARANCE STRIPER DOWN RIGHT
	31-01 31-02	D7-68 S3-1	36	REMOVE X	36		9.00		2		1	1		ROAD TO PEPIN COUNTY PARK 1 MILE SCHOOL BUS STOP AHEAD
	31-02	S3-1	36	X	36		9.00		2		1	1		SCHOOL BUS STOP AHEAD
	31-04	R1-1	30	X	30	5.18		1			1	1		STOP SIGN
	31-05	W14-3	48	X	36		6.00		1		1	1		NO PASSING ZONE
	32-01	W14-3	48	Х	36		6.00		1		1	1	32-02	NO PASSING ZONE
	32-02	R59-51	36	Х	36	9.00					1		32-01	STOP FOR BUS FLASHING LIGHTS
	32-03	R1-1	30	Х	30	5.18		1			1	1		STOP SIGN
	32-04	J4-1	24	Х	36	6.00			1		1			REASSURANCE ASSEMBLY
•	32-05	D2-2	78	Х	24	13.00			2		1	2		DESTINATION/DISTANCE (TWO DESTINATION)
	32-06	R1-1	30	Х	30	5.18		1			1	1		STOP SIGN
	32-07	J1-1	24	X	39	6.50			1		1	1		JUNCTION OR END ASSEMBLY
	32-08	J2-3	72	X	57	28.50				2	1	2		ROUTE TURN ASSEMBLY
-	32-09	R1-1	30	Х	30	5.18		1			1	1		STOP SIGN
	32-10	D1-2	72	Х	30	15.00		2			1	2		TWO DESTINATION (ARROWS)
	32-11	J2-1	24	Х	57	9.50				1	1	1		ROUTE TURN ASSEMBLY
	32-12	W13-3	24	X	30		5.00	1			1	1		RAMP SPEED 20 MPH
	32-13	D1-2	72	Х	30	15.00		2			1	2		TWO DESTINATION (ARROWS)
	32-14	J3-1	24	Х	57	9.50				1	1	1		DIRECTIONAL ASSEMBLY
	32-15	J2-2	48	Х	36	12.00			1		1	1		ROUTE TURN ASSEMBLY
	32-16	155-56	30	Х	36	7.50			1		1	1		ADOPT A HIGHWAY SPONSOR
	32-17	J3-3	72	Х	57	28.50				2	1	2		ADOPT A HIGHWAY SPONSOR
	32-18	R1-1	36	X	36	7.46							POLE	ADOPT A HIGHWAY SPONSOR
-	33-01	J3-2	48	X	57	19.00				1	1	1		DIRECTIONAL ASSEMBLY
	33-02	R7-1R	18	X	24	3.00		1			1	1		NO PARKING ANY TIME (RIGHT ARROW)
	33-03	W14-3	48	X	36		6.00		1		1	1		NO PASSING ZONE
	33-04	R7-1L	18	X	24	3.00	2.00	1			1	1		NO PARKING ANY TIME (LEFT ARROW)
	33-05	W5-52L	12	X	36	40.00	3.00	4	1		1	1		CLEARANCE STRIPER DOWN RIGHT
-	33-06	I3-1 W5-52R	12	X	24 36	10.00	3.00	1			1	1		LAKE OR RIVER NAME CLEARANCE STRIPER DOWN LEFT
	33-07	R1-1	30	X	30	5.18	3.00	1			1	1		STOP SIGN
	33-09	R7-1D	18	X	24	3.00		1			1	1		NO PARKING ANY TIME (DOUBLE ARROW)
	33-10	R7-1L	18	X	24	3.00		1			1	1		NO PARKING ANY TIME (LEFT ARROW)
	33-11	I3-1	60	X	24	10.00		1			1	1		LAKE OR RIVER NAME
•	33-12	W5-52R	12	Х	36		3.00		1		1	1		CLEARANCE STRIPER DOWN LEFT
	33-13	W5-52L	12	X	36		3.00		1		1	1		CLEARANCE STRIPER DOWN RIGHT
	33-14	D5-65	36	X	36	9.00			2		1	2		COURT HOUSE HISTORICAL SITE 1 MILE
	33-15	R7-1D	18	Х	24	3.00		1			1	1		NO PARKING ANY TIME (DOUBLE ARROW)
	33-16	R7-1R	18	Х	24	3.00		1			1	1		NO PARKING ANY TIME (RIGHT ARROW)
•	34-01	W5-52L	12	Х	36		3.00		1		1	1		ROUTE TURN ASSEMBLY
	34-02	W5-52R	12	X	36		3.00		1		1	1		CLEARANCE STRIPER DOWN LEFT
	34-03	W14-3	48	Х	36		6.00		1		1	1	34-04	NO PASSING ZONE
	34-04	R59-51	36	X	36	9.00					1		34-03	STOP FOR BUS FLASHING LIGHTS
	34-05	W5-52R	12	Х	36		3.00		1		1	1		CLEARANCE STRIPER DOWN LEFT
	34-06	W5-52L	12	Х	36		3.00		1		1	1		CLEARANCE STRIPER DOWN RIGHT
	34-07	J1-1	24	Х	39	6.50			1		1	1		JUNCTION OR END ASSEMBLY
	34-08	155-56	30	X	36	7.50			1		1	1		ADOPT A HIGHWAY SPONSOR
	34-09	J4-2	48	X	36	12.00			1		1	1		REASSURANCE ASSEMBLY
-	34-10	J12-1	24	X	45	7.50			1		1	1		ROUTE TURN WITHOUT CARDINAL
	34-11	E10-82		ESTR		 7.50								TOURIST ORIENTED DIRECTIONAL SIGNS
	34-12	J12-1	24	X	45	7.50			1		1	1		ROUTE TURN WITHOUT CARDINAL
	34-13	R1-1	30	X	30	5.18		1			1	1		STOP SIGN
	34-14	J13-2	48	X	45	15.00			1		1	1		DIRECTIONAL WITHOUT CARDINAL
	34-15 34-16	W11-6	30 54	X	30	9.00	6.25	2	2		1	1		SNOWMOBILE CROSSING SYMBOL
	34-16	I2-3 T 1530-05-60	54	Х	24	9.00 1550.51	672.75	2 119	225	19	296	298		MUNICIPALITY SIGN-POP OR UNINC
	FRUJECI	1 1030-05-60	, IUIAL			TG.UGG1	672.75	119	223	19	290	290		

FILE NAME : G:\WDOTCO\14023 (2014 - 2016 DESIGN WORK ORDERS)\14023-019\CIVIL 3D\SHEETSPLAN\MQ\030201-MQ.DWG

PROJECT NO: 1530-05-60

PLOT DATE : 12/7/2016

WISDOT/CADDS SHEET 42

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STH 35 PERMANENT SIGNING TYPE II

			SIGN	I		637.2210 SIGNS TYPE II	637.2230 SIGNS TYPE II	634.0614	634.0616	634.0616 634.0618 S WOOD 4X6-INCH			SIGN	
			SIZE			REFLECTIVE	REFLECTIVE	POS	TS WOOD 4X6-	INCH	SIGNS	SMALL SIGN	MOUNTED	
	SIGN	SIGN	W	Х	Н	Н	F	14 FT	16 FT	18 FT	TYPE II	SUPPORTS	ON SAME	
CATEGORY	#	CODE	IN		IN	SF	SF	EACH	EACH	EACH	EACH	EACH	POST AS	REMARKS
0010														
	1-01	R1-4	18	Х	6	0.75					1		POLE, 1-02	ALL WAY
	1-02	R1-1	36	Х	36	7.46					1		POLE, 1-01	STOP SIGN
	1-03	R7-1D	24	Х	30	5.00					1		1-05	NO PARKING ANY TIME (DOUBLE ARROW)
	1-04	JV3-2	24	Х	81	13.50				1	1			ANY VERTICAL CONFIGURED J-PANEL
	1-05	J3-2	48	Х	57	19.00			1		1	1	1-03	DIRECTIONAL ASSEMBLY
	1-06	D7-53R	54	Х	36	13.50			2		1	1		PERROT STATE PARK (RIGHT ARROW)
	1-07	R7-1D	24	Χ	30	5.00		1			1	1		NO PARKING ANY TIME (DOUBLE ARROW)
	1-08	D1-3	84	Χ	42	24.50				2	1	2		THREE DESTINATION (ARROWS)
	1-09	W3-1	36	Χ	36		9.00		2		1	1		STOP AHEAD
	1-10	JV2-2	24	Χ	81	13.50				1	1	1	1-11	ANY VERTICAL CONFIGURED J-PANEL
	1-12	R7-1L	18	Χ	24	3.00		1			1	1		NO PARKING ANY TIME (LEFT ARROW)
	1-13	J2-4	96	Χ	57	38.00				2	1	2		ROUTE TURN ASSEMBLY
	1-14	R1-1	36	Χ	36	7.46					1		MAST ARM	STOP SIGN
	1-15	R1-3P	24	Х	9	1.50					1		1-16	ALL WAY
	1-16	R1-1	36	Х	36	7.46			1		1	1	1-15	STOP SIGN
	1-17	R7-1L	24	Х	30	5.00		1			1	1		NO PARKING ANY TIME (LEFT ARROW)
	1-18	J4-2	48	Х	36	12.00			1		1	2		REASSURANCE ASSEMBLY
	1-19	JV4-2	24	Х	60	10.00				1	1			ANY VERTICAL CONFIGURED J-PANEL
	1-20	R7-1D	24	Х	30	5.00		1			1	1		NO PARKING ANY TIME (DOUBLE ARROW)
	1-21	R2-1	24	Х	30	5.00		1			1	1		NO PARKING ANY TIME (DOUBLE ARROW)
	1-22	R7-1D	24	Х	30	5.00					1		1-23	NO PARKING ANY TIME (DOUBLE ARROW)
	1-23	W3-1	36	X	36		9.00		2		1	1	1-22	STOP AHEAD
	1-24	R7-1R	18	X	24	3.00		1			1	1		NO PARKING ANY TIME (RIGHT ARROW)
	1-25	R1-1	30	X	30	5.18		1			1	1		STOP SIGN
	1-25	D2-3	96	X	36	24.00				2	1	2		DESTINATION/DISTANCE (THREE DESTINATION)
	1-27	R2-1	24	X	30	5.00		1			1	1		SPEED LIMIT 45 MPH
		J1-1	24	X	39				1		1			JUNCTION OR END ASSEMBLY
	1-28					6.50						1		
	1-29	12-3	72	X	24	12.00		2			1	· ·		CENTERVILLE UNINCORPORATED
	1-31	JV4-2	24	X	60	10.00				1	1	1		ANY VERTICAL CONFIGURED J-PANEL
	1-32	W3-5	36	X	36		9.00		2		1	1		SPEED LIMIT 45 AHEAD (ARROW)
	1-33	R1-1	30	Х	30	5.18		1			1	1		STOP SIGN
	1-34	J12-1	24	Х	45	7.50			1		1	1		ROUTE TURN WITHOUT CARDINAL
	1-35	J1-1	24	Х	39	6.50			1		1	1		JUNCTION OR END ASSEMBLY
	1-36	R2-1	24	Х	30	5.00		1			1	1		SPEED LIMIT 45 MPH
	1-37	W14-3	48	Х	36		6.00		1		11	1		NO PASSING ZONE
	1-38	J12-1	24	Х	45	7.50			1		1	1		ROUTE TURN WITHOUT CARDINAL
	1-39	R1-1	30	Χ	30	5.18		1			1	1		STOP SIGN
	1-40	JV12-1	24	Χ	69	11.50				1	1	1		ANY VERTICAL CONFIGURED J-PANEL
	1-41	J4-3	72	Χ	36	18.00			2		1	1		REASSURANCE ASSEMBLY
	2-01	J1-1	24	Χ	39	6.50			1		1	1		JUNCTION OR END ASSEMBLY
	2-02	W5-52L	12	Χ	36		3.00		1		1	1		CLEARANCE STRIPER DOWN RIGHT
	2-03	W5-52R	12	X	36		3.00		1		1	1		CLEARANCE STRIPER DOWN LEFT
	2-04	W5-52R	12	Х	36		3.00		1		1	1		CLEARANCE STRIPER DOWN LEFT
	2-05	W5-52L	12	Х	36		3.00		1		1	1		CLEARANCE STRIPER DOWN RIGHT
	3-01	R1-1	30	Х	30	5.18		1			1	1		STOP SIGN
	4-01	R1-1	30	Х	30	5.18		1			1	1		STOP SIGN
	5-01	E10-82		ESTR										TOURIST ORIENTED DIRECTIONAL SIGNS
	5-02	R1-1	30	Х	30	5.18		1			1	1		STOP SIGN
		TOTAL						•			47	•		2.2.000.

HWY: STH 35 COUNTY: TREMPEALEAU MISCELLANEOUS QUANTITIES PROJECT NO: 7150-00-60 PLOT DATE : 12/7/2016

PLOT BY : KL ENGINEERING PLOT NAME :PLOT SCALE : 1:1.185

				SIGN		637.2210 SIGNS TYPE II	637.2230 SIGNS TYPE II	634.0614	634.06	634.0618	638.2602 REMOVING	638.3000 REMOVING	SIGN			
				SIZE		REFLECTIVE	REFLECTIVE	POSTS	S WOOD 4X	6-INCH	SIGNS	SMALL SIGN	MOUNTED			
	SIGN	SIGN	W	X	Н	Н	F	14 FT	16 FT	18 FT	TYPE II	SUPPORTS	ON SAME			
CATEGORY	#	CODE	IN		IN	SF	SF	EACH	EACH	EACH	EACH	EACH	POST AS	REMARKS		
0010	SUB	TOTAL				355.71	45.00	16	23	11	47	43				
_																
	5-03	R1-1	30	Χ	30	5.18		1			1	1		STOP SIGN		
	6-01	E10-82		ESTR										TOURIST ORIENTED DIRECTIONAL SIGNS		
	6-02	W14-3	48	Χ	36		6.00		1		1	1		NO PASSING ZONE		
	6-03	D7-68	F	REMOV	E						1	2		ROAD TO NATIONAL WILDLIFE REFUGE 1/2 MILE		
_	6-04	M1-88	F	REMOV	E						1			BINOCULAR SYMBOL		
	6-05	R1-1	30	Χ	30	5.18		1			1	1		STOP SIGN		
	6-06	D7-77R	60	Χ	36	15.00			2		1	2		NATIONAL WILDLIFE REFUGE (RIGHT ARROW)		
	6-07	D7-77L	60	Χ	36	15.00			2		1	2		NATIONAL WILDLIFE REFUGE (LEFT ARROW)		
	6-08	J1-1	24	Χ	39	6.50			1		1	1		JUNCTION OR END ASSEMBLY		
_	7-01	J4-4	96	Х	36	24.00			2		1	1		REASSURANCE ASSEMBLY		
	7-03	W1-7	48	Χ	24		8.00	1			1	1		NIGHT ARROW (DOUBLE)		
	7-04	J12-1	24	Χ	45	7.50			1		1	1		ROUTE TURN WITHOUT CARDINAL		
	7-05	D1-1	78	Χ	15	8.13		2			1	1		ONE DESTINATION (ARROW)		
	7-06	D1-1	78	Χ	15	8.13		2			1	1		ONE DESTINATION (ARROW)		
_	7-07	J12-1	24	Χ	45	7.50			1		1	1		ROUTE TURN WITHOUT CARDINAL		
	7-08	R1-1	30	Χ	30	5.18		1			1	1		STOP SIGN		
	7-09	J12-2	48	Χ	45	15.00			1		1	1		ROUTE TURN WITHOUT CARDINAL		
	7-10	J4-4	96	Χ	36	24.00			2		1	1		AMERICA'S BYWAYS		
	7-12	D7-68	F	REMOV	E						1	2	7-13	ROAD TO NATIONAL WILDLIFE REFUGE 1/2 MILE		
_	7-13	M1-88	F	REMOV	E						1		7-12	BINOCULAR SYMBOL		
	7-14	J1-1	24	Χ	39	6.50			1		1	1		JUNCTION OR END ASSEMBLY		
	7-15	W14-3	48	Χ	36		6.00		1		1	1		NO PASSING ZONE		
	7-16	W14-3	48	Χ	36		6.00		1		1	1		NO PASSING ZONE		
	8-01	R1-1	30	Χ	30	5.18		1			1	1		STOP SIGN		
_	8-02	W14-3	48	Χ	36		6.00		1		1	1		NO PASSING ZONE		
	8-03	W14-3	48	Χ	36		6.00		1		1	1		NO PASSING ZONE		
	8-04	W5-52L	12	Χ	36		3.00		1		1	1		CLEARANCE STRIPER DOWN RIGHT		
	8-05	I3-1	72	Χ	24	12.00		2			1	1		LAKE OR RIVER NAME		
	8-06	W5-52R	12	Χ	36		3.00		1		1	1		CLEARANCE STRIPER DOWN LEFT		
_	9-01	W5-52R	12	Х	36		3.00		1		1	1		CLEARANCE STRIPER DOWN LEFT		
	9-02	W5-52L	12	Χ	36		3.00		1		1	1		CLEARANCE STRIPER DOWN RIGHT		
	9-03	W14-3	48	Χ	36		6.00		1		1	1		NO PASSING ZONE		
	9-04	W14-3	48	Χ	36		6.00		1		1	1		NO PASSING ZONE		
	9-05	W5-52L	12	Χ	36		3.00		1		1	1		CLEARANCE STRIPER DOWN RIGHT		
_	9-06	I3-1	72	Х	24	12.00		2			1	1		LAKE OR RIVER NAME		
	9-07	W5-52R	12	Χ	36		3.00		1		1	1		CLEARANCE STRIPER DOWN LEFT		
	9-08	12-2	90	Χ	15	9.38		2			1	2		TREMPEALEAU COUNTY		
	9-09	W5-52R	12	Χ	36		3.00		1		1	1		CLEARANCE STRIPER DOWN LEFT		
	9-10	W5-52L	12	Χ	36		3.00		1		1	1		CLEARANCE STRIPER DOWN RIGHT		
	9-11	J1-1	24	X	39	6.50			1		1	1		JUNCTION OR END ASSEMBLY		
	PROJECT 7°	150-00-60 TOT	TAL			553.57	119.00	31	52	11	86	85				

HWY: STH 35 COUNTY: TREMPEALEAU MISCELLANEOUS QUANTITIES SHEET PROJECT NO: 7150-00-60

USH 63 PERMANENT SIGNING TYPE II

				SIGN		637.2210 SIGNS TYPE II	637.2230 SIGNS TYPE II	634.0612	634.0614	634.0616	634.0618	634.0620	638.2602 REMOVING	638.3000 REMOVING	SIGN	
	SIGN	SICN	14/	SIZE	ы	REFLECTIVE	REFLECTIVE F	12 ET	14 FT	S WOOD 4X6-		20FT	- SIGNS TYPE II	SMALL SIGN	MOUNTED	
CATEGORY	#	SIGN CODE	W IN	Х	H IN	H SF	SF	12 FT EACH	EACH	16 FT EACH	18 FT EACH	EACH	EACH	SUPPORTS EACH	ON SAME POST AS	REMARKS
0010	· · ·	OODL	114		1111	01	OI .	LAOIT	LAOIT	LAOIT	LAOIT	LAOIT	LAGIT	LAOIT	100170	KEWAKKO
00.0																
-	1-01	R5-1	30	Х	30	6.25							1		1-02	DO NOT ENTER
	1-02	J3-3	72	X	57	28.50					2		1	2	1-01	DIRECTIONAL ASSEMBLY
	1-03	D1-2	72	X	30	15.00			2				1	2		TWO DESTINATION (ARROWS)
	1-04	J2-1	24	Х	57	9.50					2		1	2		ROUTE TURN ASSEMBLY
	1-05	R1-1	36	Х	36	7.46				1			1	1		STOP SIGN
-	1-06	R5-1A	36	Х	24	6.00			1				1	1		WRONG WAY
	1-07	R4-7	36	Х	48	12.00				1			1	1		KEEP RIGHT
	1-08	J4-2	48	Х	36	12.00				1			1	1		REASSURANCE ASSEMBLY
	1-09	R2-1	24	Х	30	5.00			1				1	1		SPEED LIMIT 40 MPH
	1-10	J2-3	72	Х	57	28.50					2		1	2		ROUTE TURN ASSEMBLY
-	1-11	J4-2	48	Х	36	12.00				1			1	1		REASSURANCE ASSEMBLY
	1-12	W3-5	36	Х	36		9.00			2			1	1		SPEED LIMIT 40 AHEAD (ARROW)
	1-13	155-56	30	Х	36	7.50				1			1	1		ADOPT A HIGHWAY SPONSOR
	1-14	R2-1	24	Х	30	5.00			1				1	1		SPEED LIMIT 55 MPH
	1-15	W14-3	48	Х	36		6.00			1			1	1		NO PASSING ZONE
-	1-16	R59-51	36	Х	36	9.00				1			1	1		STOP FOR BUS FLASHING LIGHTS
	2-01	W14-3	48	Х	36		6.00			1			1	1		NO PASSING ZONE
	2-02	R1-1	30	X	30	5.18			1				1	1		STOP SIGN
	2-03	R1-1	30	Х	30	5.18			1				1	1		STOP SIGN
	3-01	W14-3	48	X	36		6.00			1			1	1		NO PASSING ZONE
-	3-02	W14-3	48	X	36		6.00			1			1	1		NO PASSING ZONE
	3-03	J2-2	48	X	57	19.00					1		1	1		ROUTE TURN ASSEMBLY
	3-04	R1-1	30	X	30	5.18			1				1	1		STOP SIGN
	3-05	D1-2	66	X	30	13.75			2				1	2		TWO DESTINATION (ARROWS)
	3-06	J3-2	48	X	57	19.00					1		1	1		DIRECTIONAL ASSEMBLY
-	3-07	155-56	30	Х	36	7.50				1			1	1		ADOPT A HIGHWAY SPONSOR
	3-08	155-56	30	X	36	7.50				1			1	1		ADOPT A HIGHWAY SPONSOR
	4-01	D2-1	72	X	15	7.50				2			1	2		DESTINATION/DISTANCE (ONE DESTINATION)
	4-02	J4-2	48	X	36	12.00				1			1			REASSURANCE ASSEMBLY
	4-03	J2-2	48	X	57	19.00					1		1			ROUTE TURN ASSEMBLY
-	4-04	J3-1	24	X	57	9.50					1		1	1		DIRECTIONAL ASSEMBLY
	4-05	D1-2	72	X	30	15.00			2				1	2		TWO DESTINATION (ARROWS)
	4-06	J1-1	24	X	39	6.50				1			1	1		JUNCTION OR END ASSEMBLY
	4-07	J2-2	48	X	57	19.00					1		1	1		ROUTE TURN ASSEMBLY
	4-09	J1-1	24	X	39	6.50				1			1	1		JUNCTION OR END ASSEMBLY
	4-10	D2-2	66	X	24	11.00				2			1	2		DESTINATION/DISTANCE (ONE DESTINATION)
	4-11	J4-1	24	X	36	6.00				1			1			REASSURANCE ASSEMBLY
	4-12	J13-1	24	X	45	7.50				1			1	1		DIRECTIONAL WITHOUT CARDINAL
	4-13	J13-1	24	X	45	7.50				1			1	1		DIRECTIONAL WITHOUT CARDINAL
_	4-14	J1-1	24	X	39	6.50				1			1	1		JUNCTION OR END ASSEMBLY
	4-15	R1-1	30	X	30	5.18			1				1	1		STOP SIGN
	4-16	J13-1	24	X	45	7.50				1			1	1		DIRECTIONAL WITHOUT CARDINAL
	4-17	W1-6	48	X	24		8.00		1				1	1		NIGHT ARROW (SINGLE)
	4-18	W14-3	48	X	36		6.00			1			1	1		NO PASSING ZONE
-	5-01	W5-52L	12	X	36		3.00		1				1	1		CLEARANCE STRIPER DOWN RIGHT
		W5-52L W5-52R	12	X	36		3.00		1				1	1		CLEARANCE STRIPER DOWN RIGHT
	5-02 5-03	W5-52R W5-52R	12	X	36		3.00		1				1	1		CLEARANCE STRIPER DOWN LEFT CLEARANCE STRIPER DOWN LEFT
	5-03 5-04	W5-52R W5-52L	12	X	36		3.00		1				1	1		CLEARANCE STRIPER DOWN LEFT CLEARANCE STRIPER DOWN RIGHT
			12 48		36 36								1	1		
_	5-05	W14-3 FOTAL	40	Х	30	392.18	6.00 65.00		18	28	11		49	53		NO PASSING ZONE

FILE NAME : G:\WDOTCO\14023 (2014 - 2016 DESIGN WORK ORDERS)\14023-019\CIVIL 3D\SHEETSPLAN\MQ\030201-MQ.DWG

PROJECT NO: 7210-00-60

HWY: USH 63

PLOT DATE : 12/7/2016

COUNTY: PIERCE

MISCELLANEOUS QUANTITIES

PLOT BY : KL ENGINEERING PLOT NAME :PLOT SCALE : 1:1.185

WISDOT/CADDS SHEET 42

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USH 63 PERMANENT SIGNING TYPE II (CONTINUED)

				SIGN		637.2210 SIGNS TYPE II	637.2230 SIGNS TYPE II	634.0612	634.0614	634.0616	634.0618	634.0620	0 638.2602 REMOVING SIGNS	NG REMOVING S SMALL SIGN	SIGN	
				SIZE		REFLECTIVE	REFLECTIVE		POST	TS WOOD 4X6			SIGNS	SMALL SIGN	MOUNTED	
	SIGN	SIGN	W	Χ	Н	Н	F	12 FT	14 FT	16 FT	18 FT	20FT	TYPE II	SUPPORTS	ON SAME	
ATEGORY	#	CODE	IN		IN	SF	SF	EACH	EACH	EACH	EACH	EACH	EACH	EACH	POST AS	REMARKS
0010						392.18	65.00		18	28	11		49	53		
-	5-06	W11-6	30	Х	30		6.25			1			1	1		SNOWMOBILE CROSSING SYMBOL
	5-07	155-56	30	Χ	36	7.50				1			1	1		ADOPT A HIGHWAY SPONSOR
	6-01	R1-1	30	Χ	30	5.18			1				1	1		STOP SIGN
	6-02	W11-6	30	Χ	30		6.25			1			1	1		SNOWMOBILE CROSSING SYMBOL
-	6-03	W2-1	30	Х	30		6.25			1			1	1		CROSS ROAD
	6-04	R1-1	30	Χ	30	5.18			1				1	1		STOP SIGN
	6-05	155-56	30	Χ	36	7.50				1			1	1		ADOPT A HIGHWAY SPONSOR
	6-06	E10-82		ESTR												TOURIST ORIENTED DIRECTIONAL SIG
	6-07	W14-3	48	Χ	36		6.00			1			1	1		NO PASSING ZONE
_	6-08	W14-3	48	Х	36		6.00			1			1	1		NO PASSING ZONE
	7-01	J1-1	24	Х	39	6.50				1			1	1	7-02	JUNCTION OR END ASSEMBLY
	7-02	W14-3	48	Х	36		6.00						1		7-01	NO PASSING ZONE
	7-03	J4-1	24	Χ	36	6.00				1			1	1		REASSURANCE ASSEMBLY
	7-04	R1-1	30	Χ	30	5.18			1				1	1		STOP SIGN
	7-05	J13-1	24	Χ	45	7.50				1			1	1		DIRECTIONAL WITHOUT CARDINAL
_	7-06	E10-82		ESTR												TOURIST ORIENTED DIRECTIONAL SIG
	7-07	E10-82		ESTR												TOURIST ORIENTED DIRECTIONAL SIG
	7-08	J12-1	24	Χ	45	7.50				1			1	1		ROUTE TURN WITHOUT CARDINAL
	7-09	R1-1	30	Χ	30	5.18			1				1	1		STOP SIGN
	7-10	J13-1	24	Х	45	7.50				1			1	1		DIRECTIONAL WITHOUT CARDINAL
-	7-11	J4-1	24	Х	36	6.00				1			1	1		REASSURANCE ASSEMBLY
	8-01	J1-1	24	Х	39	6.50	6.50			1			1	1		JUNCTION OR END ASSEMBLY
	8-02	W5-52L	12	Х	36		3.00		1				1	1		CLEARANCE STRIPER DOWN RIGHT
	8-03	W5-52R	12	Х	36		3.00		1				1	1		CLEARANCE STRIPER DOWN LEFT
	8-04	W5-52R	12	Х	36		3.00		1				1	1		CLEARANCE STRIPER DOWN LEFT
-	8-05	W5-52L	12	Х	36		3.00		1				1	1		CLEARANCE STRIPER DOWN RIGHT
	9-01	W14-3	48	Х	36		6.00			1			1	1		NO PASSING ZONE
	9-02	155-56	30	Х	36	7.50				1			1	1		ADOPT A HIGHWAY SPONSOR
	9-03	R7-1L	24	Х	30	5.00			1				1	1		NO PARKING ANY TIME (LEFT ARROW
	9-04	J4-1	24	X	36	6.00				1			1	1		REASSURANCE ASSEMBLY
-	9-05	R7-1R	24	X	30	5.00			1				1	1		NO PARKING ANY TIME (RIGHT ARROV
	9-06	J13-1	24	X	45	7.50			· 	1			1	1		DIRECTIONAL WITHOUT CARDINAL
	9-07	R1-1	30	X	30	5.18			1				1	1		STOP SIGN
	9-08	J1-1	24	X	36	6.00			· 	1			1	1		JUNCTION OR END ASSEMBLY
	9-09	W11-6	30	X	30		6.25				1		1	1		SNOWMOBILE CROSSING SYMBOL
-	9-09	J13-1	24	X	45	7.50	6.25			1			1	1		DIRECTIONAL WITHOUT CARDINAL
	9-10 9-11	J13-1 J13-1	24	X	45 45	7.50 7.50				1			1	1		DIRECTIONAL WITHOUT CARDINAL
	9-11 9-12	J13-1 J1-1	24	X	45 39	7.50 6.50				1			1	1		JUNCTION OR END ASSEMBLY
	9-12 9-13	R1-1	30	X	39	5.18			1				1	1		STOP SIGN
	9-13 9-14	W11-6	30	X	30	5.16	6.25				1		1	1		SNOWMOBILE CROSSING SYMBOL
-	9-14	R1-1	30	X	30	5.18	6.25		1				1	1		STOP SIGN
	9-15 9-16	J13-1	24	X	30 45	5.16 7.50				1			1	1		DIRECTIONAL WITHOUT CARDINAL
	9-16 9-17	J13-1 J4-1	24	X	45 36	6.00				1			1	1		REASSURANCE ASSEMBLY
	9-17 9-18	J4-1 I55-56	30	X	36					1			1	1		ADOPT A HIGHWAY SPONSOR
						7.50				· ·			1	•		
-	10-01	W14-3	48	X	36		6.00			1			1	1		NO PASSING ZONE
	10-02	W14-3	48	X	36	 F 40	6.00			1			1	1		NO PASSING ZONE
	11-01	R1-1	30	X	30	5.18			1	4			1	1		STOP SIGN
	11-02	W14-3	48	X	36		6.00			1			1	1		NO PASSING ZONE
	11-03	R1-1	30	X	30	5.18			1				1	1		STOP SIGN
_	13-01	R1-1 FOTAL	30	Х	30	5.18			1 34				1	1		STOP SIGN

FILE NAME : G:\WDOTCO\14023 (2014 - 2016 DESIGN WORK ORDERS)\14023-019\CIVIL 3D\SHEETSPLAN\MQ\030201-MQ.DWG

PROJECT NO: 7210-00-60

HWY: USH 63

PLOT DATE : 12/**7**/2016

COUNTY: PIERCE

MISCELLANEOUS QUANTITIES

PLOT BY : KL ENGINEERING PLOT NAME :PLOT SCALE : 1:1.185

WISDOT/CADDS SHEET 42

Ε

			SIG			637.2210 SIGNS TYPE II REFLECTIVE	637.2230 SIGNS TYPE II	634.0612	634.0614	634.062	634.0618	634.0620	638.2602 REMOVING	638.3000 REMOVING	SIGN		
				SIZ	Œ		REFLECTIVE	REFLECTIVE		POST	S WOOD 4X6	6-INCH		SIGNS	SMALL SIGN	MOUNTED	
	SIGN	SIGN	W	Х	- 1	Н	Н	F	12 FT	14 FT	16 FT	18 FT	20FT	TYPE II	SUPPORTS	ON SAME	
ATEGORY	#	CODE	IN		I	N	SF	SF	EACH	EACH	EACH	EACH	EACH	EACH	EACH	POST AS	REMARKS
0010	SUB	TOTAL					585.98	156.75		34	56	13		96	99		
	14-01	R1-1	30	X	3	30	5.18			1				1	1		STOP SIGN
	14-02	W14-3	48	Х	3	36		6.00			1			1	1		NO PASSING ZONE
	14-03	W5-52L	12	Х	3	36		3.00		1				1	1		CLEARANCE STRIPER DOWN RIGHT
	14-04	W5-52R	12	X	3	36		3.00		1				1	1		CLEARANCE STRIPER DOWN LEFT
	14-05	W5-52R	12	Х	3	36		3.00		1				1	1		CLEARANCE STRIPER DOWN LEFT
	14-06	W5-52L	12	Х	3	36		3.00		1				1	1		CLEARANCE STRIPER DOWN RIGHT
	14-07	J1-1	24	Х	3	39	6.50				1			1	1		JUNCTION OR END ASSEMBLY
	15-01	155-56	30	Х	3	36	7.50				1			1	1		ADOPT A HIGHWAY SPONSOR
	15-02	J4-1	24	Х	3	36	6.00				1			1	1		REASSURANCE ASSEMBLY
	15-03	J13-1	24	Х	4	4 5	7.50				1			1	1		DIRECTIONAL WITHOUT CARDINAL
	15-04	R1-1	30	Х	3	30	5.18			1				1	1		STOP SIGN
	15-05	J13-1	24	Х	4	45	7.50				1			1	1		DIRECTIONAL WITHOUT CARDINAL
	15-06	J13-1	24	Х	4	45	7.50				1			1	1		DIRECTIONAL WITHOUT CARDINAL
	15-07	R1-1	30	Х	3	30	5.18			1				1	1		STOP SIGN
	15-08	J4-1	24	Х	3	36	6.00				1			1	1		REASSURANCE ASSEMBLY
	15-09	155-56	30	Х	3	36	7.50				1			1	1	15-10	ADOPT A HIGHWAY SPONSOR
	15-10	W14-3	48	Х	3	36		6.00						1		15-09	NO PASSING ZONE
	15-11	W14-3	48	Х	3	36		6.00			1			1	1		NO PASSING ZONE
	15-12	J1-1	24	Х	3	39	6.50				1			1	1		JUNCTION OR END ASSEMBLY
	15-13	W1-8	18	Х	2	24		3.00						1		15-14	CHEVRON
	15-14	J4-1	24	Х	3	36	6.00				1			1	1	15-13	REASSURANCE ASSEMBLY
	15-15	W1-8	18	Х	2	24		3.00	1					1	1	15-16	CHEVRON
	15-16	W1-8	18	Х	2	24		3.00						1		15-15	CHEVRON
	15-17	J13-1	24	Х	5	57	7.50				1			1	1		US ROUTE MARKER
	15-18	R1-1	30	Х	3	30	5.19			1				1	1		STOP SIGN
	15-19	J13-1	24	Х		45	7.50				1			1	1		DIRECTIONAL WITHOUT CARDINAL
	15-20	J1-1	24	Х	3	39	6.50				1			1	1		JUNCTION OR END ASSEMBLY
	15-21	W1-2R	30	Х	3	30		6.25				1		1	1	15-24	RIGHT CURVE
	15-22	W13-1	18	Х	1	18		2.25						1		15-23	ADVISORY SPEED (YELLOW BACK)
	15-23	W1-8	18	Х	2	24		3.00	1					1	1	15-26	CHEVRON
	15-24	W1-8	18	Х	2	24		3.00						1		15-25	CHEVRON
	16-01	W1-8	18	Х	2	24		3.00	1					1	1	16-02	CHEVRON
	16-02	W1-8	18	Х	2	24		3.00						1		16-01	CHEVRON
	16-03	W1-8	18	Х	2	24		3.00	1					1	1	16-04	CHEVRON
	16-04	W1-8	18	Х	2	24		3.00						1		16-03	CHEVRON
	16-05	W1-8	18	X		24		3.00	1					1	1	16-06	CHEVRON
	16-06	W1-8	18	Х		24		3.00						1		16-05	CHEVRON
	16-07	W1-8	18	Х		24		3.00	1					1	1	16-08	CHEVRON
	16-08	W1-8	18	X		24		3.00	1					1	1	16-07	CHEVRON
	16-09	R1-1	30	X		30	5.18			1				1	1		STOP SIGN
	16-10	R1-1	36	X		36	7.46				1			1	1		STOP SIGN
	16-11	W1-8	18	Х		24		3.00	1					1	1	16-12	CHEVRON
	16-12	W1-8	18	X		24		3.00						1		16-11	CHEVRON
	16-13	J13-1	24	X		- · 45	7.50				1			1	1		DIRECTIONAL WITHOUT CARDINAL
	16-14	W1-2L	30			30		6.25			1			1	1	16-15	LEFT CURVE
	16-15	W13-1	18			18		2.25						1		16-14	ADVISORY SPEED (YELLOW BACK)
	16-16	J1-1	24			39	6.50				1			1	1		JUNCTION OR END ASSEMBLY
		TOTAL				-	723.35	248.75	8	43	75	14		143	136		

COUNTY: PIERCE HWY: USH 63 MISCELLANEOUS QUANTITIES SHEET PROJECT NO: 7210-00-60

FILE NAME : G:\WDOTCO\14023 (2014 - 2016 DESIGN WORK ORDERS)\14023-019\CIVIL 3D\SHEETSPLAN\MQ\030201-MQ.DWG

PLOT DATE : 12/7/2016

				SIGN	ı	637.2210 SIGNS TYPE II	637.2230 SIGNS TYPE II	634.0612	634.0614	634.0616	634.0618	634.0620	638.2602 REMOVING	638.3000 REMOVING	SIGN	
				SIZE		REFLECTIVE	REFLECTIVE		POS	TS WOOD 4X6	-INCH		SIGNS	SMALL SIGN	MOUNTED	
	SIGN	SIGN	W	Х	Н	Н	F	12 FT	14 FT	16 FT	18 FT	20FT	TYPE II	SUPPORTS	ON SAME	
CATEGORY	#	CODE	IN		IN	SF	SF	EACH	EACH	EACH	EACH	EACH	EACH	EACH	POST AS	REMARKS
0010	SUE	STOTAL				723.35	248.75	8	43	75	14		143	136		
																OPERA LIMIT AS ALIEAD (ADDOLLA)
	16-17	W3-5	36	X	36		9.00			2			1	1		SPEED LIMIT 45 AHEAD (ARROW)
	16-18 16-19	I2-3-U R1-1	54 30	X X	24 30	9.00 5.18			2 1				1 1	1		MARTELL UNINCORPORATED STOP SIGN
	16-20	W2-1	30	X	30	3.16	6.25			1			1	1		CROSS ROAD
	16-21	R2-1	24	X	30	5.00			1				1	1		SPEED LIMIT 45 MPH
	16-22	R2-1	24	X	30	5.00			1				1	1		SPEED LIMIT 55 MPH
	17-01	R1-1	30	Х	30	5.18			1				1	1		STOP SIGN
	17-02	R2-1	24	Х	30	5.00			1				1	1		SPEED LIMIT 45 MPH
	17-03	W5-52L	12	Х	36		3.00		1				1	1		CLEARANCE STRIPER DOWN RIGHT
	17-04	W5-52R	12	Х	36		3.00		1				1	1		CLEARANCE STRIPER DOWN LEFT
	17-05	I3-1	36	Х	24	6.00				1			1	1	17-06	LAKE OR RIVER NAME
	17-06	R9-55	18	Χ	24	3.00							1		17-05	NO FISHING FROM BRIDGE
	17-07	W3-5	36	Χ	36		9.00				2		1	1		SPEED LIMIT 45 AHEAD (ARROW)
	17-08	R1-1	30	Χ	30	5.18			1				1	1		STOP SIGN
	17-09	R1-1	30	Х	30	5.18			1				1	1		STOP SIGN
	17-10	R1-1	30	Х	30	5.18			1				1	1		STOP SIGN
	17-11	R2-1	24	Х	30	5.00			1				1	1		SPEED LIMIT 55 MPH
	17-12	W5-52R	12	Х	36		3.00		1				1	1		CLEARANCE STRIPER DOWN LEFT
	17-13	I3-1	36	X	24	6.00				1			1	1	17-13	LAKE OR RIVER NAME
	17-14	R9-55	18	X	24	3.00							1		17-14	NO FISHING FROM BRIDGE
	17-15	W14-3	48	X	36		6.00			1			1	1		NO PASSING ZONE
	17-16	W5-52L	12	X	36	0.00	3.00		1				1	1		CLEARANCE STRIPER DOWN RIGHT
	17-17 17-18	I2-3-U W14-3	54 48	X X	24 36	9.00	6.00		2	1			1	2 1		MARTELL UNINCORPORATED NO PASSING ZONE
	18-01	W14-3 R1-1	30	X	30	5.18	6.00		1				1	1		STOP SIGN
	18-02	W14-3	48	X	36		6.00			1			1	1		NO PASSING ZONE
	18-03	D5-61	48	X	24	8.00			1				1	1		WAYSIDE [1/2] MILE
	18-04	W1-2L	30	X	30		6.25				1		1	1	18-05	LEFT CURVE
	18-05	W13-1	18	Х	18		2.25						1		18-04	ADVISORY SPEED (YELLOW BACK)
	18-06	W14-3	48	Х	36		6.00			1			1	1		NO PASSING ZONE
	18-07	J1-1	24	Х	39	6.50				1			1	1		JUNCTION OR END ASSEMBLY
	19-01	155-56	30	Х	36	7.50				1			1	1		ADOPT A HIGHWAY SPONSOR
	19-02	J4-1	24	Х	36	6.00				1			1			REASSURANCE ASSEMBLY
	19-03	D2-2	78	Х	24	13.00				2			1	2		DESTINATION/DISTANCE (TWO DESTINATION)
	19-04	R1-1	30	Х	30	5.18			1				1	1		STOP SIGN
	19-05	W1-7	48	Х	24		8.00			1			1	1	19-06	NIGHT ARROW (DOUBLE)
	19-06	D5-62R	48	Χ	24	8.00			1				1	1		WAYSIDE (RIGHT ARROW)
	19-07	J3-2		ESTF	?											DIRECTIONAL ASSEMBLY
	19-08	W1-10L	30	Χ	30		6.25				1		1	1		COMBINATION LEFT CURVE/INTERSECTION
	19-09	D1-3	90	Х	36	22.50						2	1	2	19-10	THREE DESTINATION (ARROWS)
	19-10	D1-1	90	Х	15	9.38							1		19-09	ONE DESTINATION (ARROW)
	19-11	W1-6	48	Х	24		8.00		1				1	1		NIGHT ARROW (SINGLE)
	19-12	R1-1	30	X	30	5.18			1				1	1		STOP SIGN
	19-13	D5-62L	48	X	24	8.00			1				1	1		WAYSIDE (LEFT ARROW)
	19-14	J3-3	72	X	57	28.50						2	11	2		DIRECTIONAL ASSEMBLY
	19-15	R5-1	30	X	30	6.25			1				1	1		DO NOT ENTER
	19-16 19-17	J4-2 J2-3	72	ESTF X	c 57	28.50						2				REASSURANCE ASSEMBLY ROUTE TURN ASSEMBLY
	19-17	JZ-3	12	^	3/	20.50						2				KOUTE TURN ASSEMBLY
	PROJECT 7	210-00-60 TO	ΓAL			972.91	339.75	8	68	90	18	6	188	180		

FILE NAME : G:\WDOTCO\14023 (2014 - 2016 DESIGN WORK ORDERS)\14023-019\CIVIL 3D\SHEETSPLAN\MQ\030201-MQ.DWG

HWY: USH 63

PROJECT NO: 7210-00-60


PLOT DATE : 12/7/2016


MISCELLANEOUS QUANTITIES

WISDOT/CADDS SHEET 42


SHEET


COUNTY: PIERCE

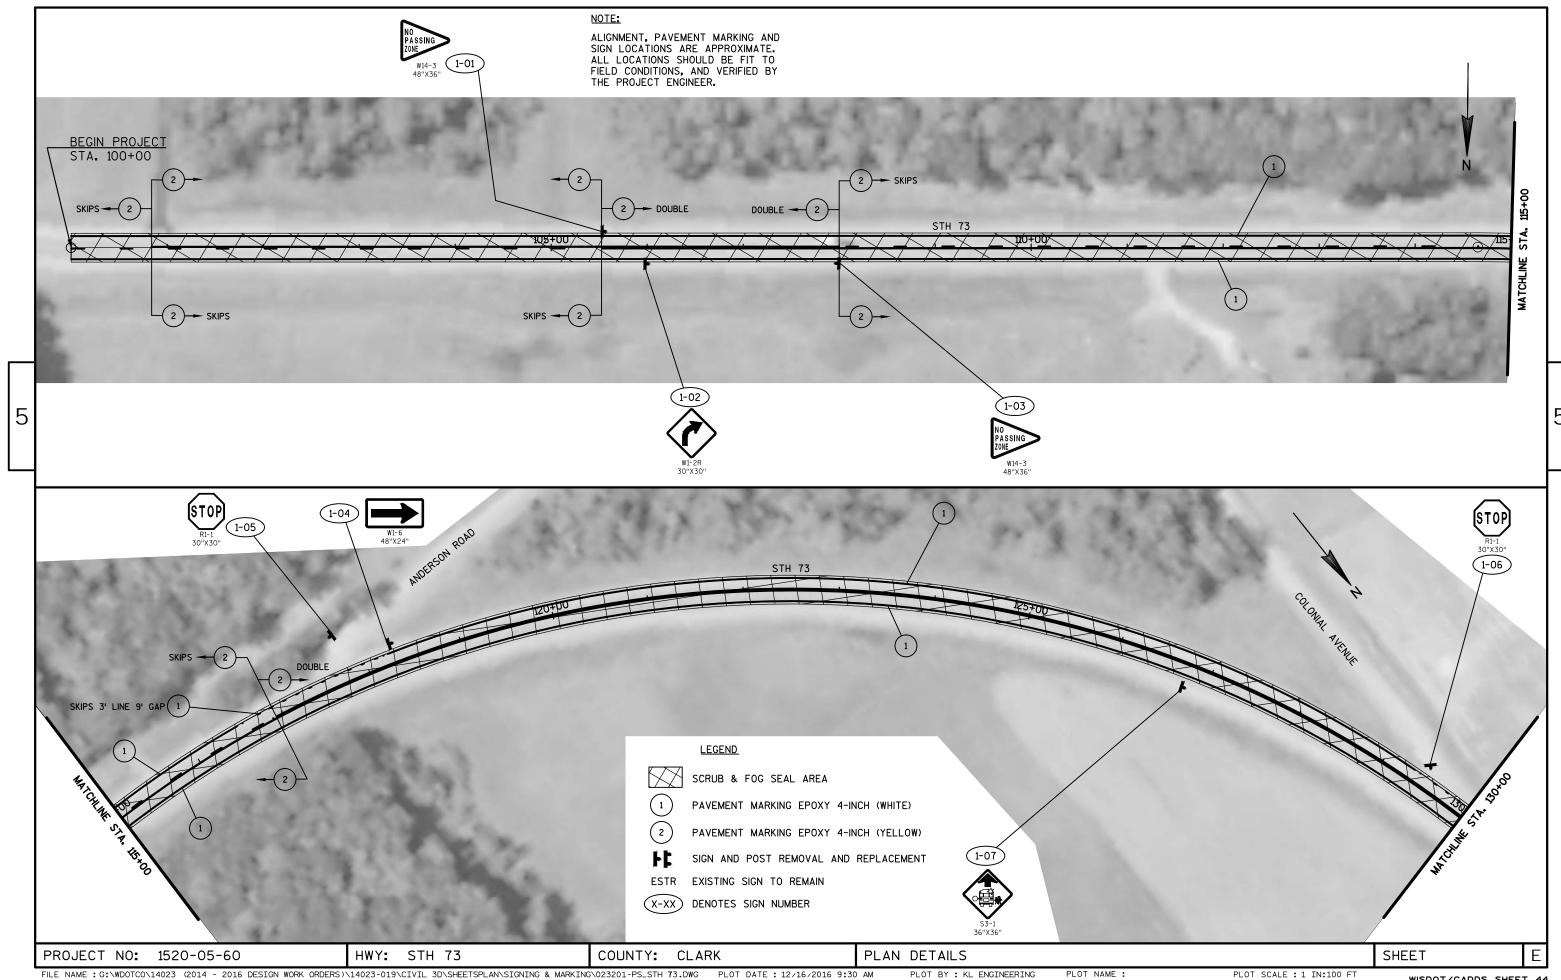


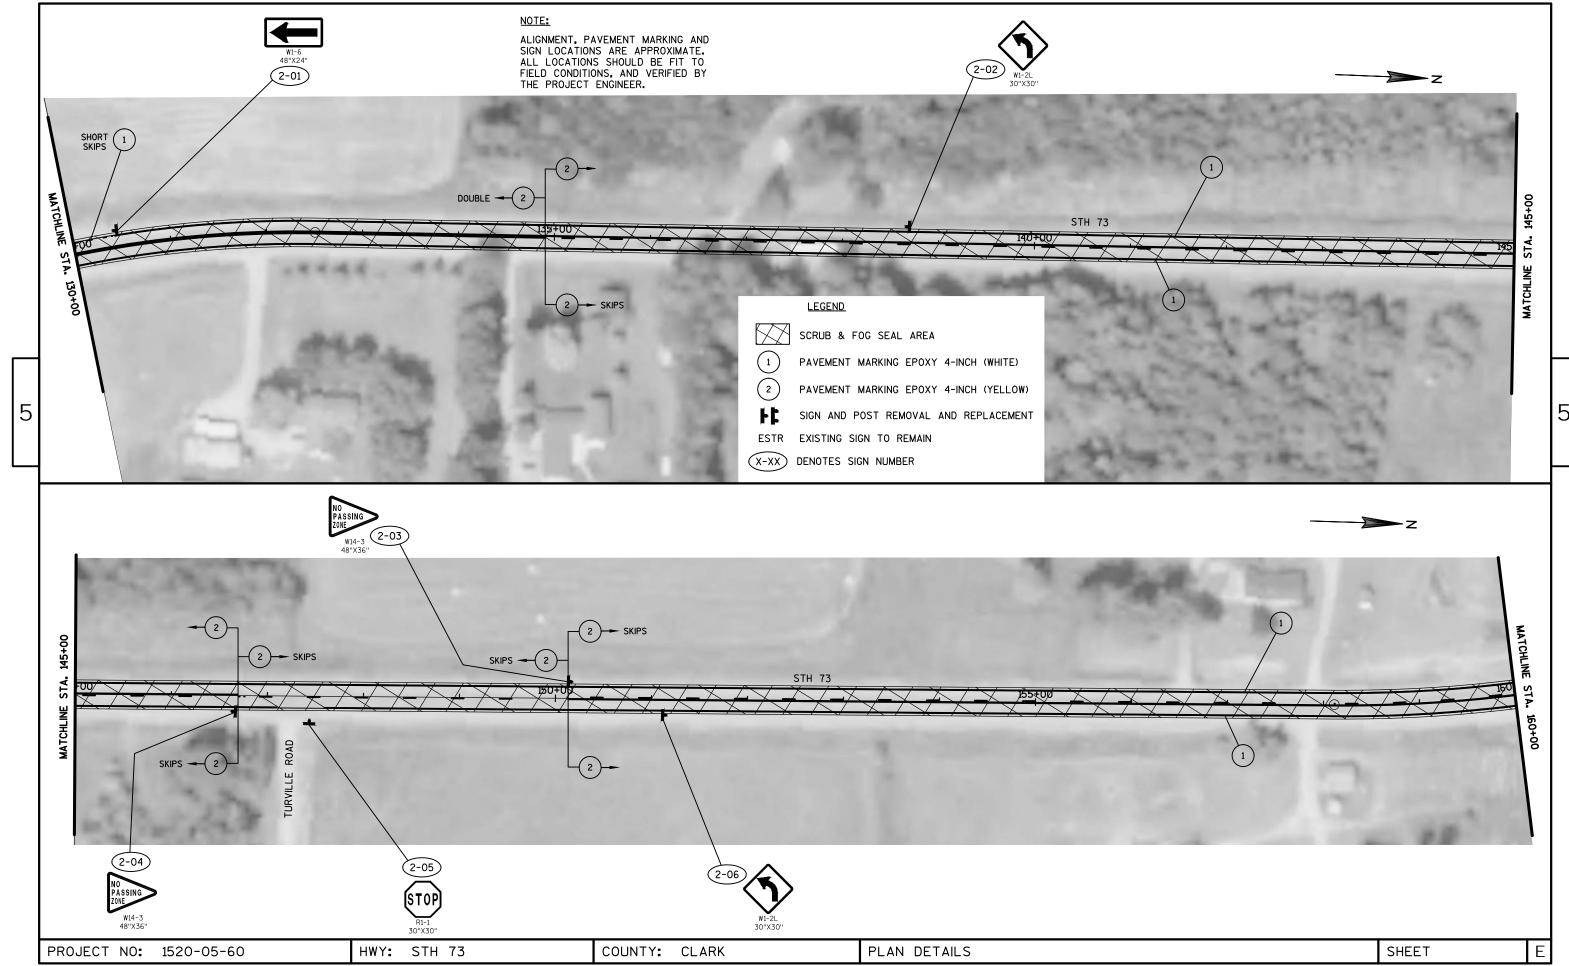





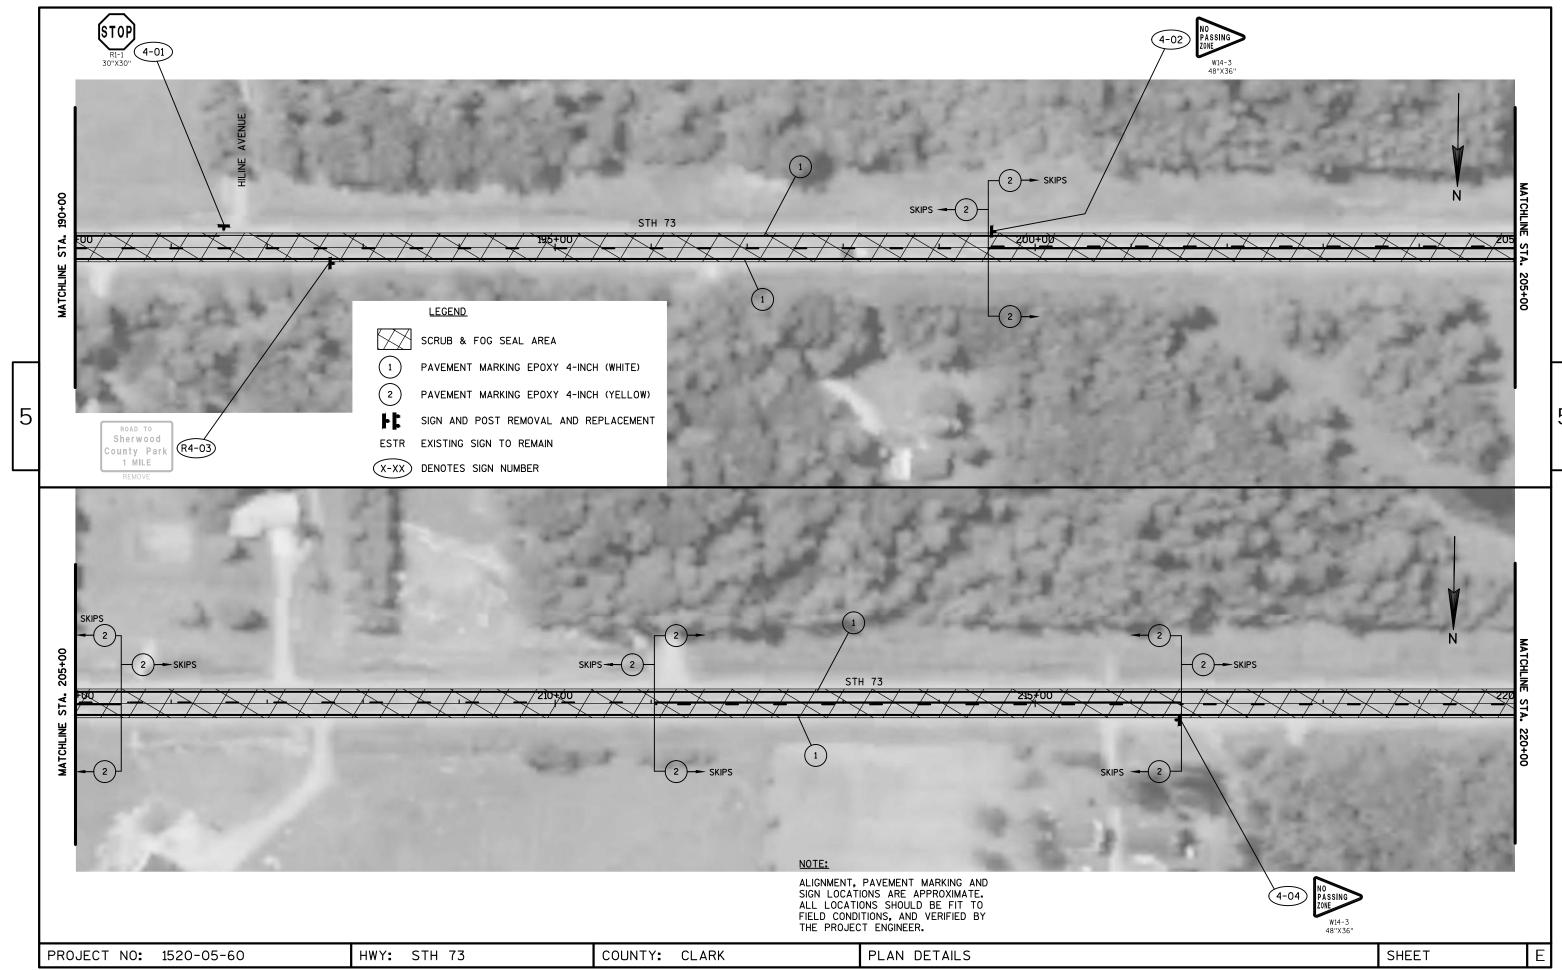


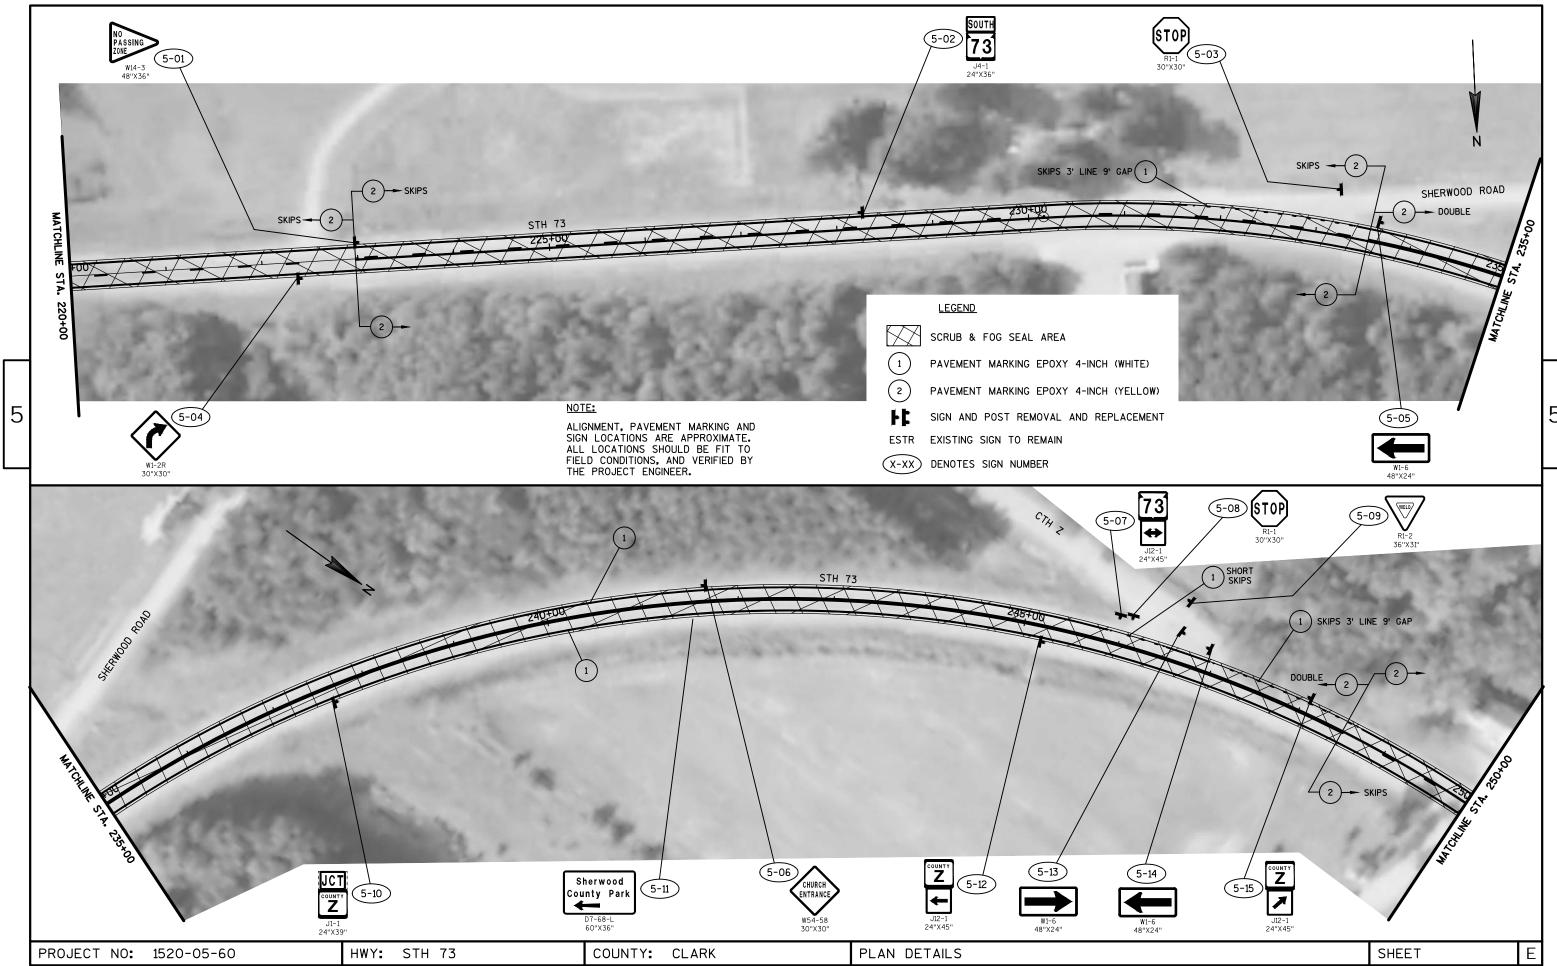


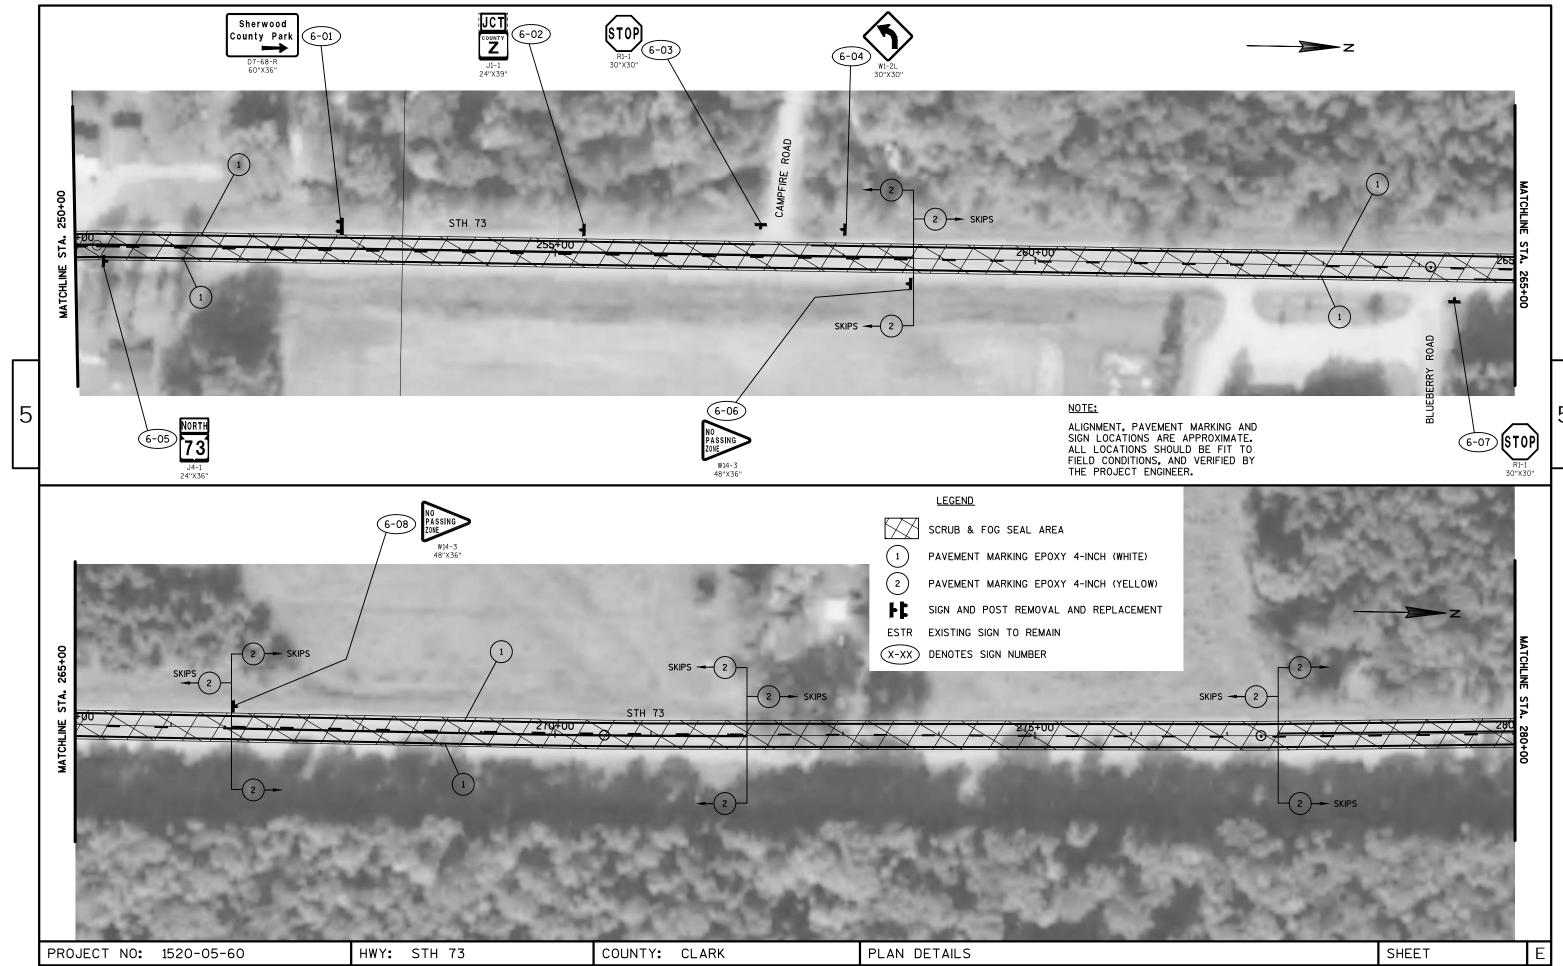


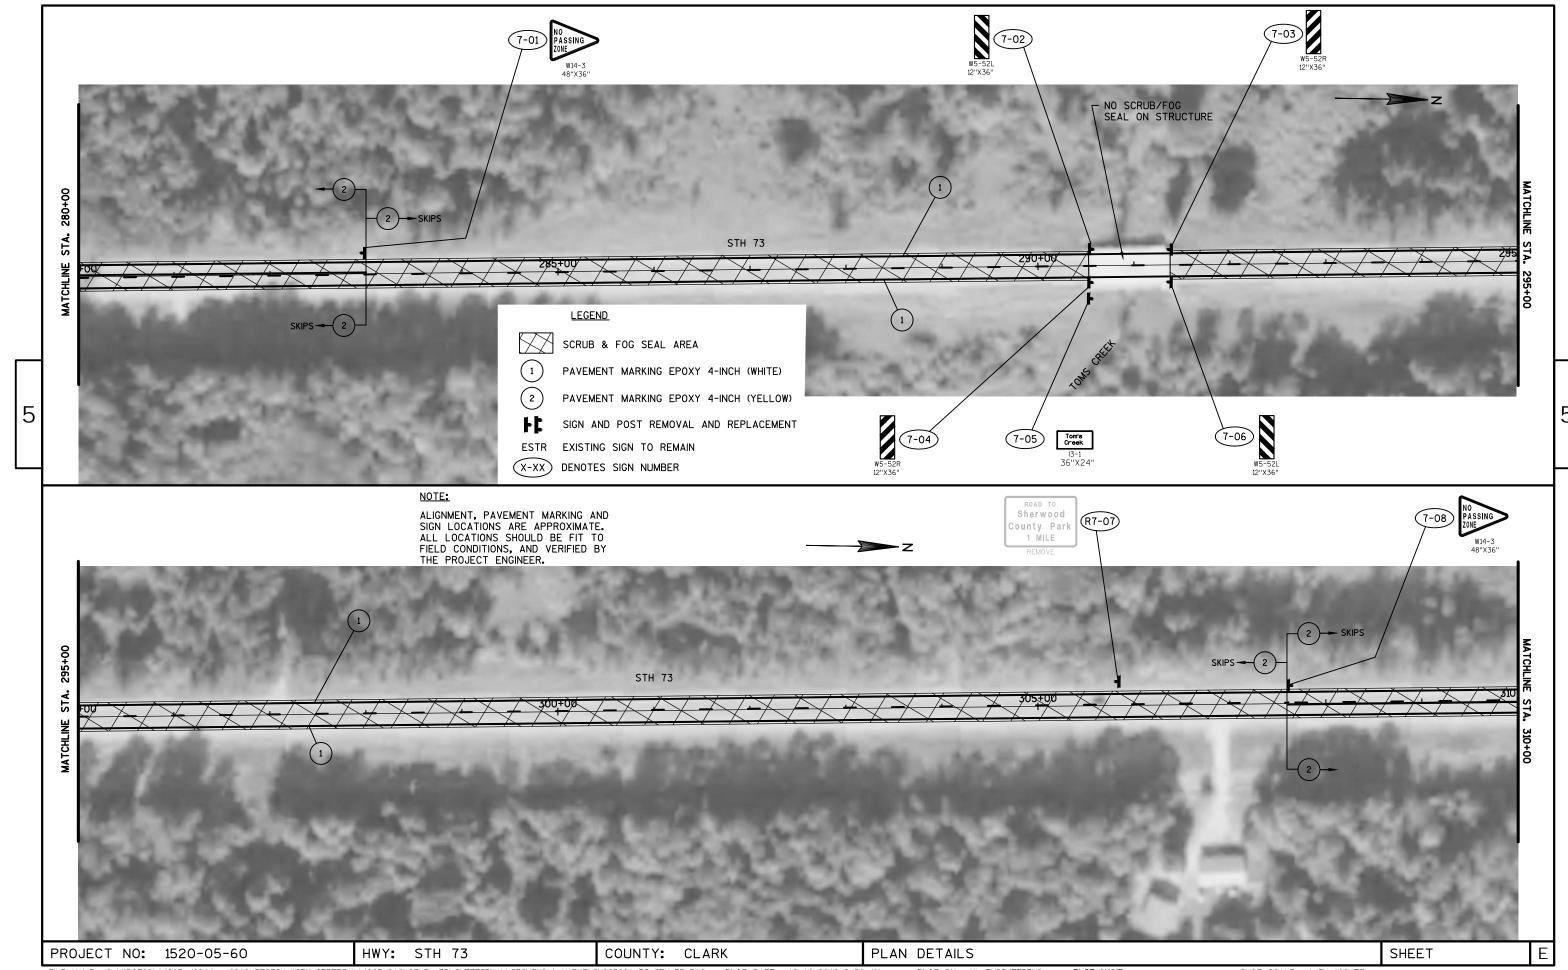


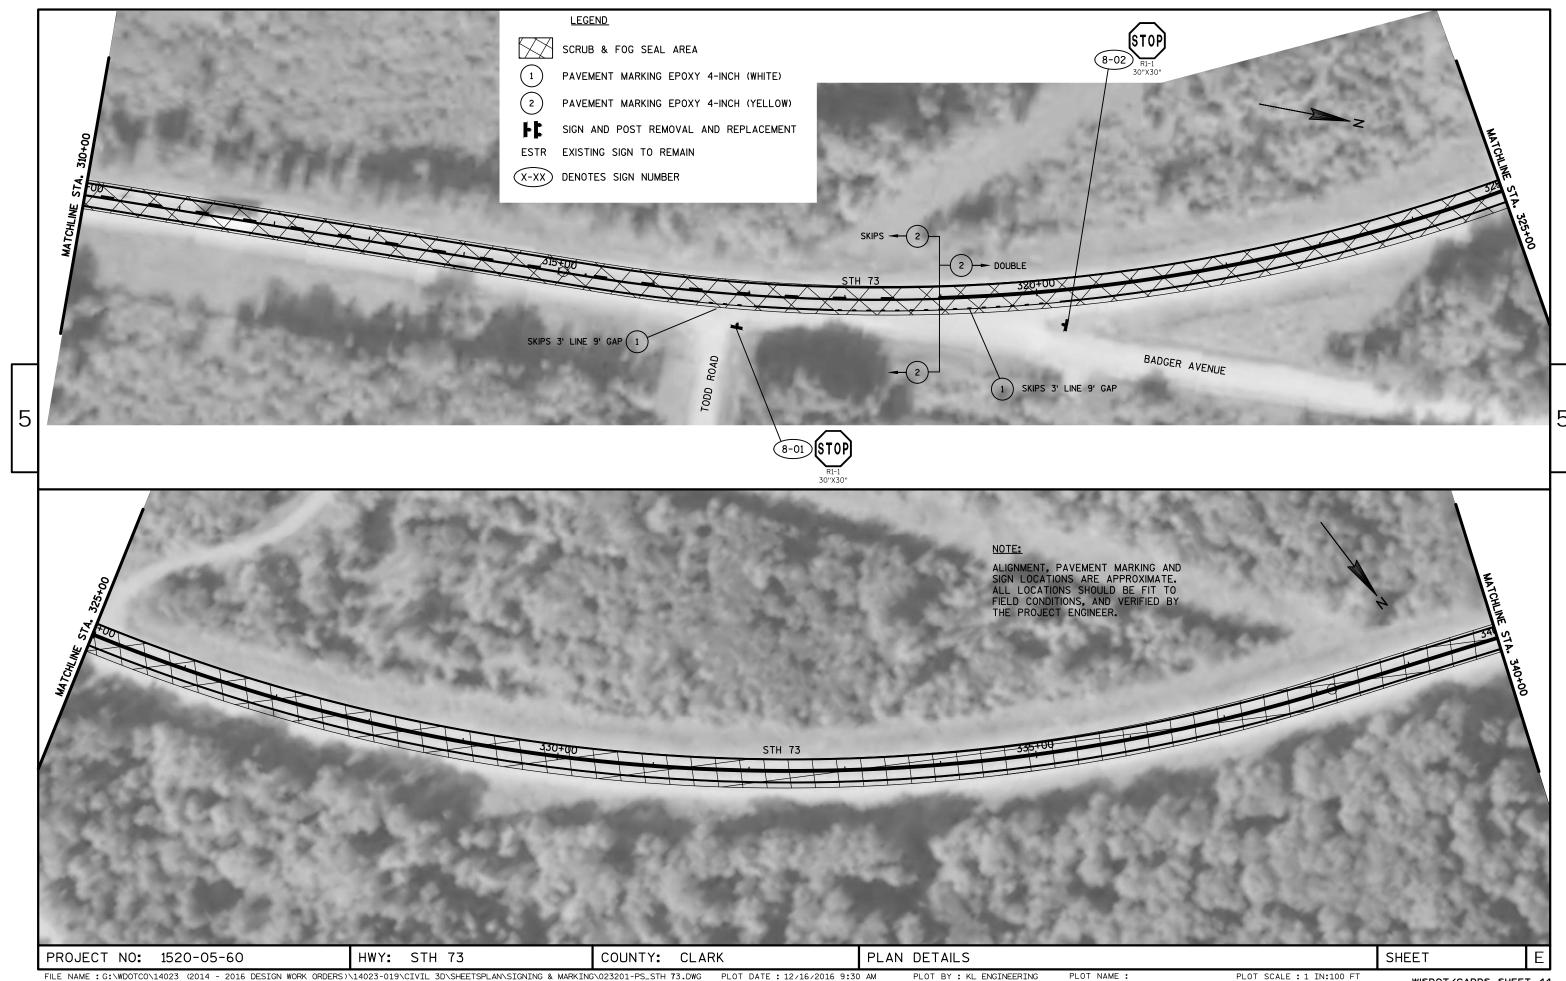

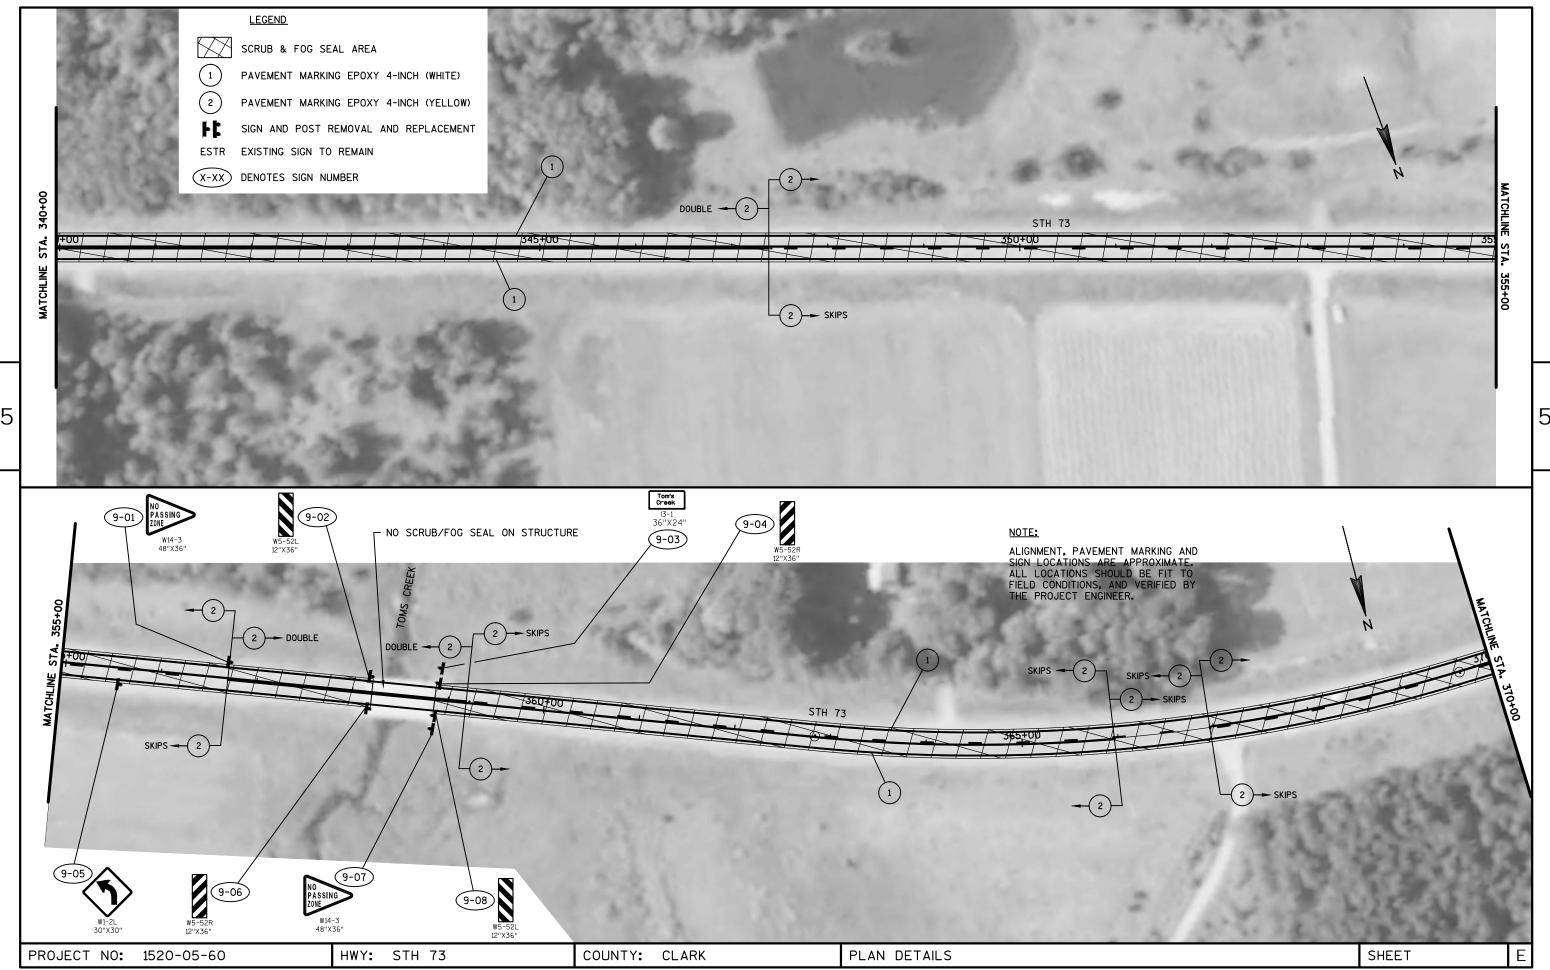


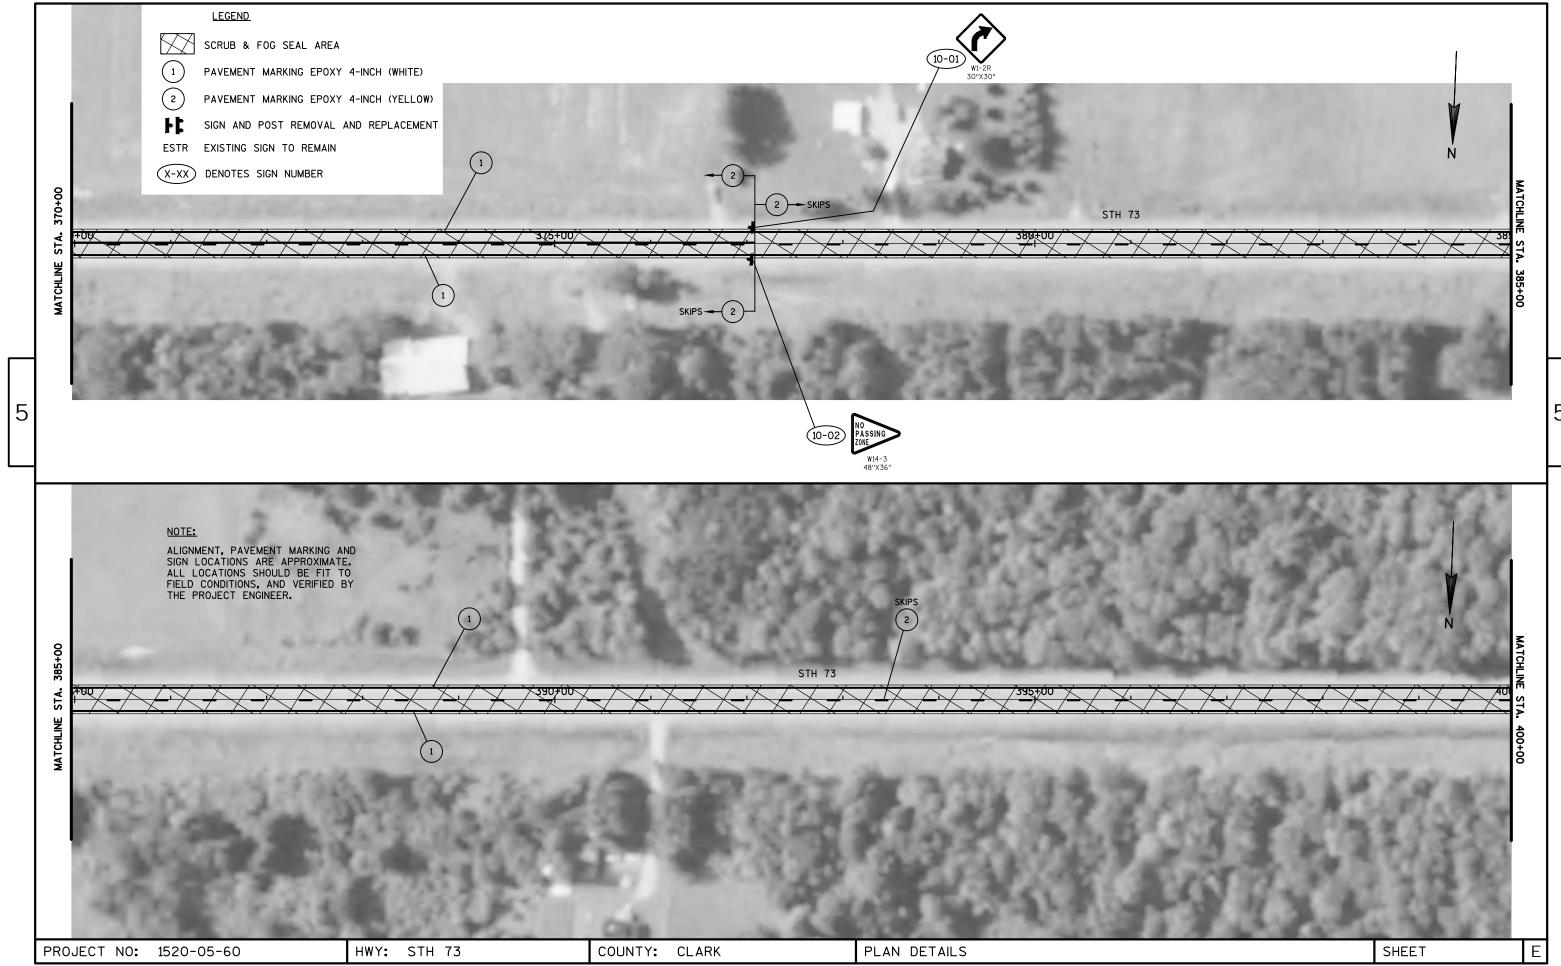


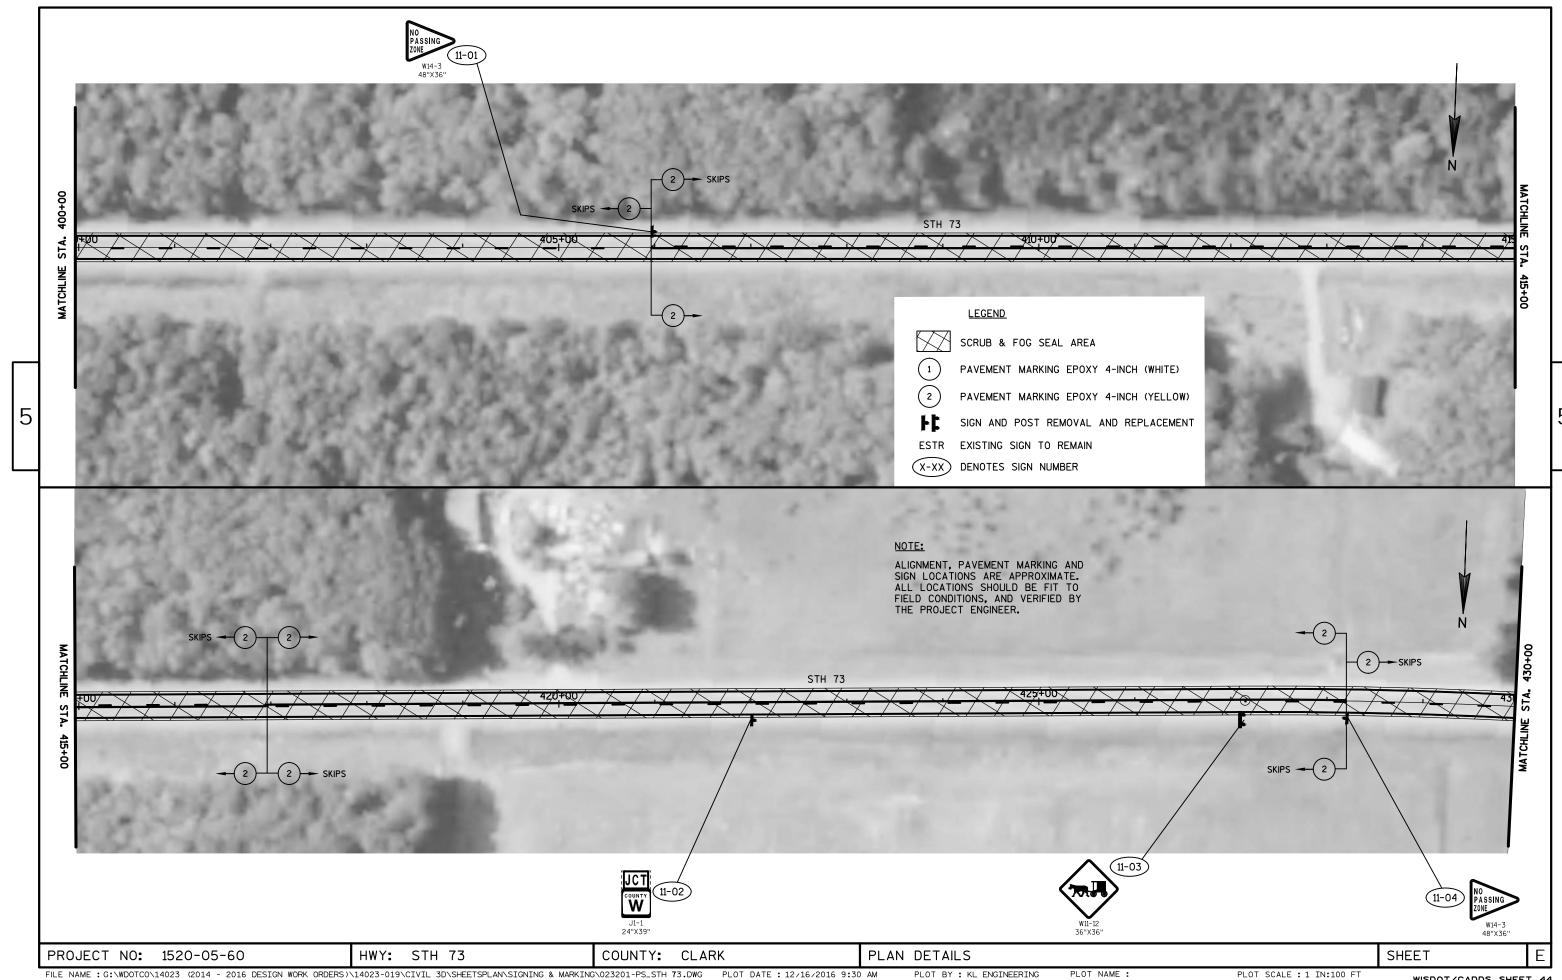


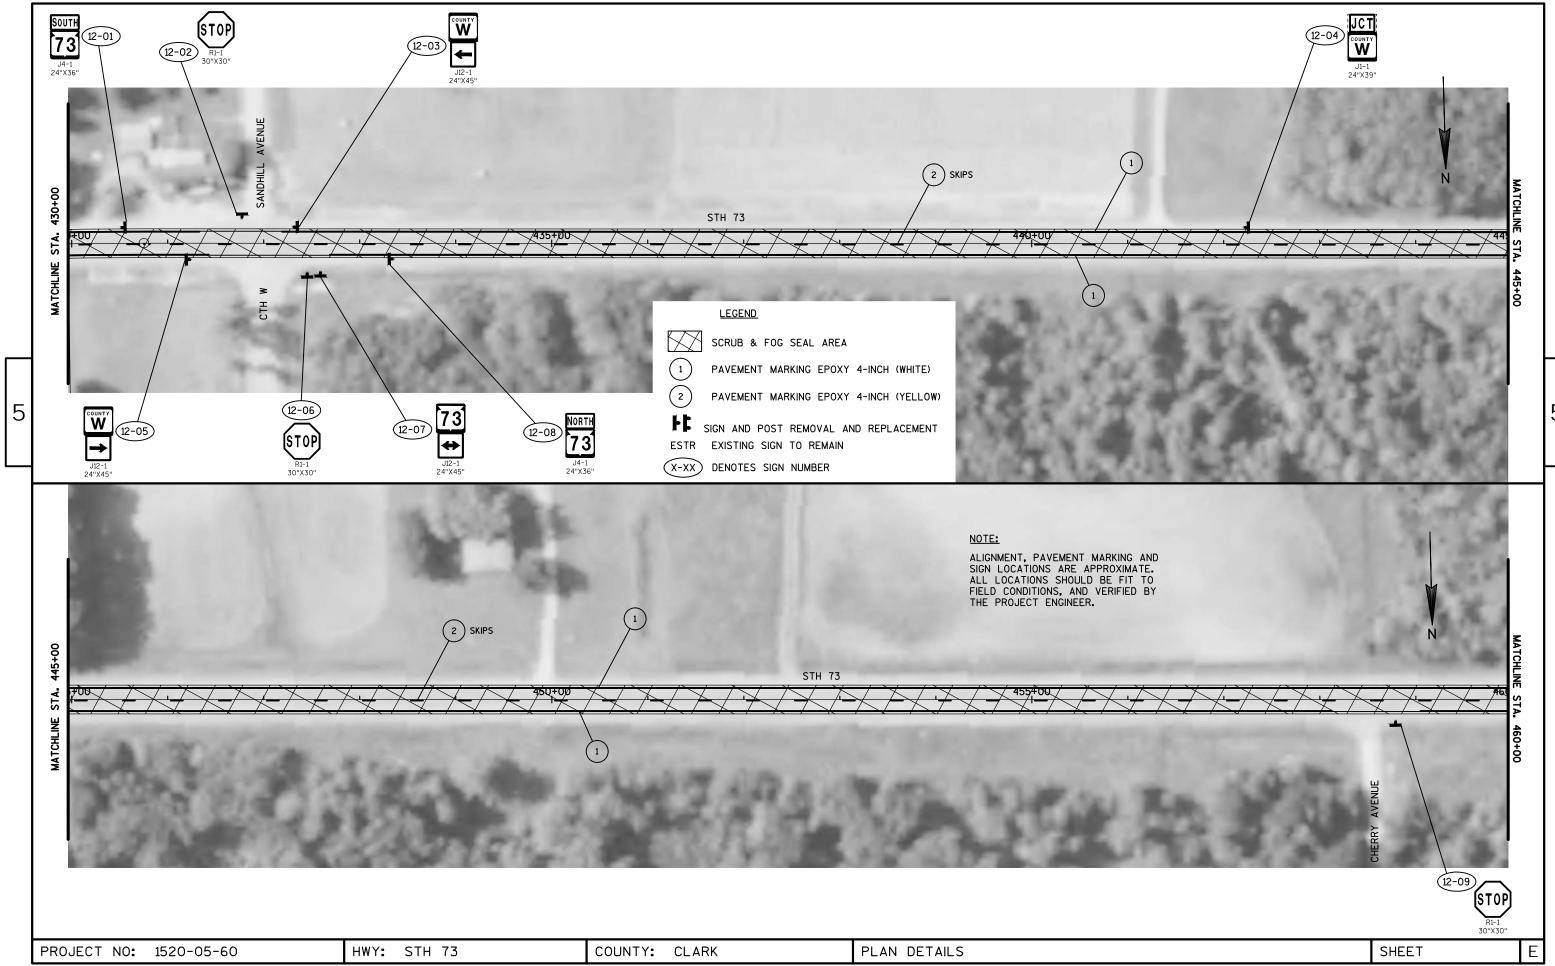





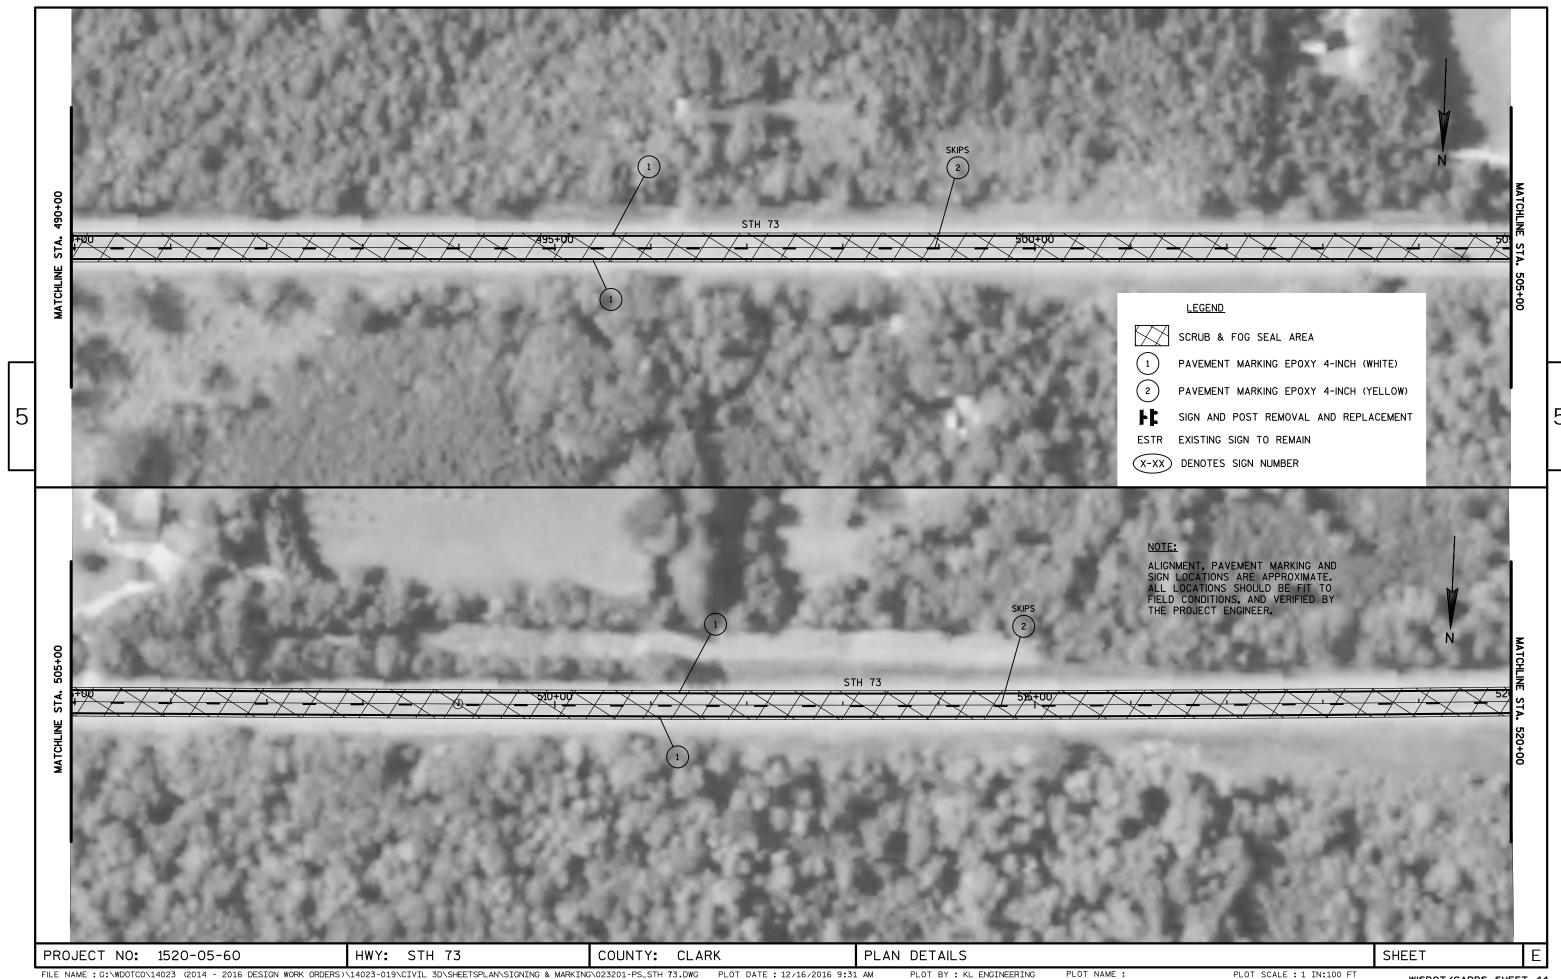


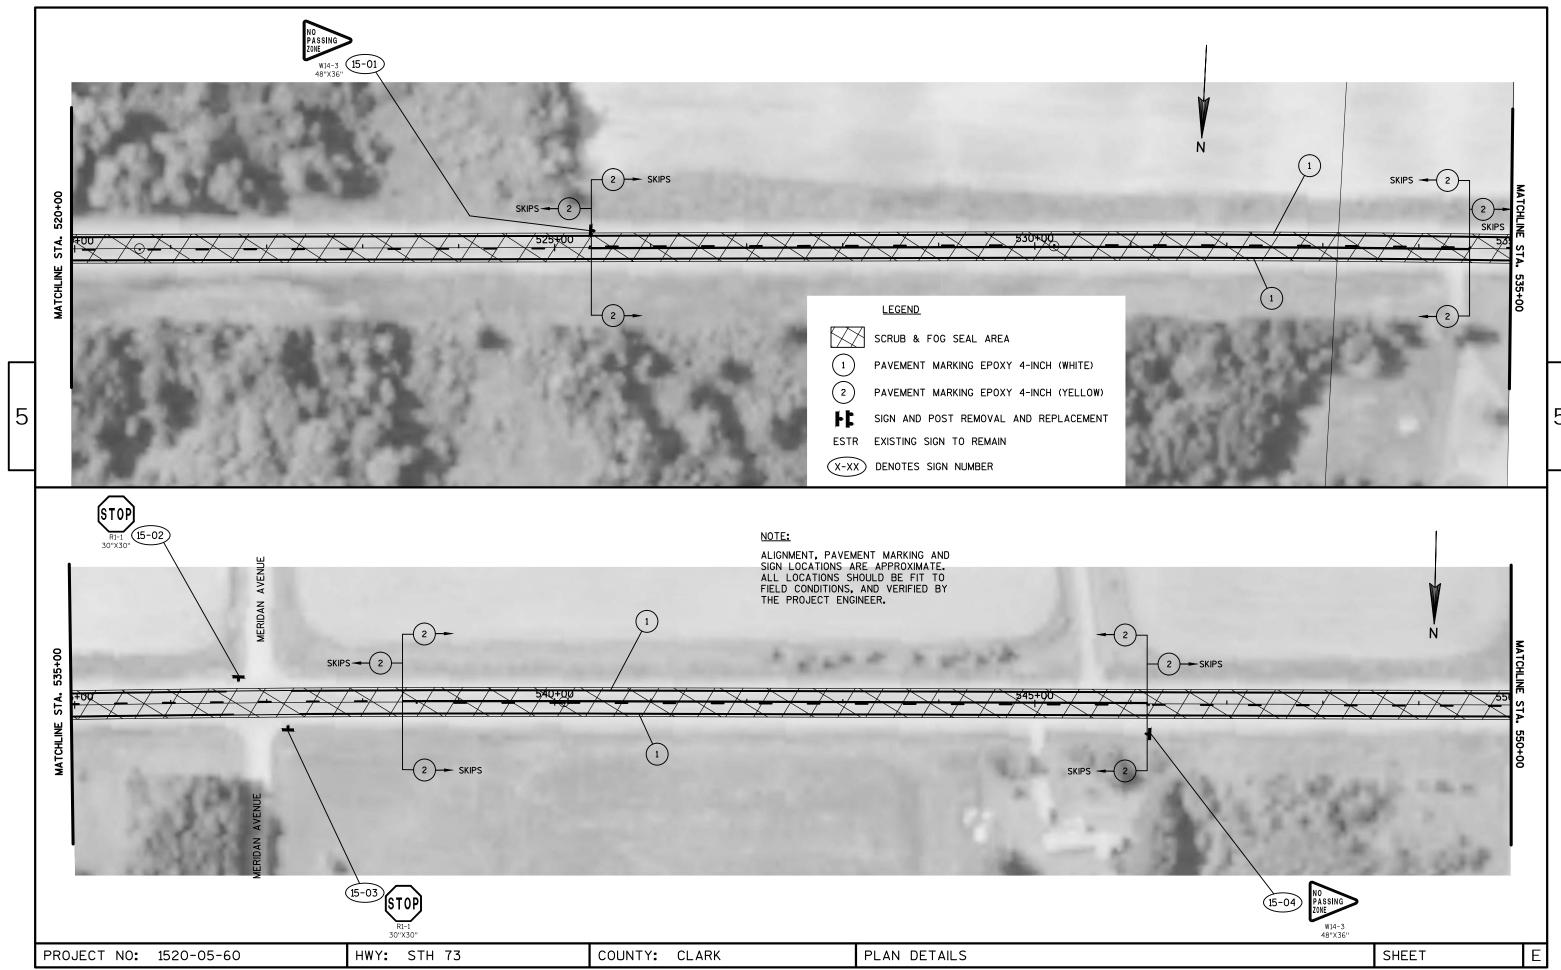

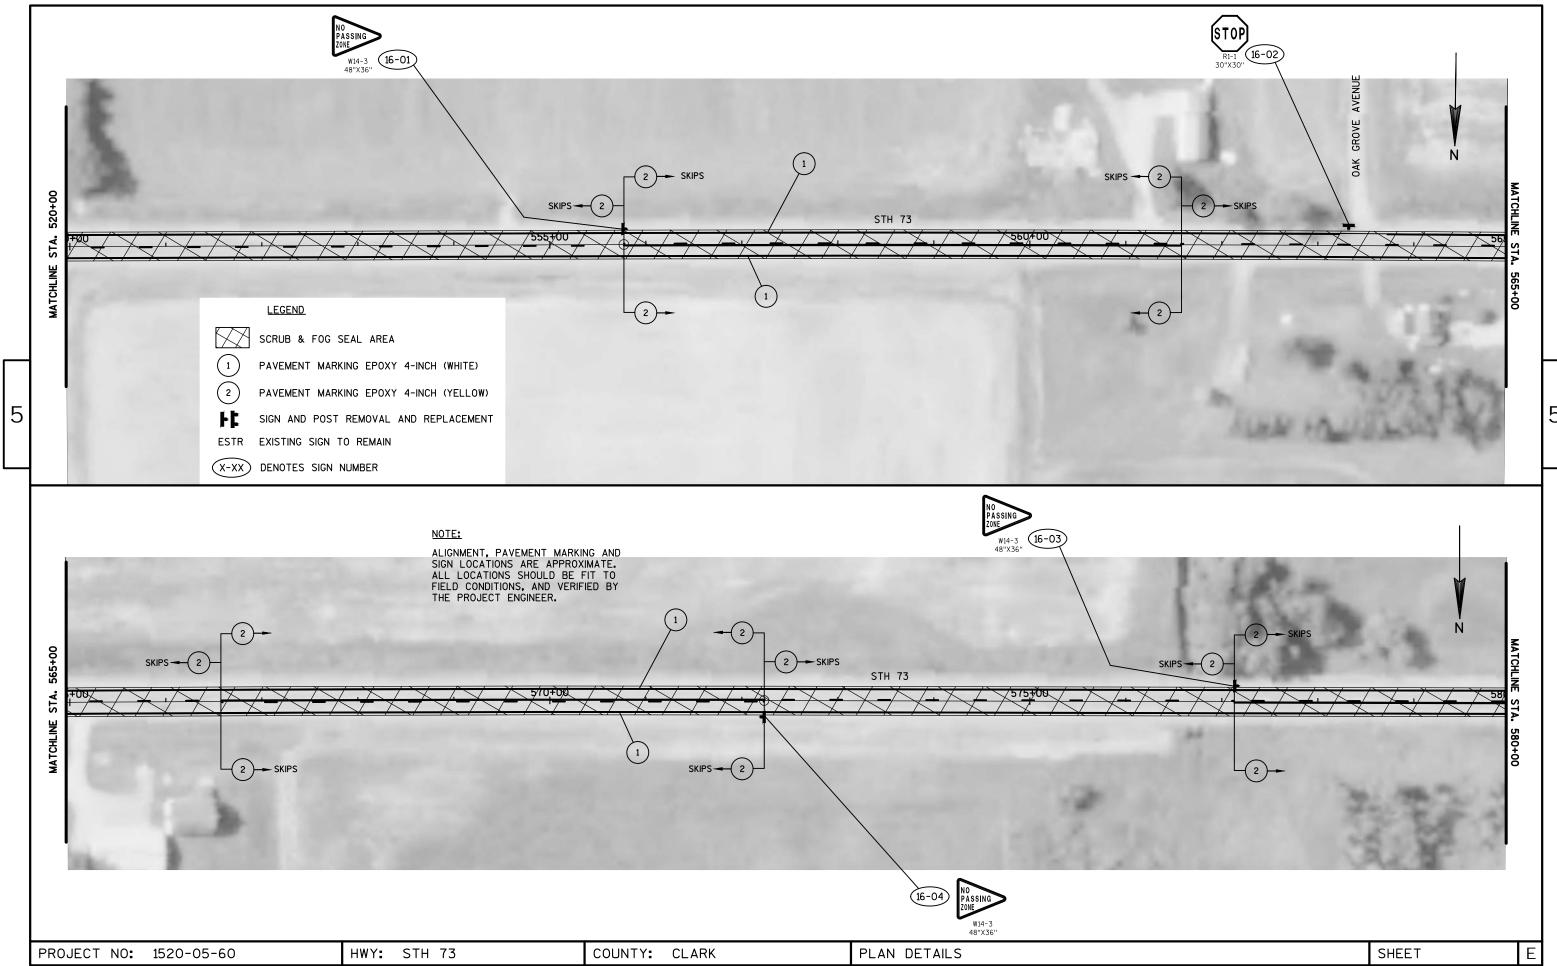


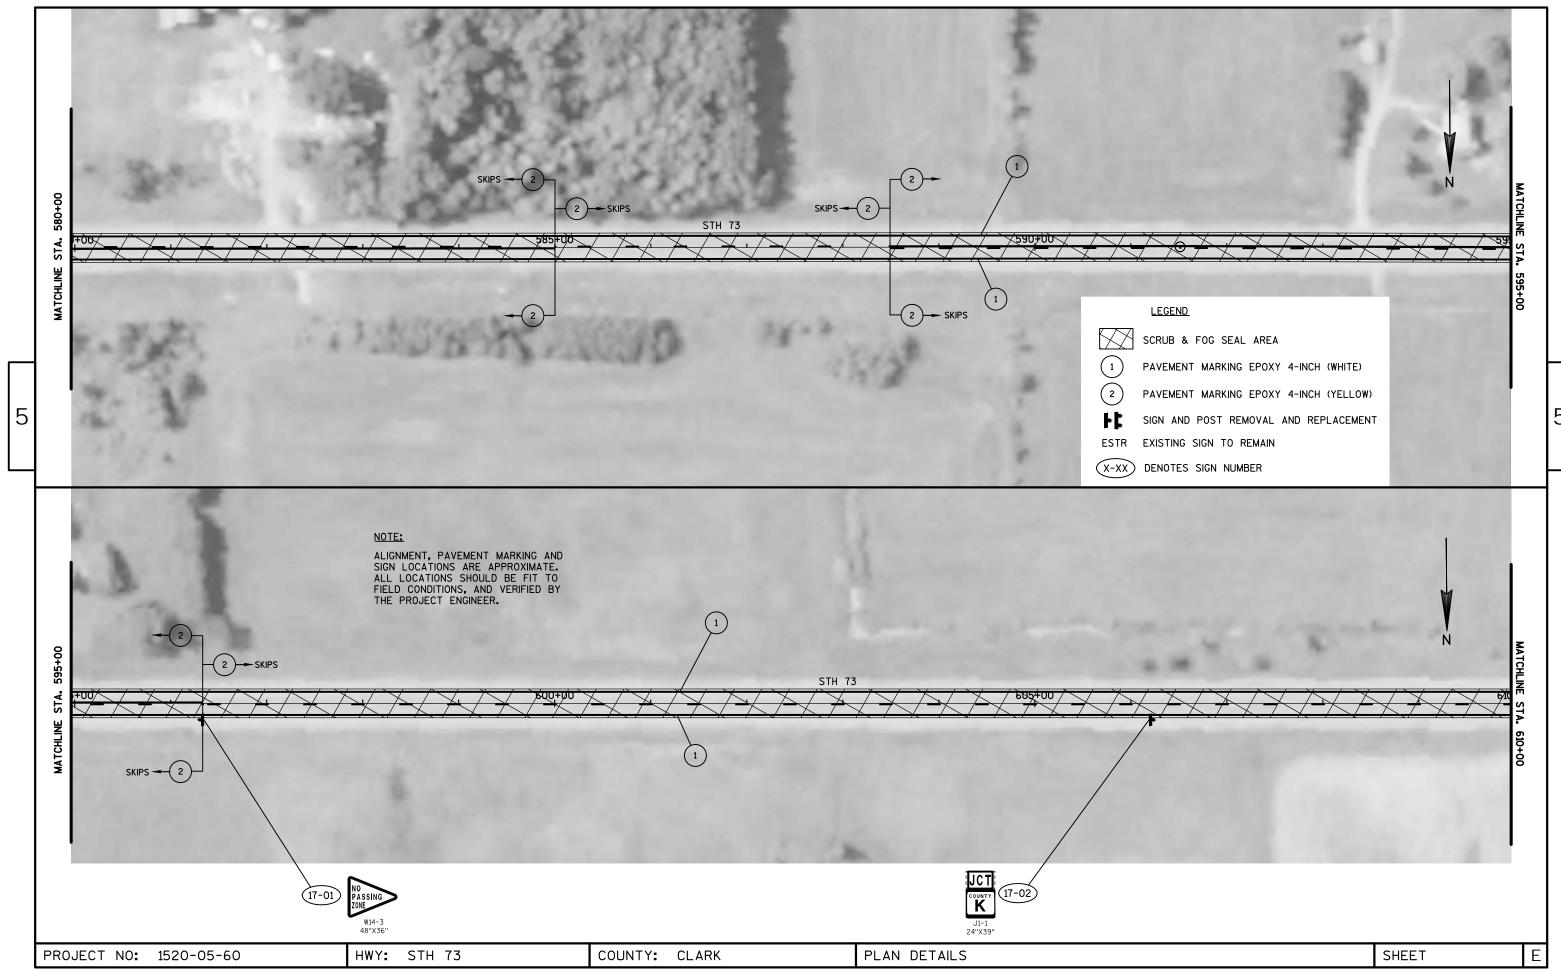


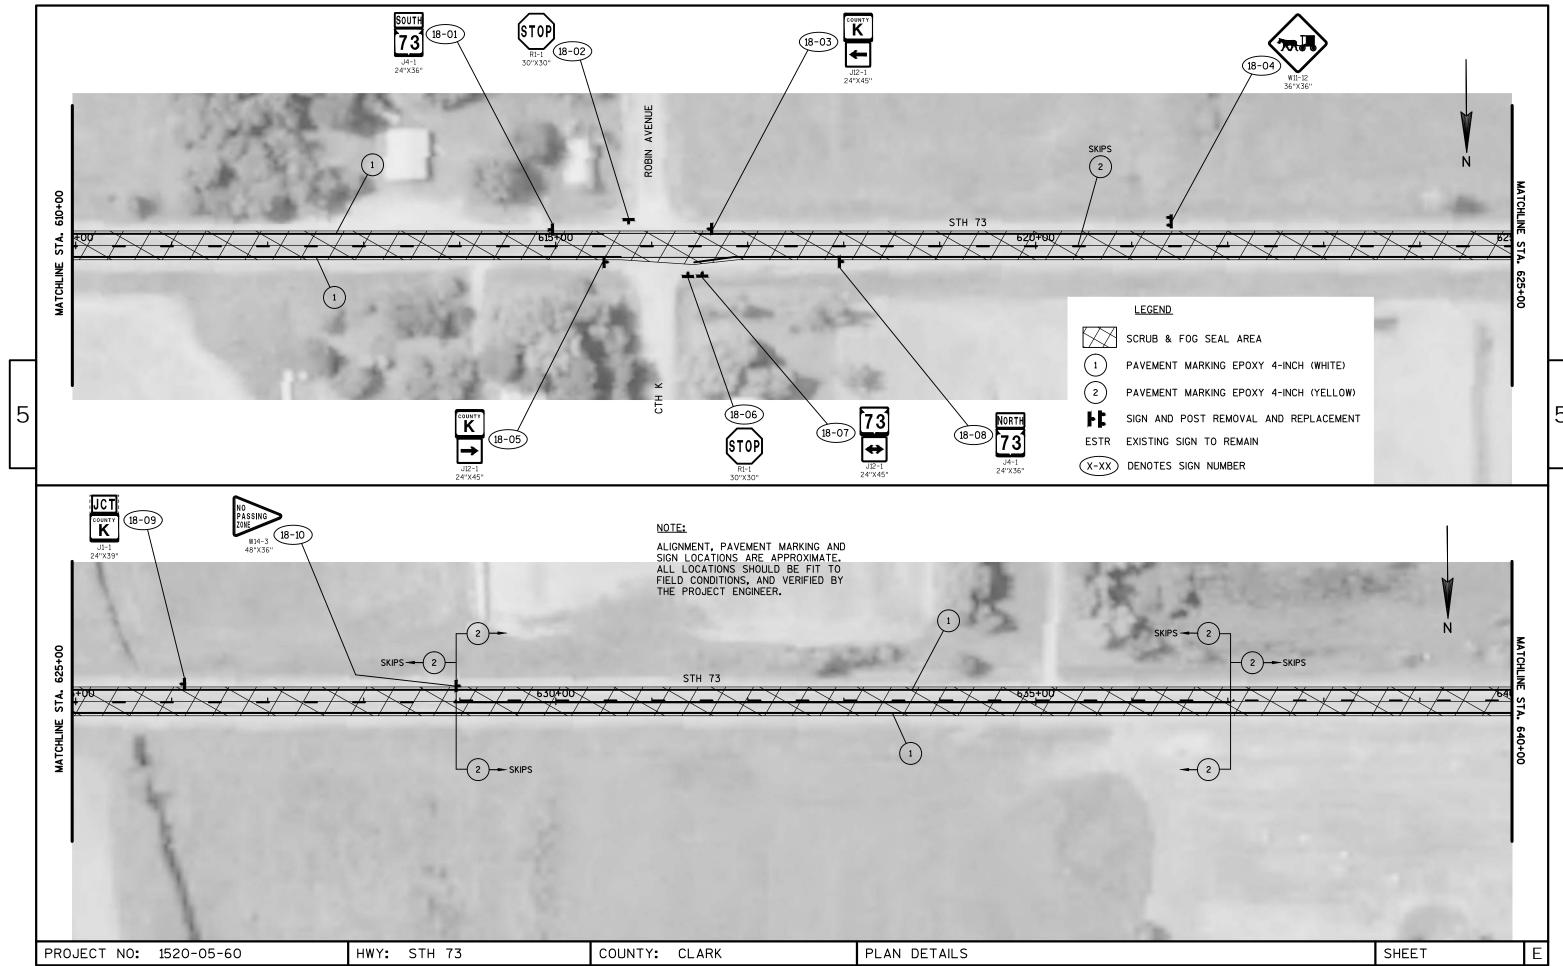


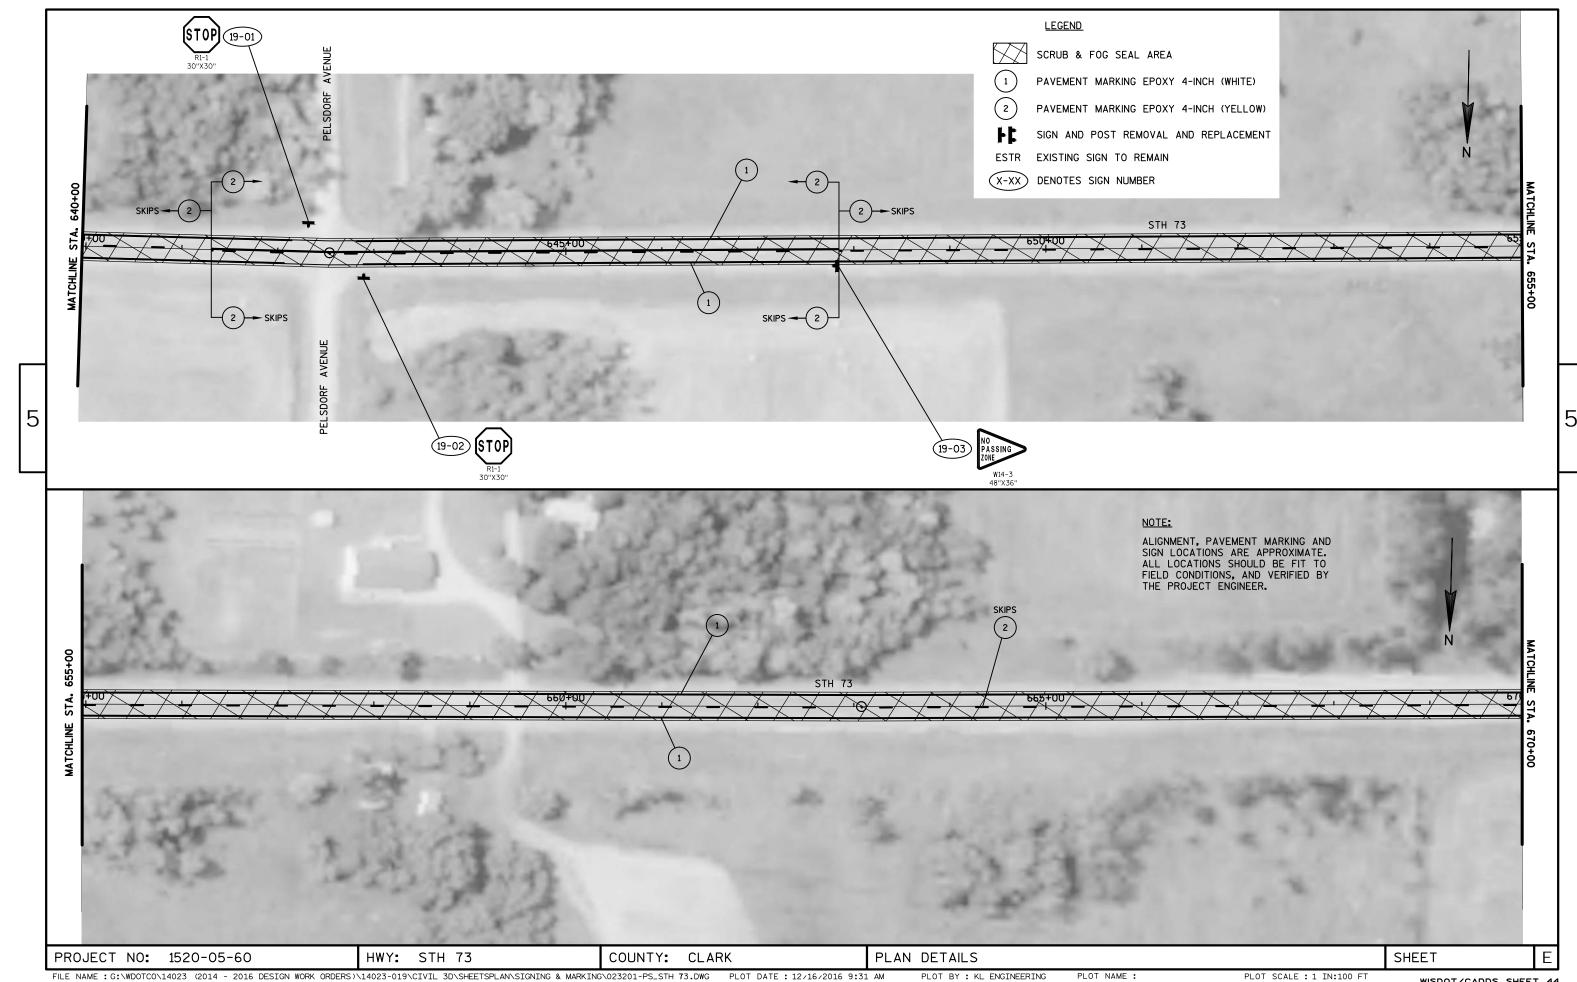





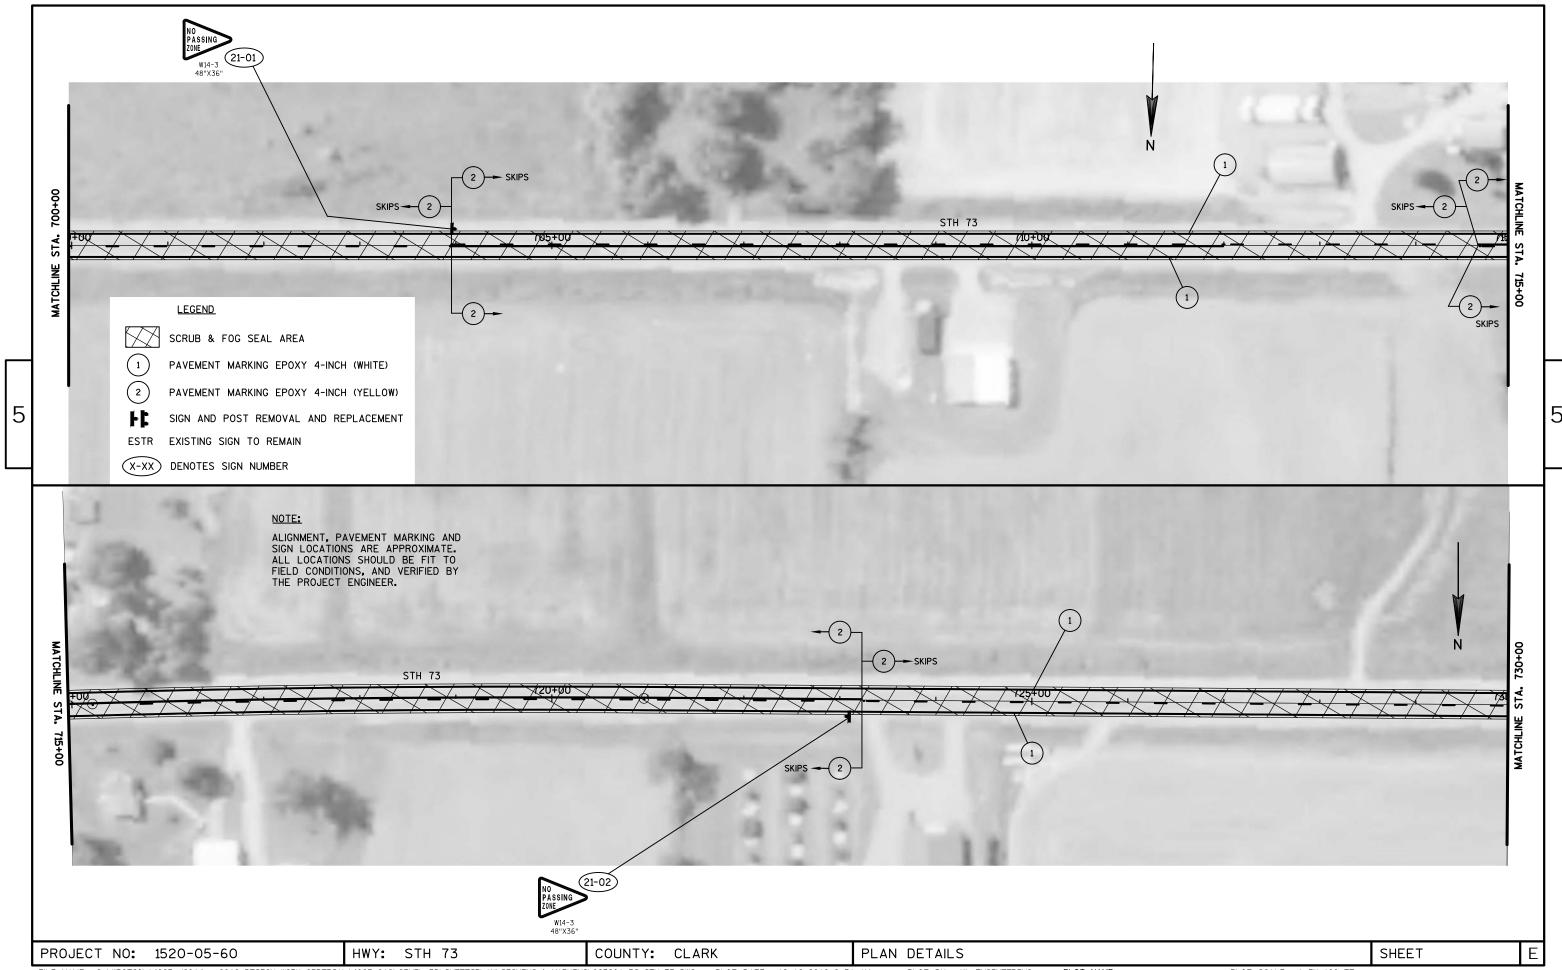


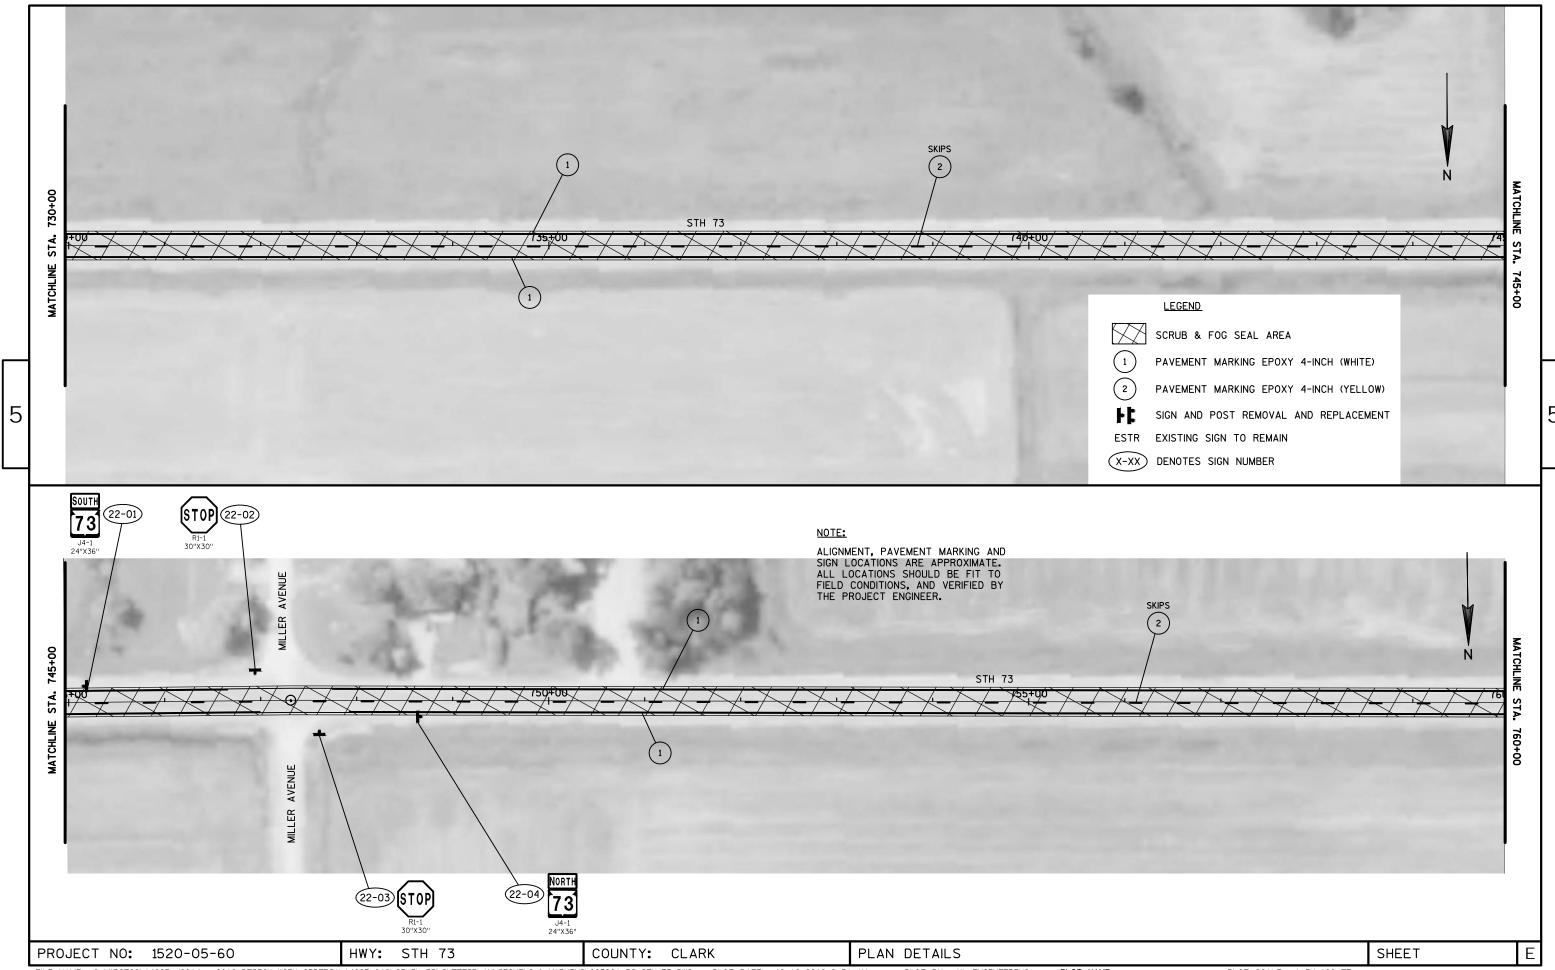


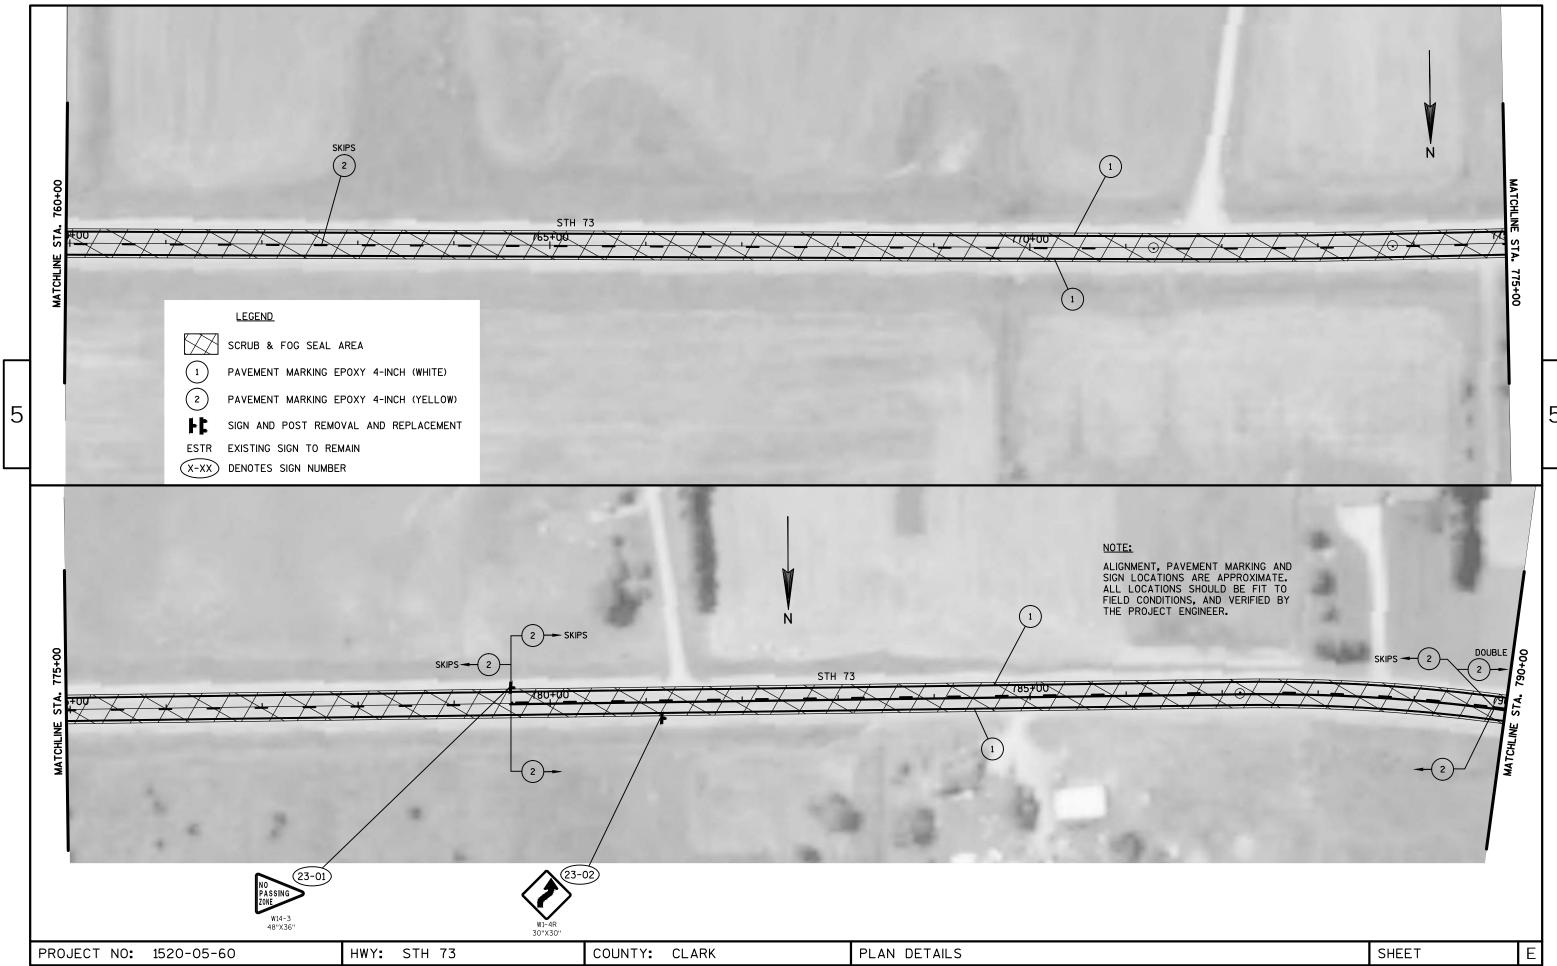


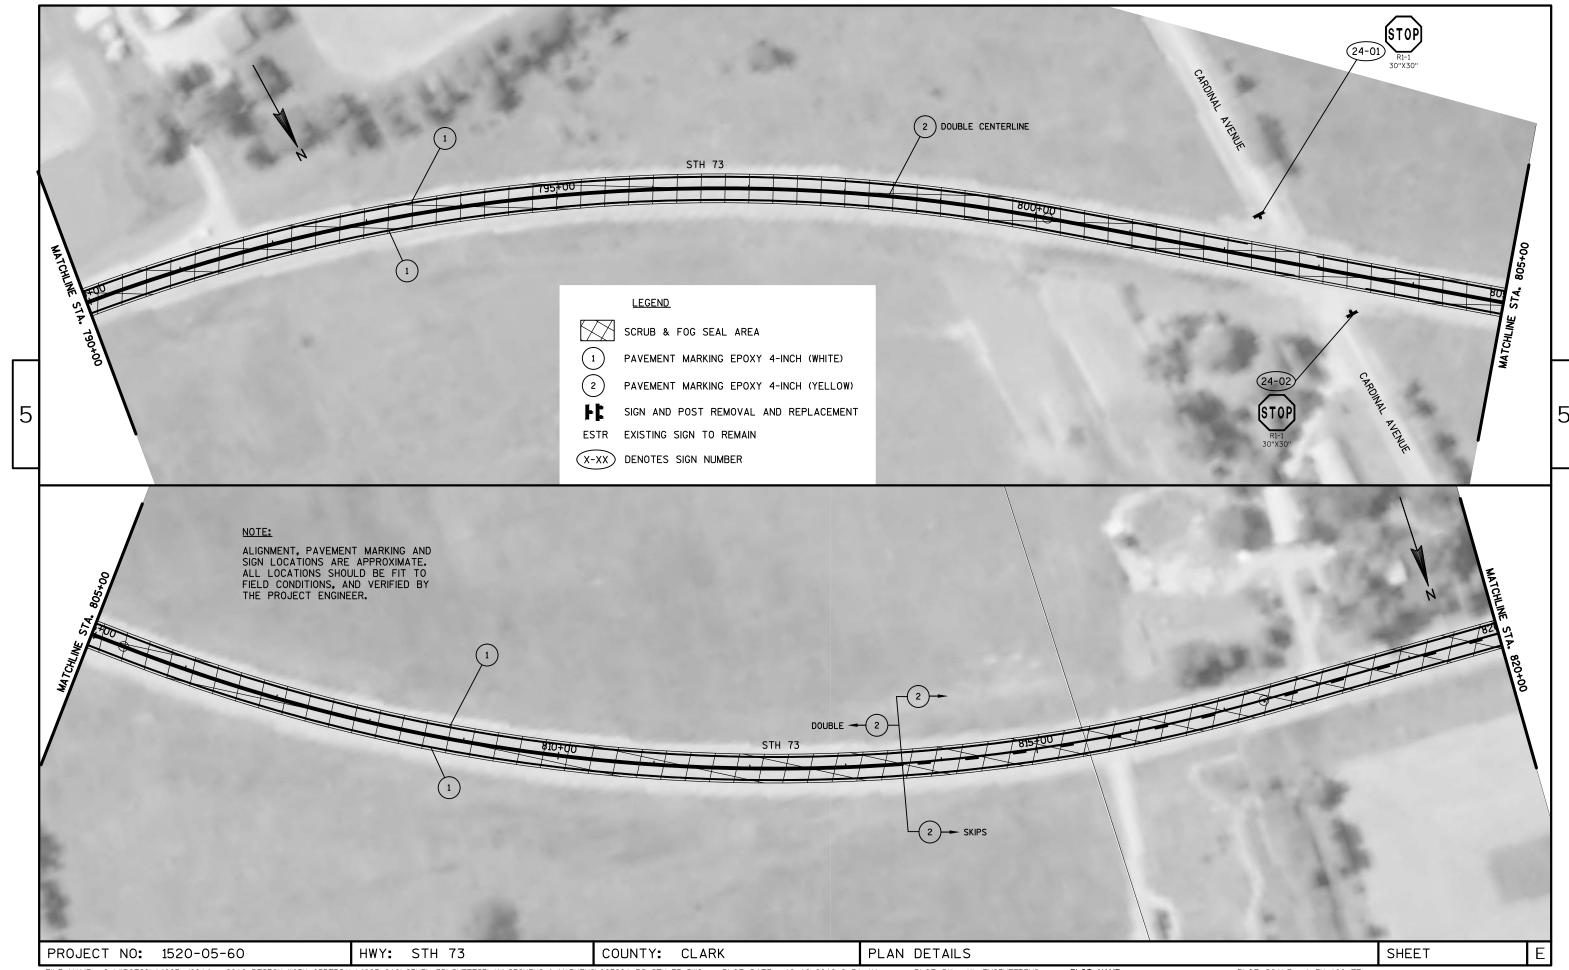


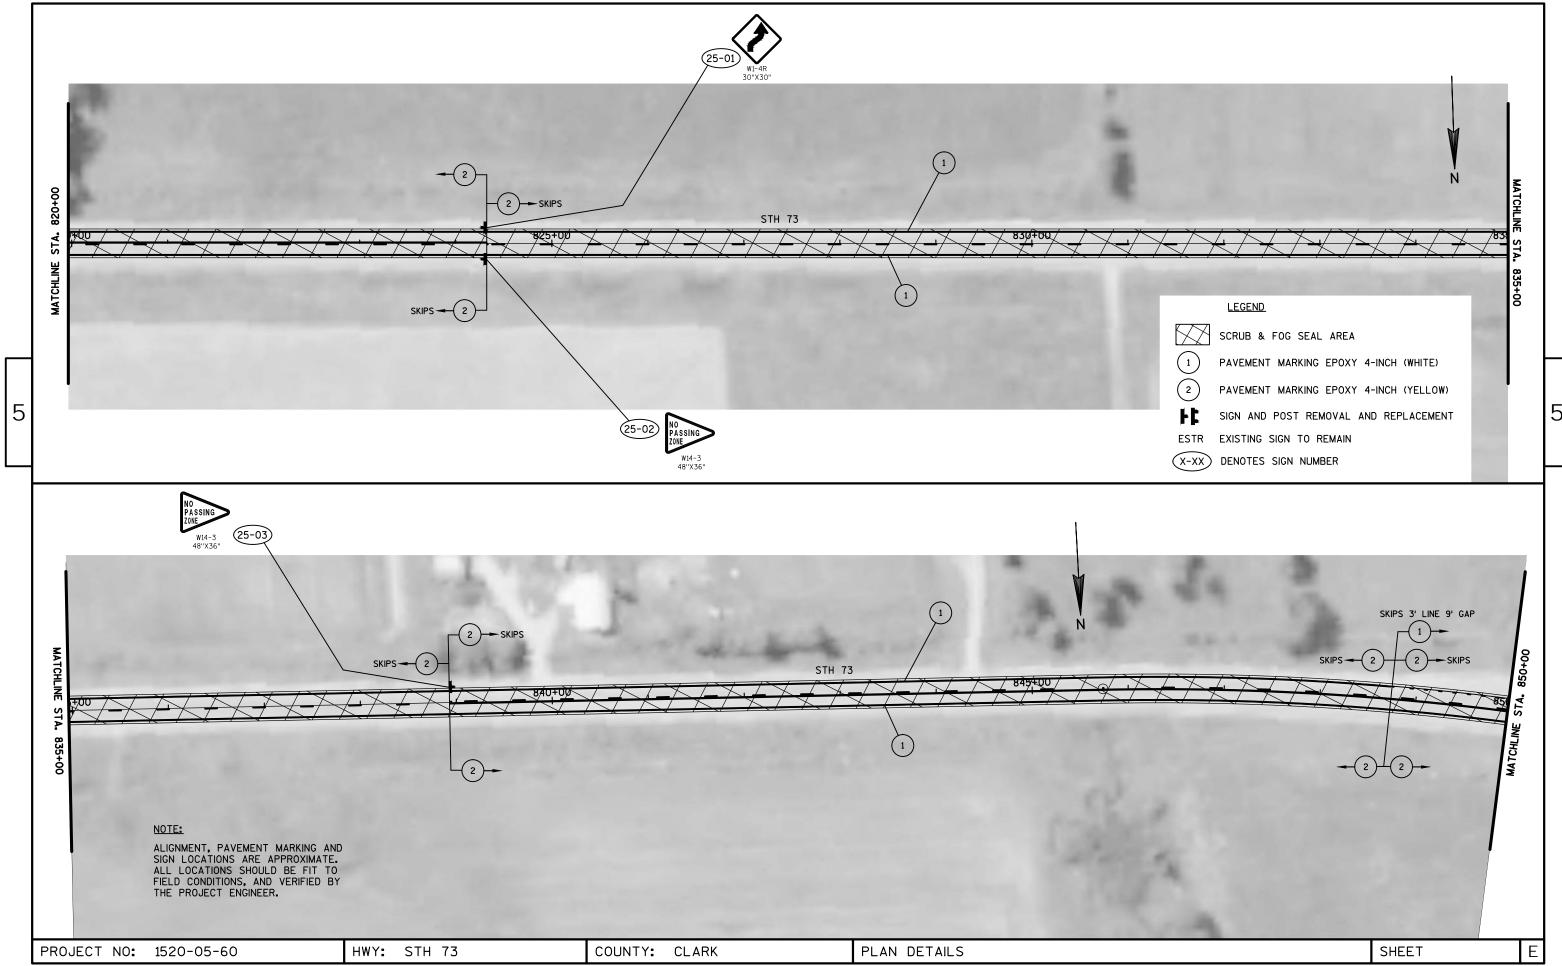


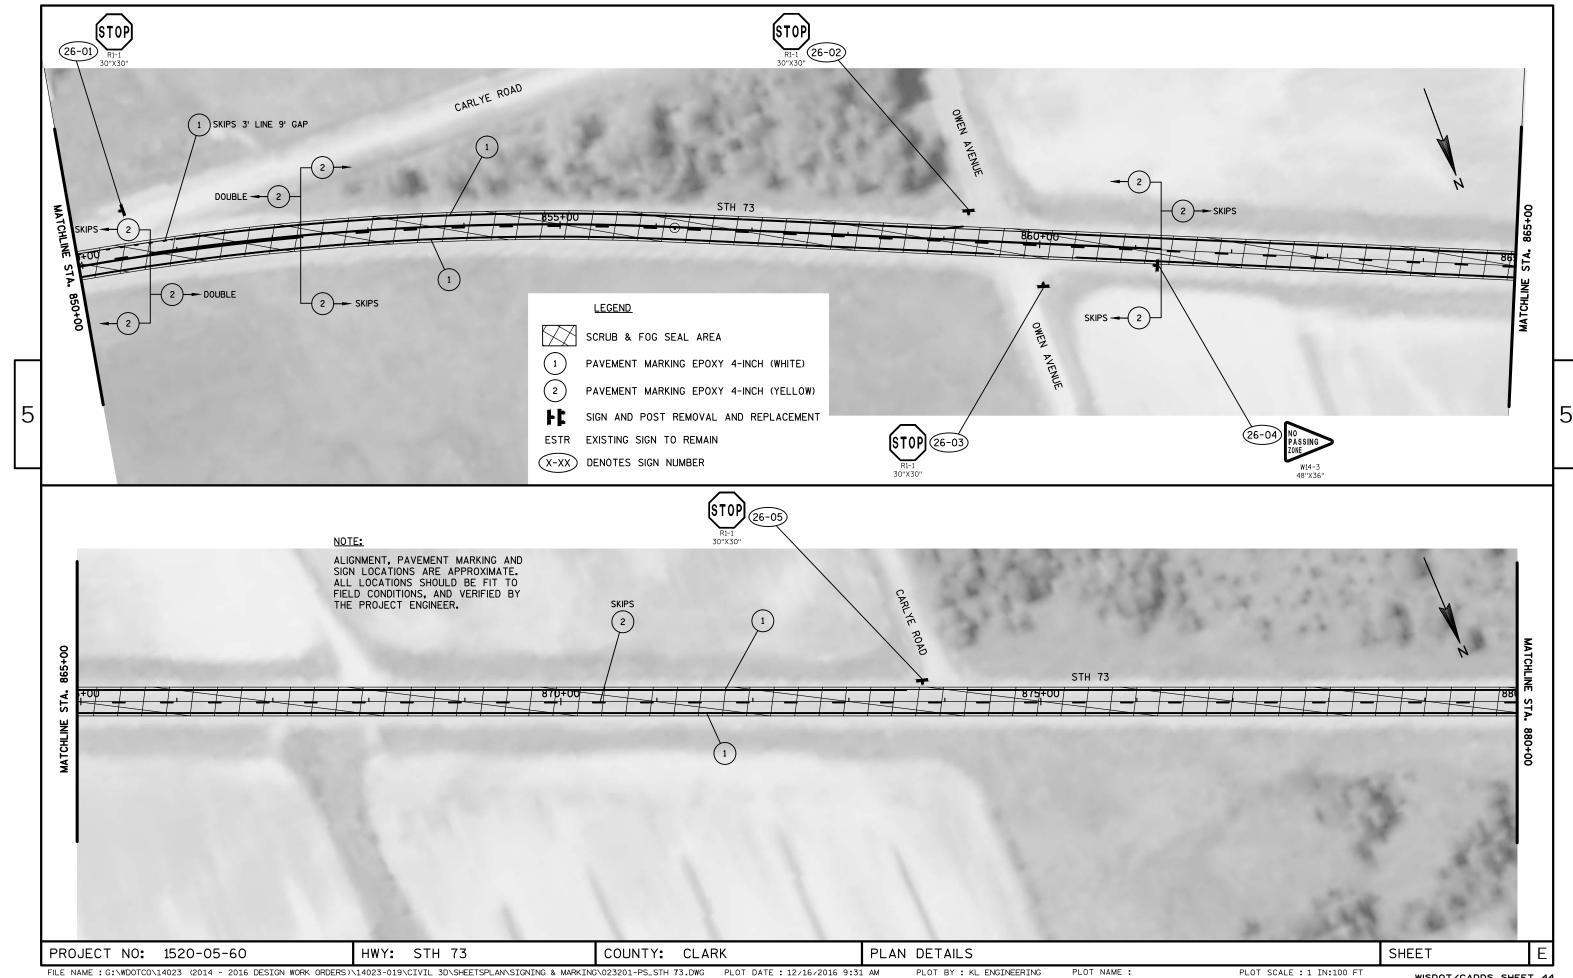

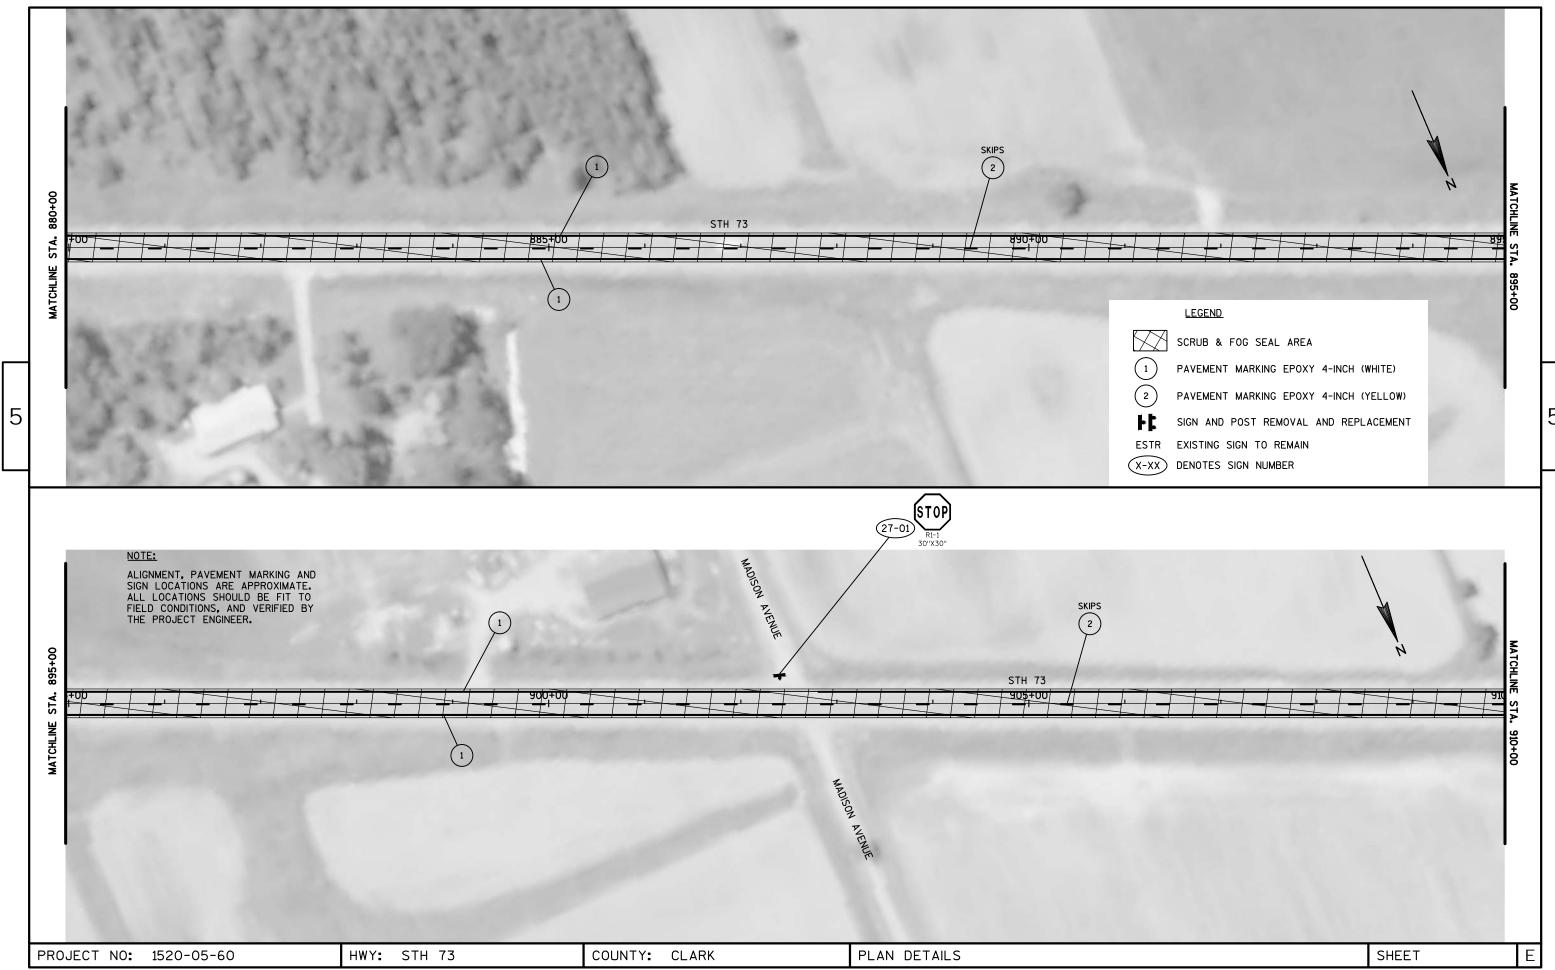

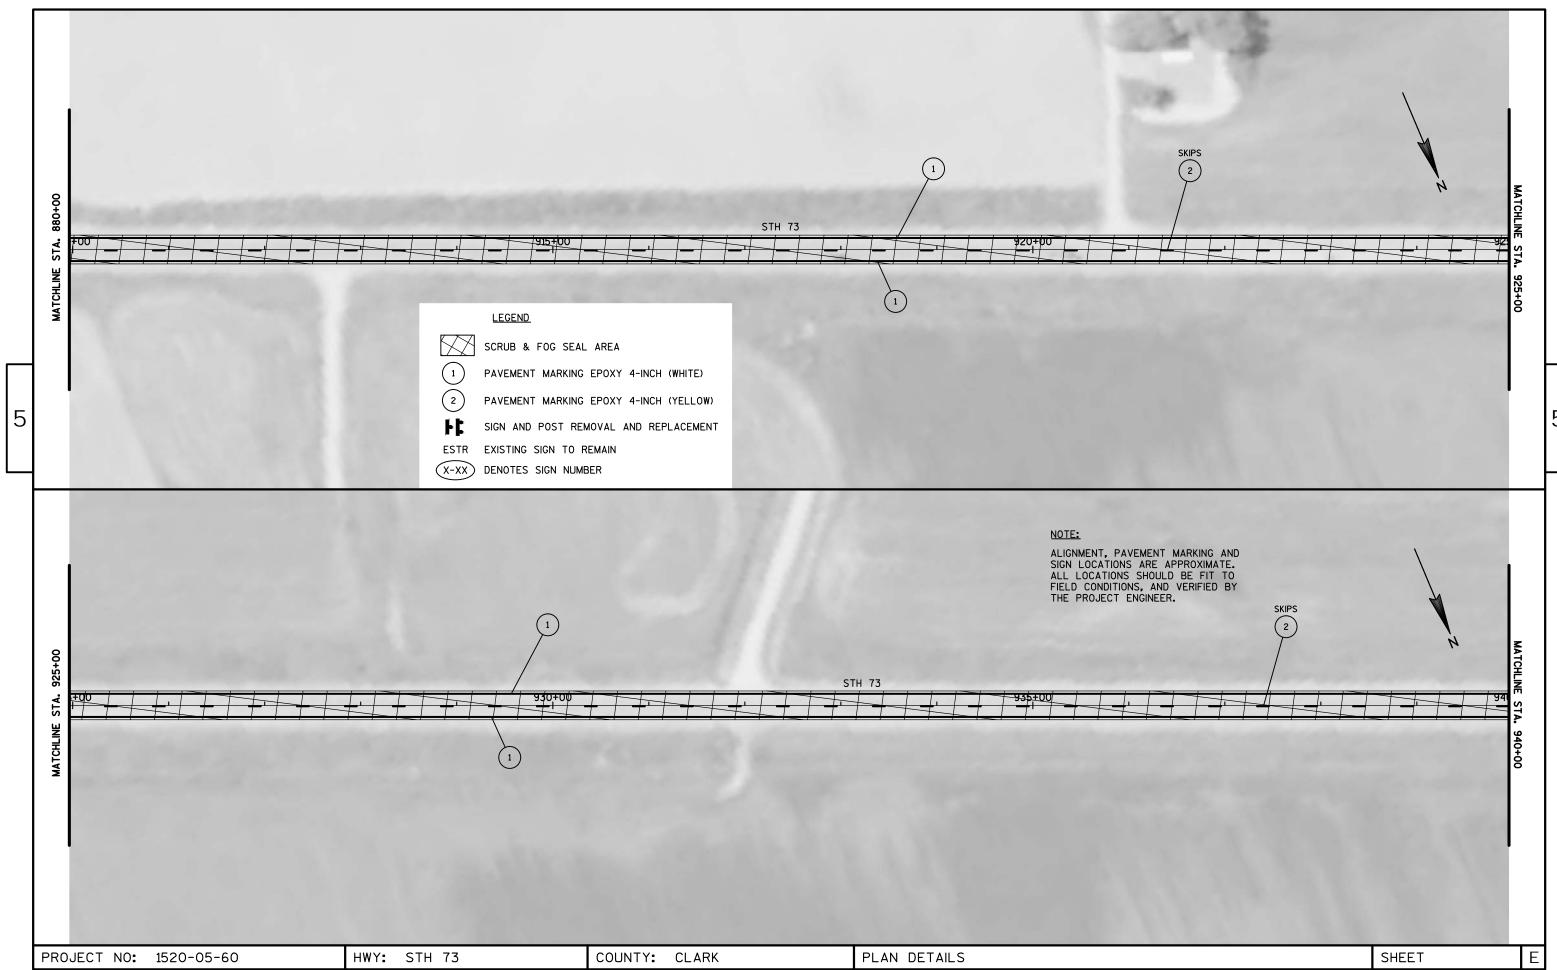

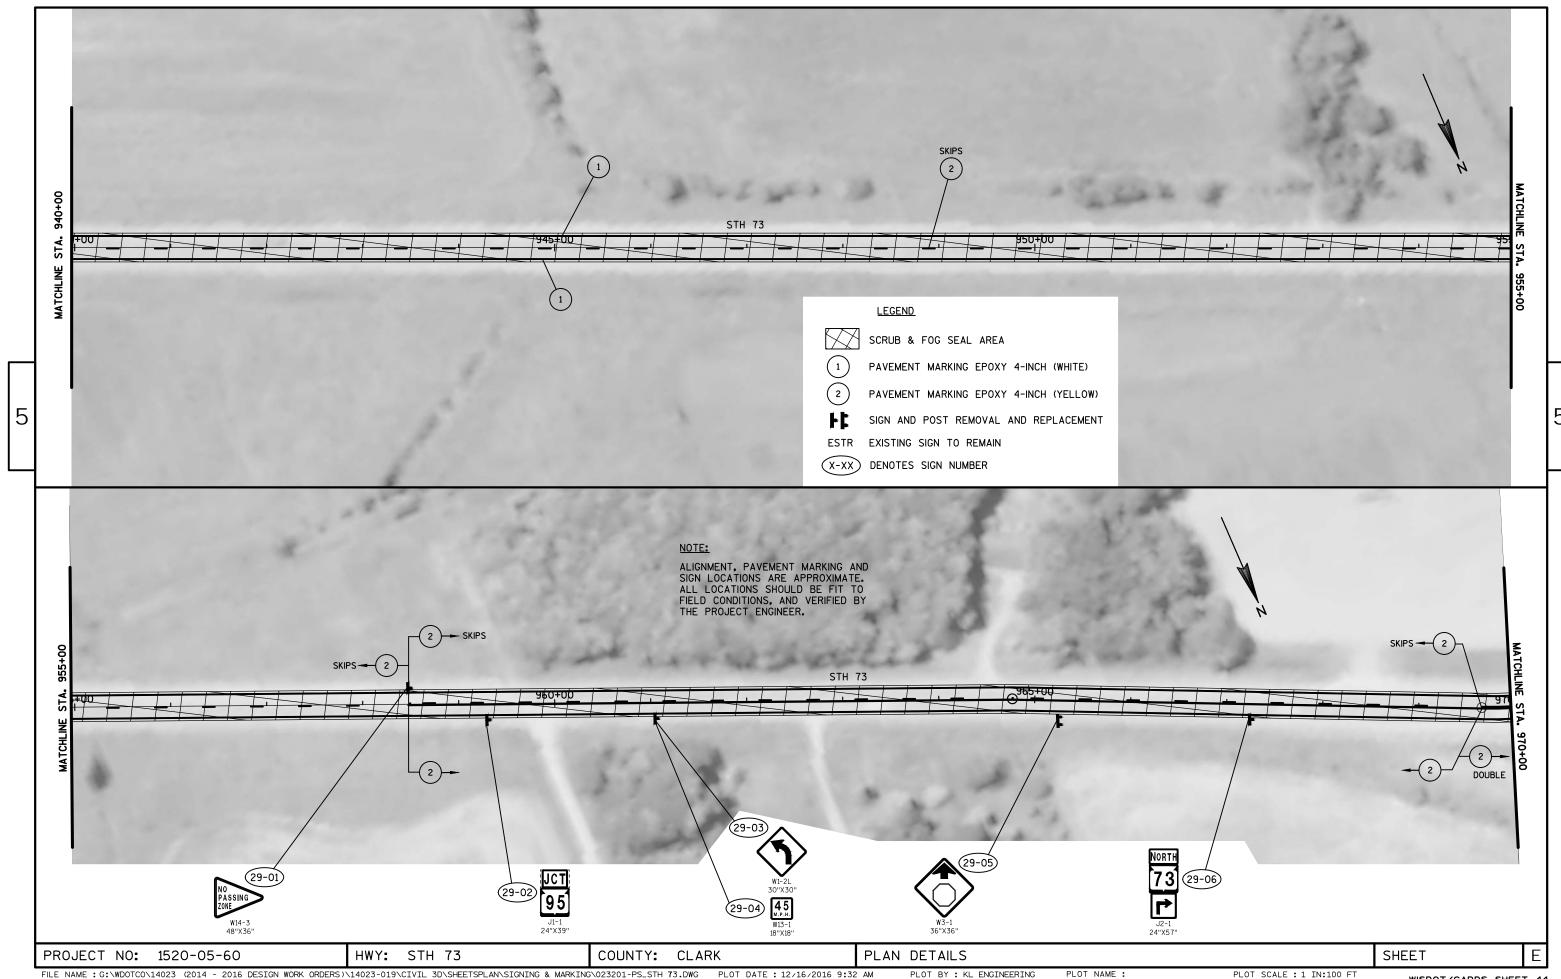

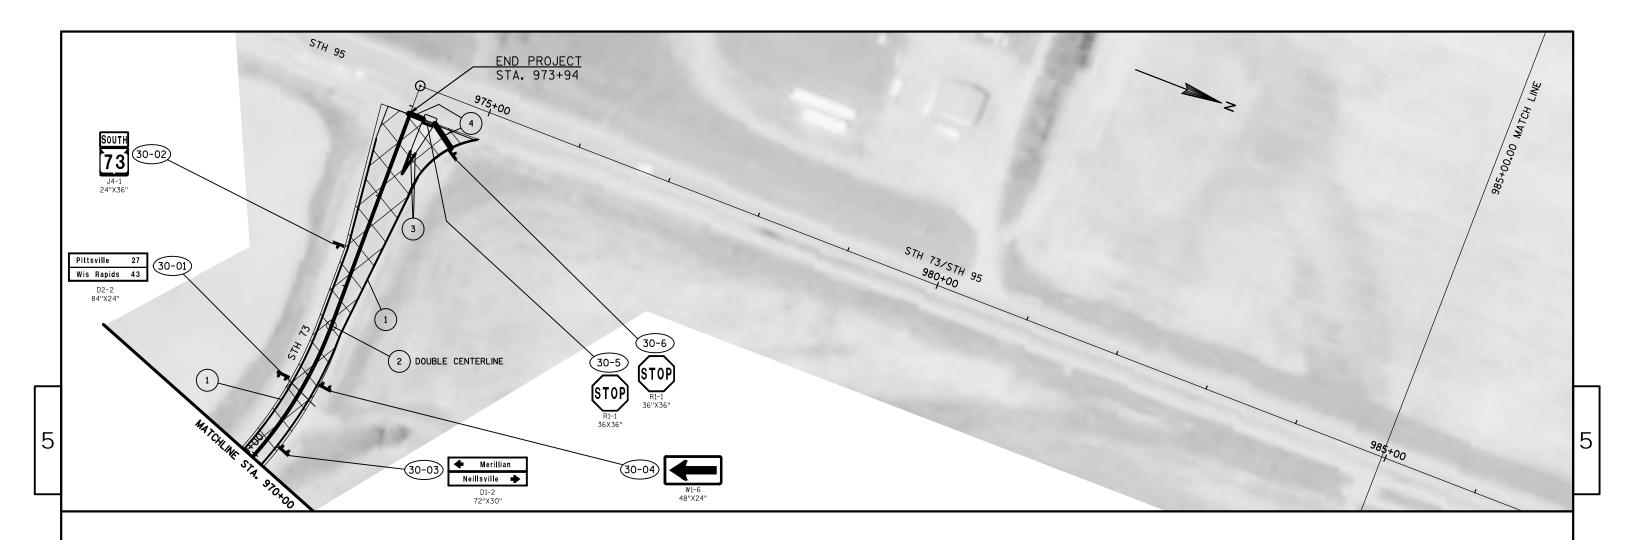

<u>LEGEND</u>

1 PAVEMENT MARKING EPOXY 4-INCH (WHITE)

2 PAVEMENT MARKING EPOXY 4-INCH (YELLOW)

3) PAVEMENT MARKING EPOXY 8-INCH (WHITE)

4 PAVEMENT MARKING STOPLINE EPOXY 18-INCH (WHITE)

SCRUB & FOG SEAL AREA

SIGN REMOVAL AND REPLACEMENT

SIGN AND POST REMOVAL AND REPLACEMENT

ESTR EXISTING SIGN TO REMAIN


-XX) DENOTES SIGN NUMBER


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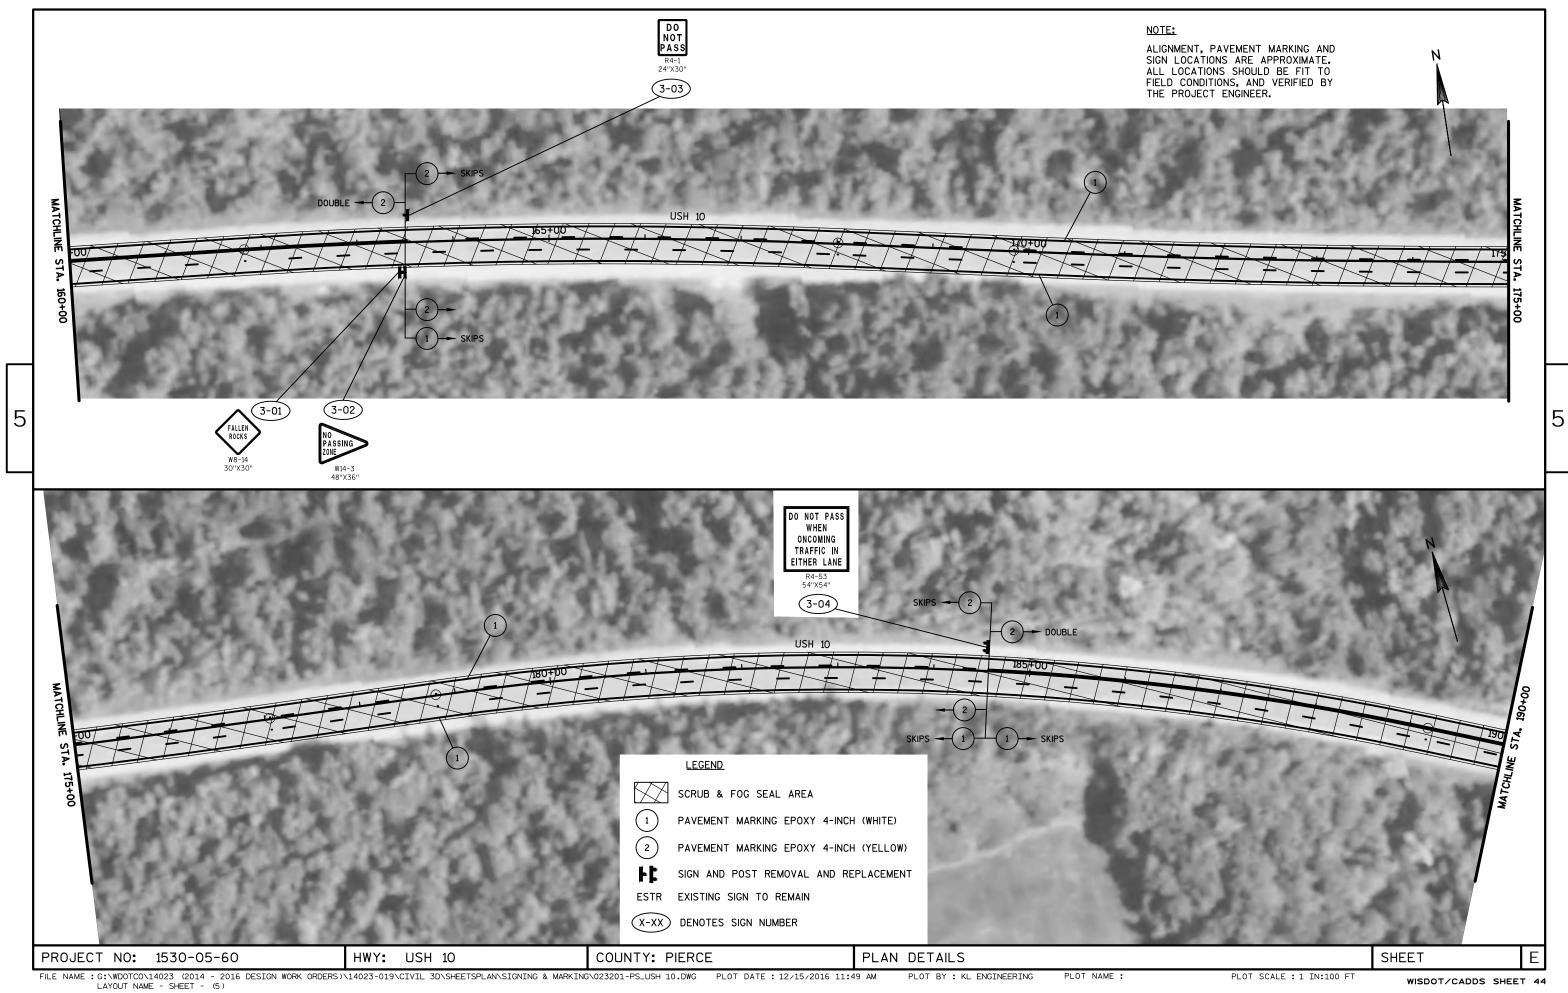
NOTE:


ALIGNMENT, PAVEMENT MARKING AND SIGN LOCATIONS ARE APPROXIMATE. ALL LOCATIONS SHOULD BE FIT TO FIELD CONDITIONS, AND VERIFIED BY THE PROJECT ENGINEER.


PROJECT NO: 1520-05-60 HWY: STH 73 COUNTY: CLARK PLAN DETAILS SHEET E




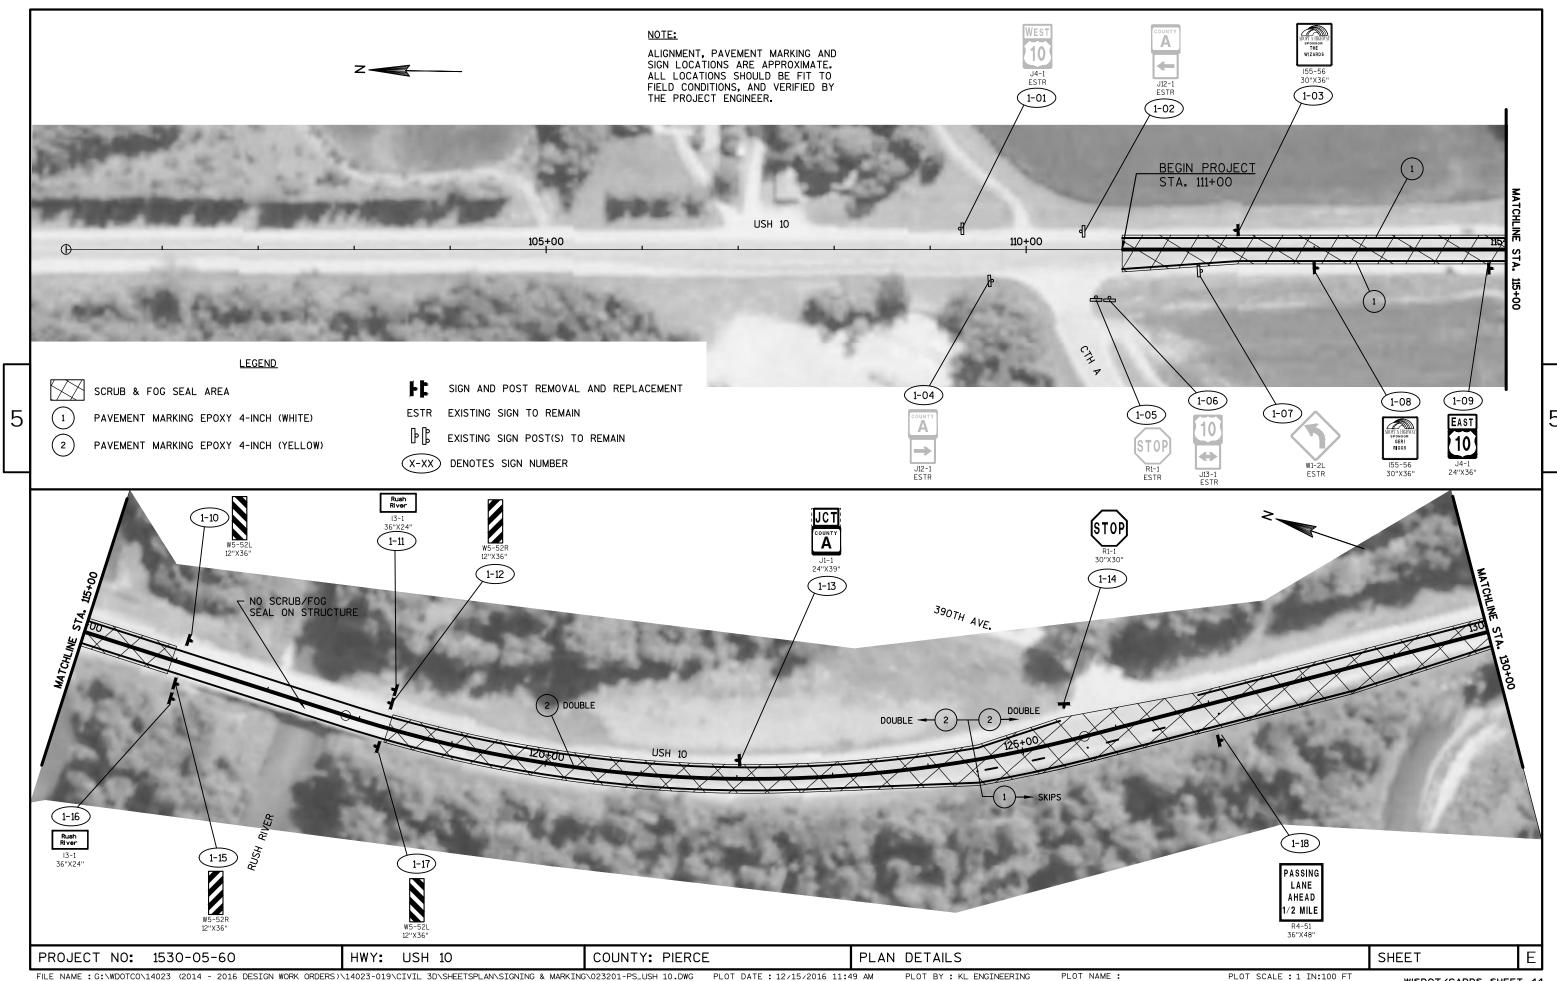


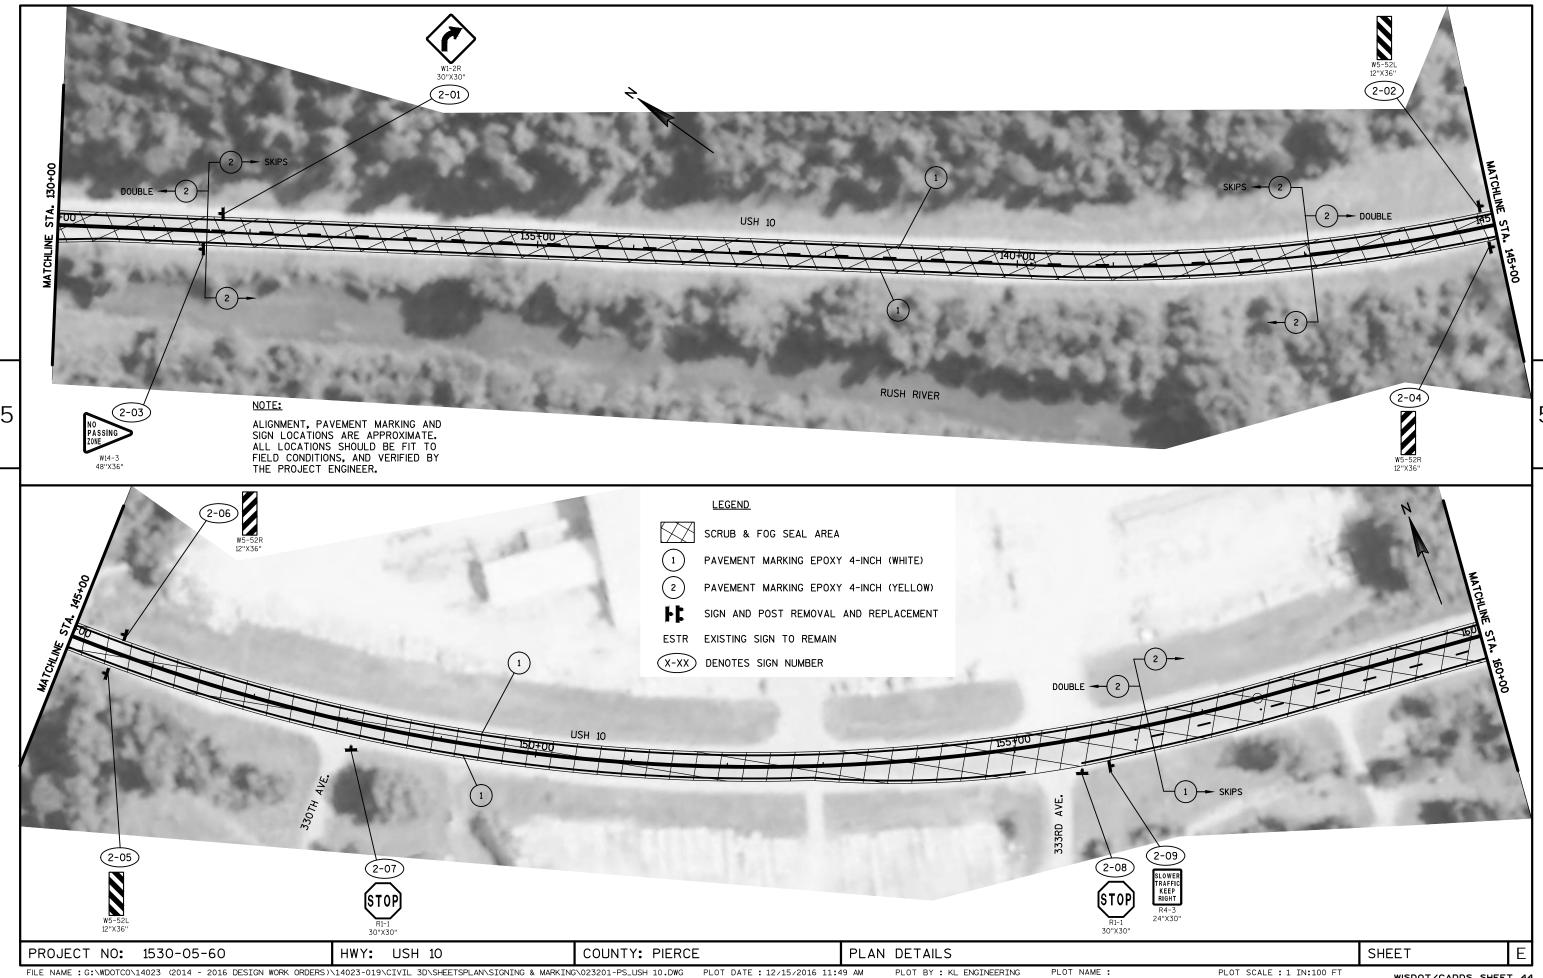


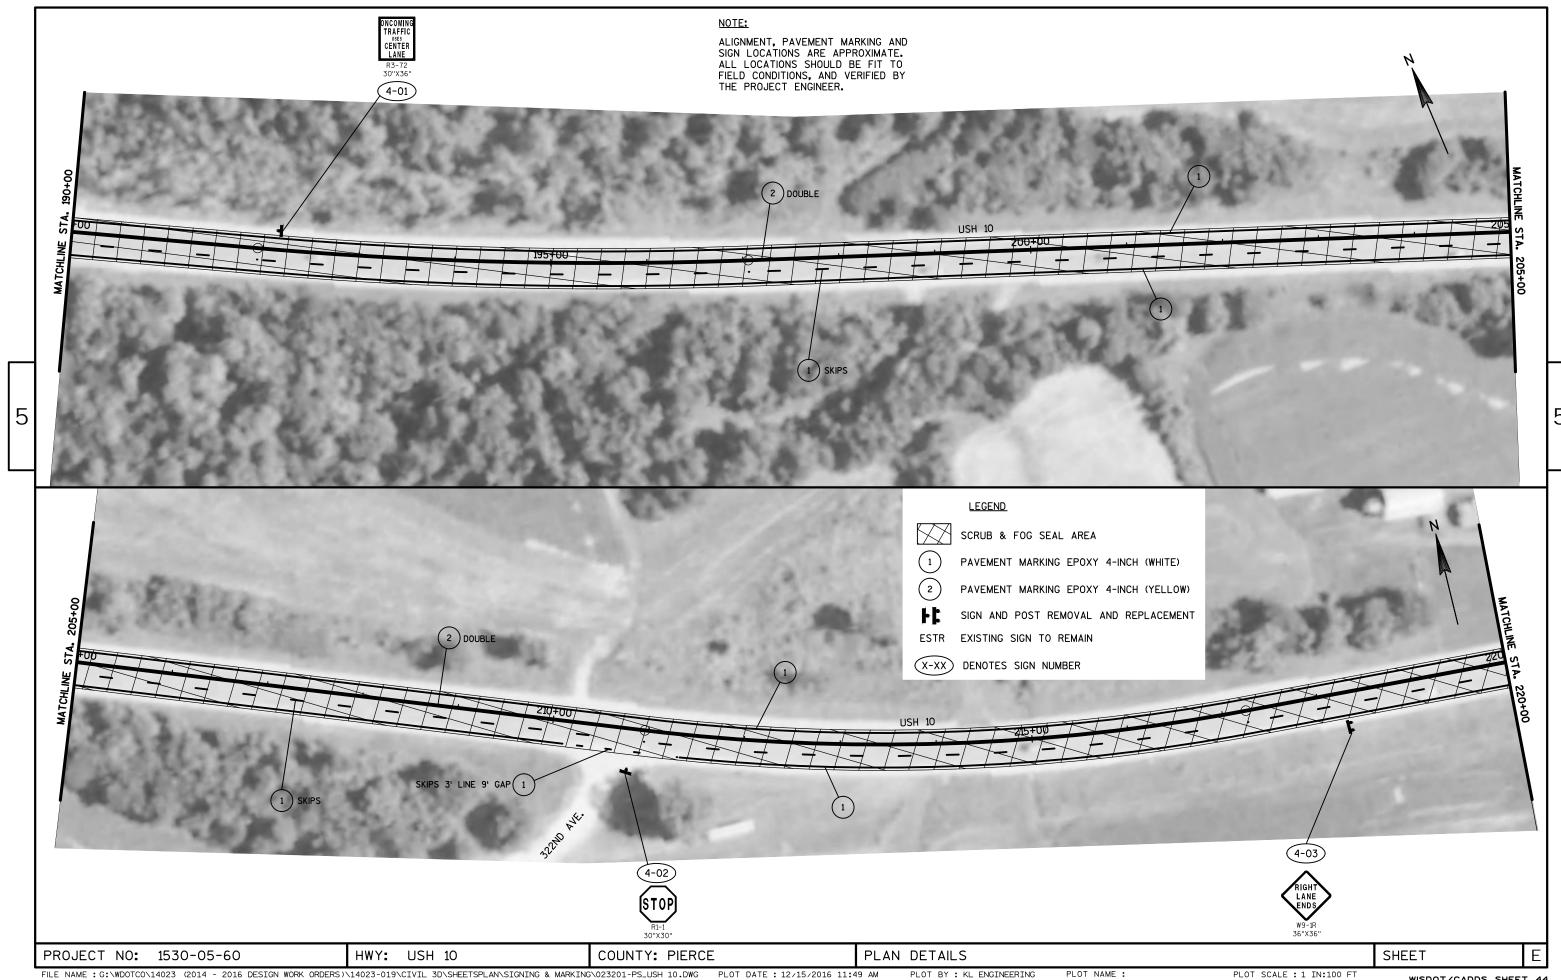


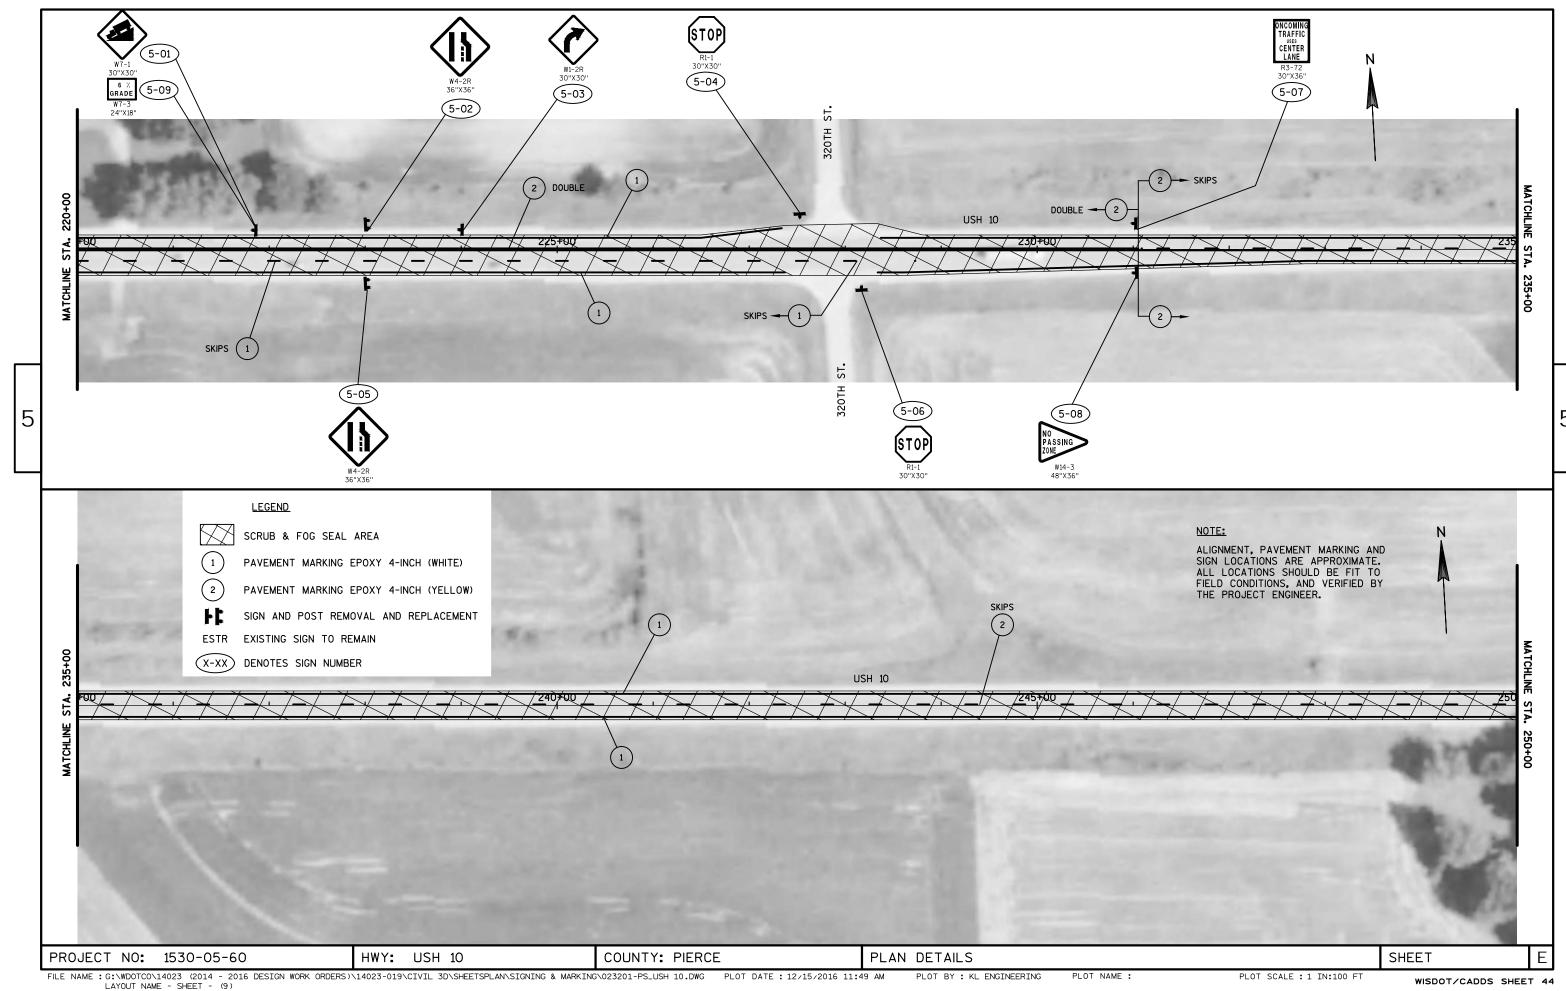


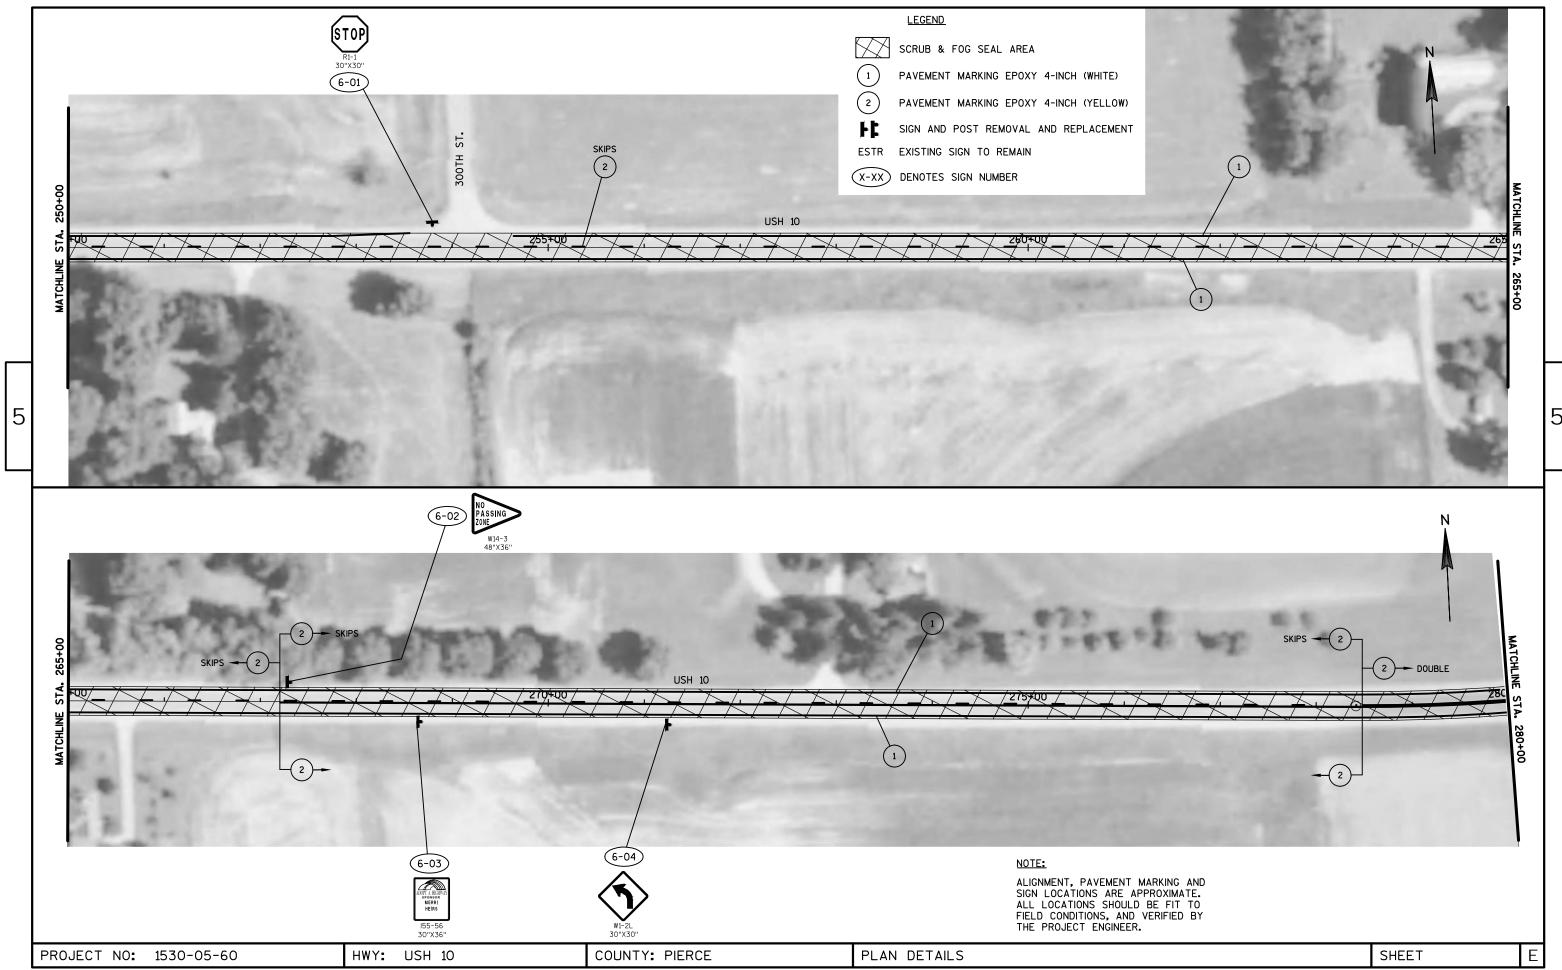


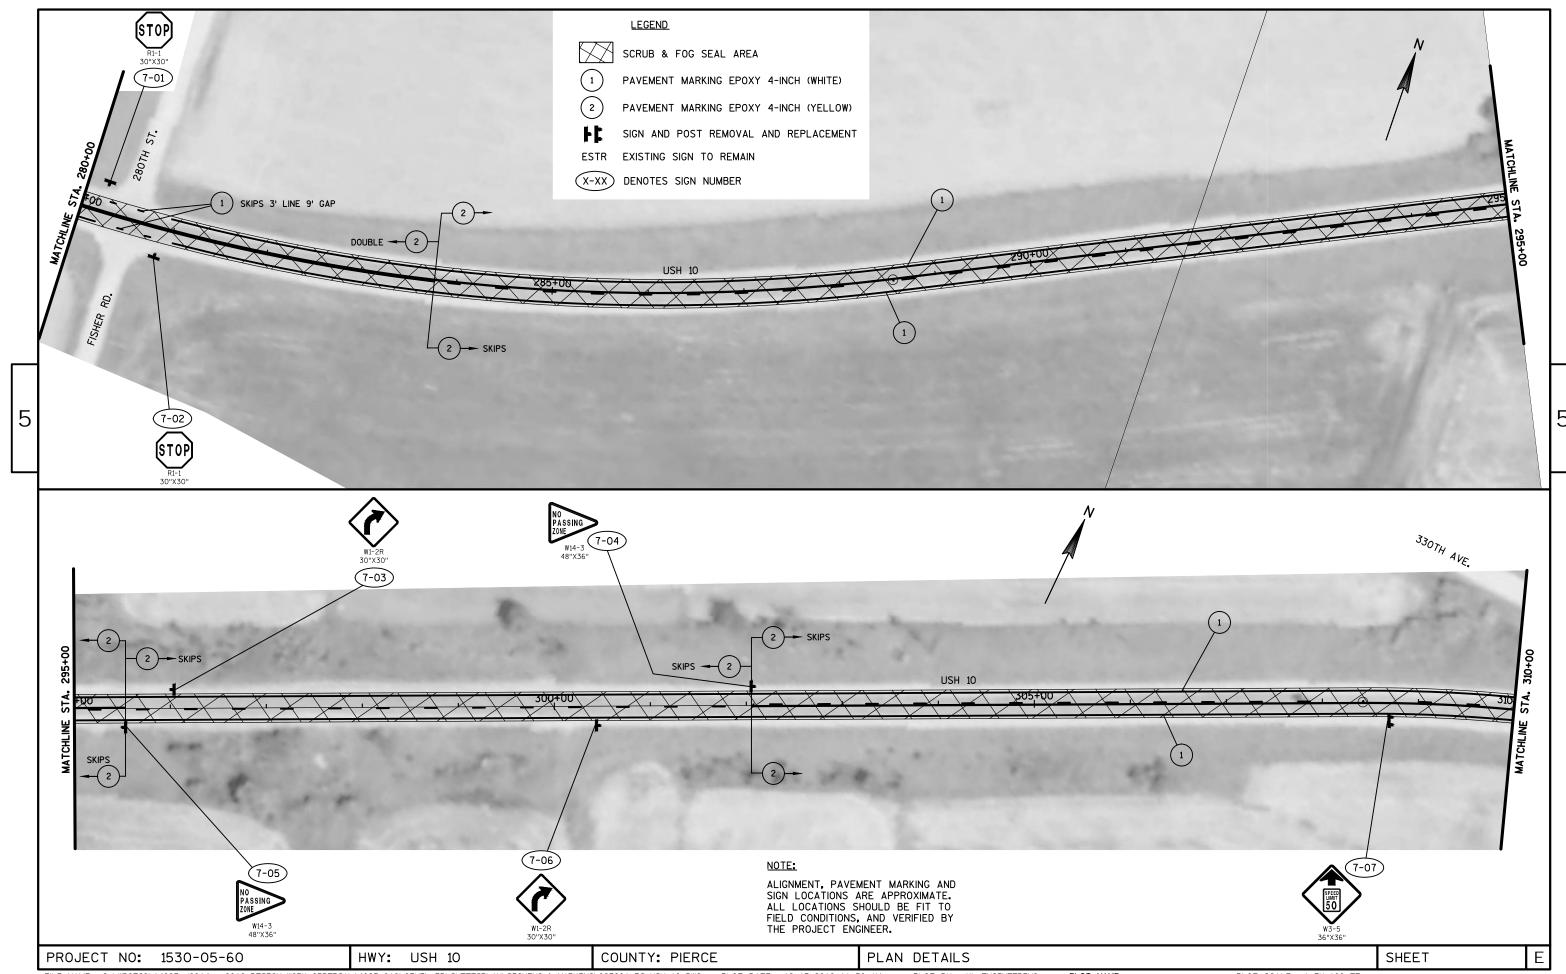


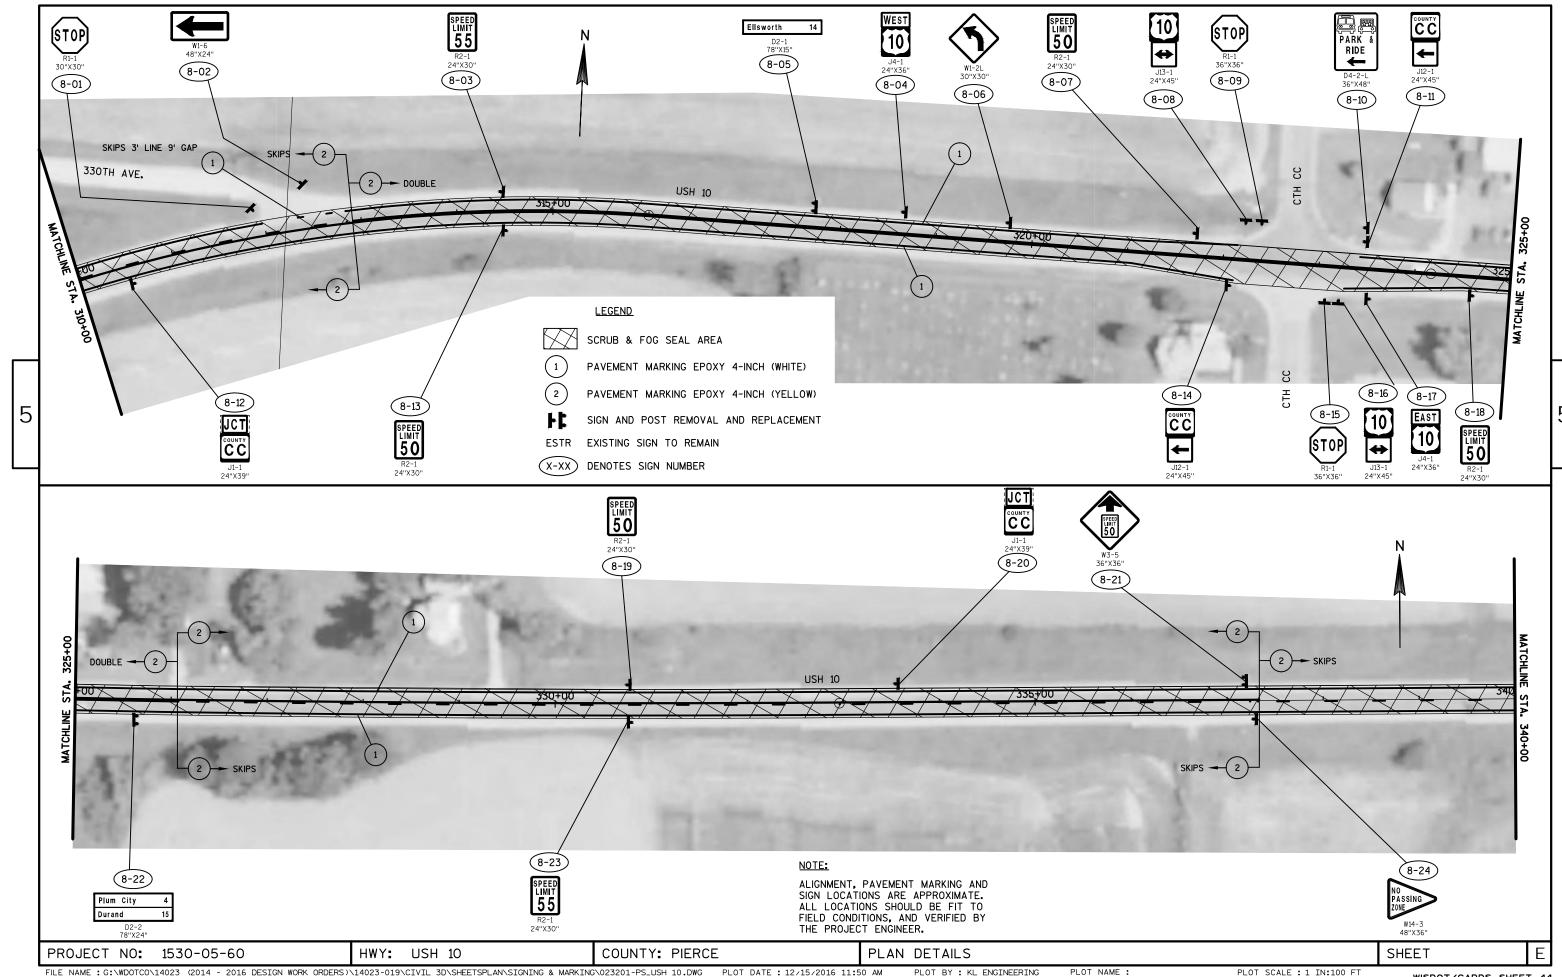


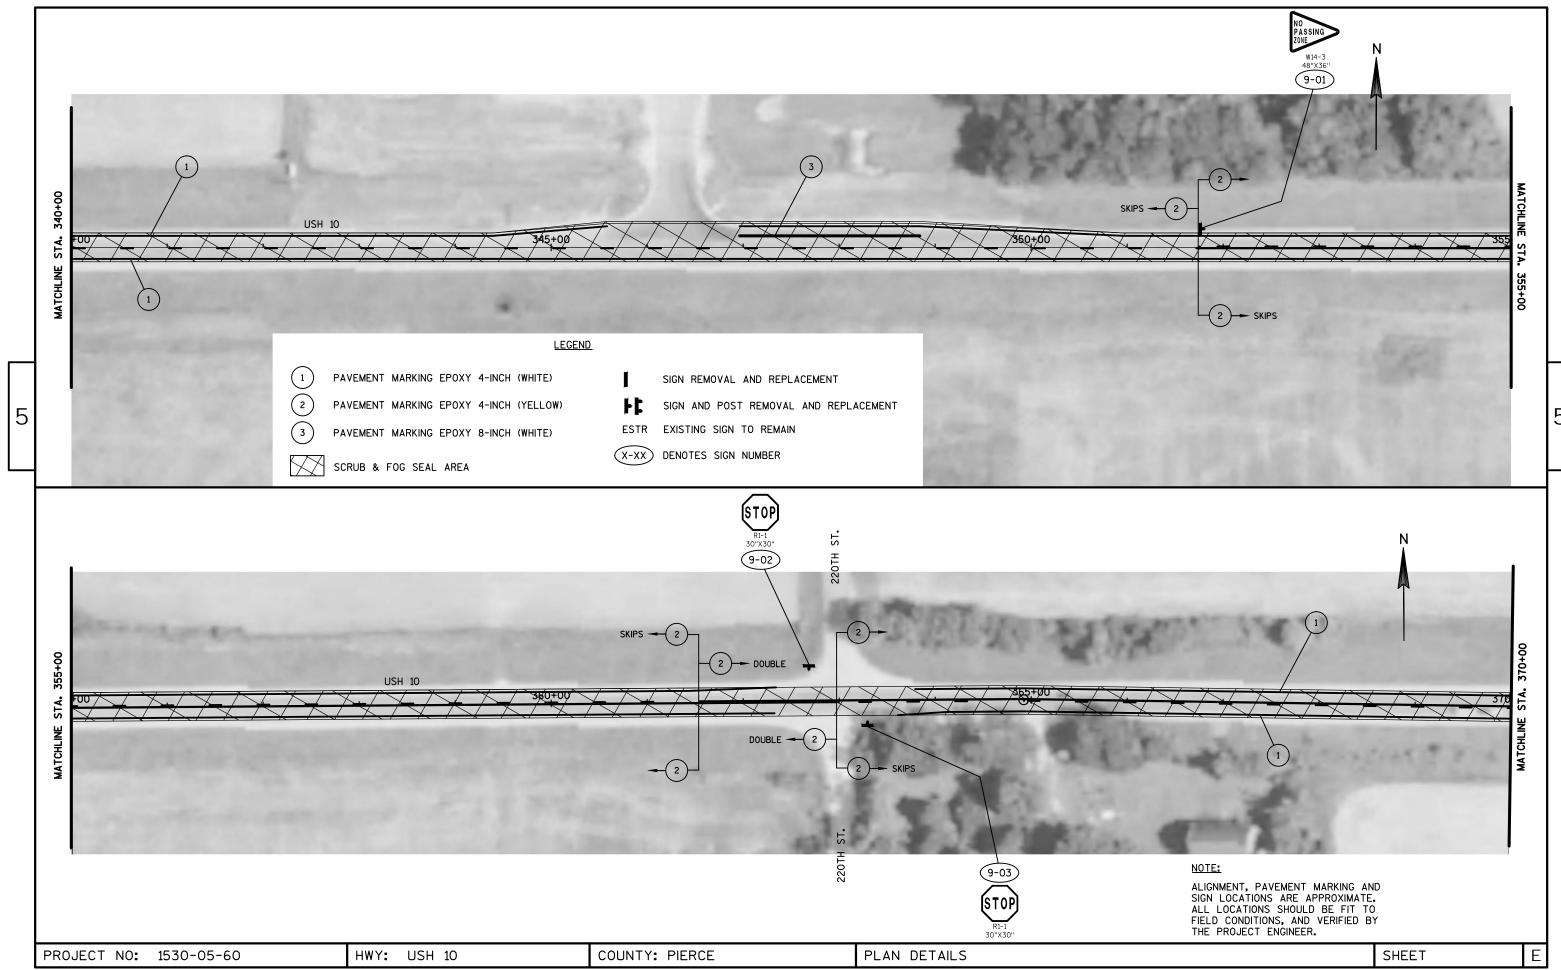


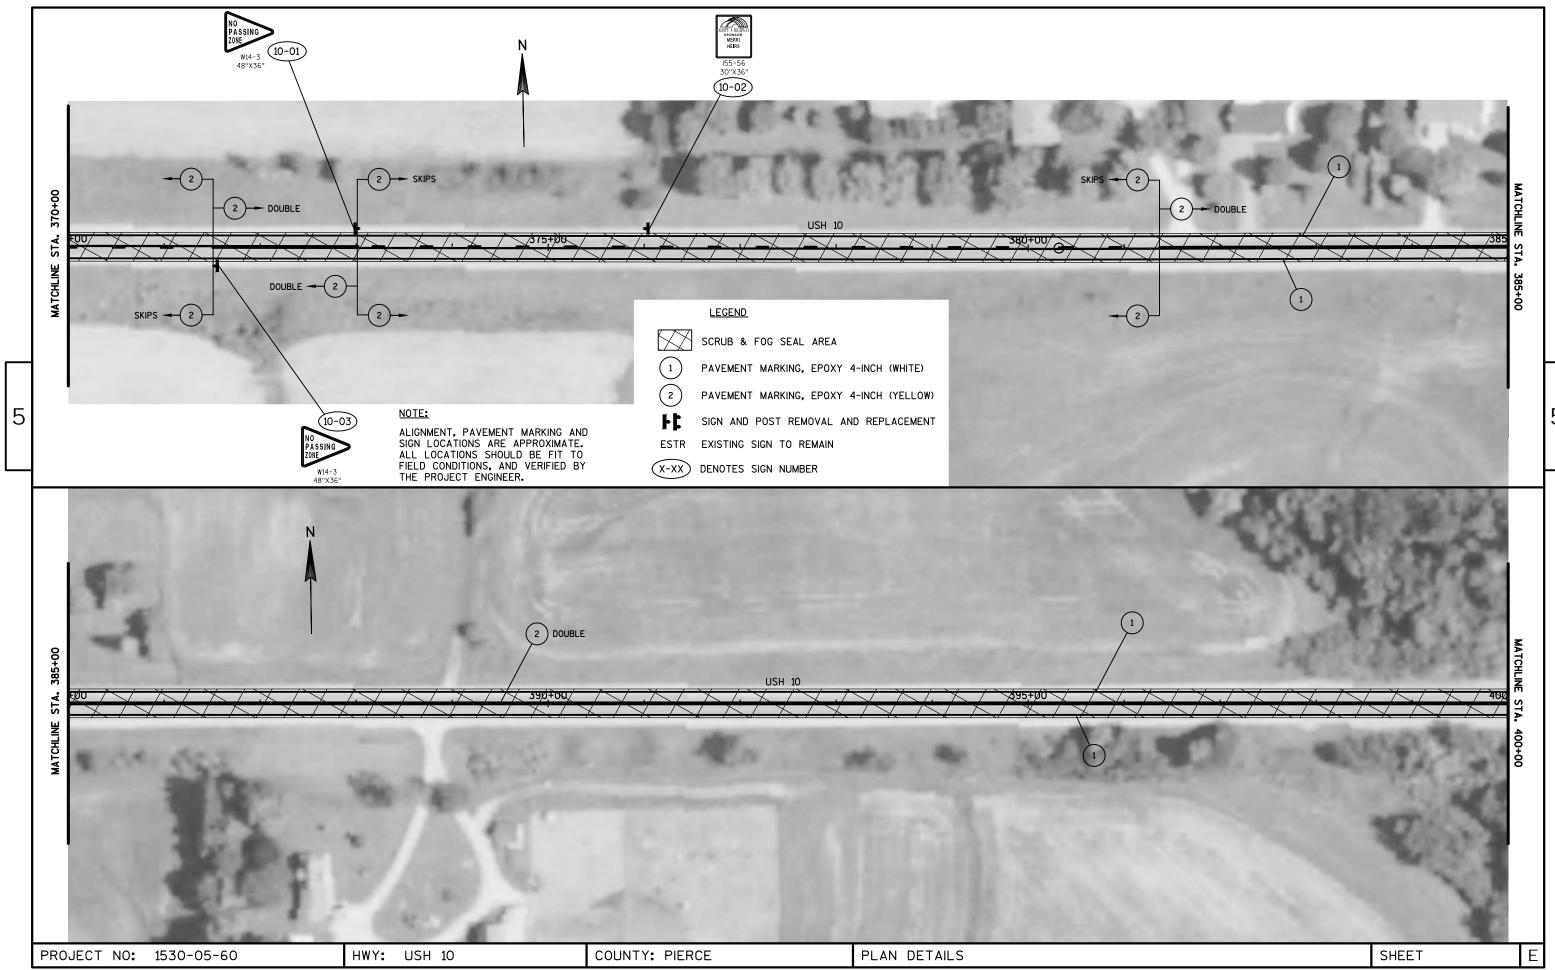


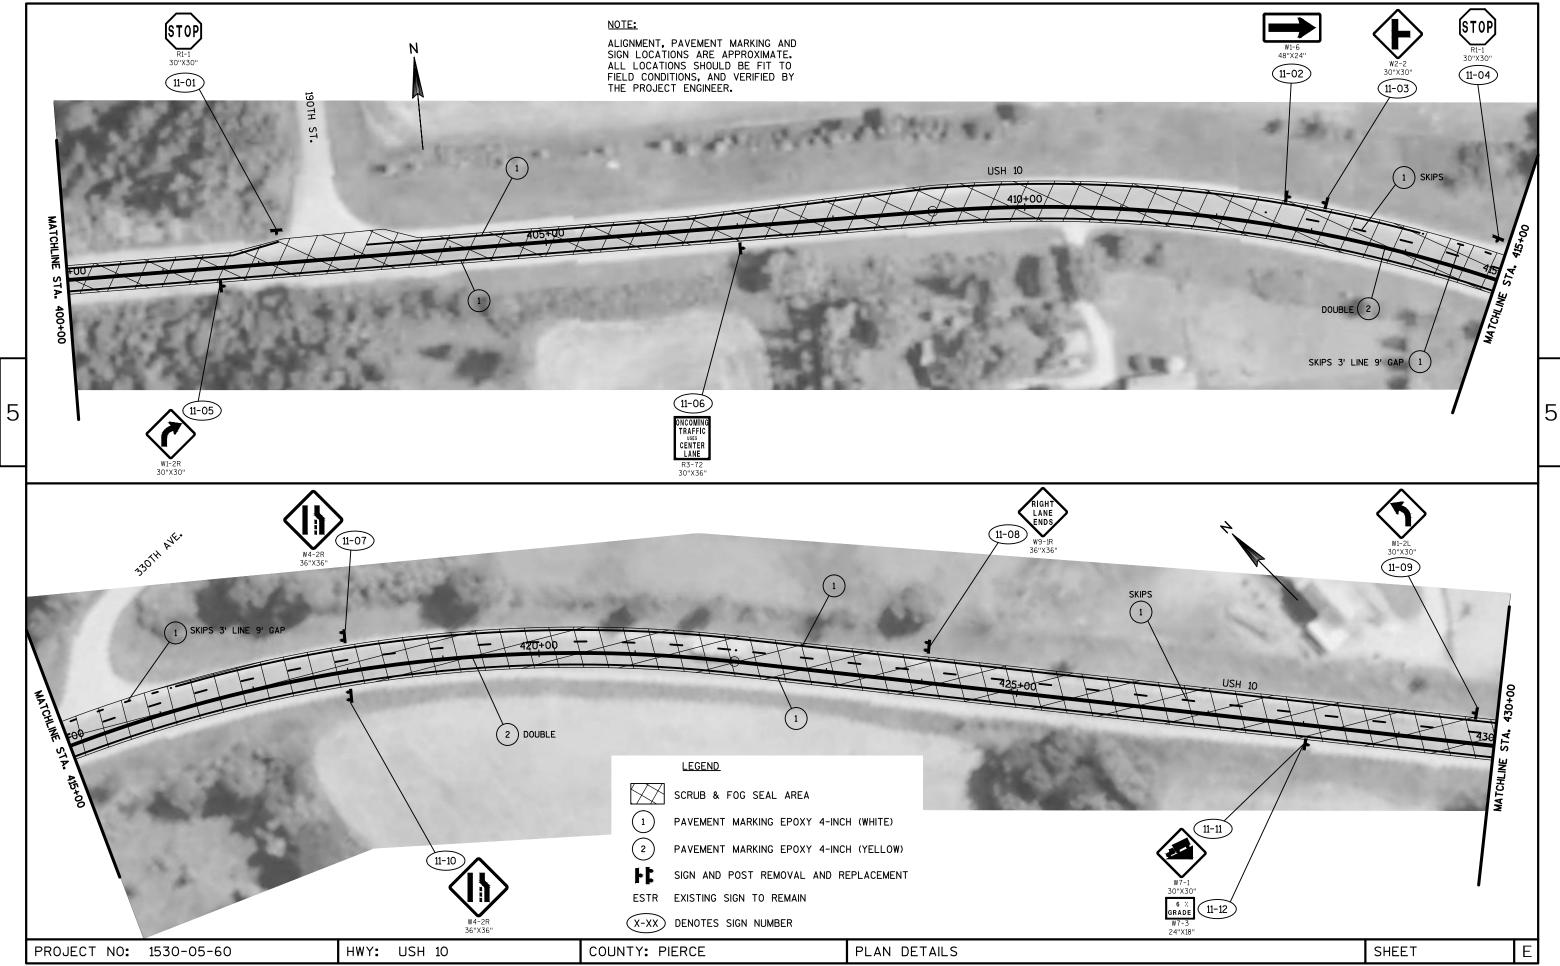

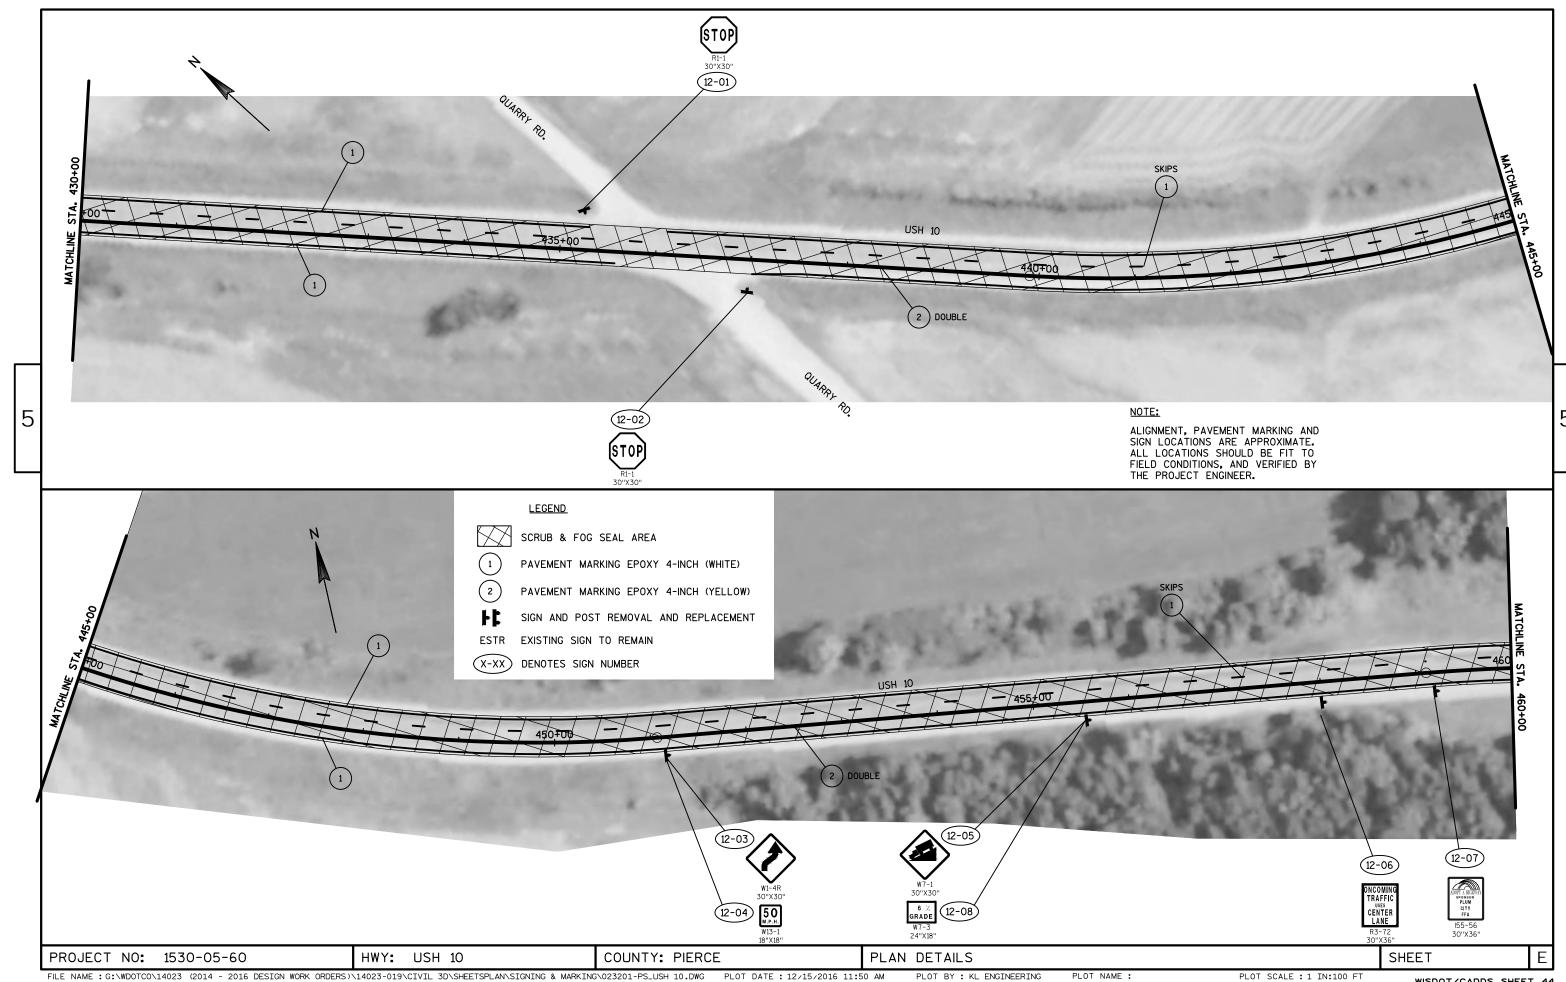


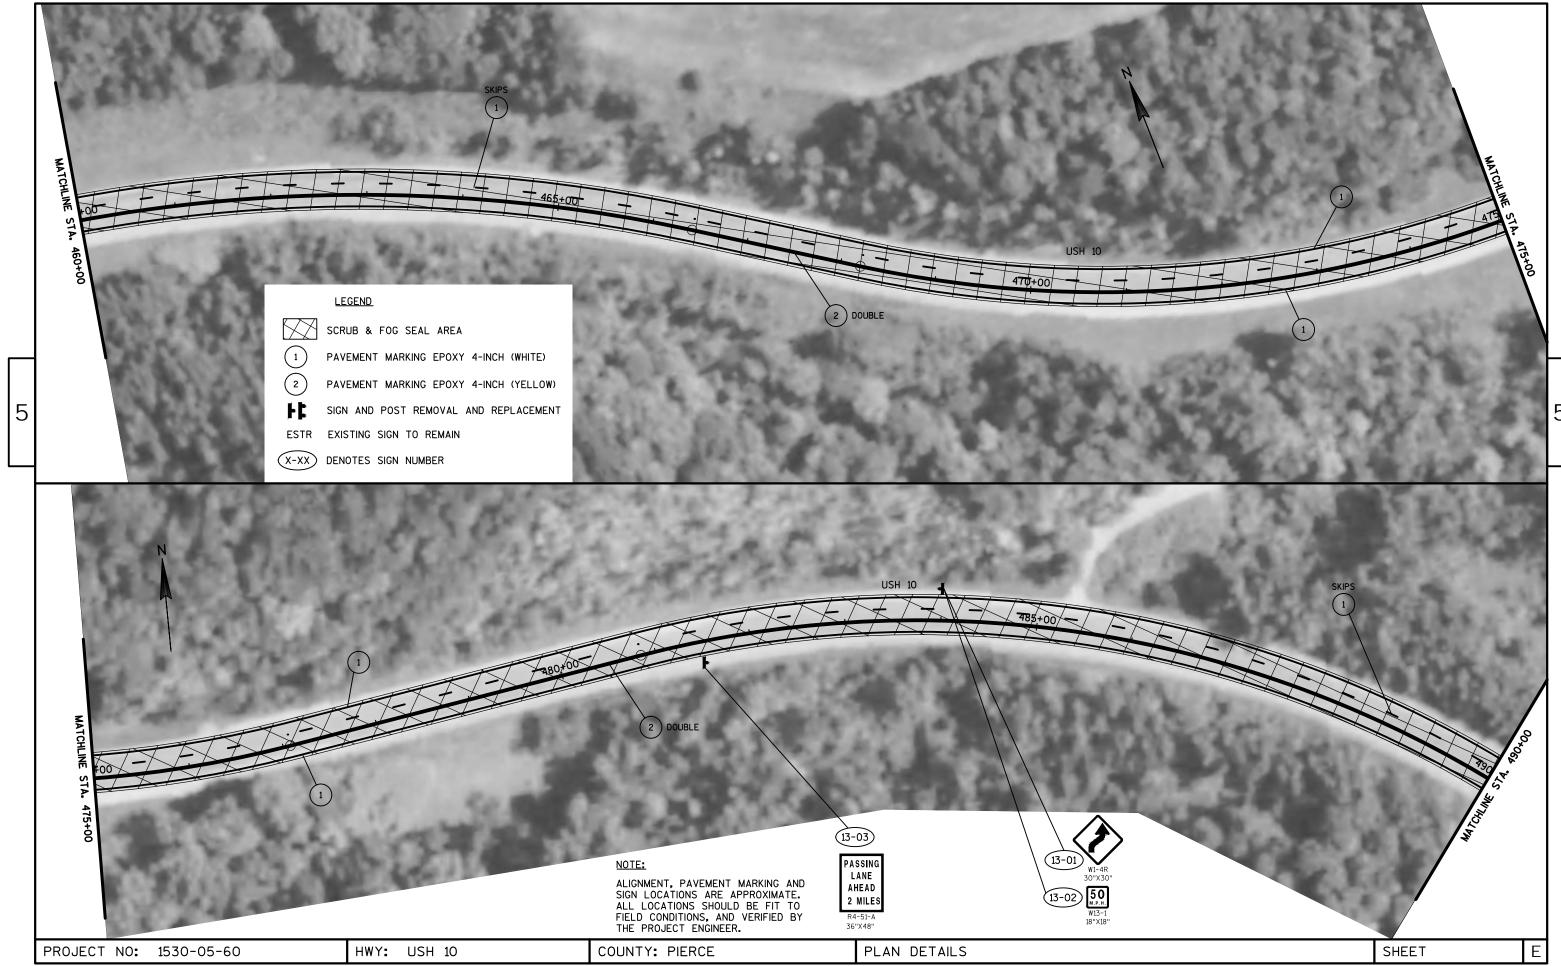


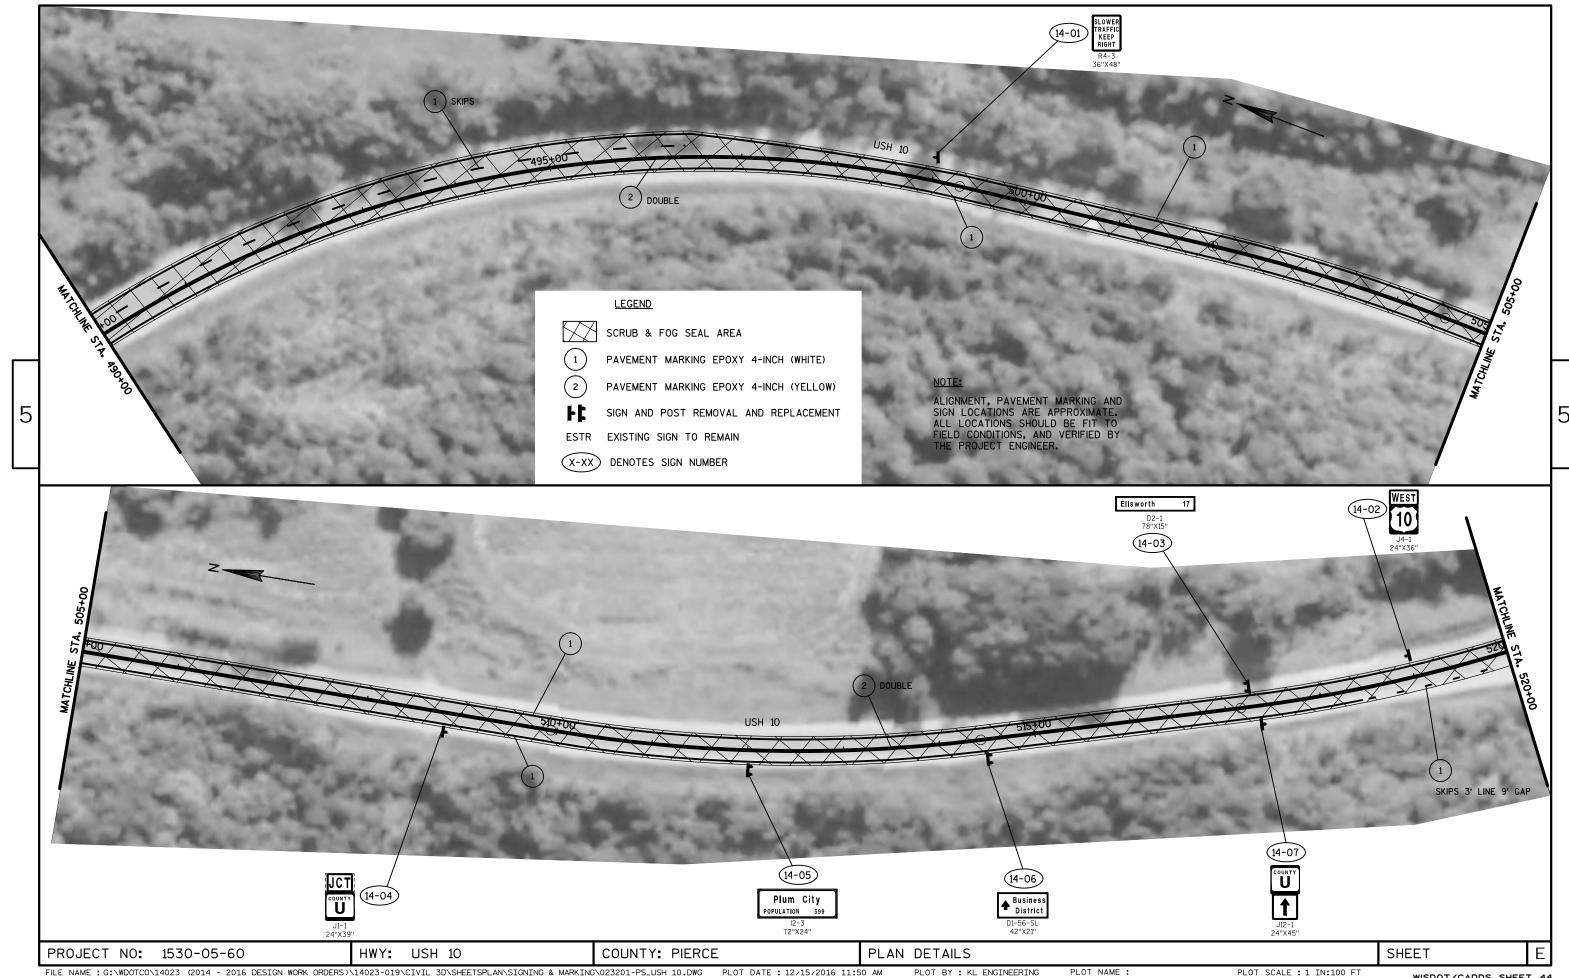


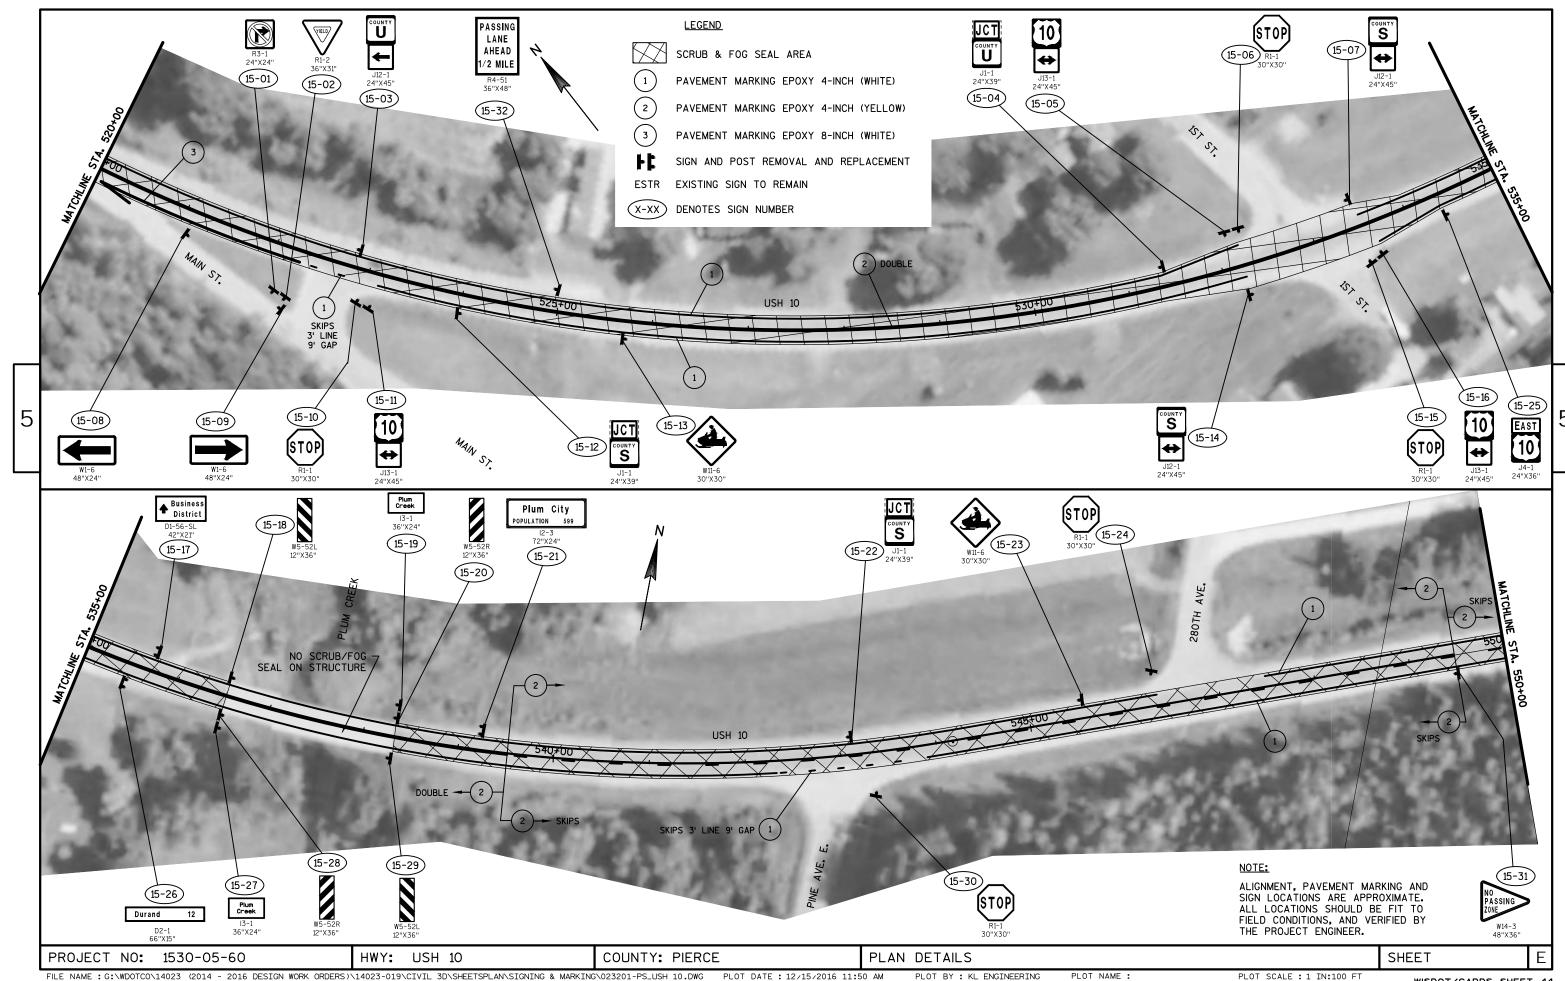





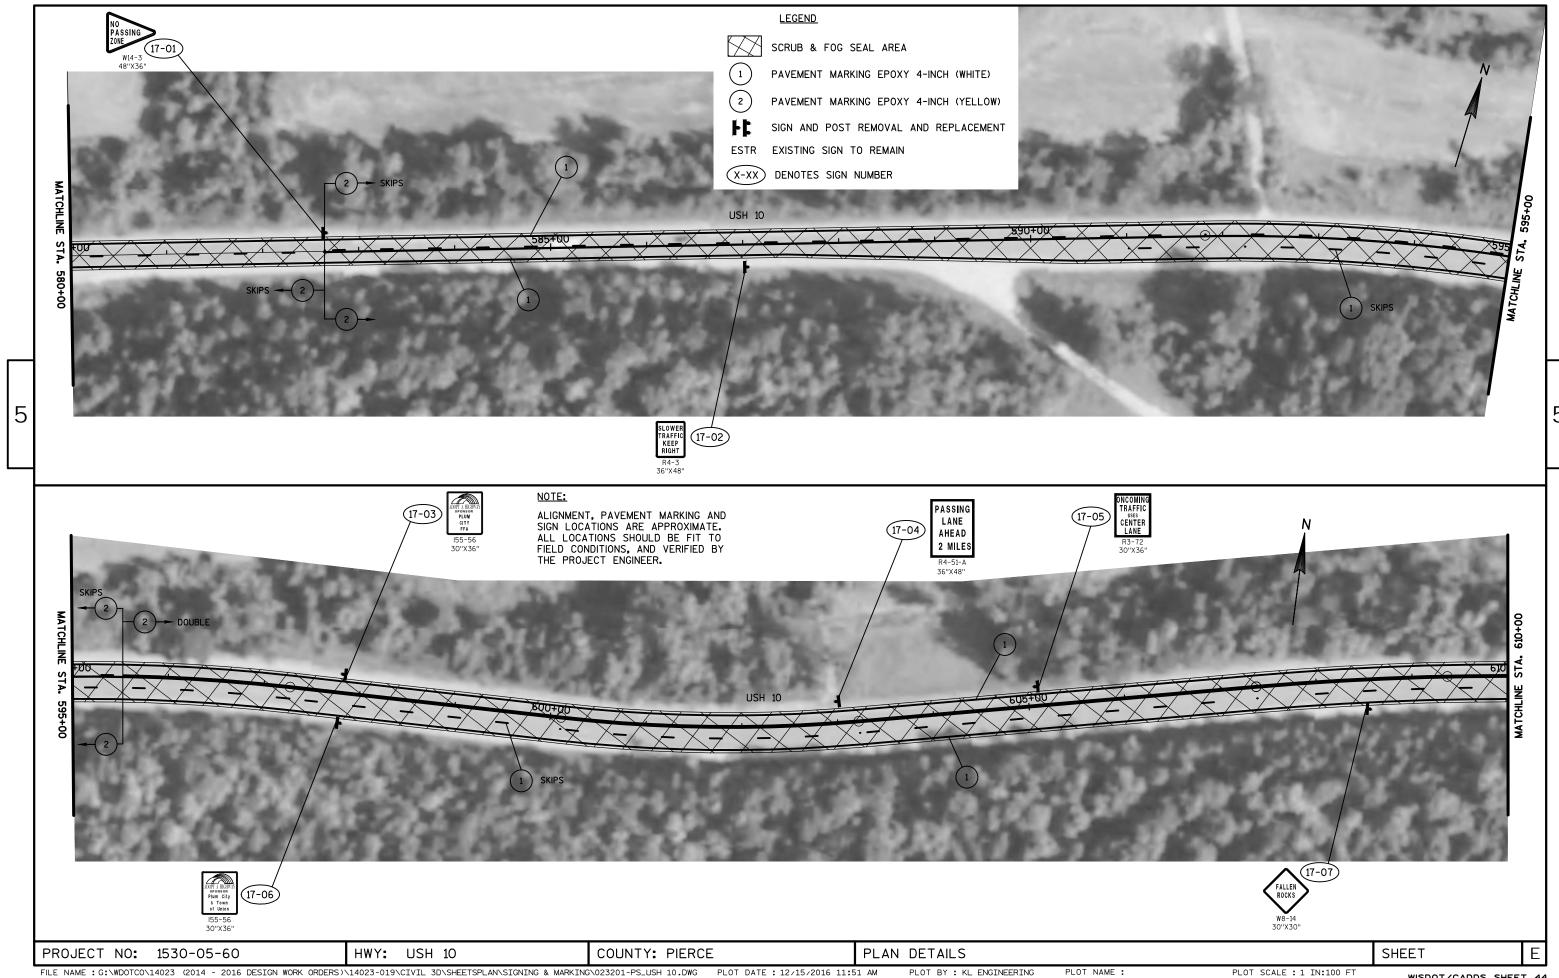


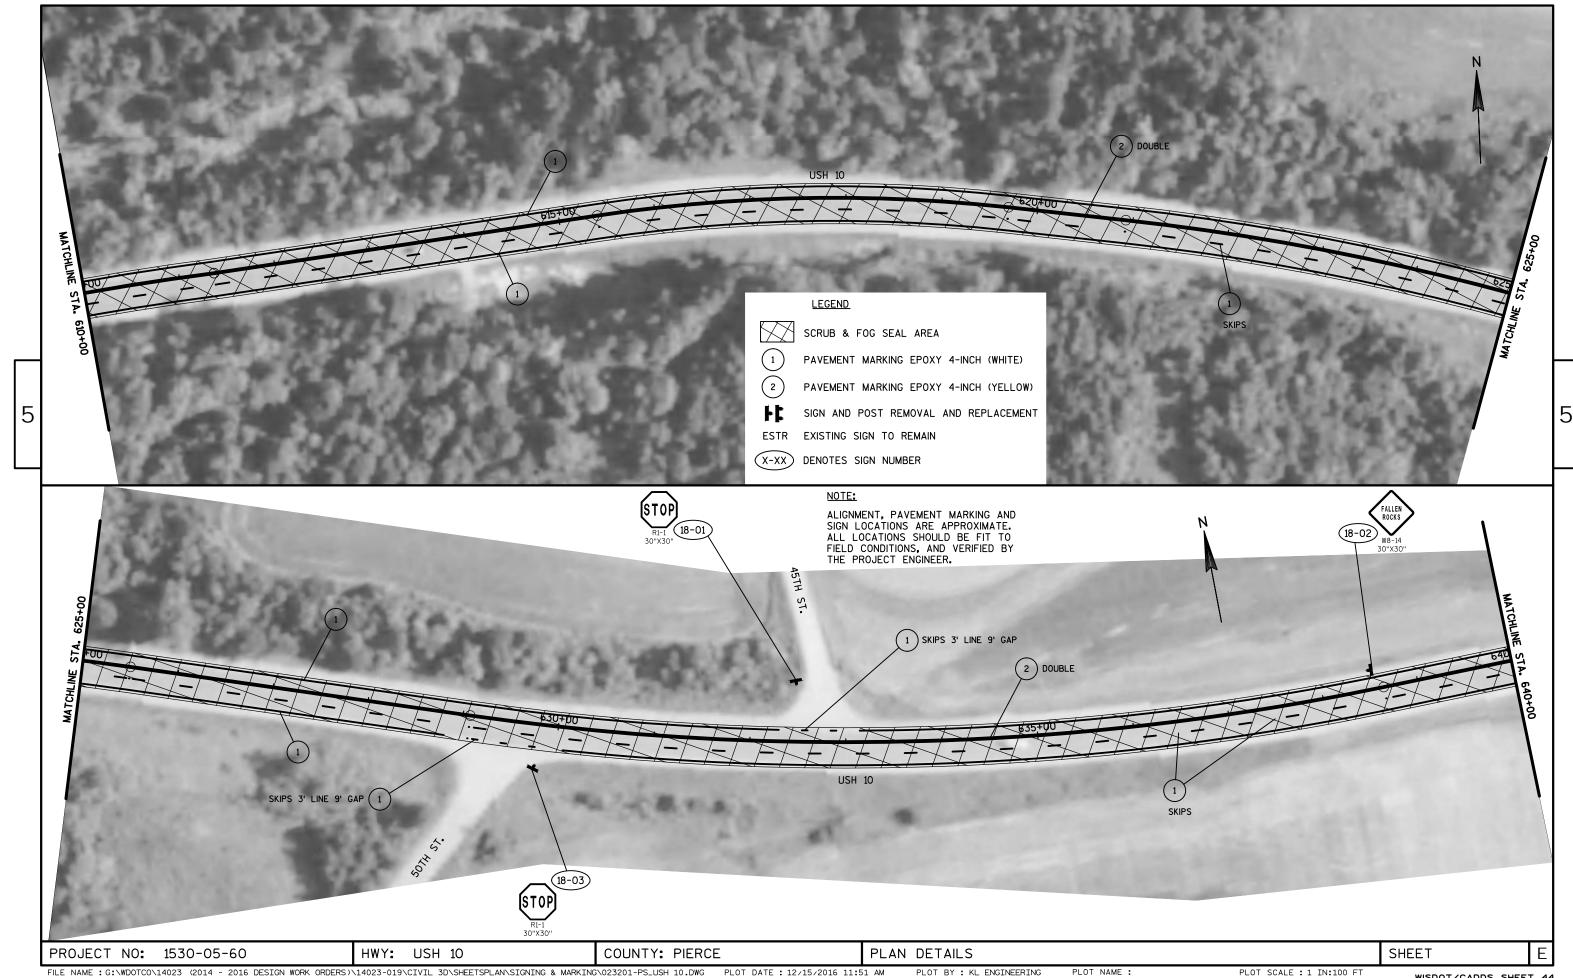


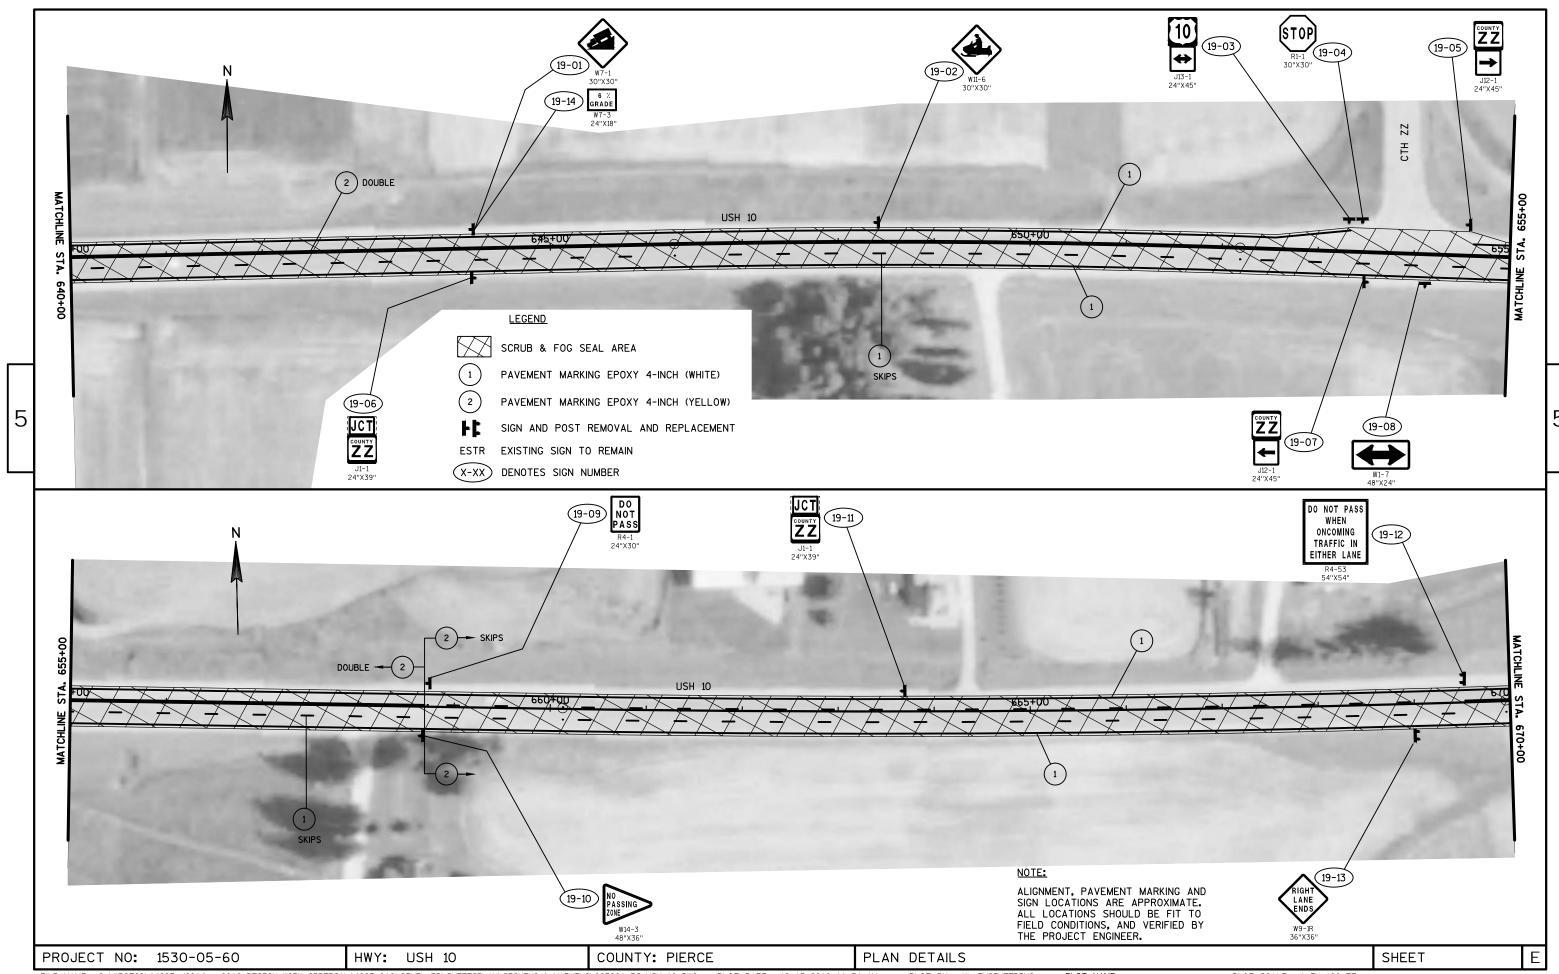


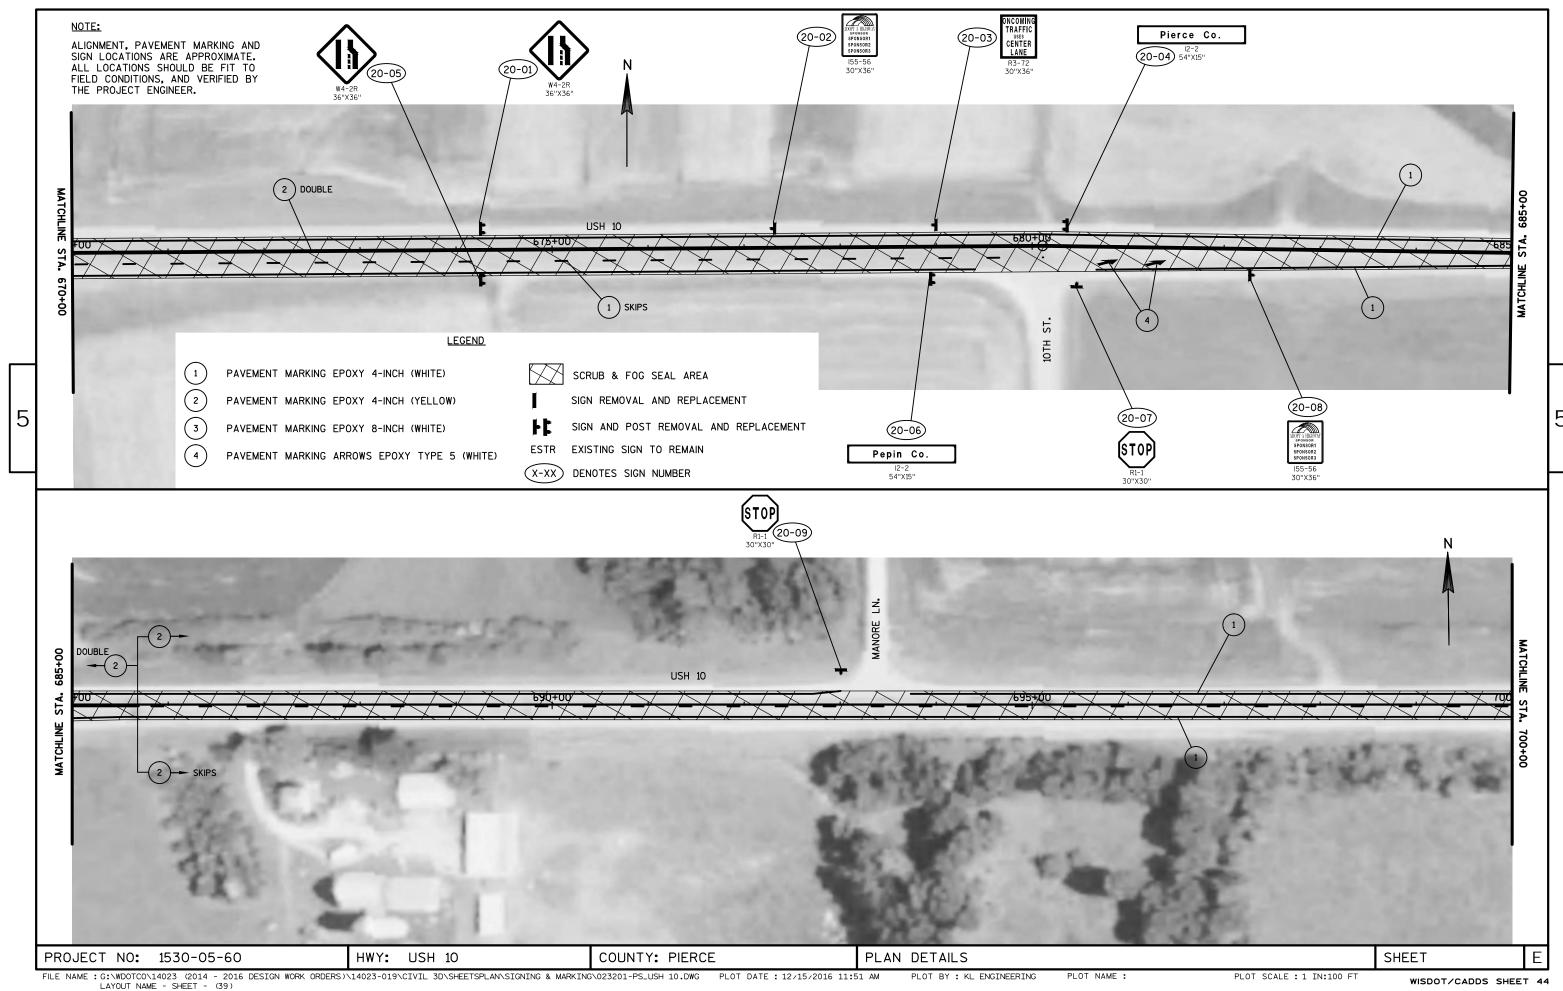


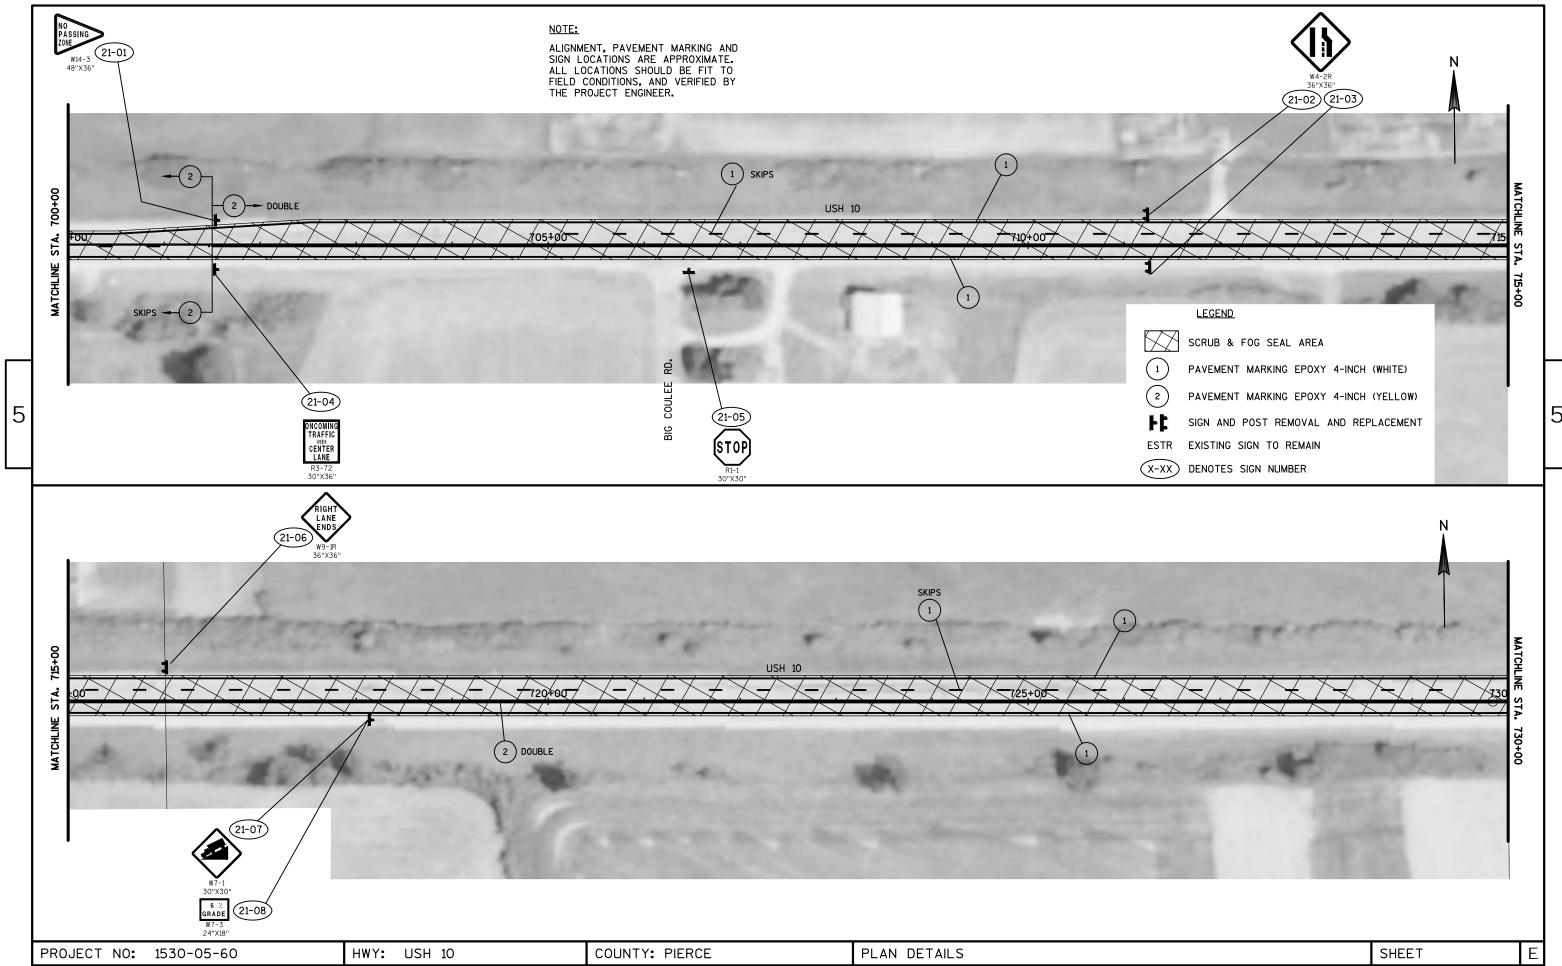


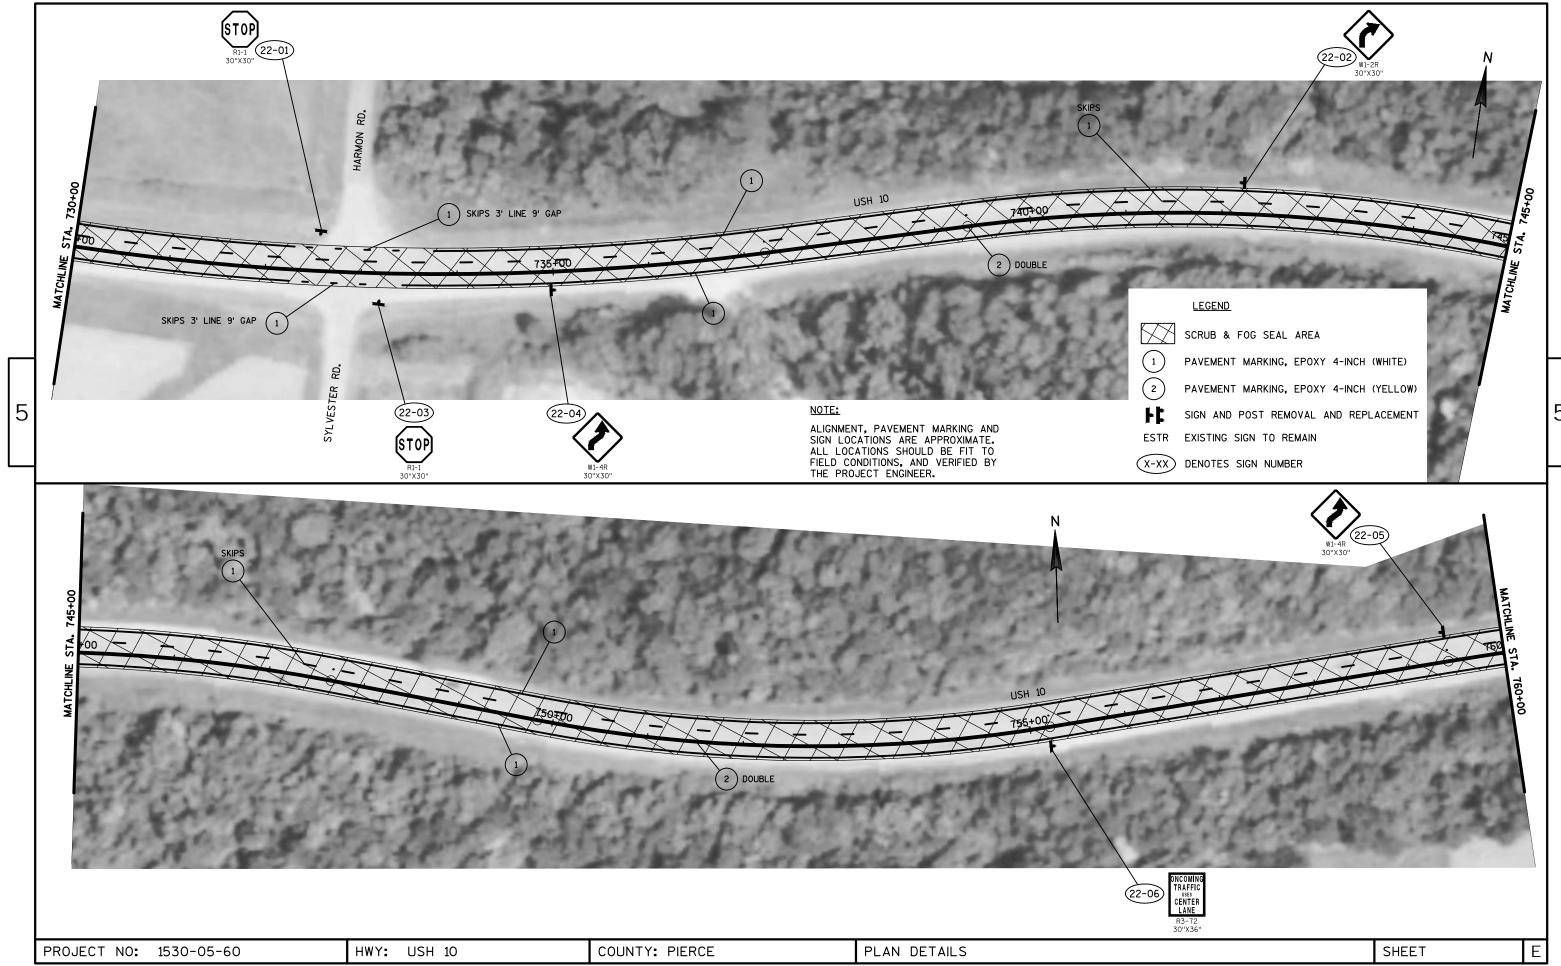


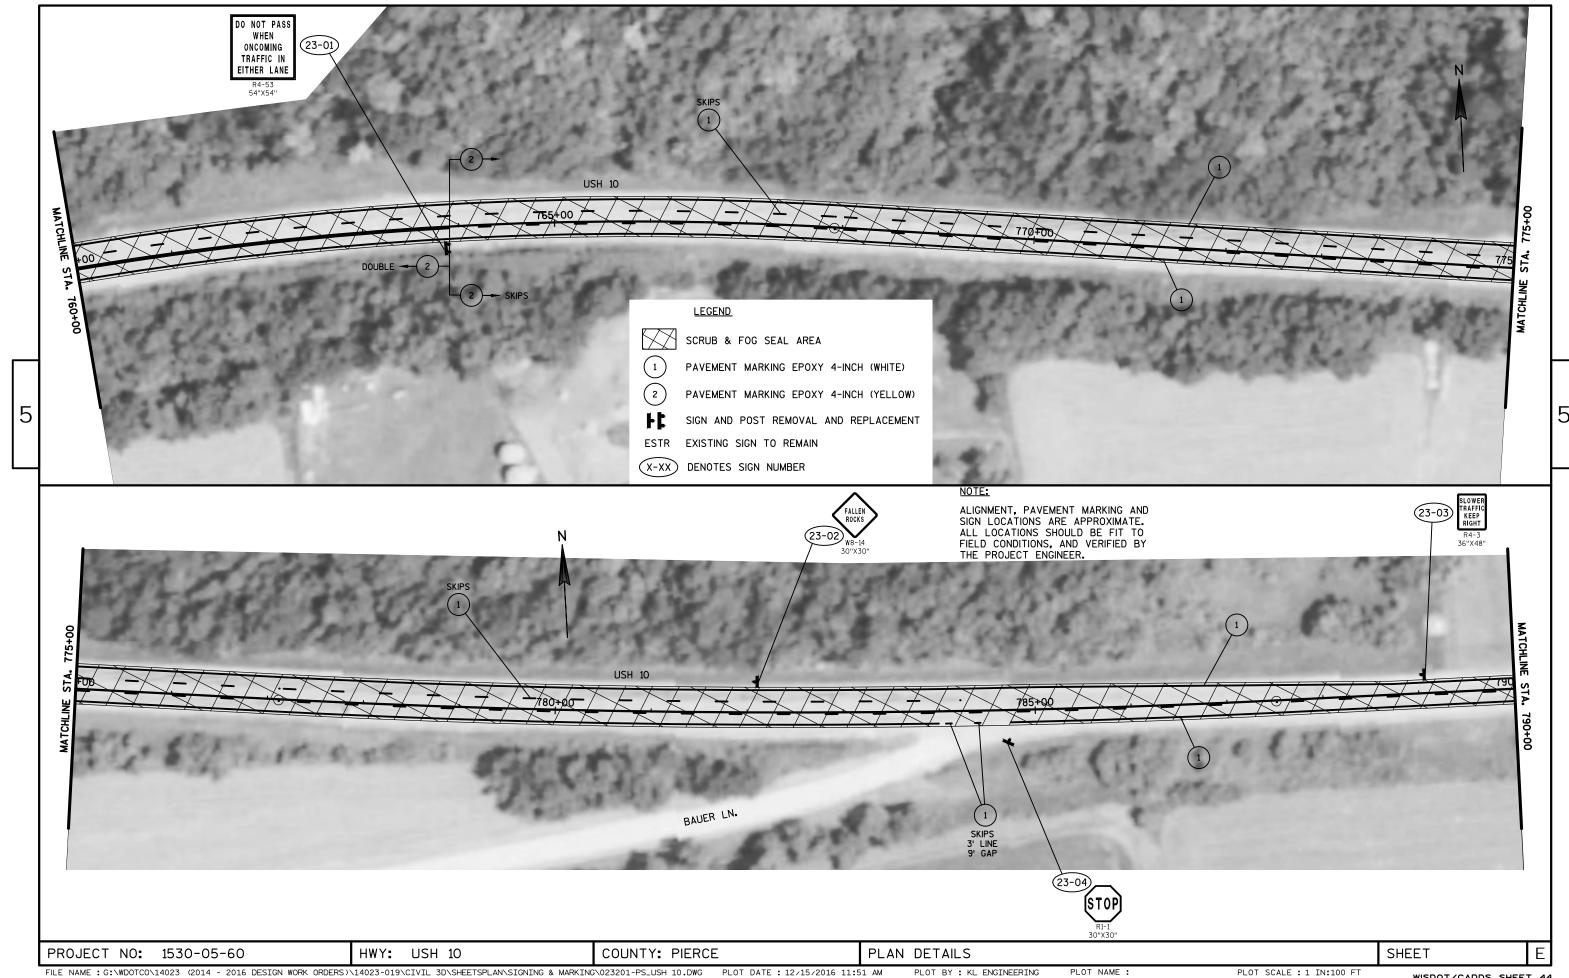


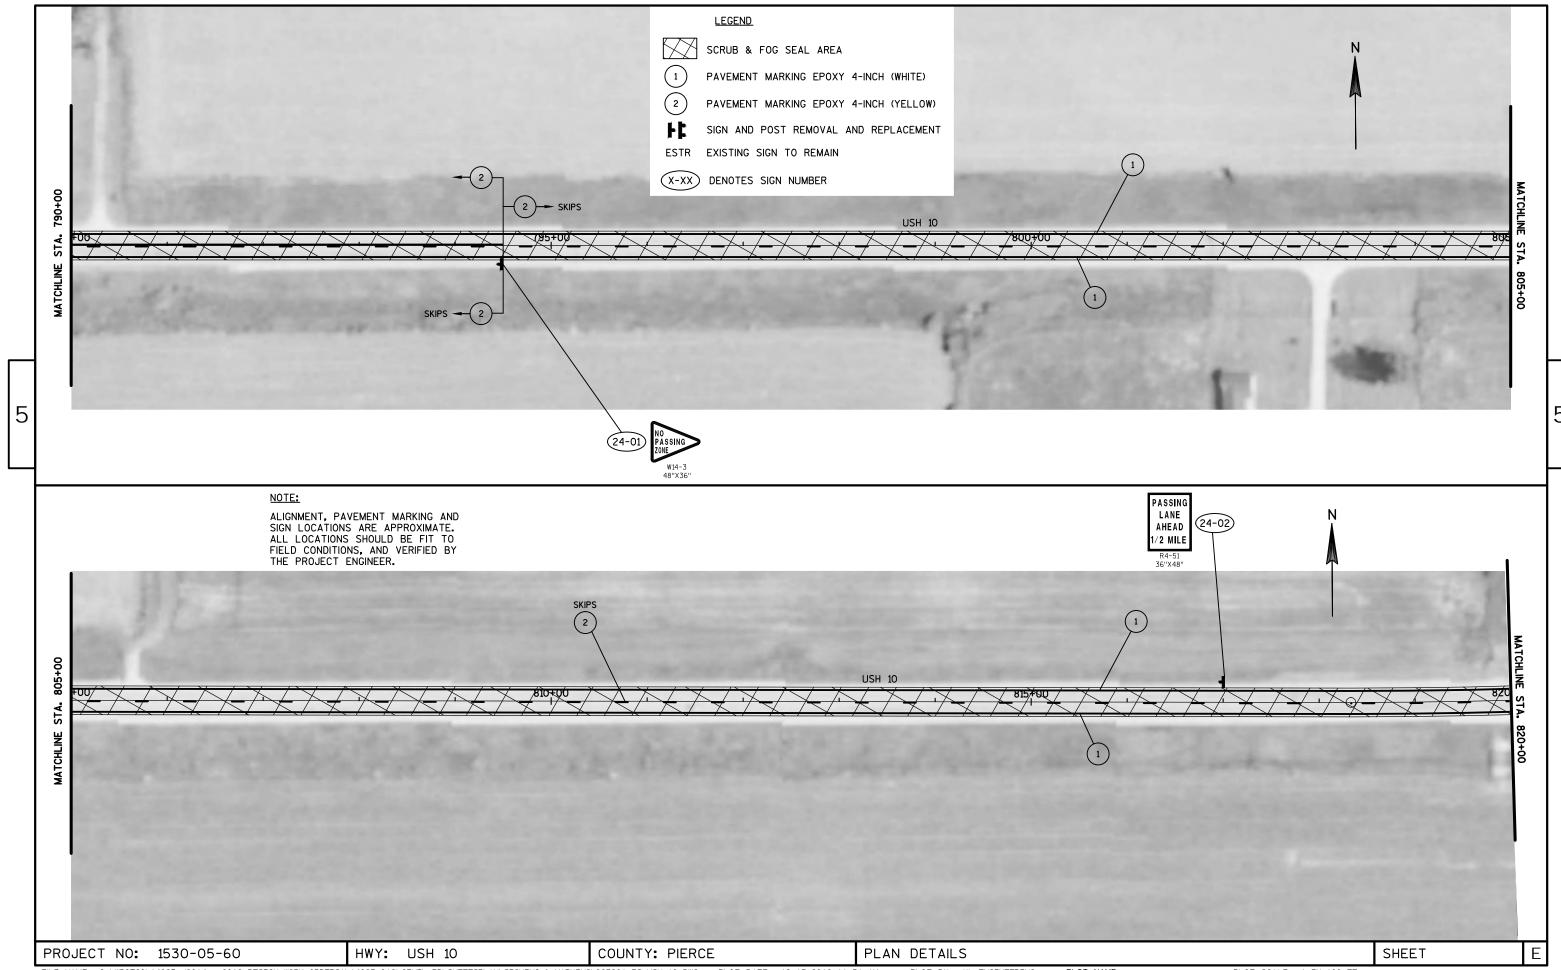


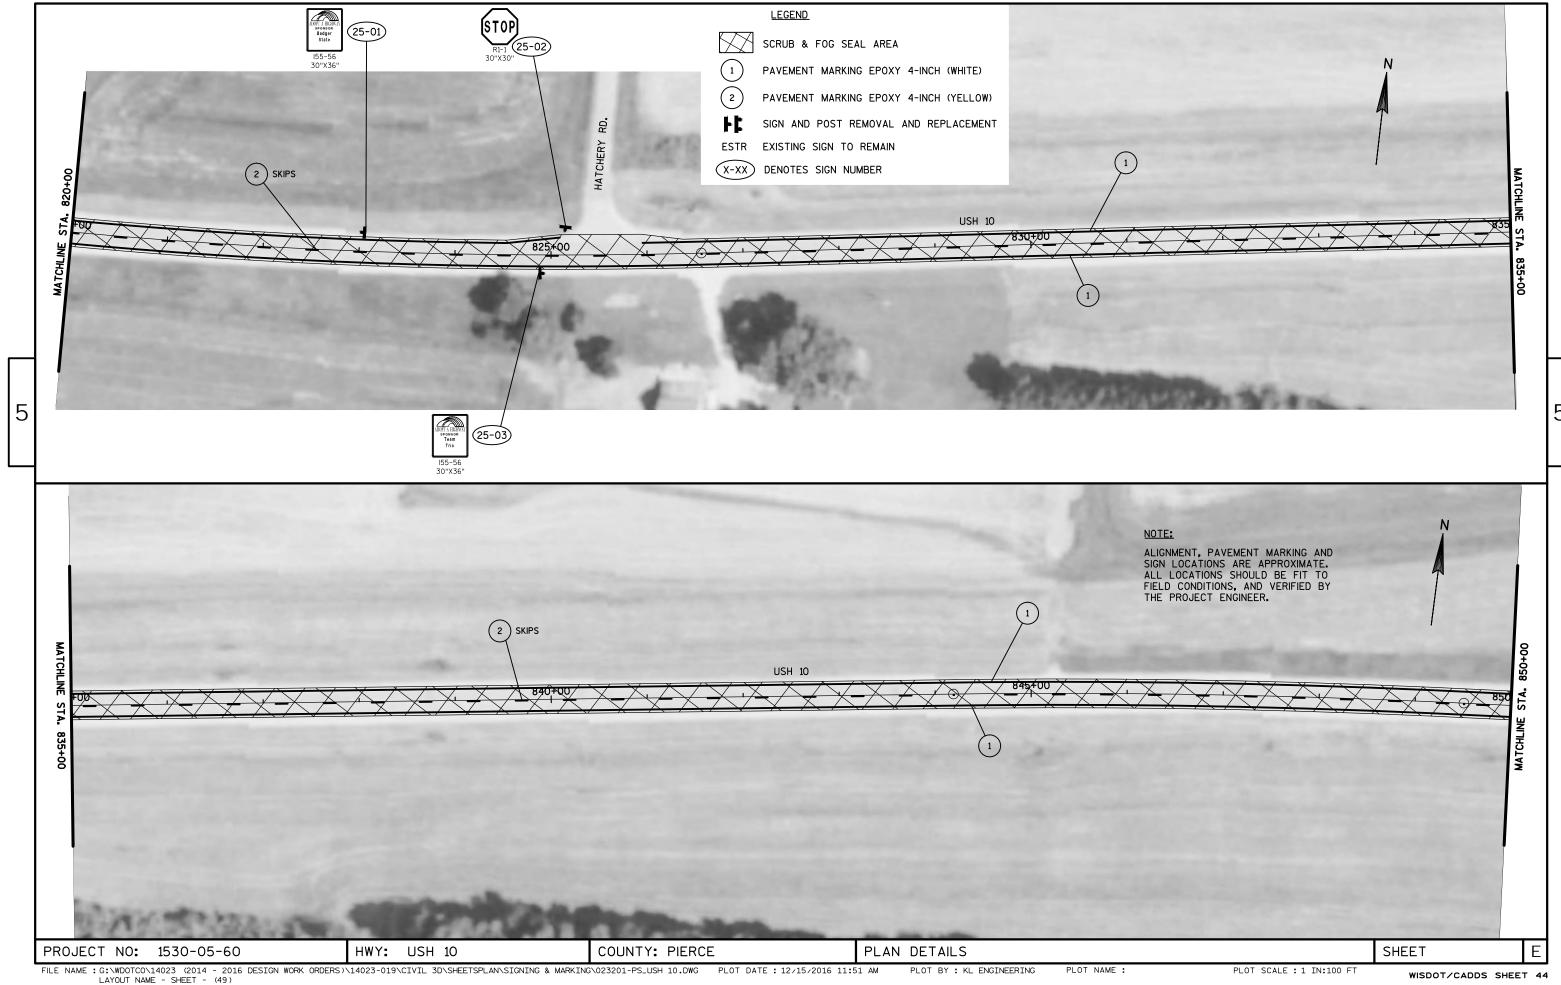


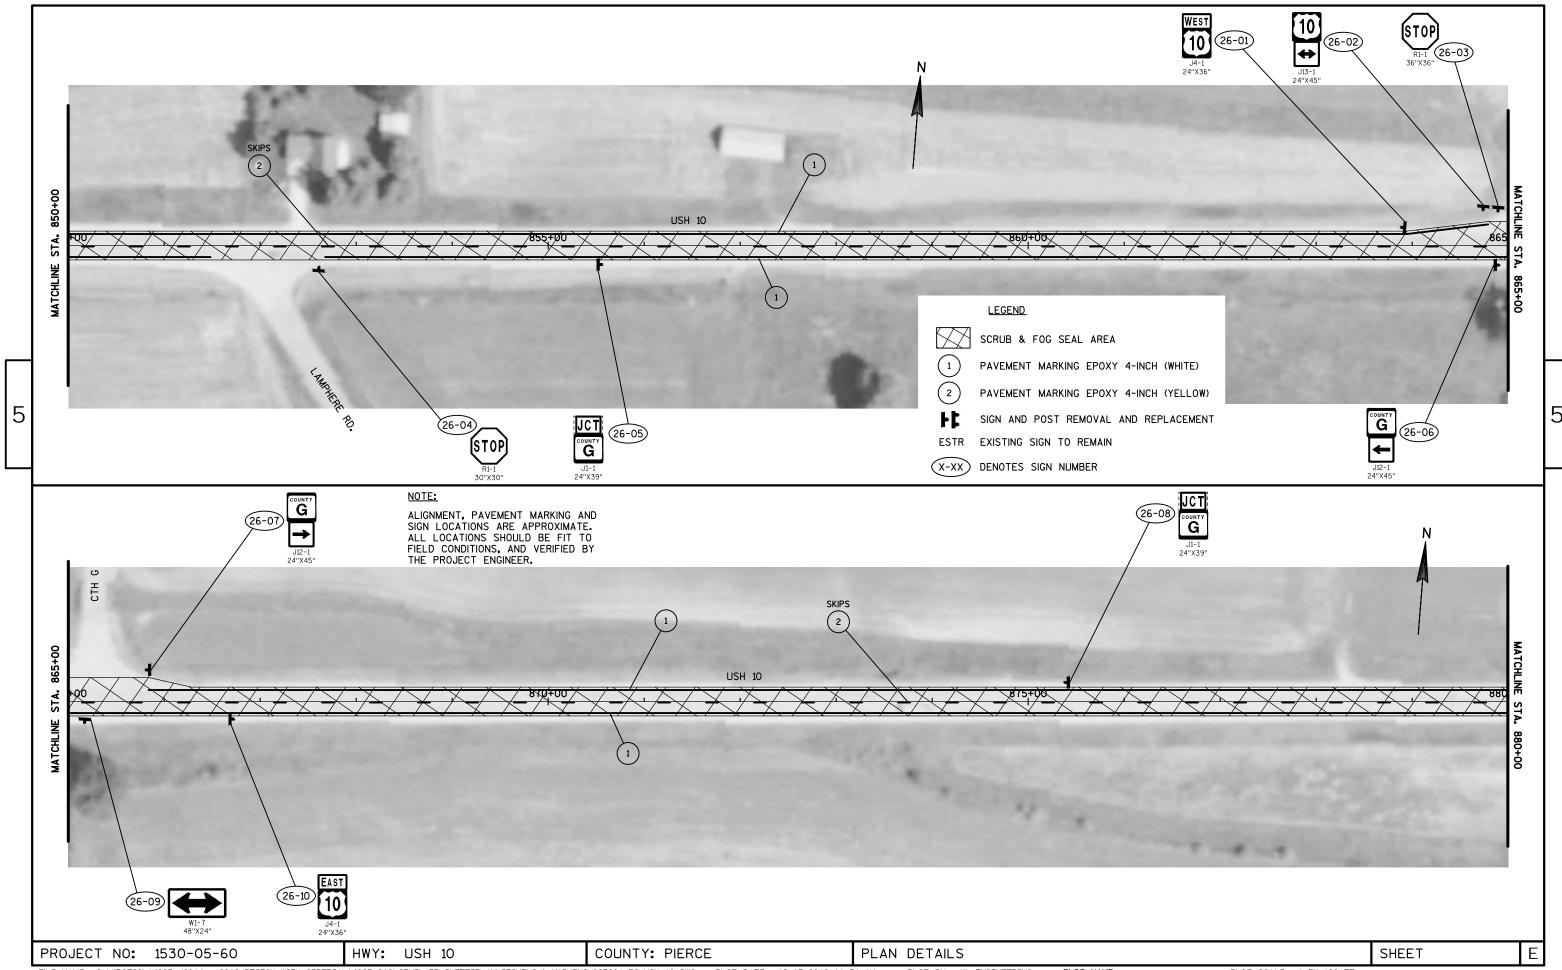


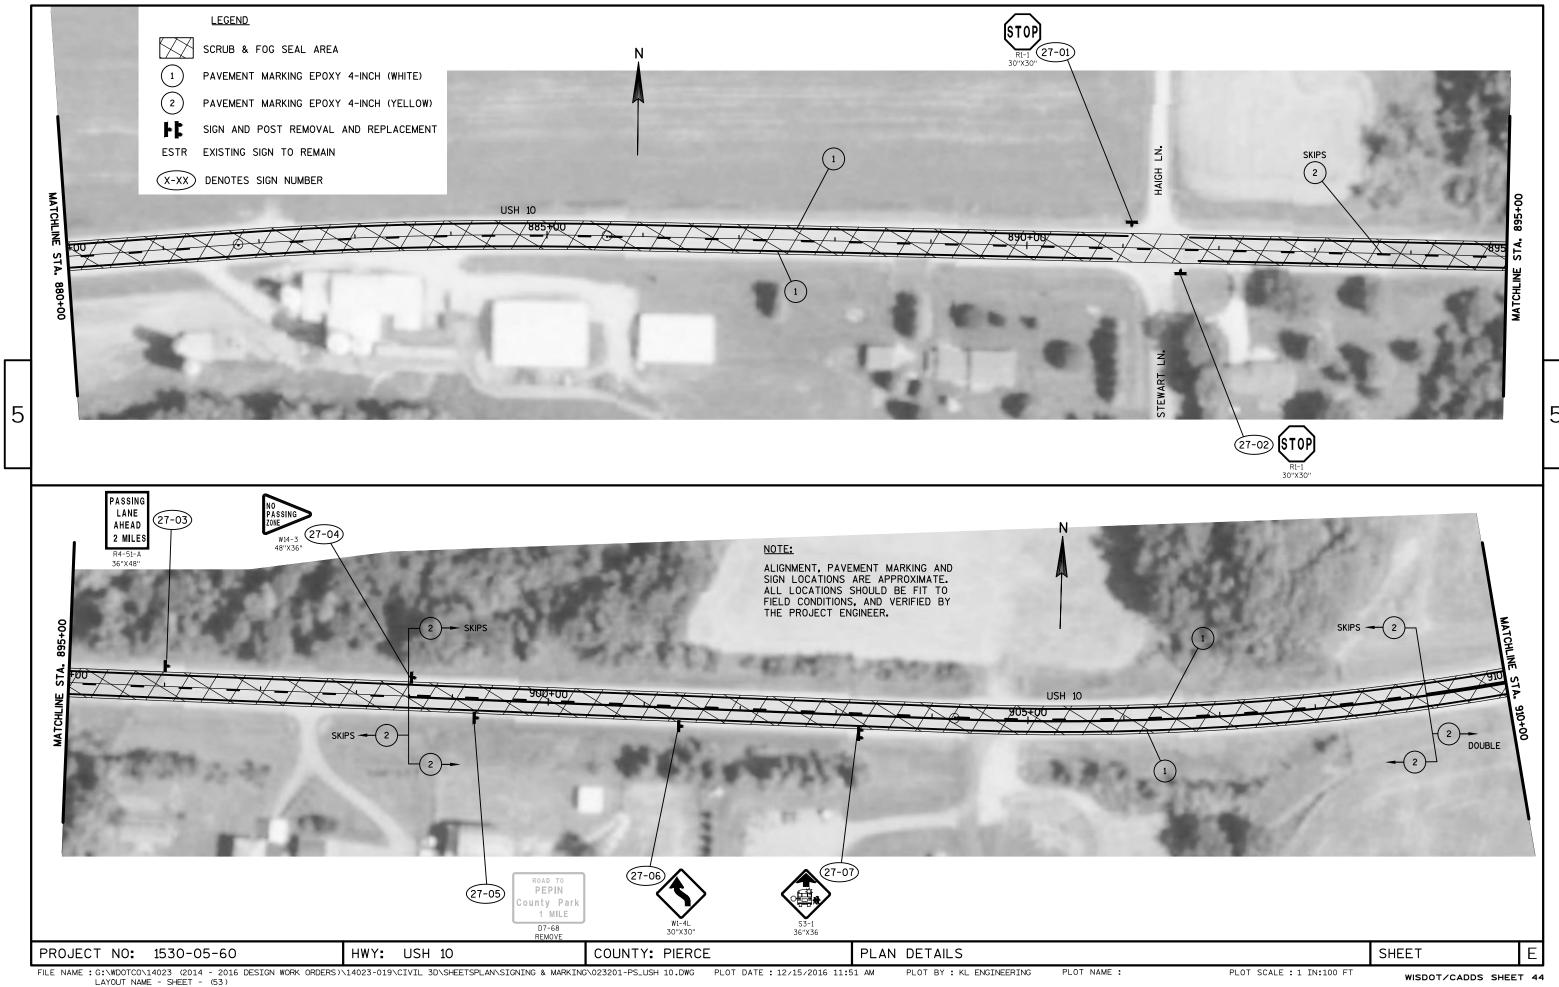


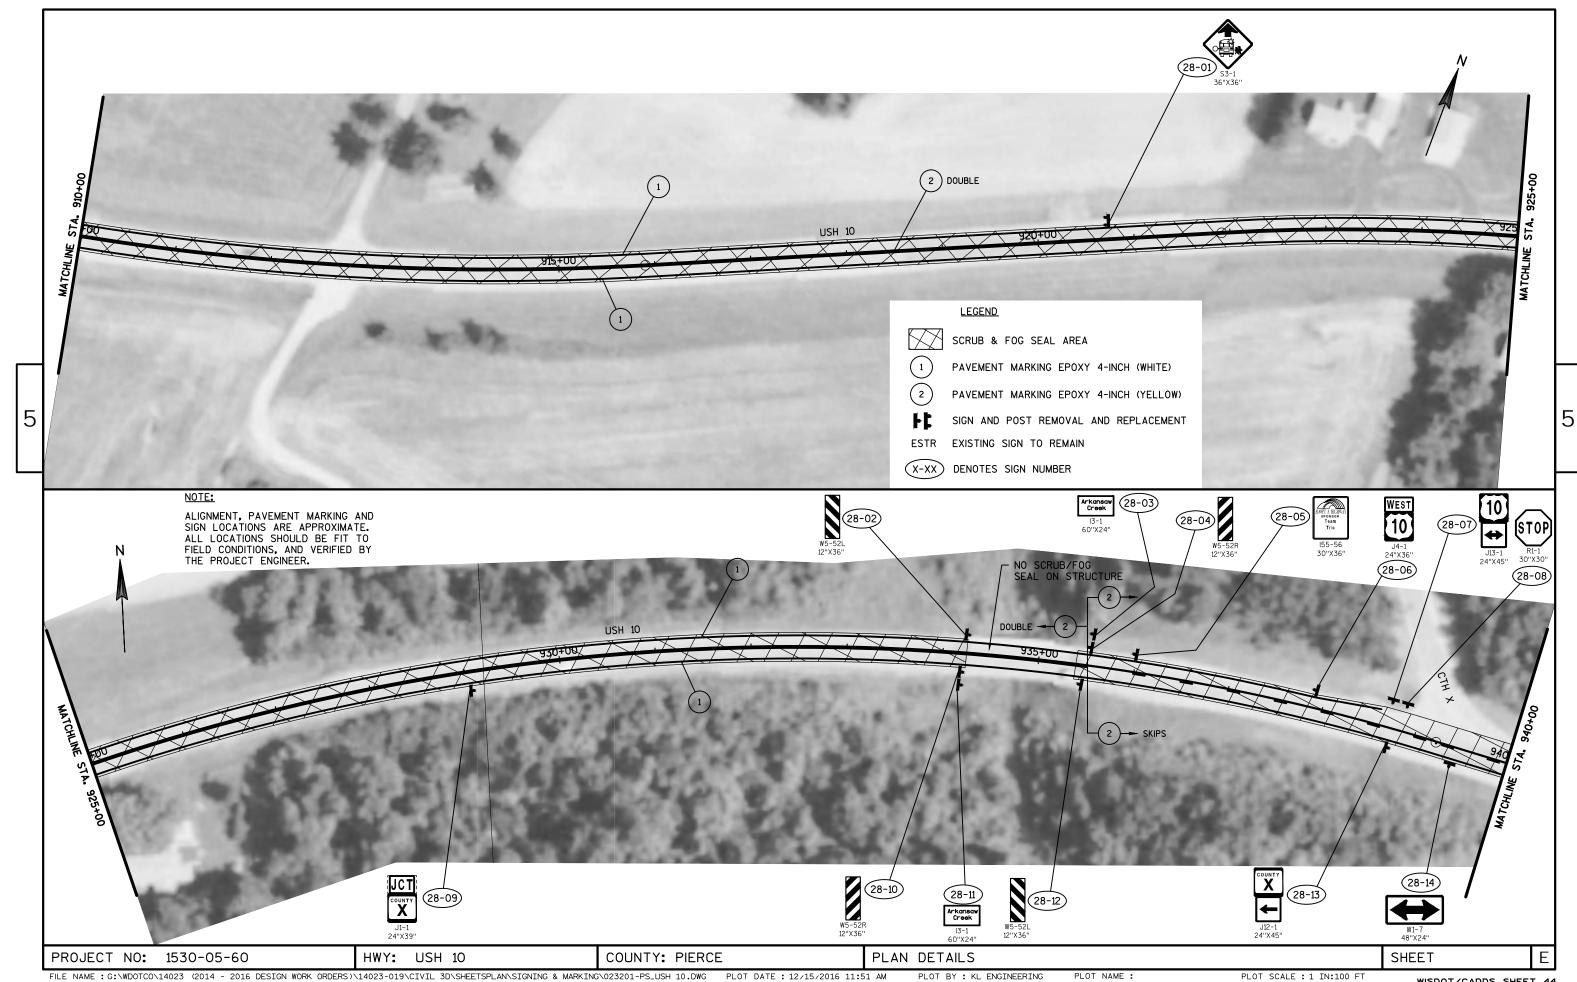


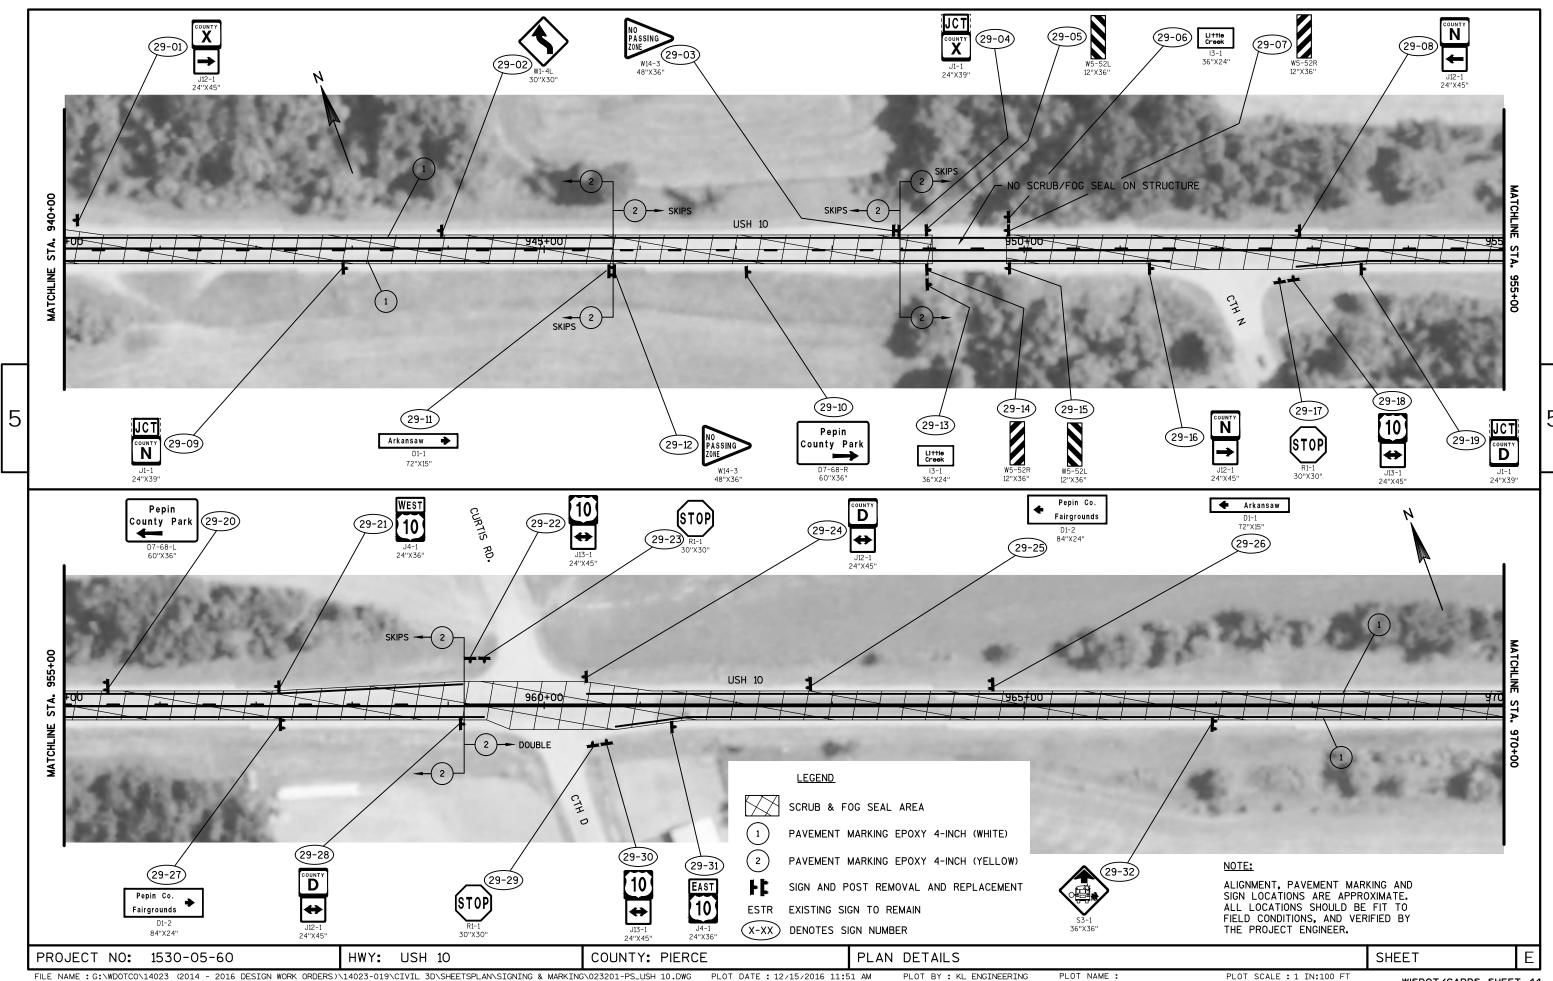


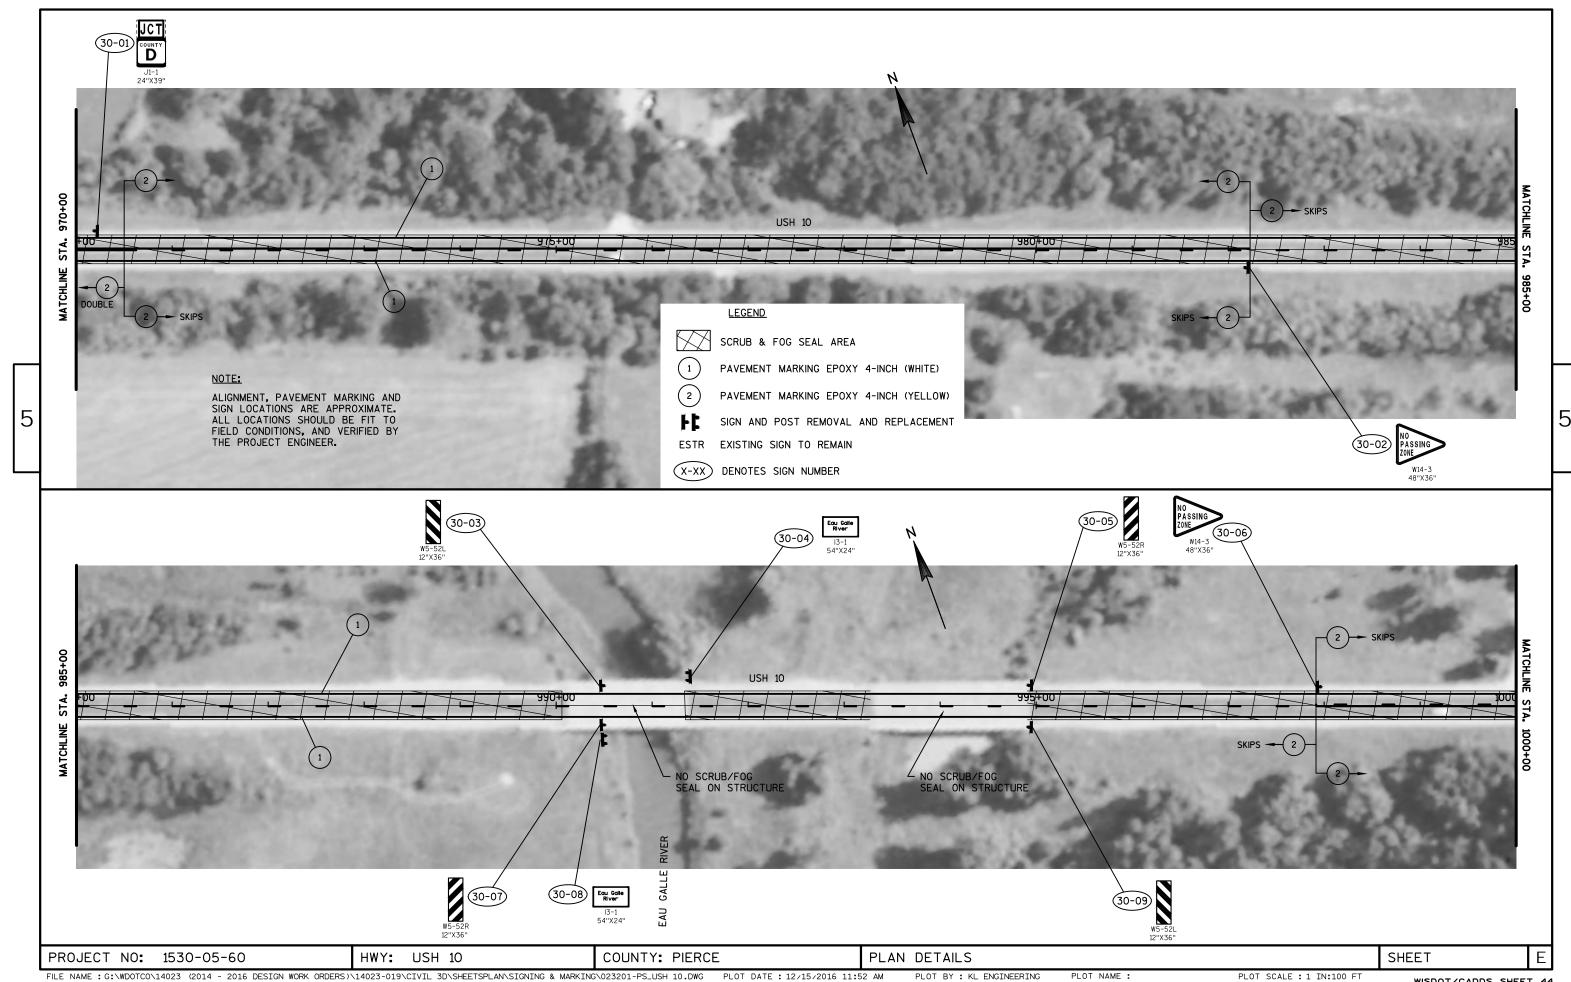

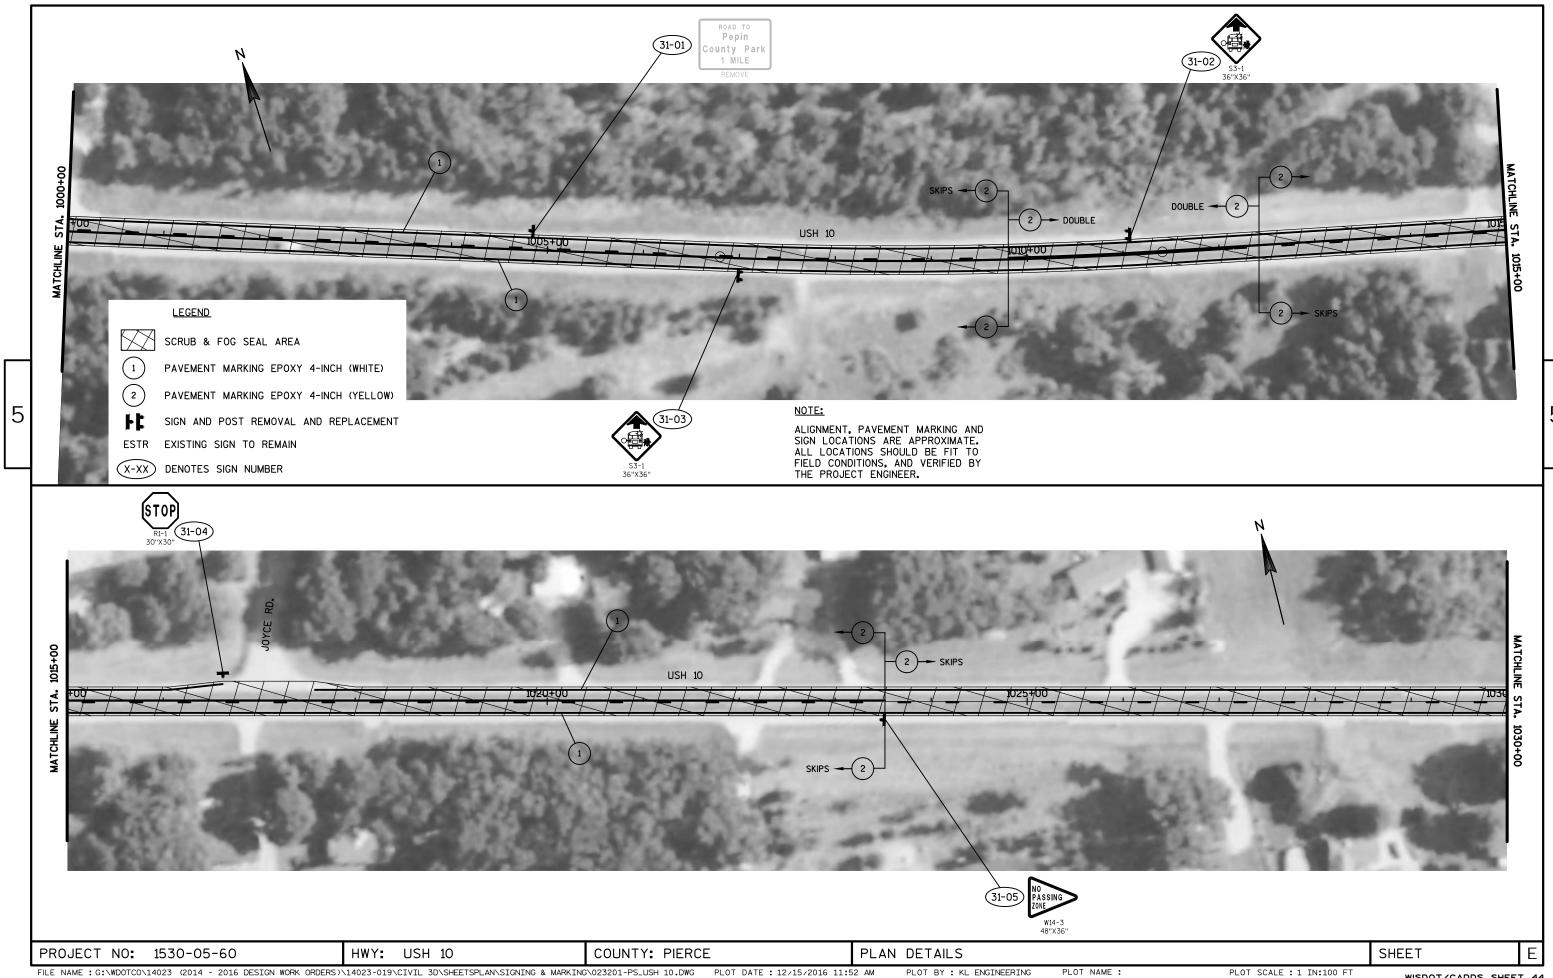


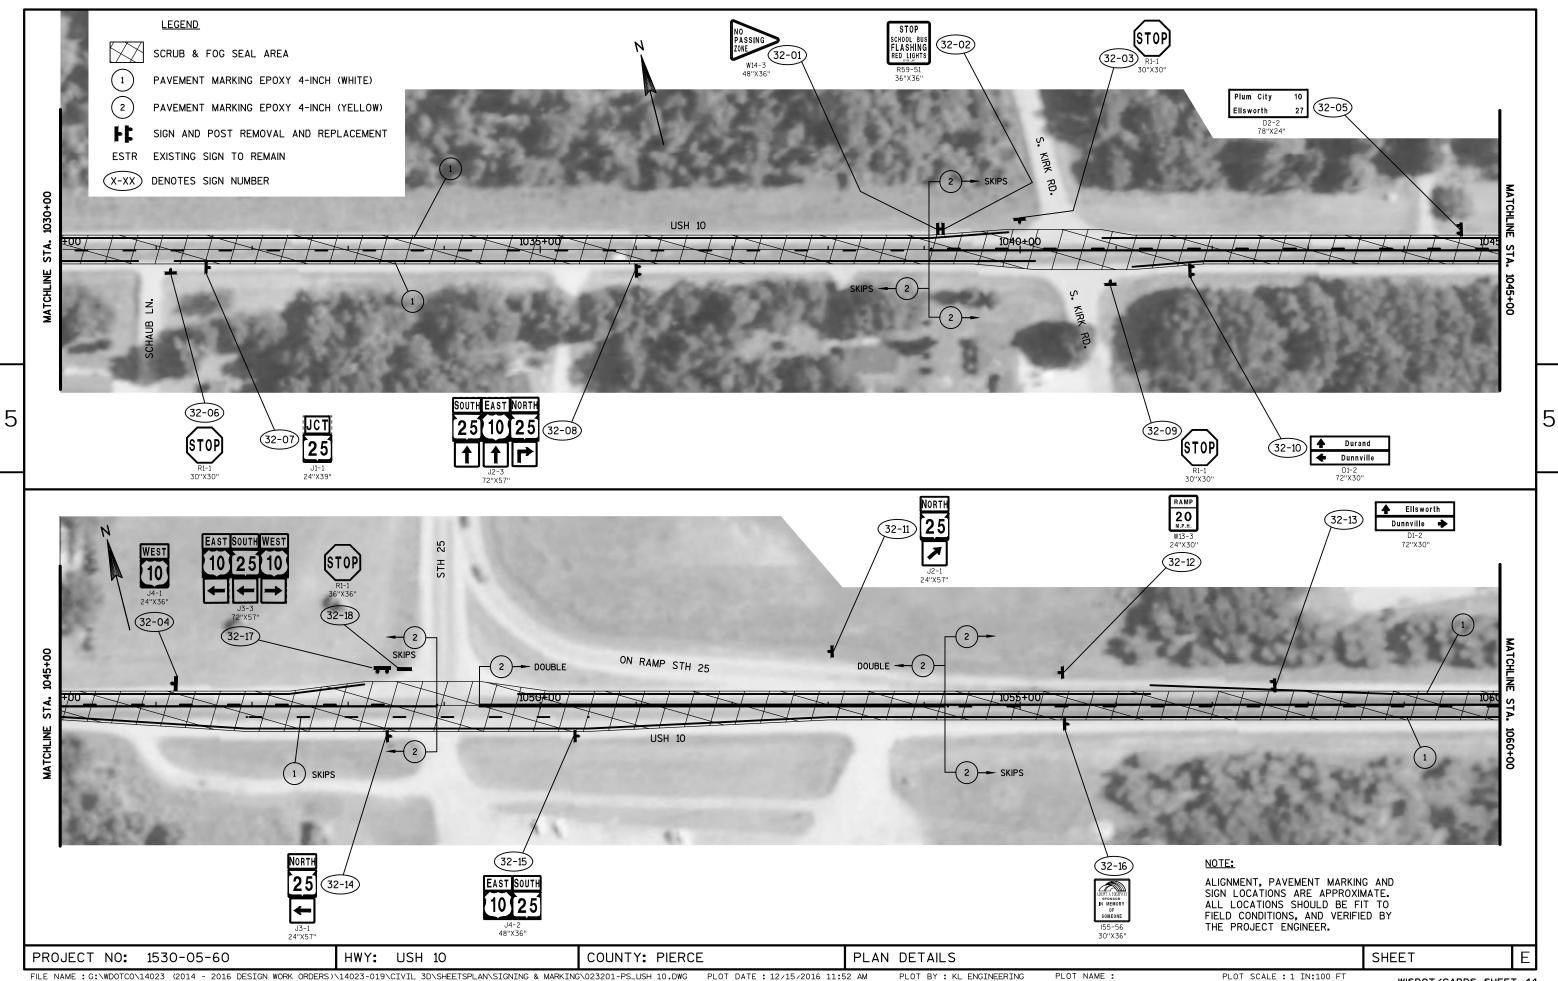


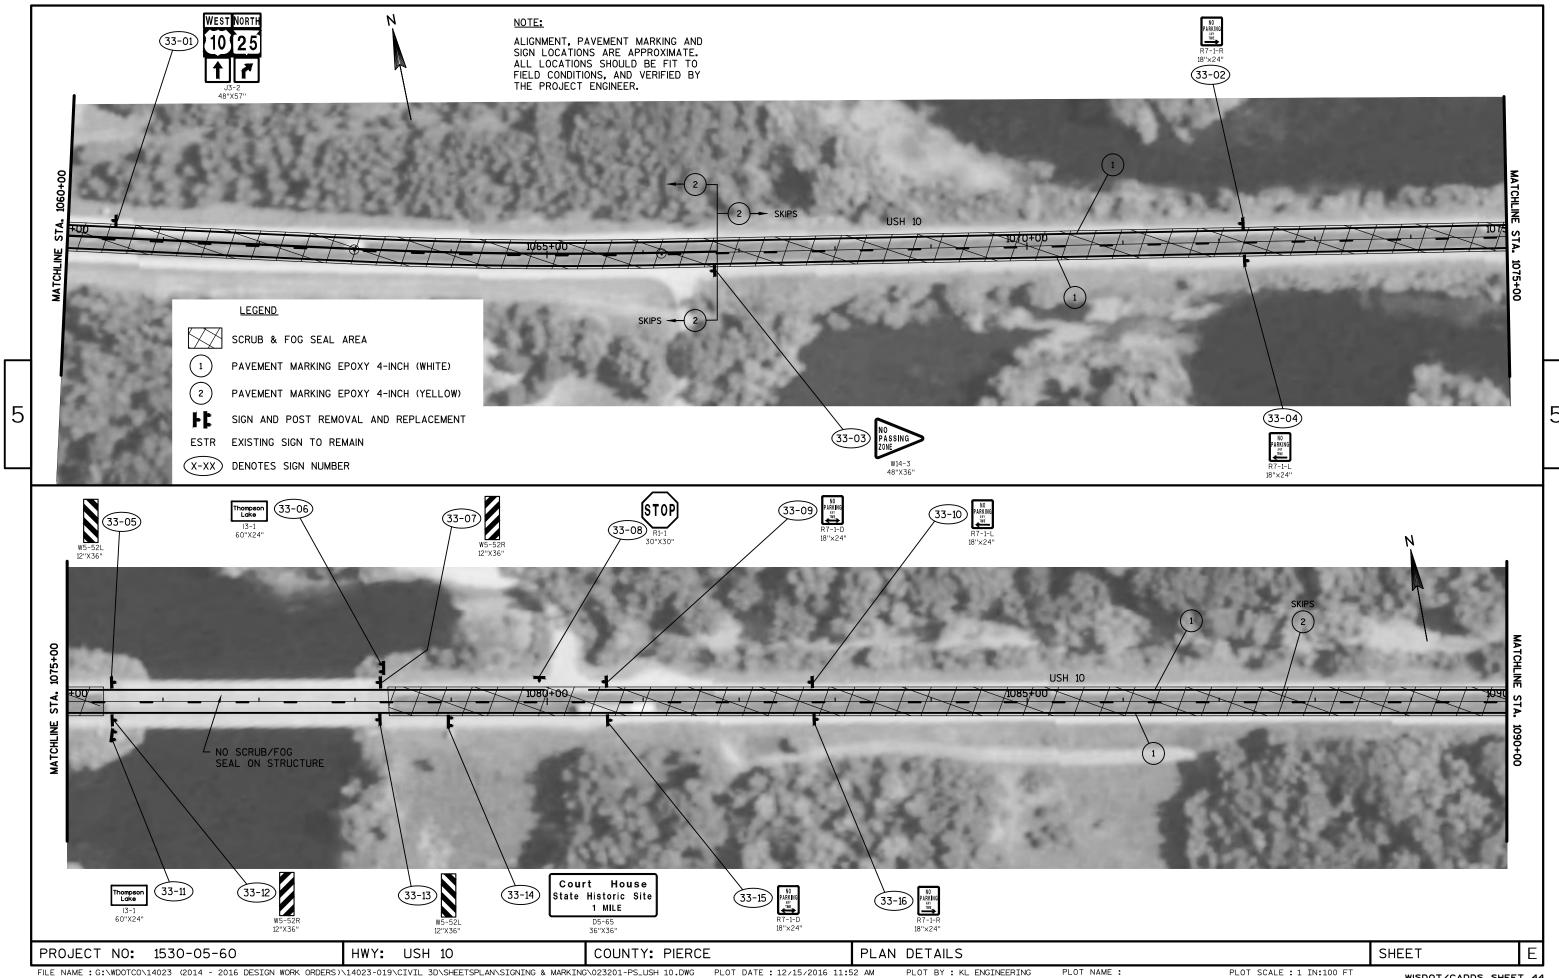


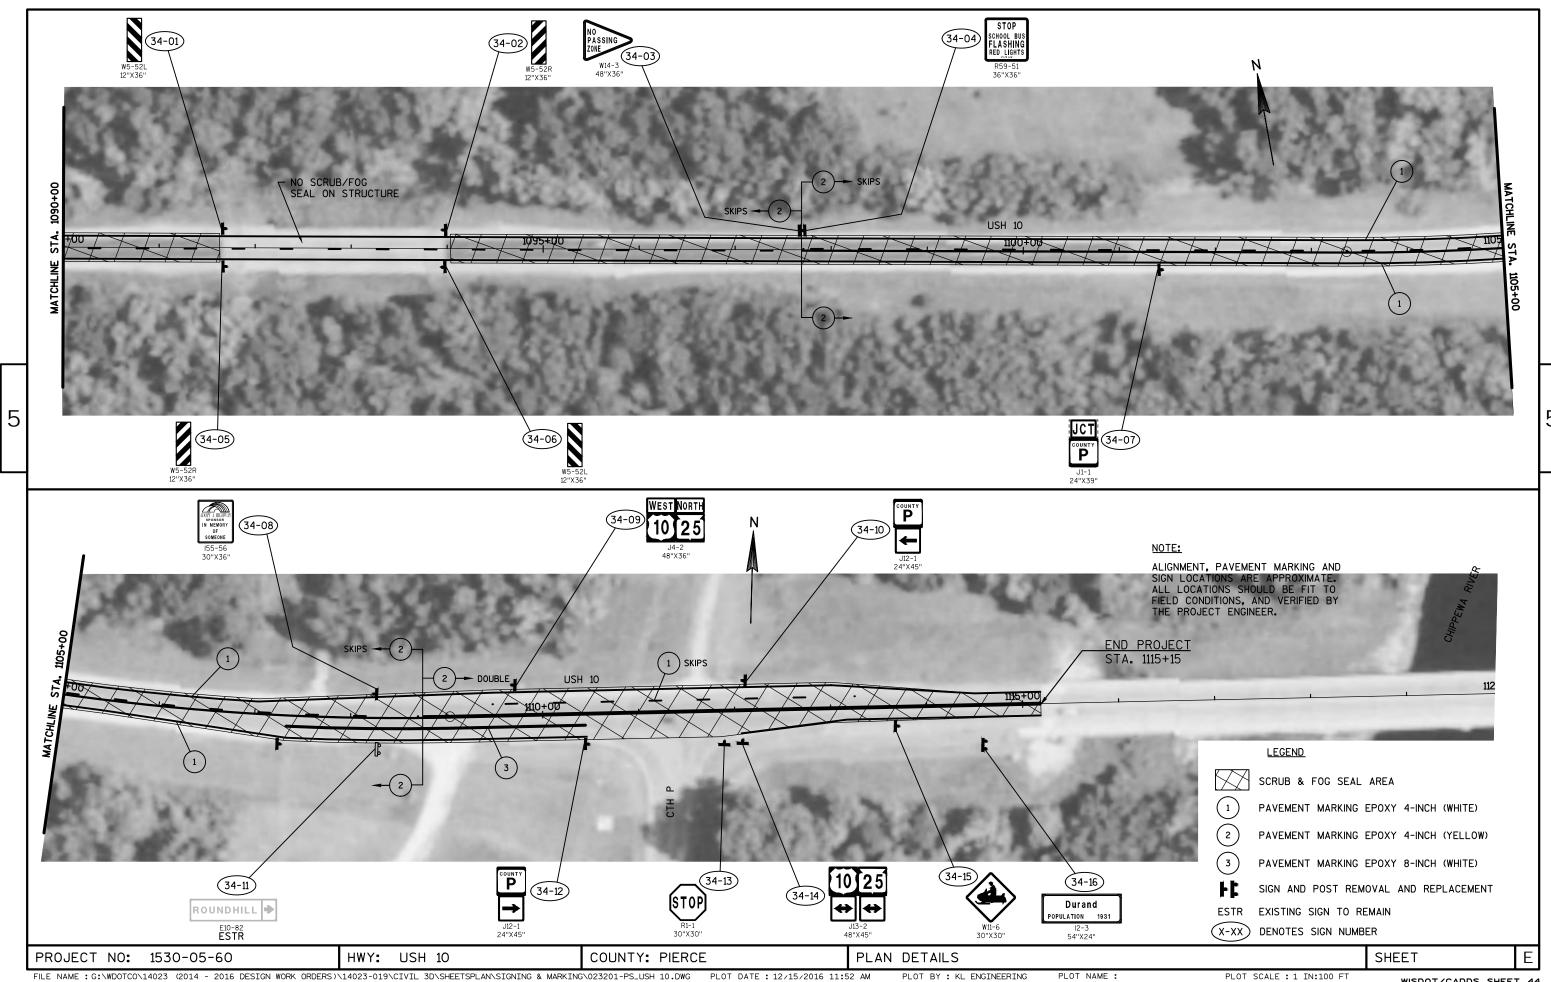





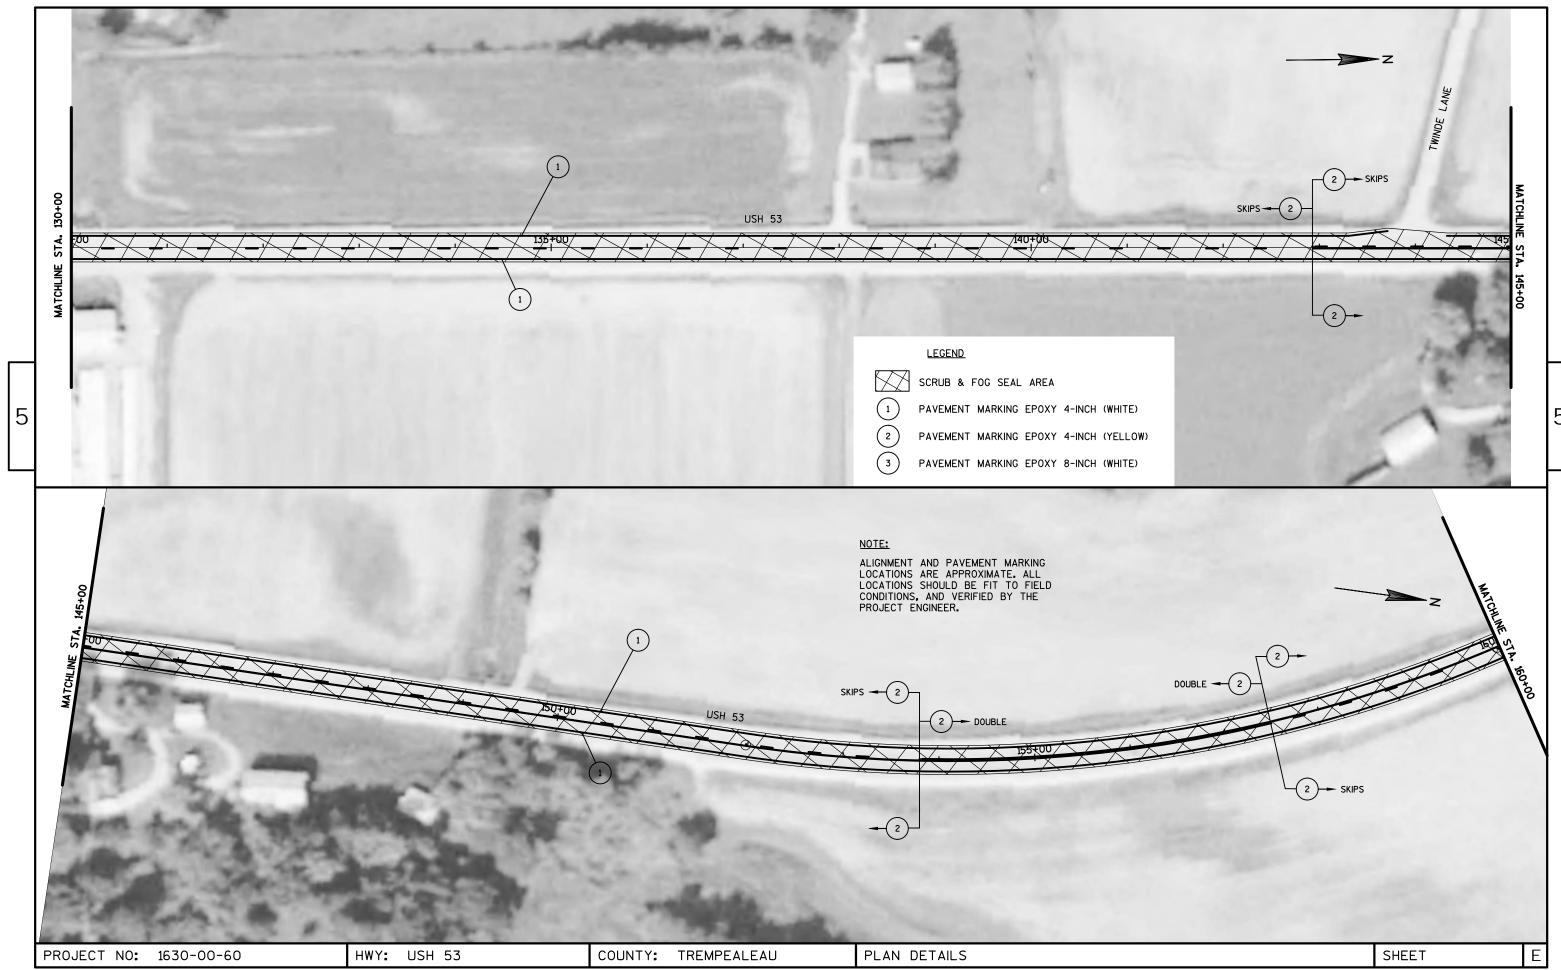

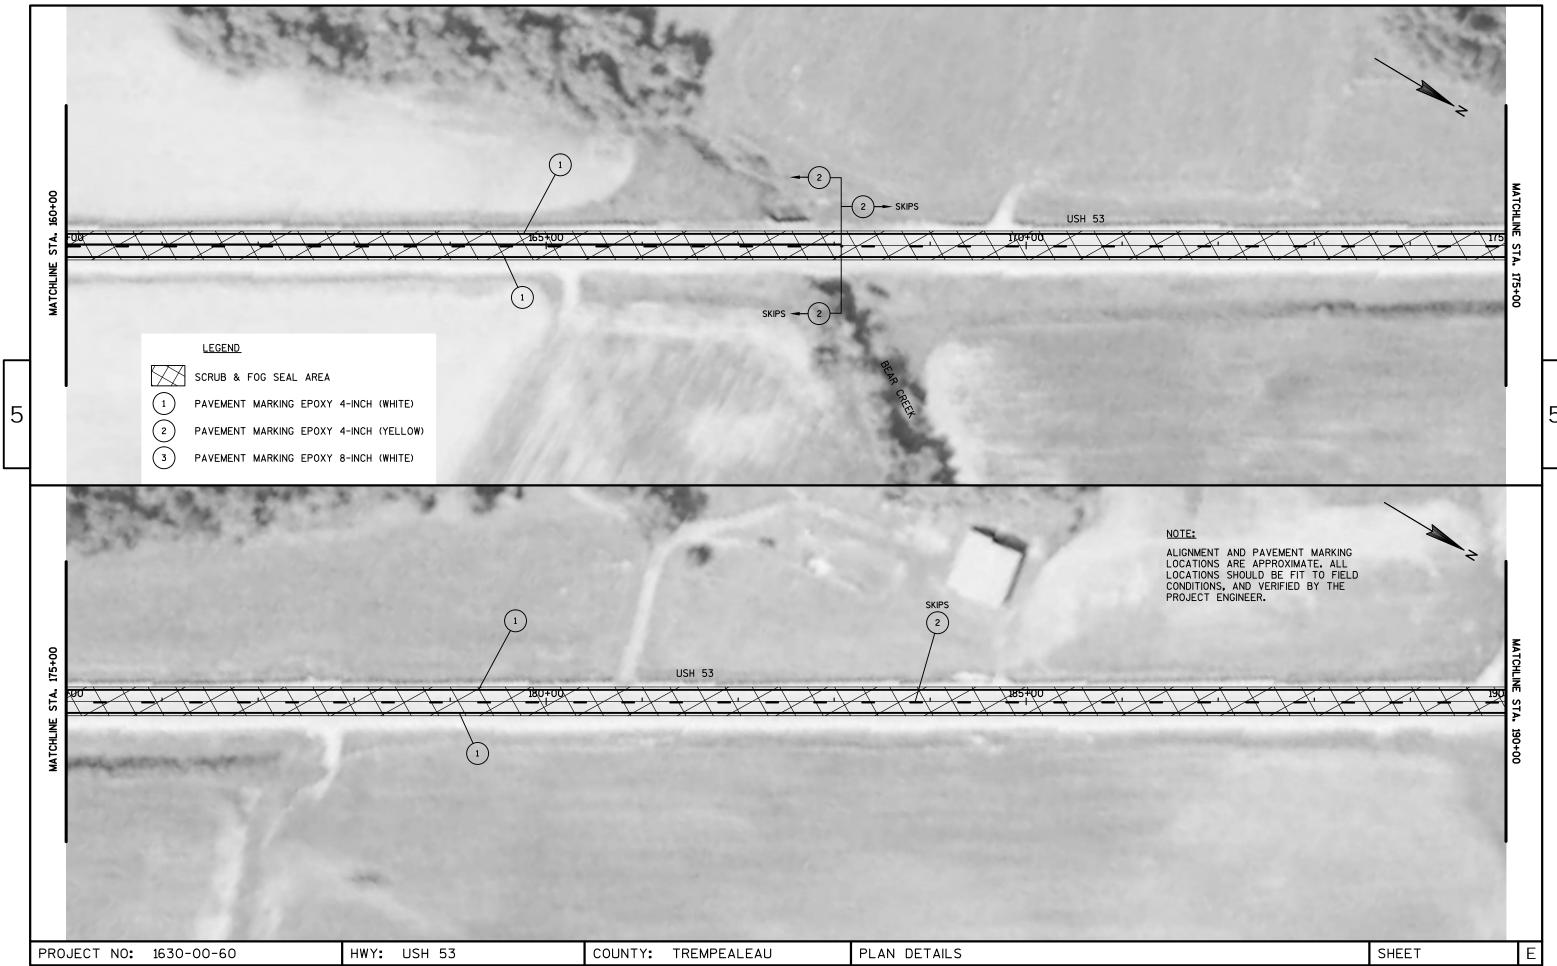

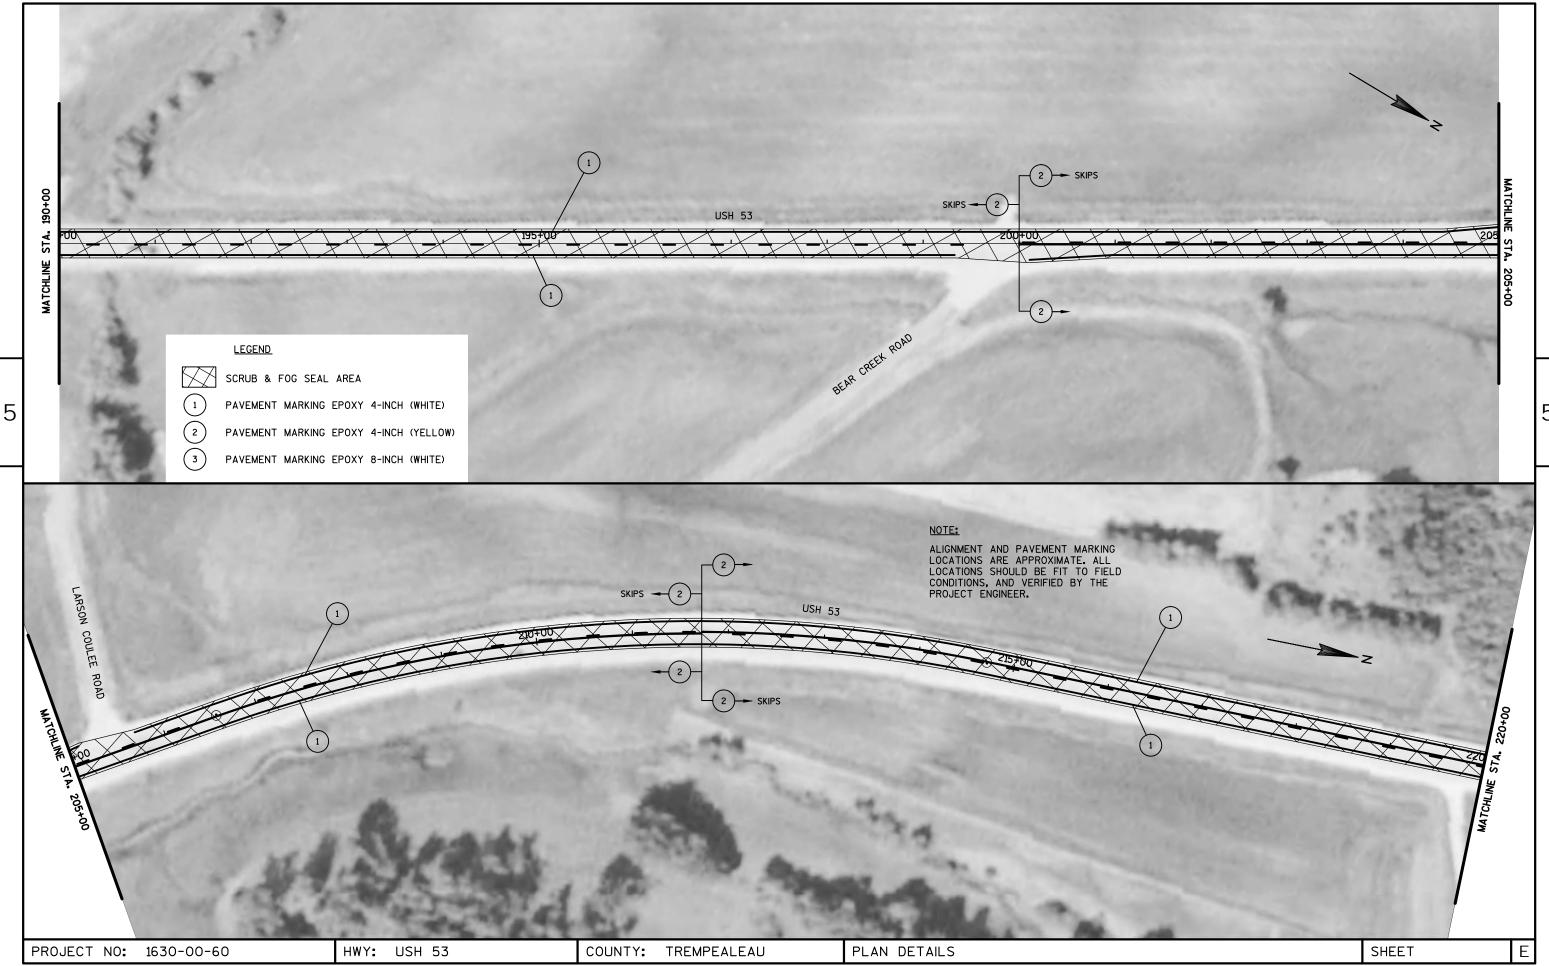


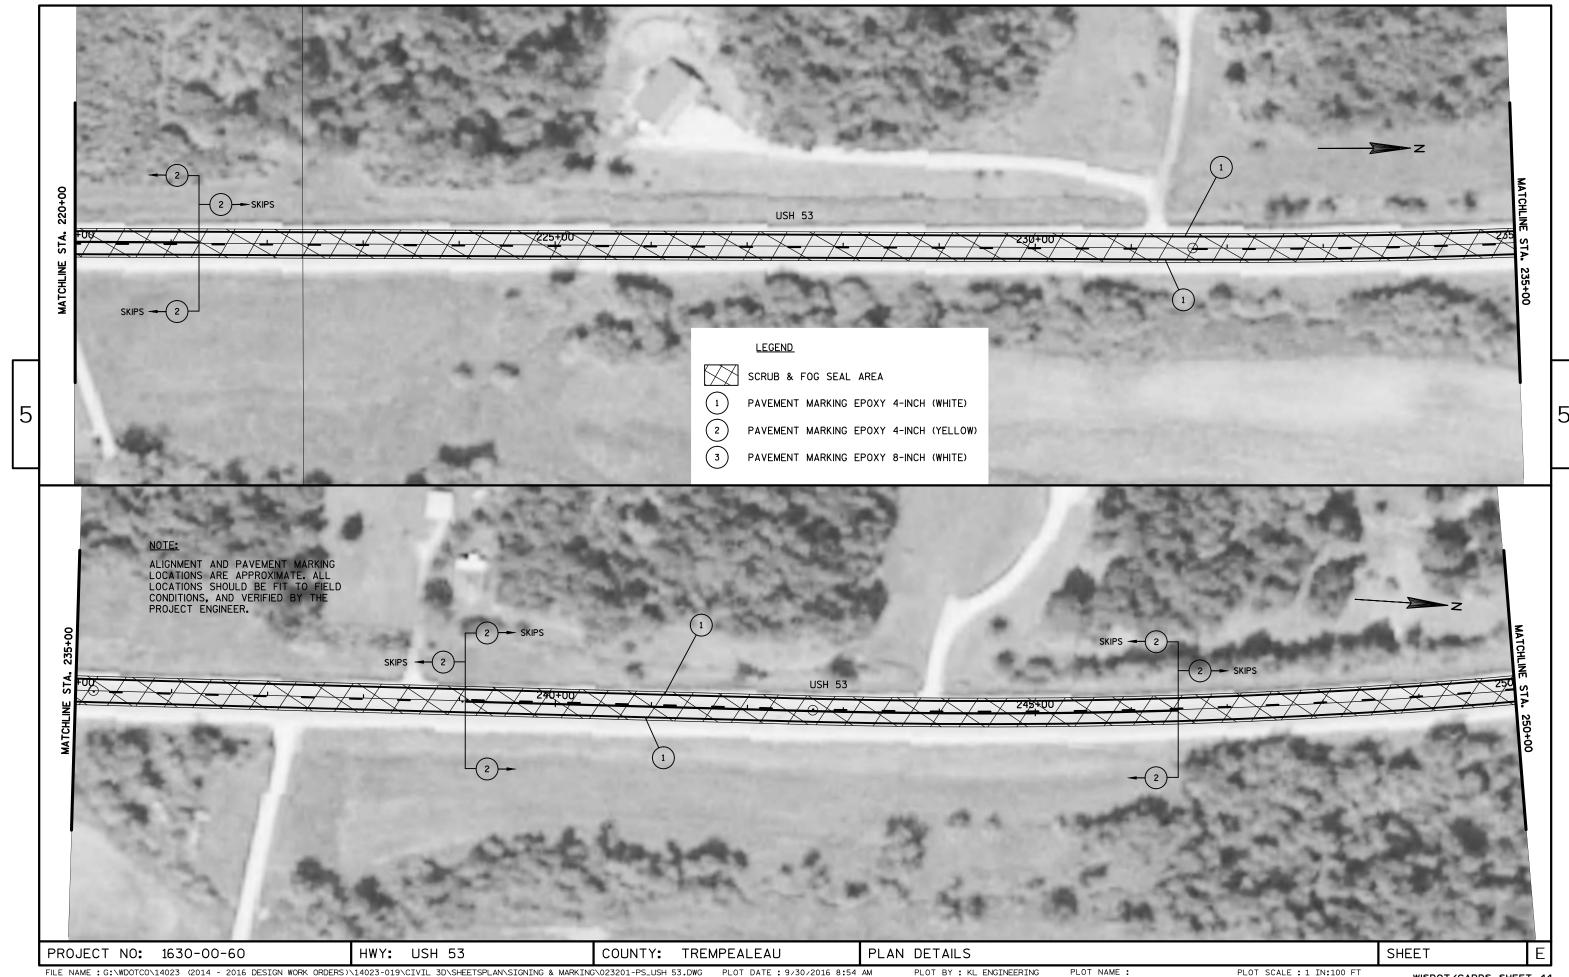


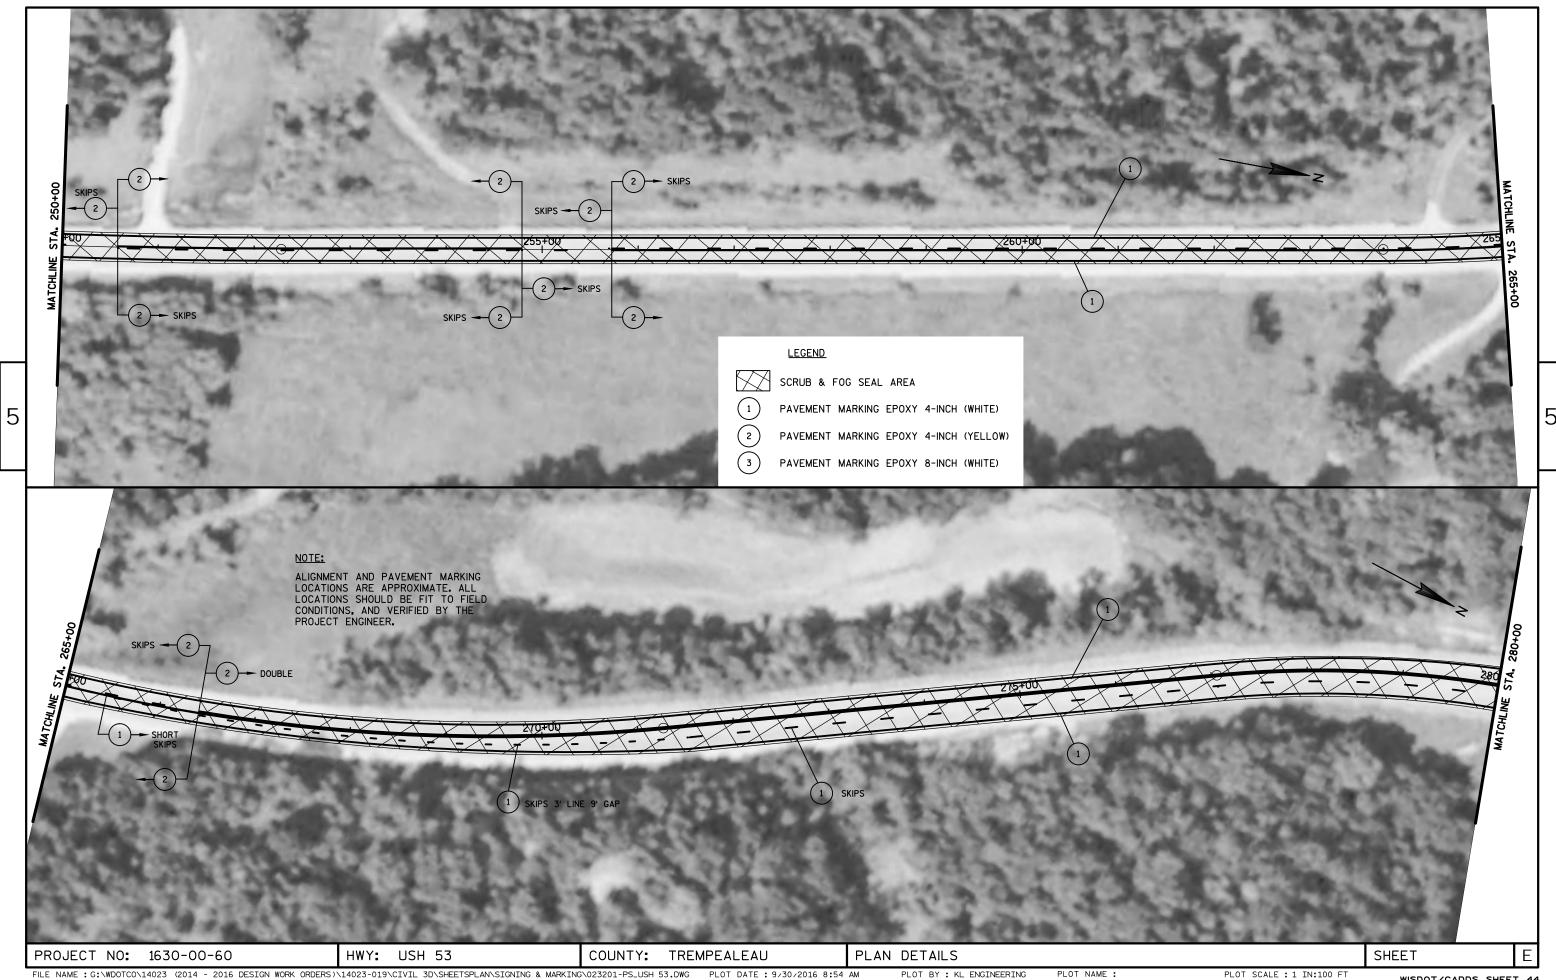


WISDOT/CADDS SHEET 44


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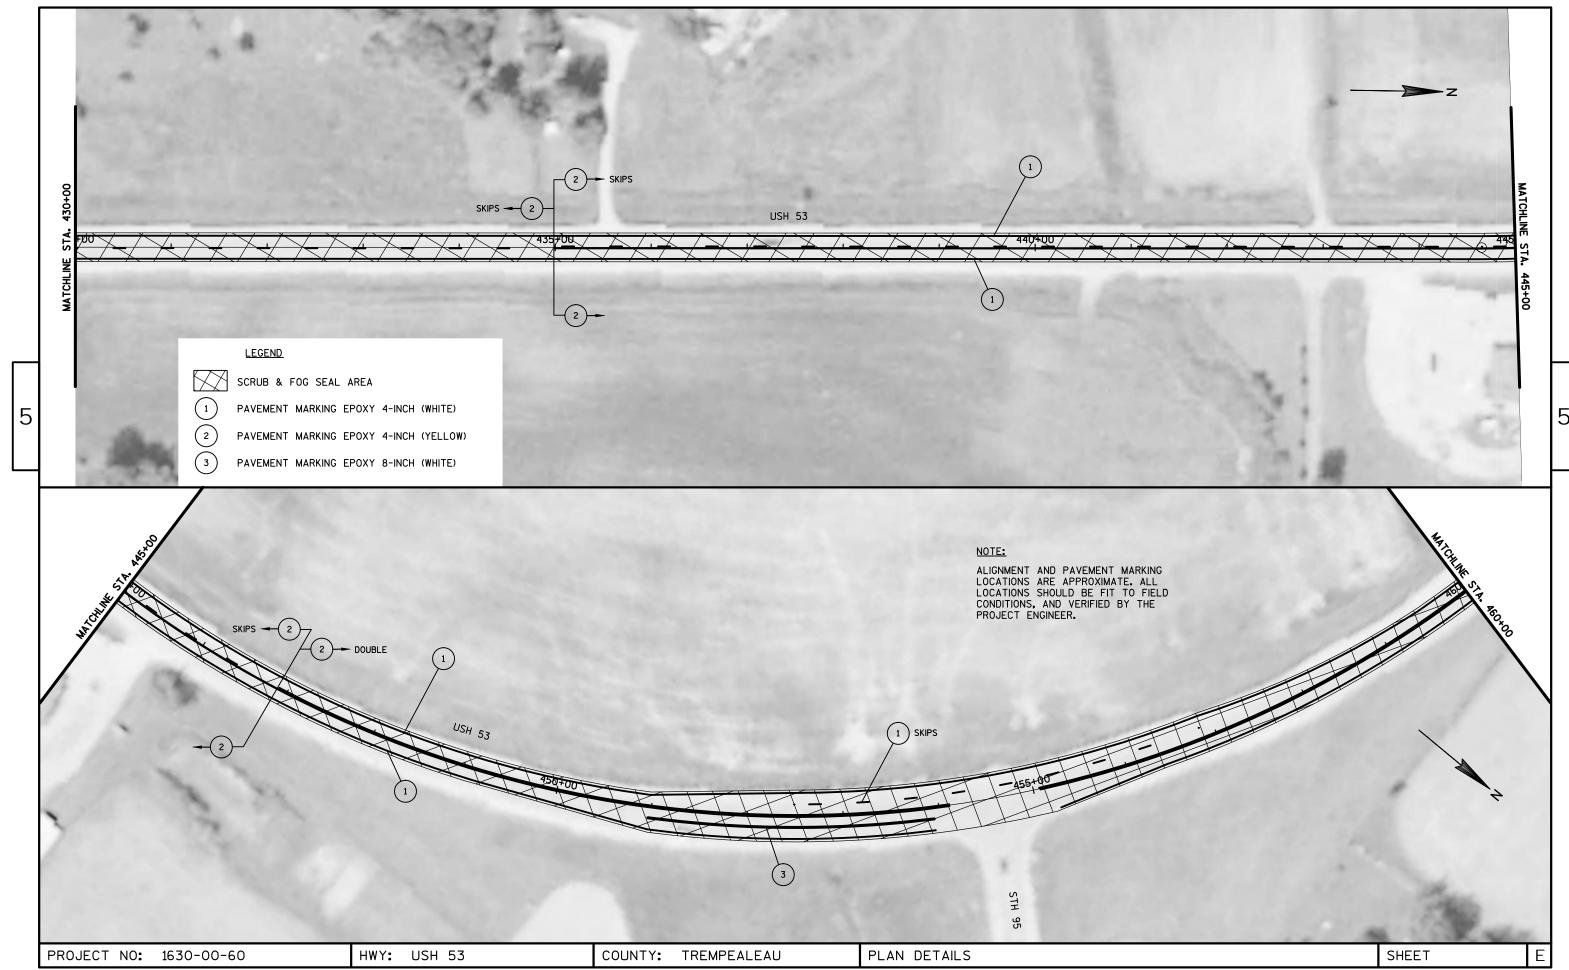


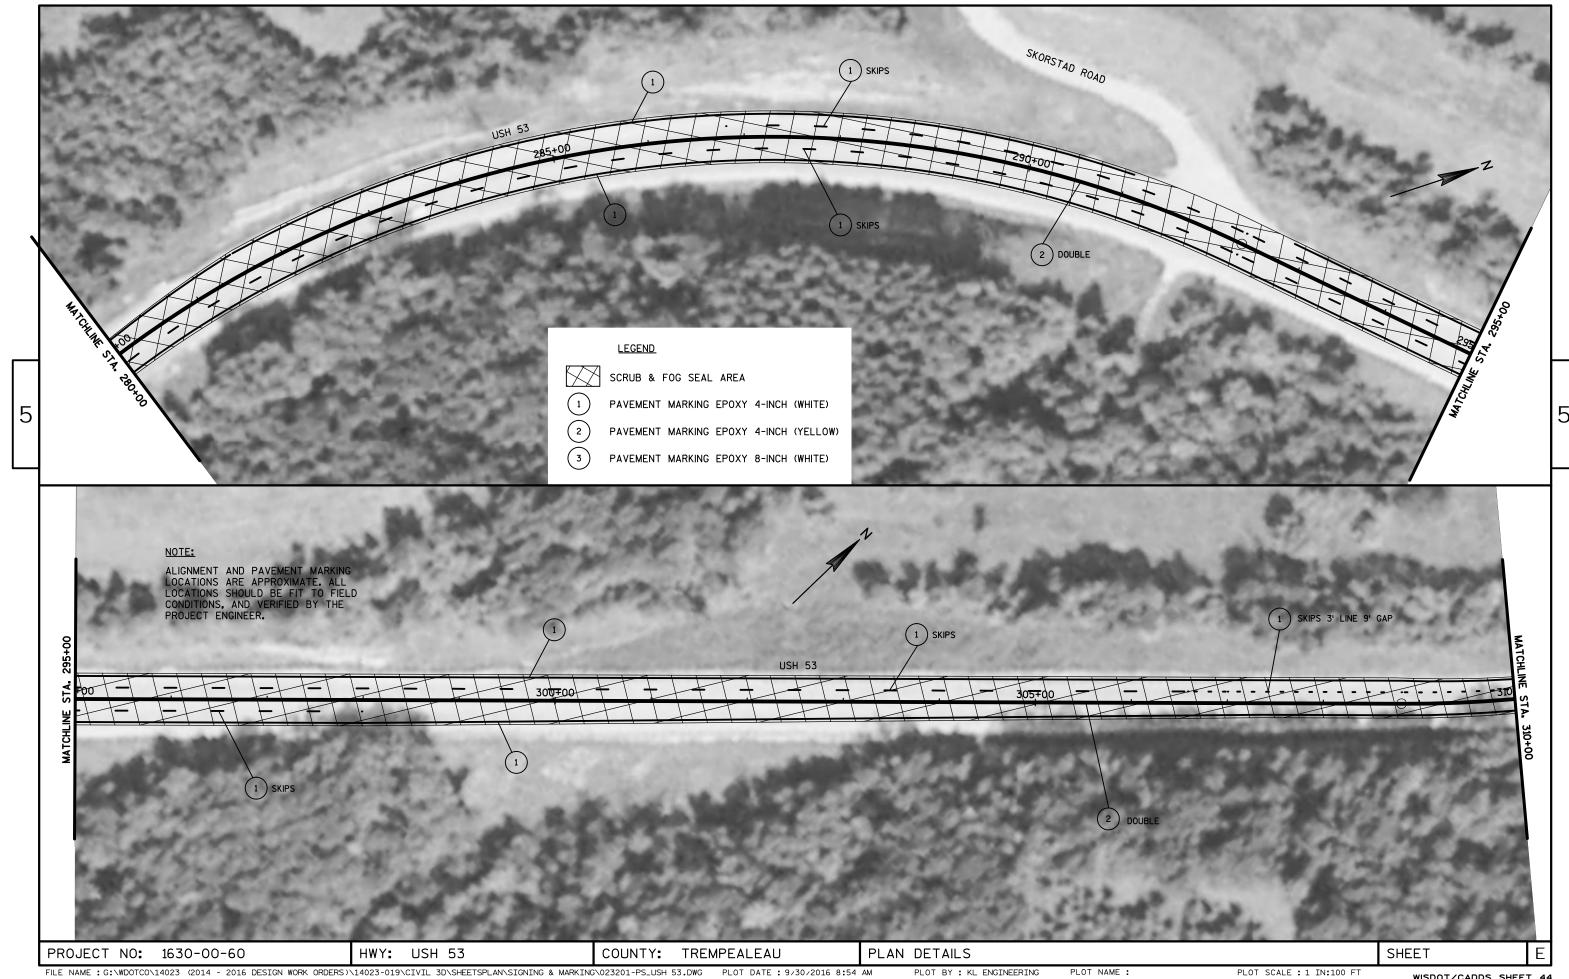


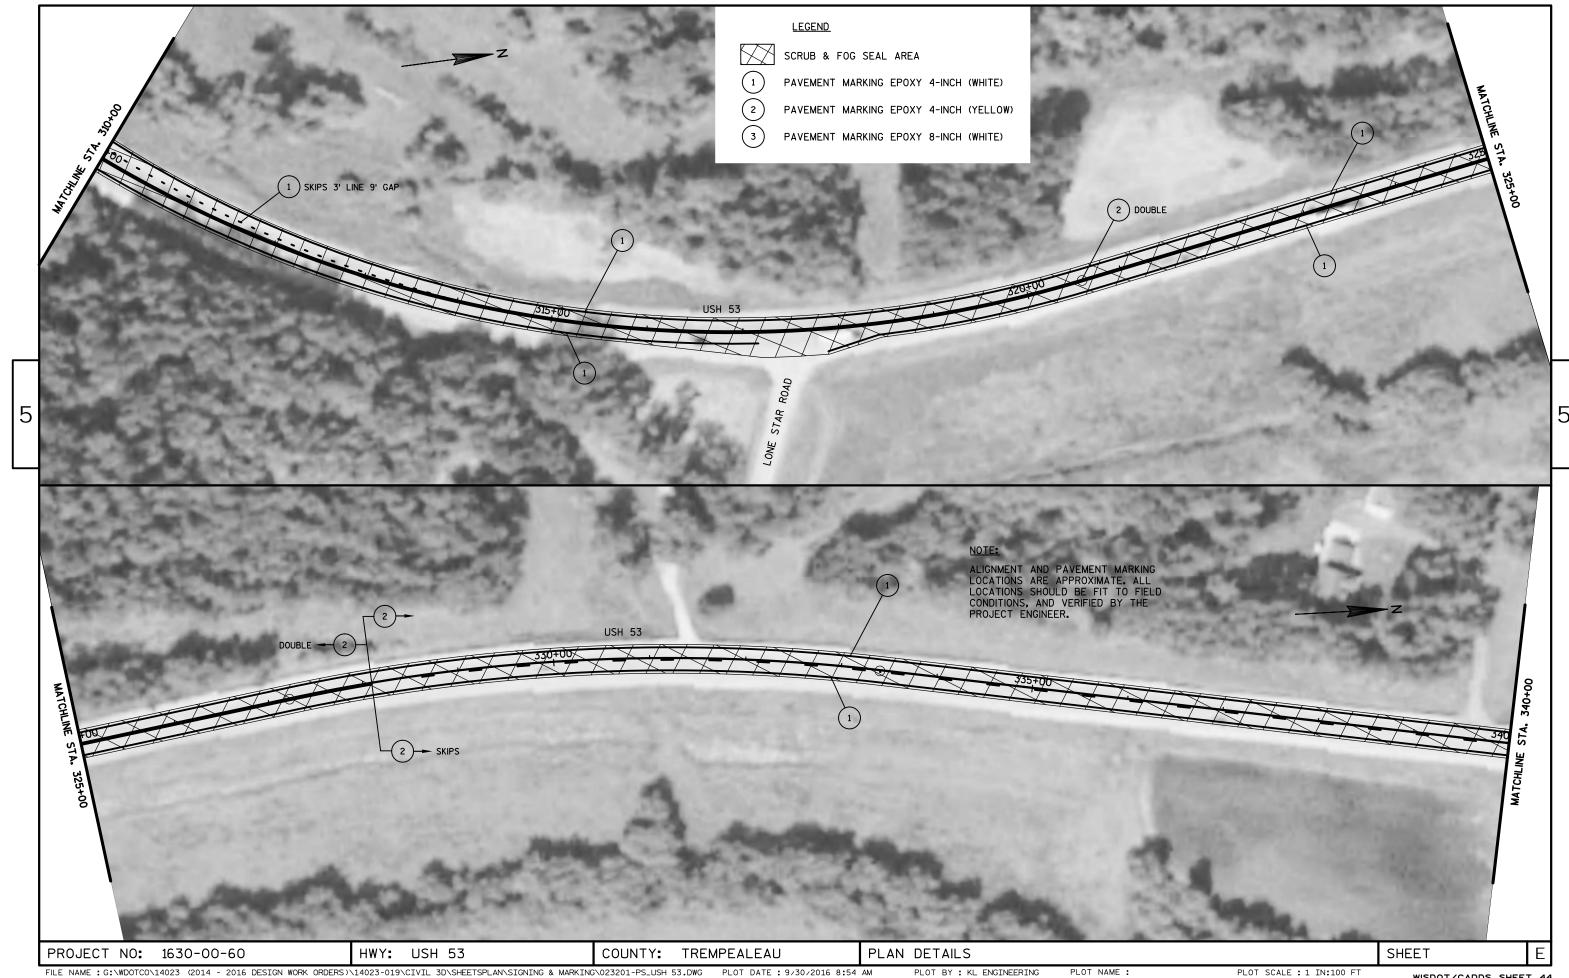


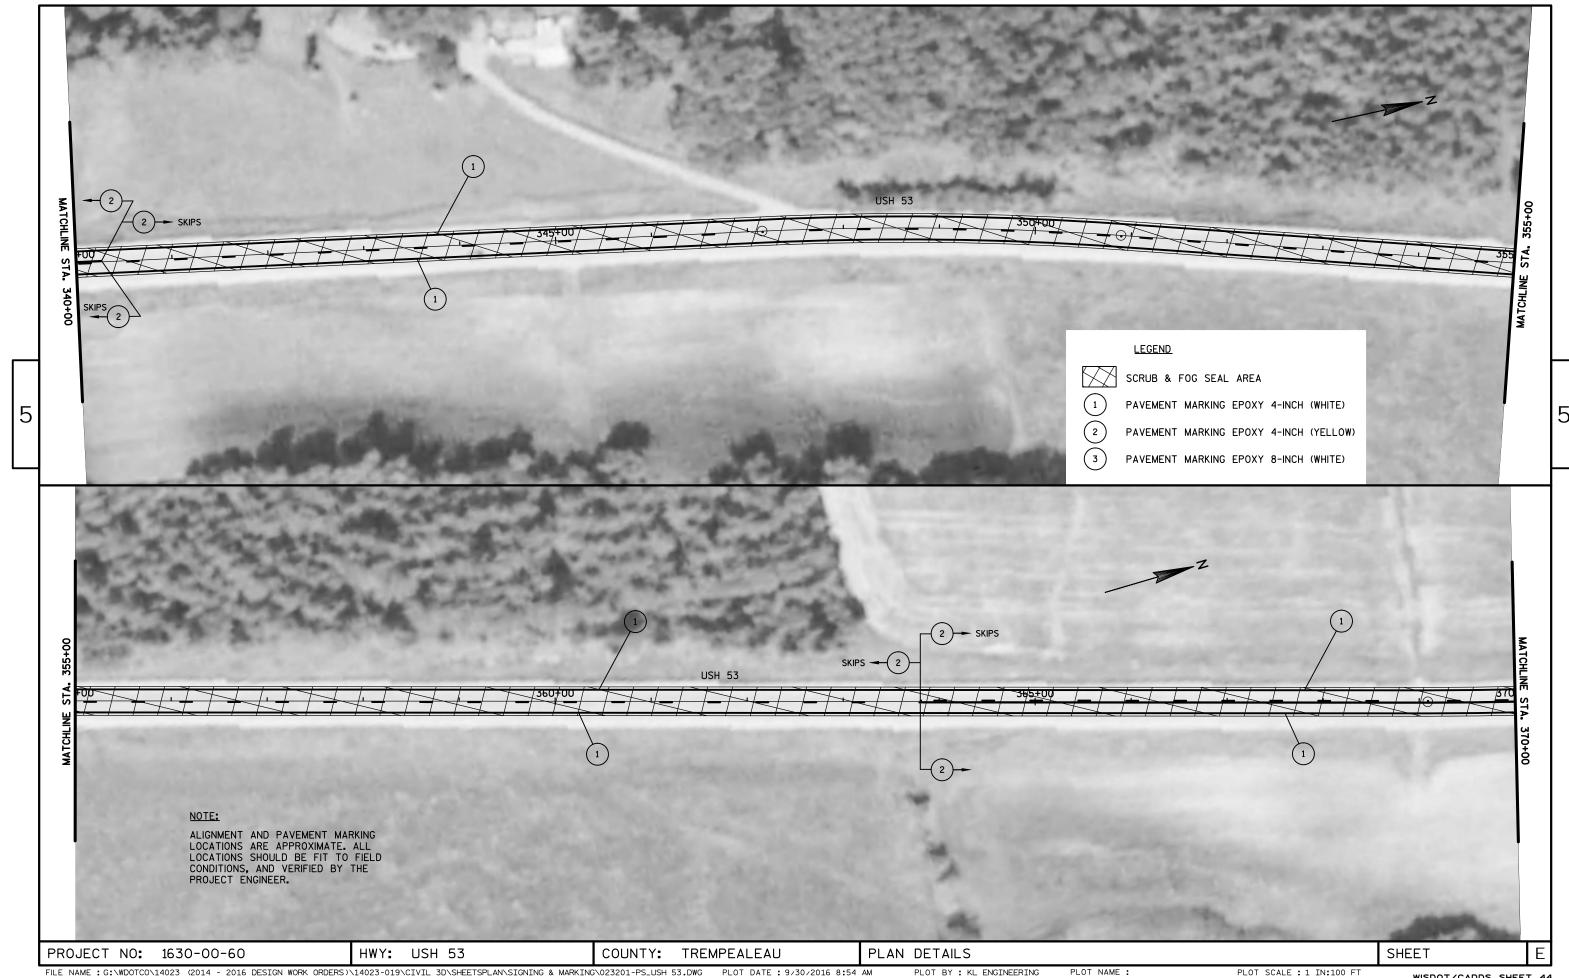




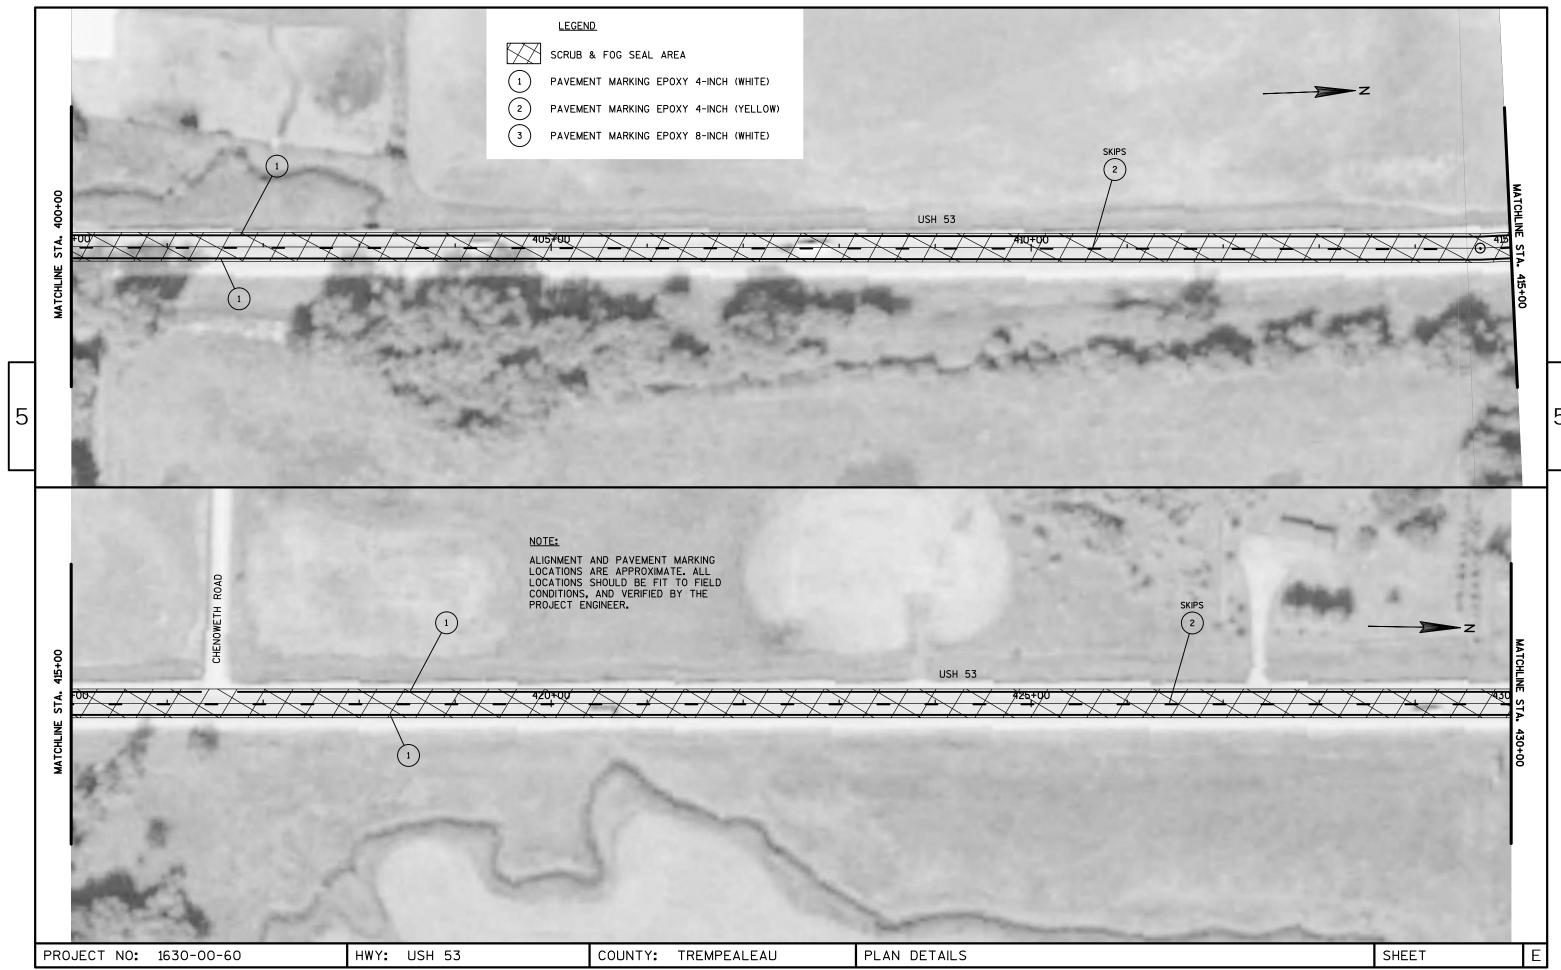


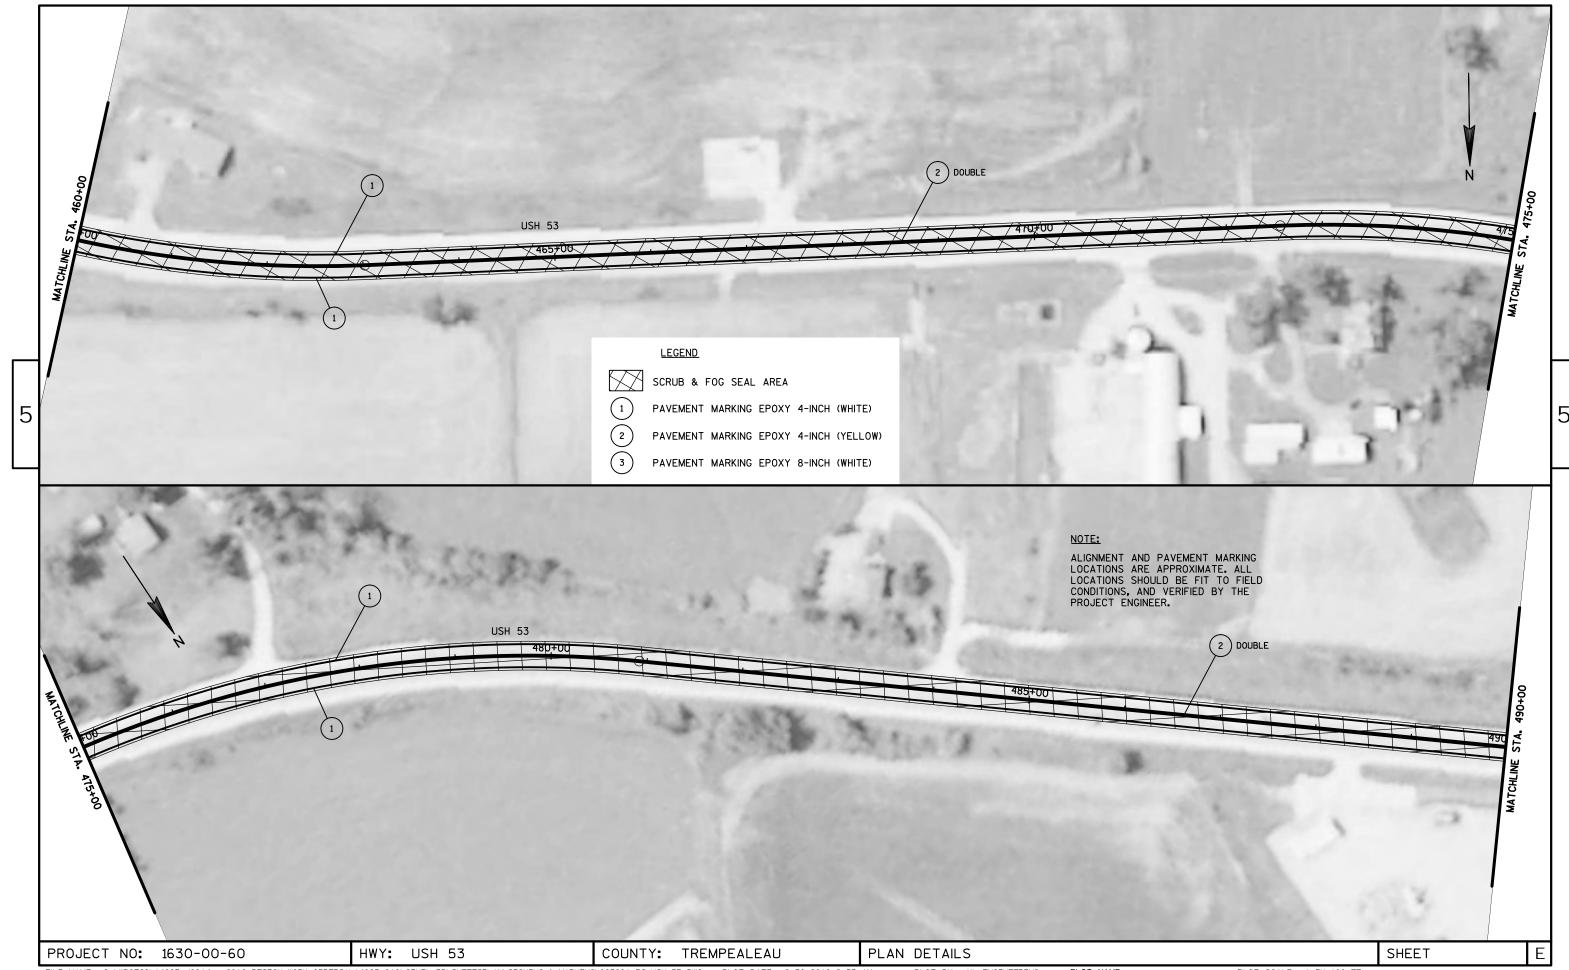


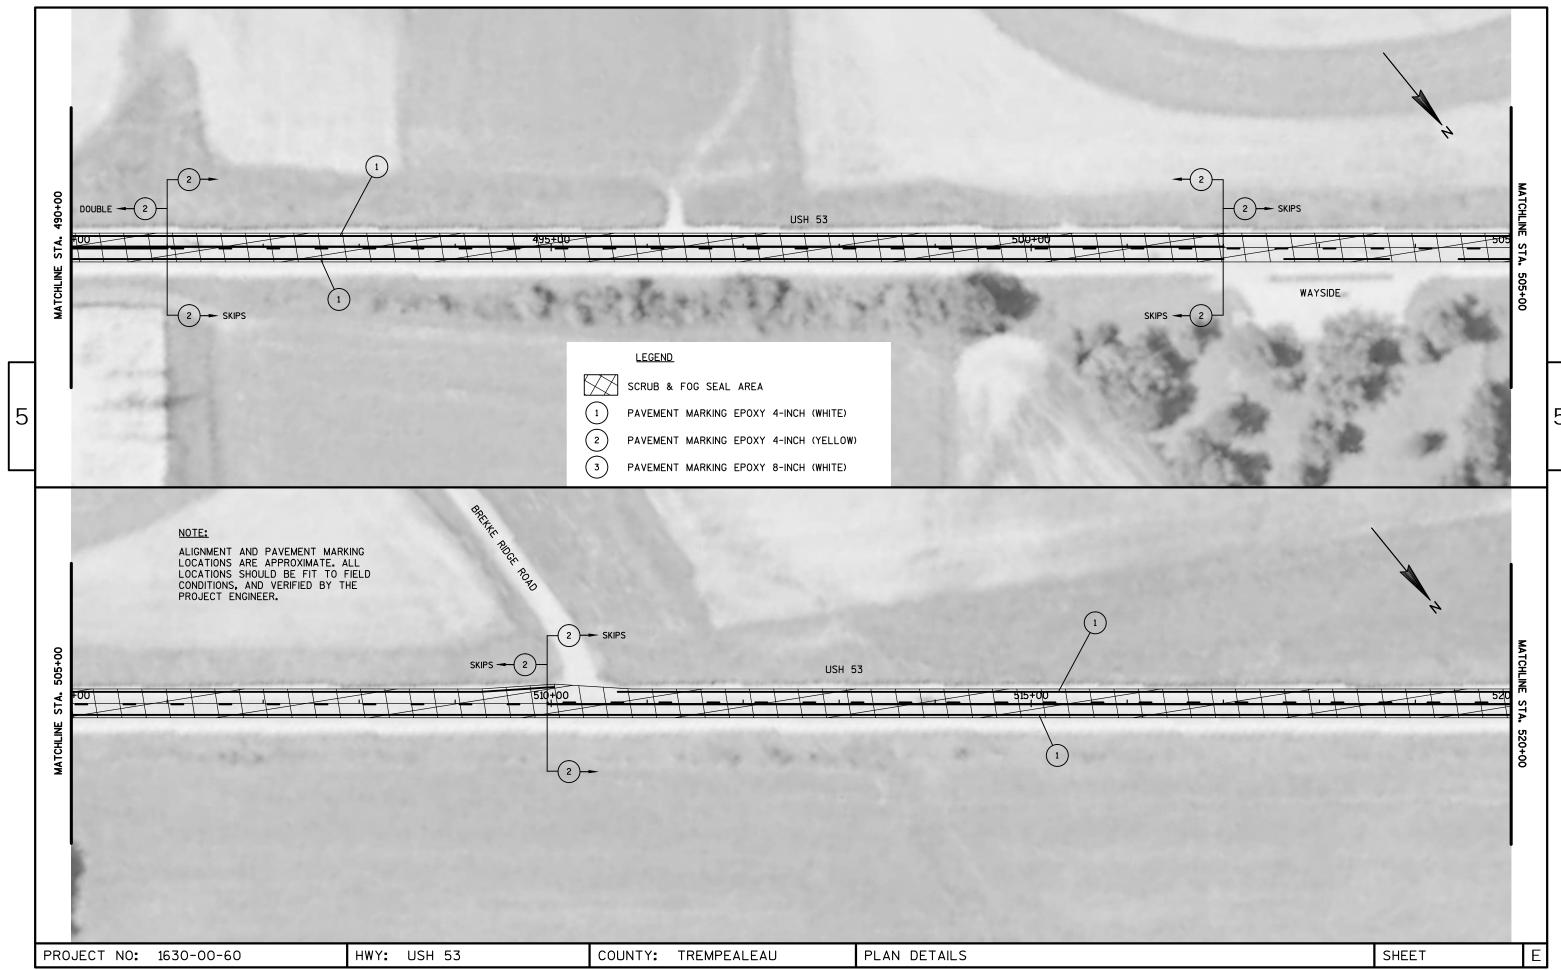




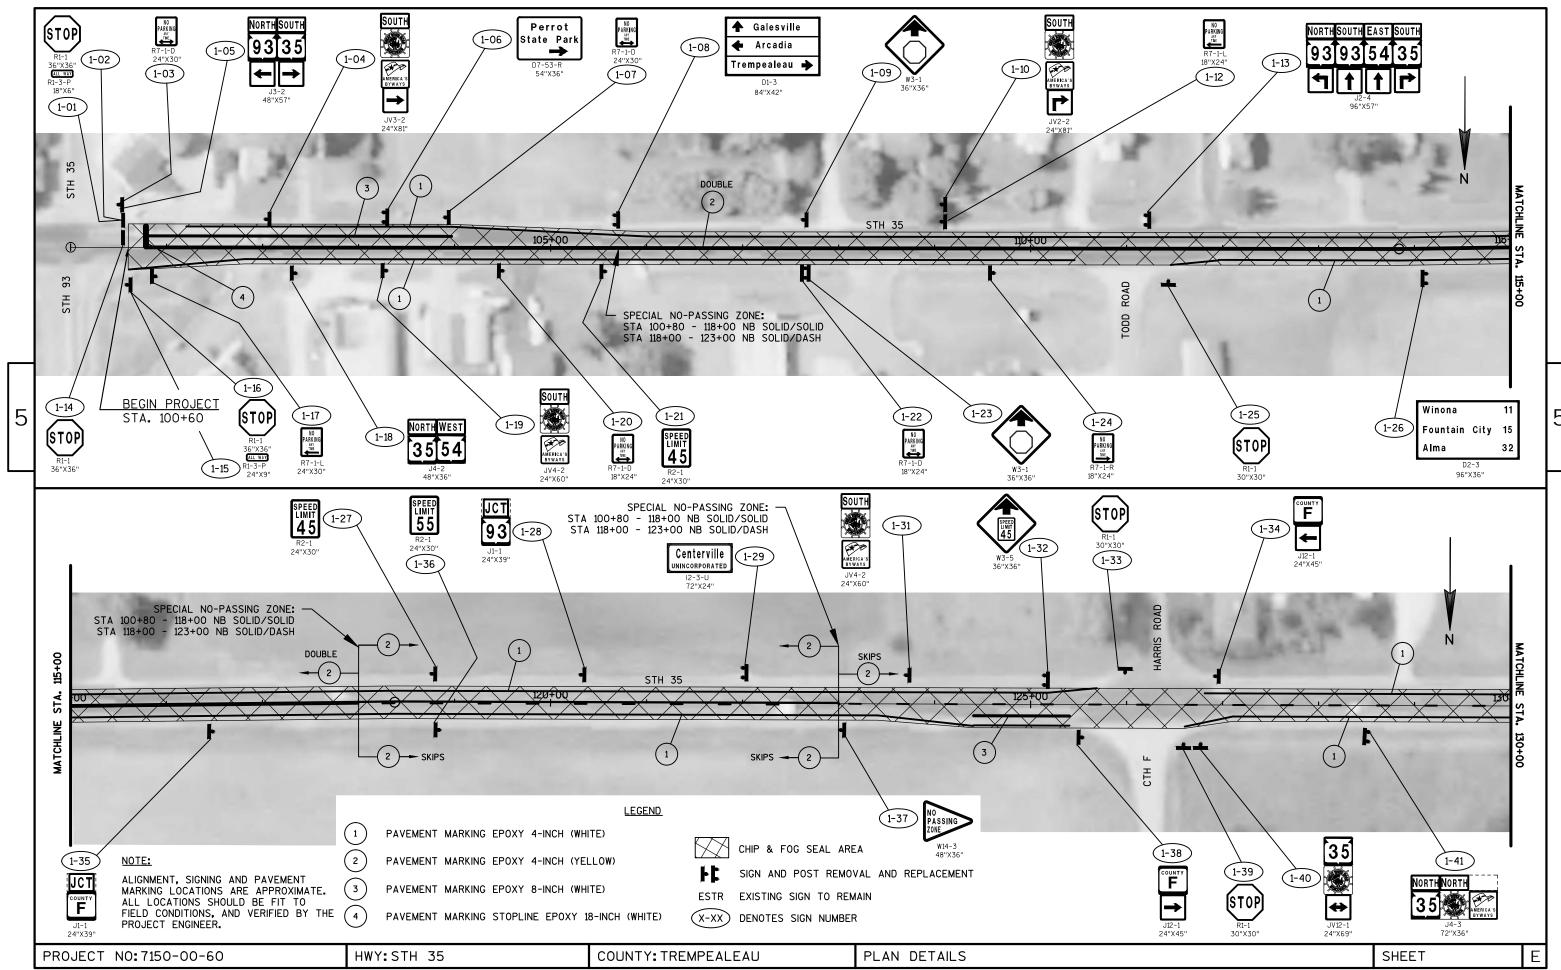


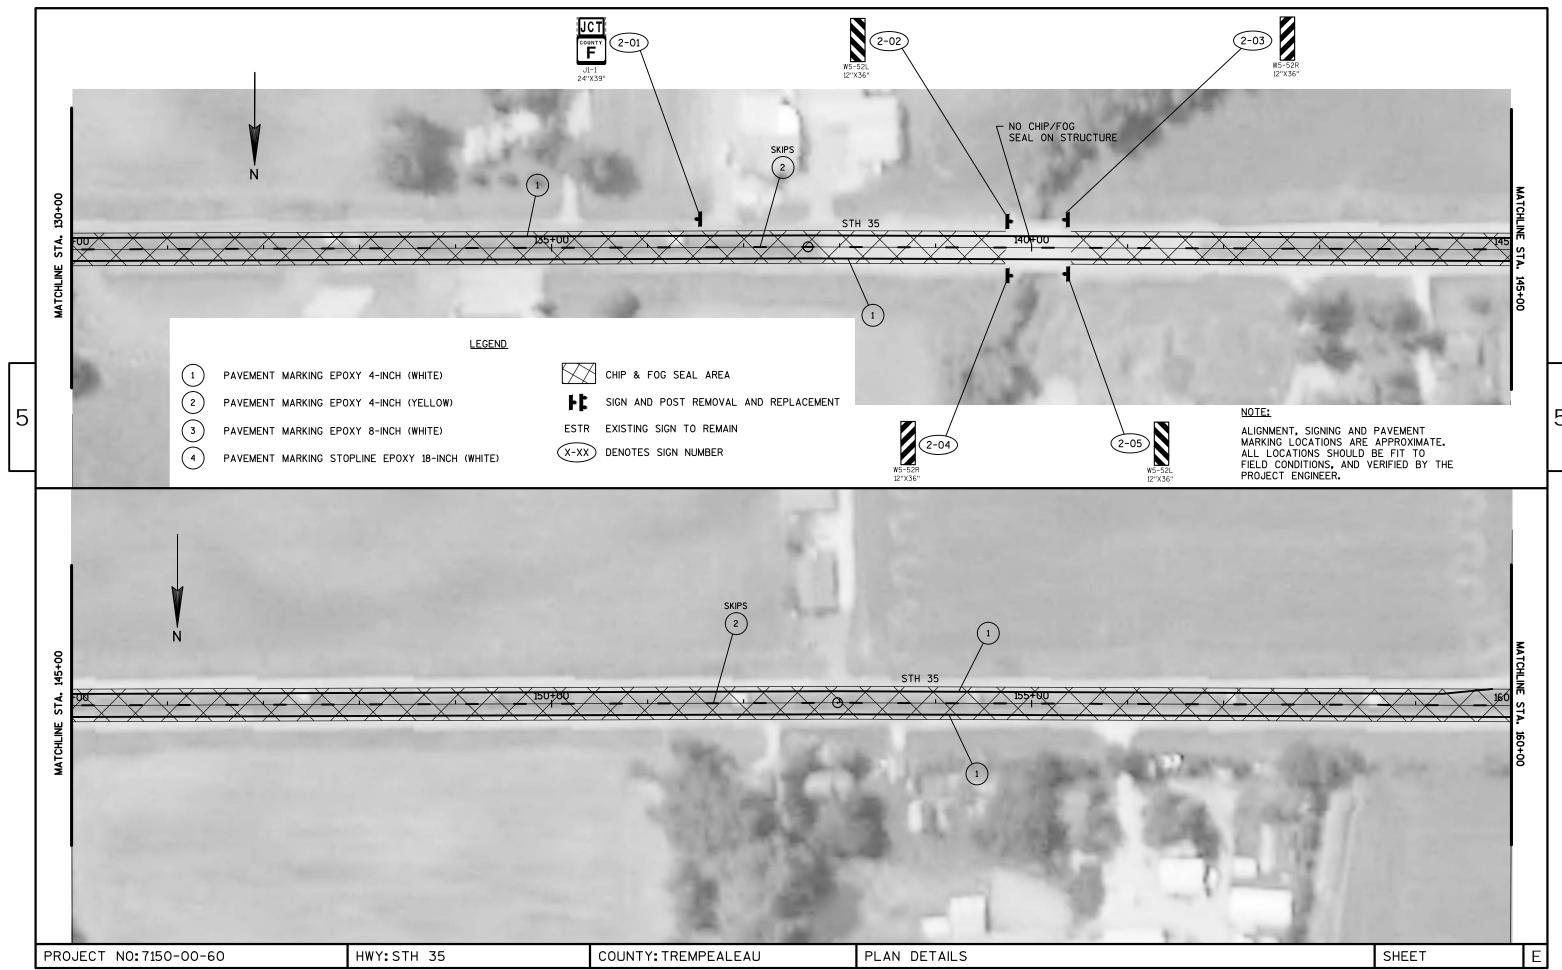


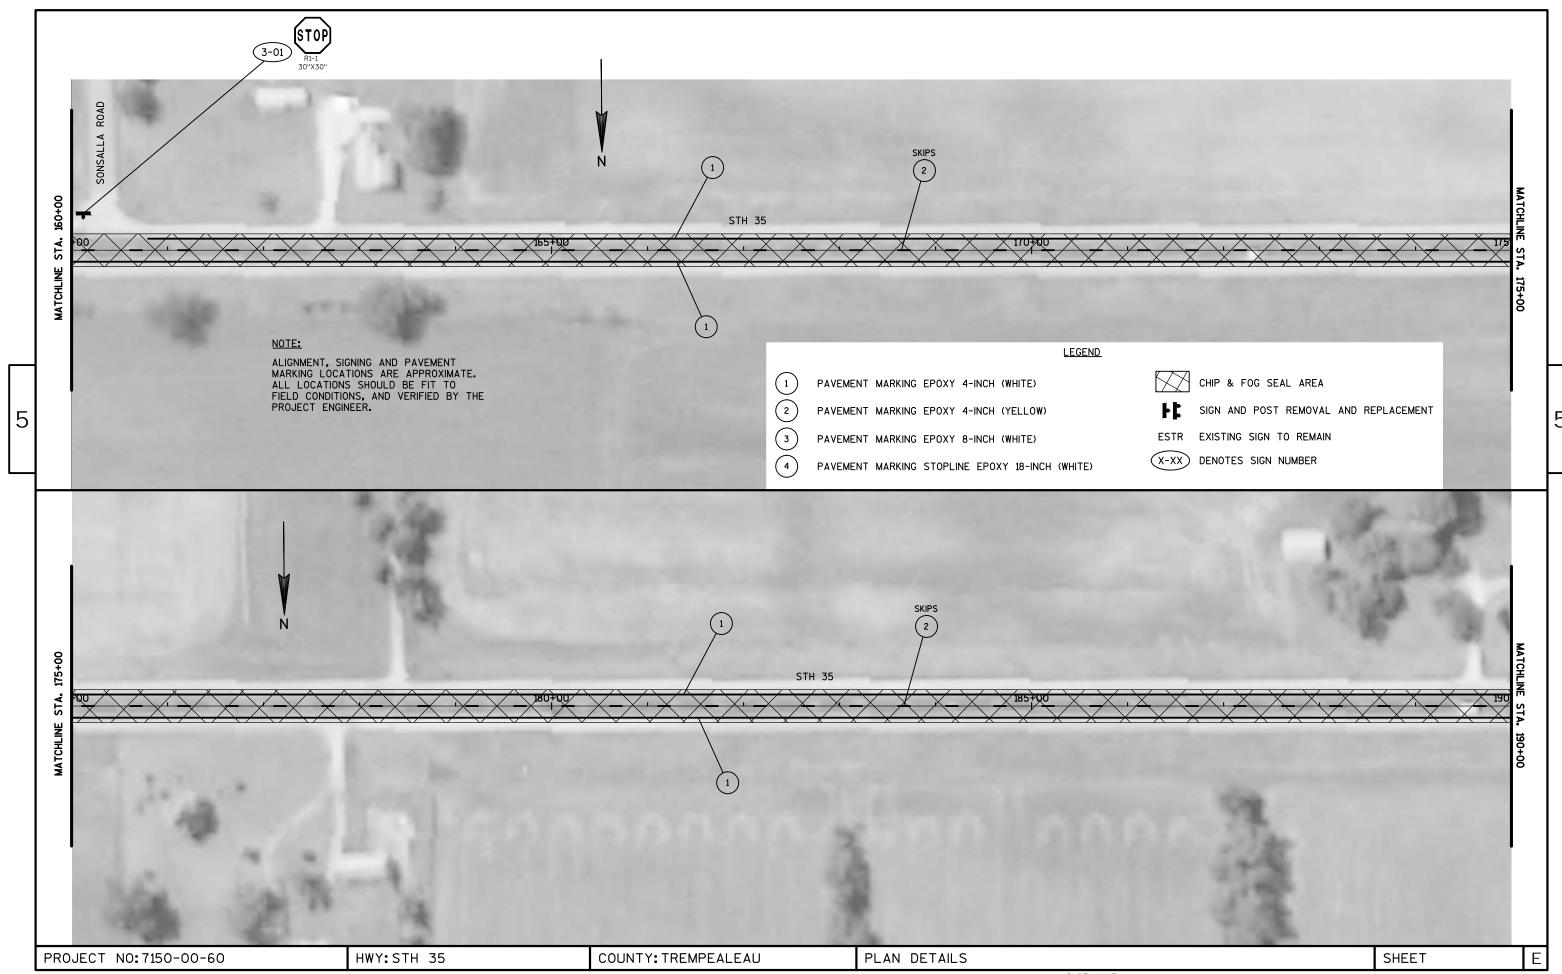





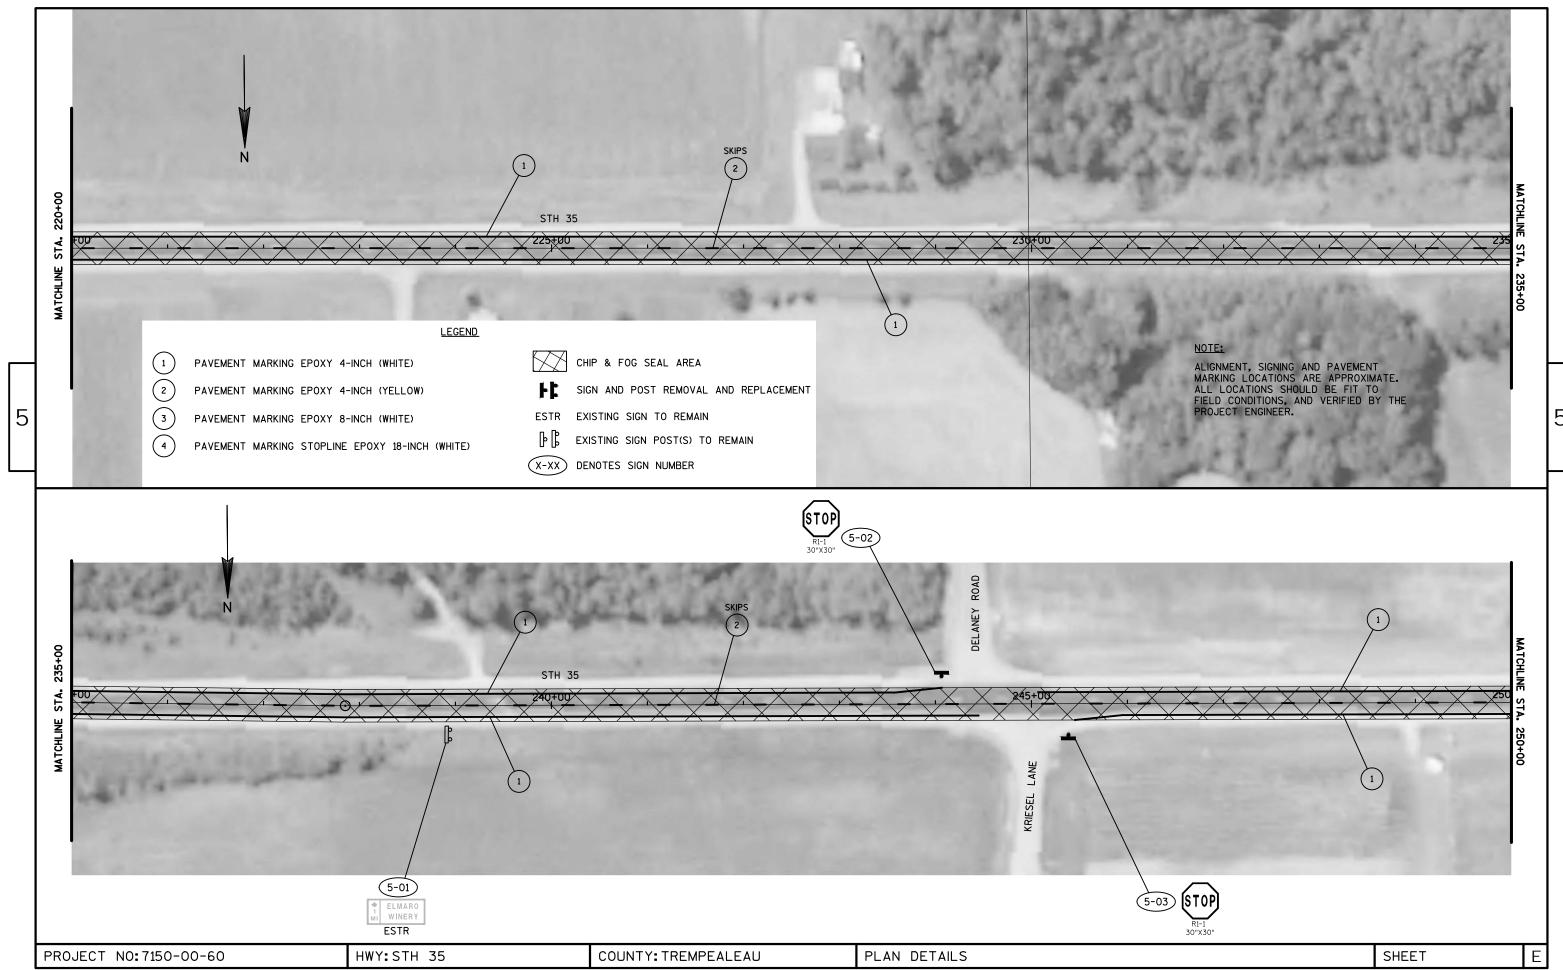


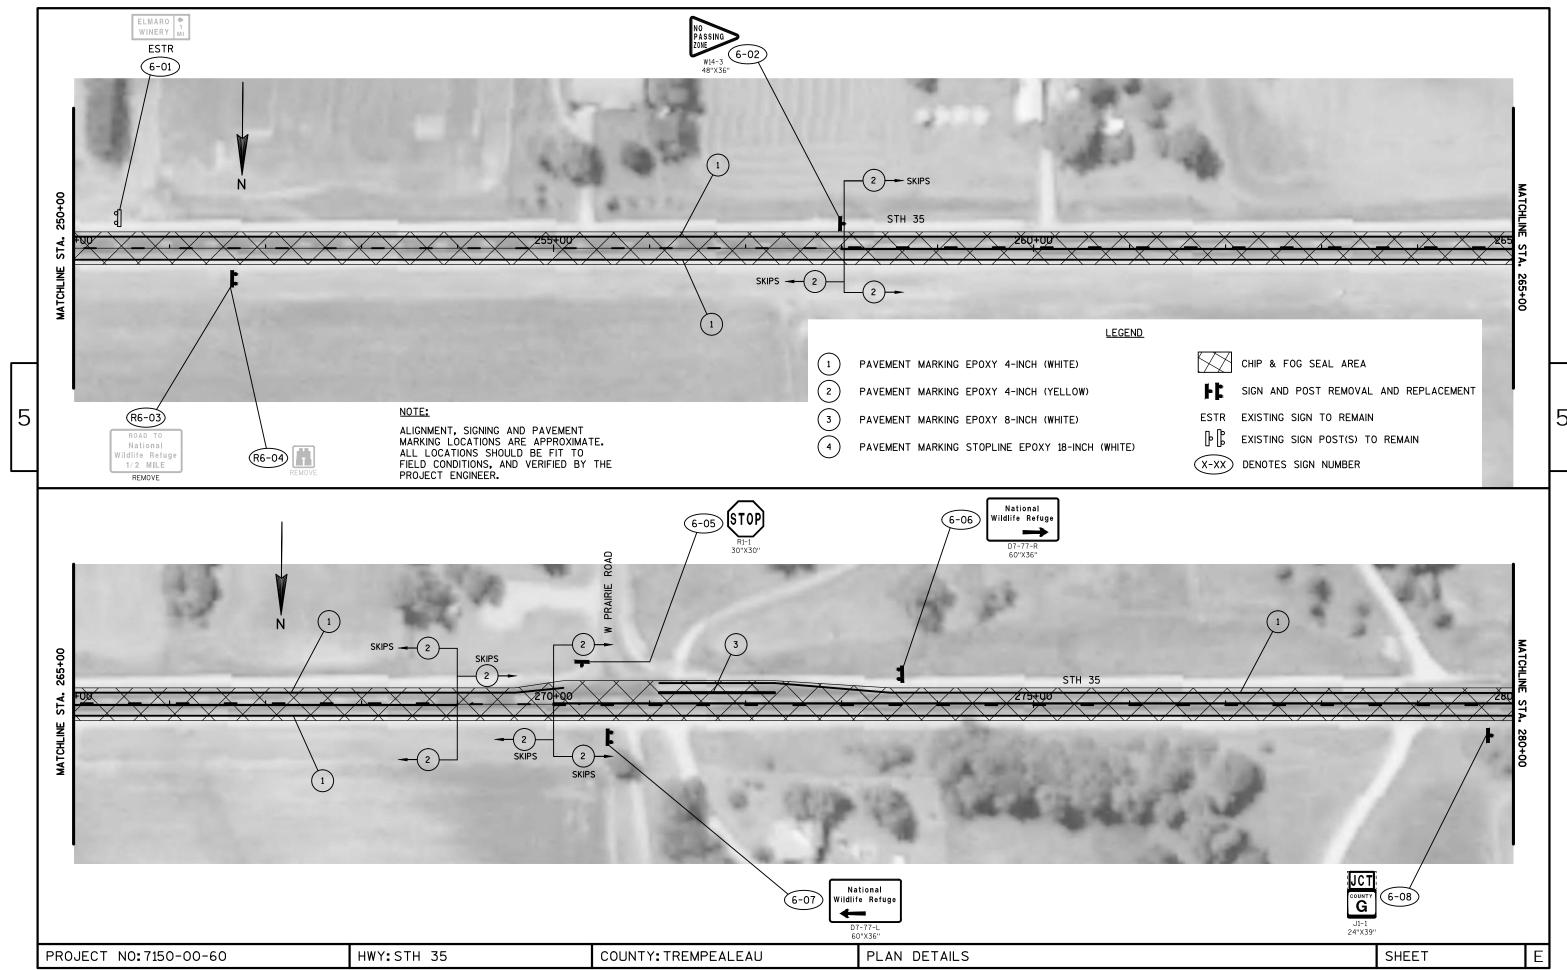


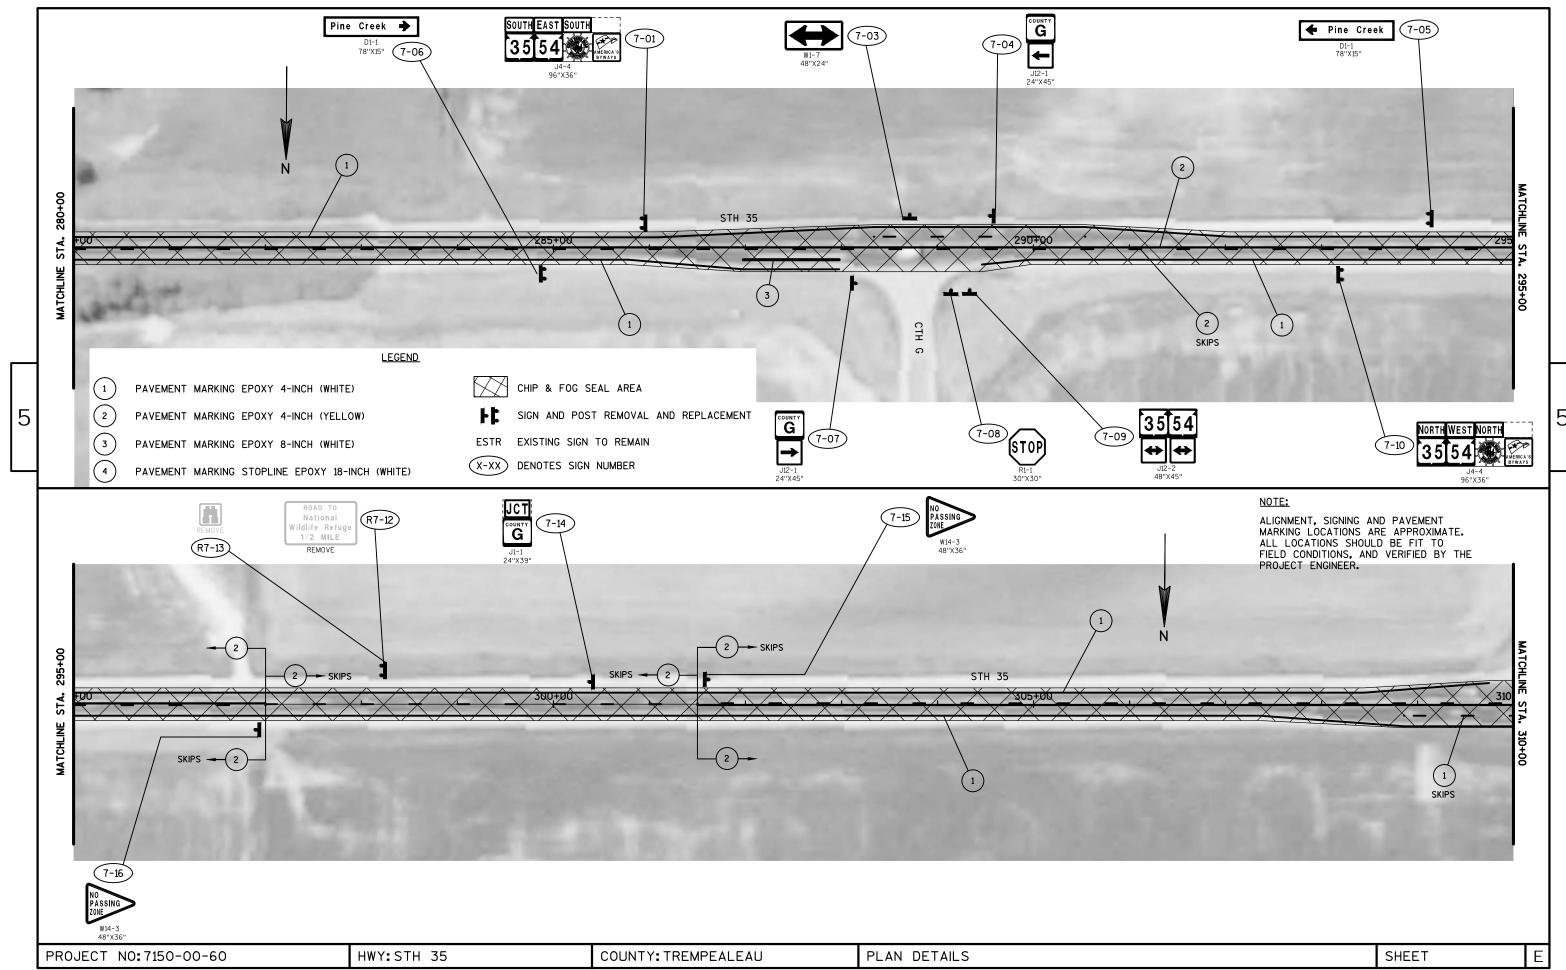


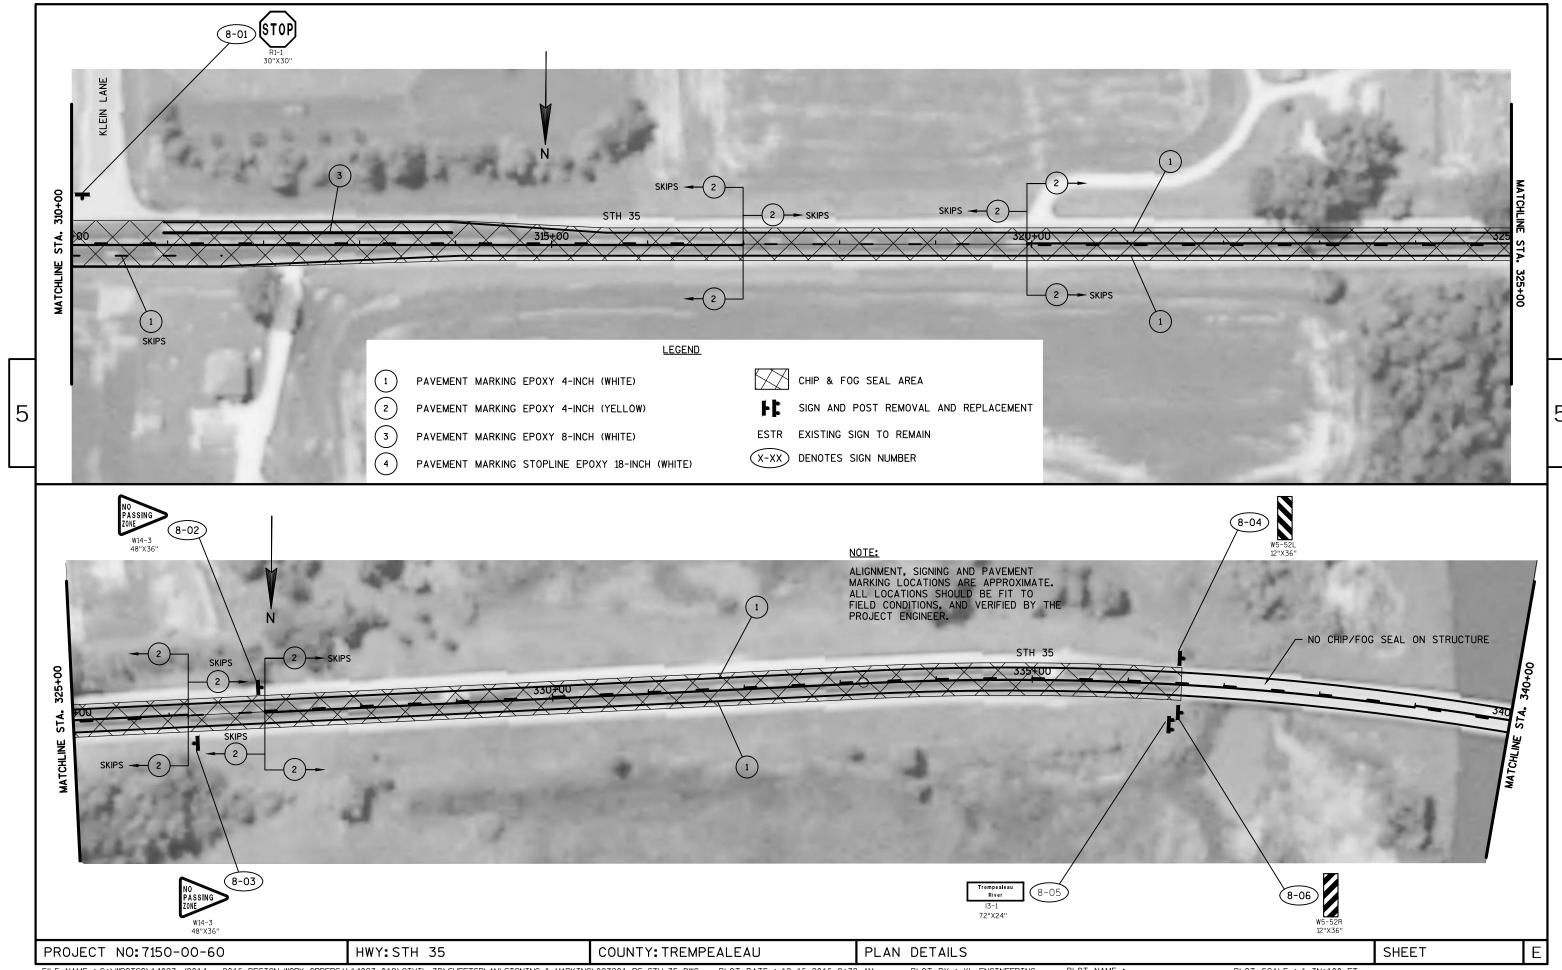


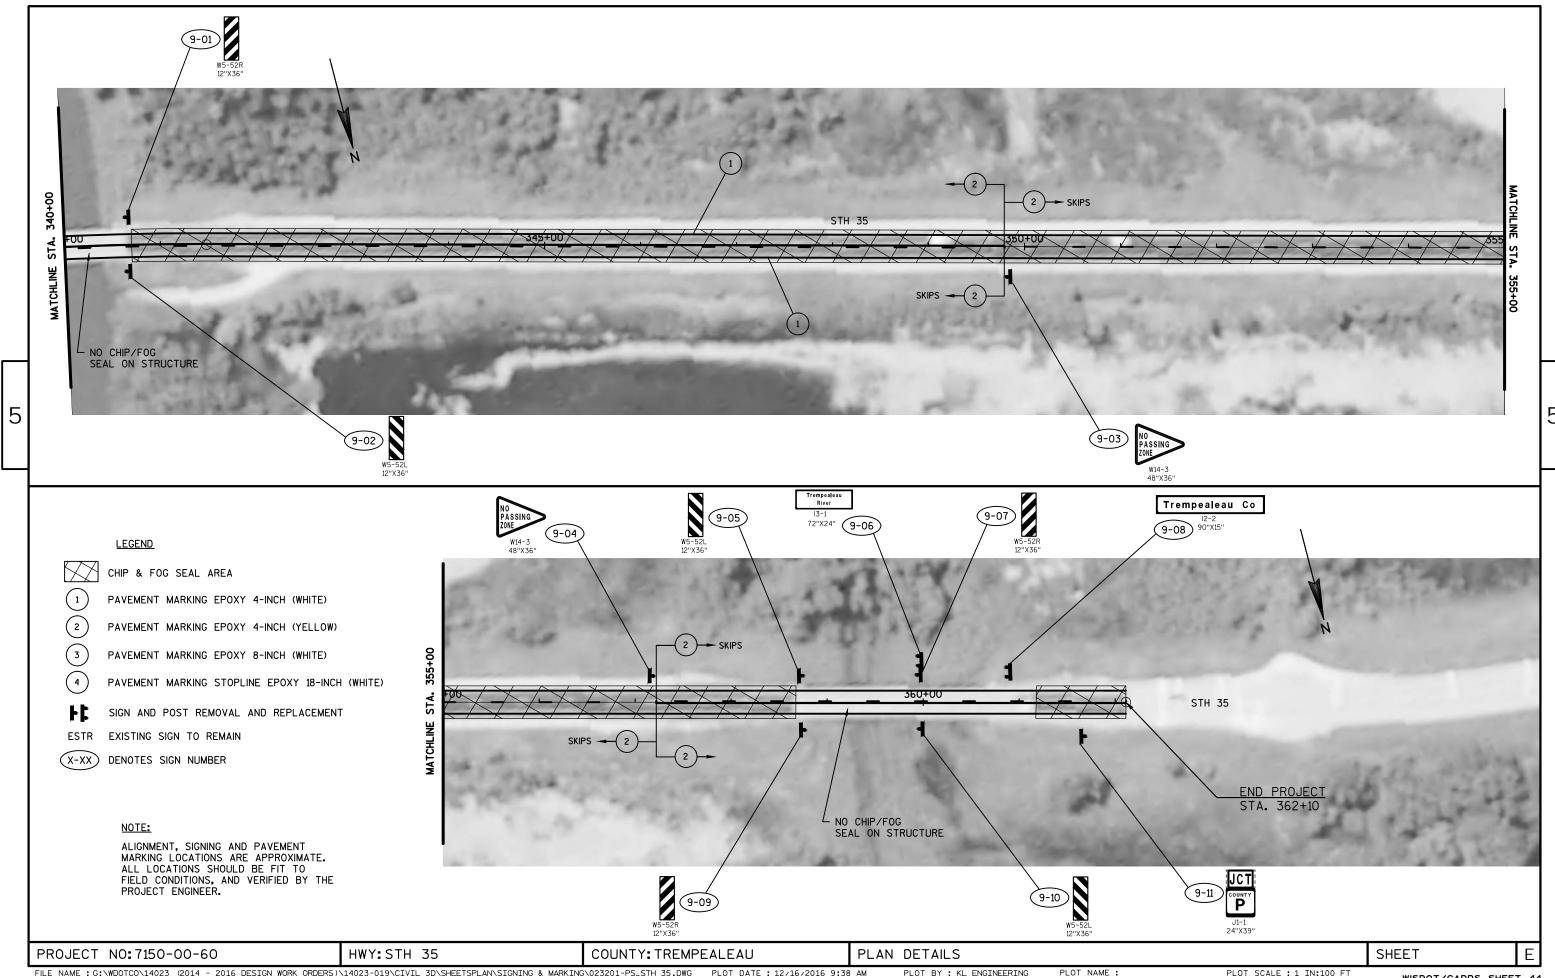


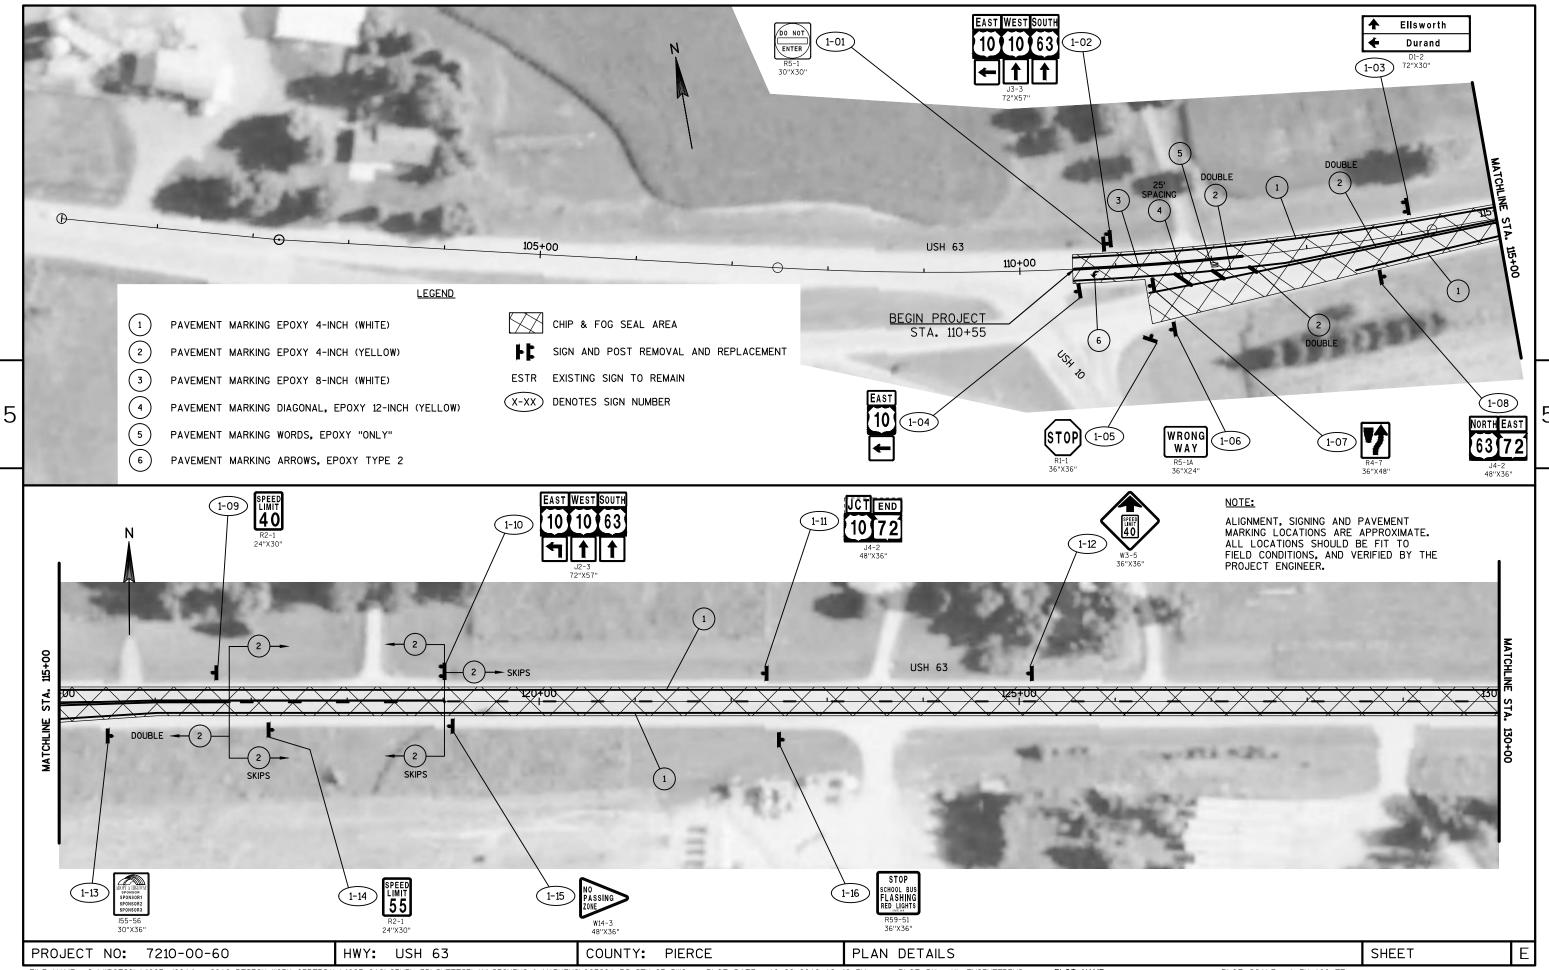


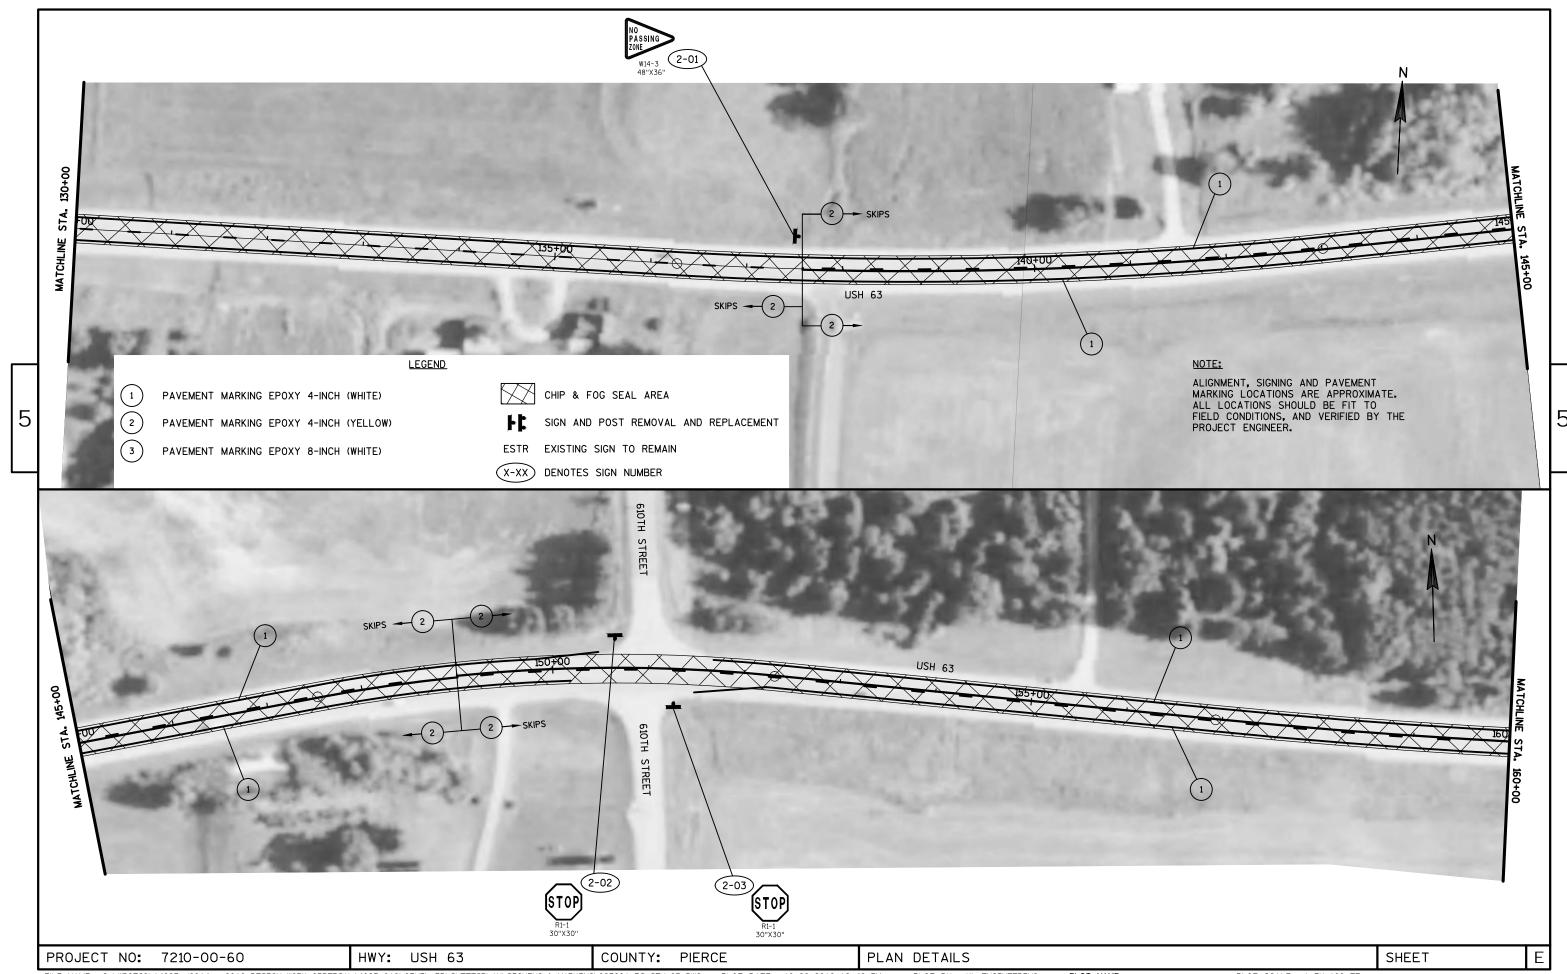


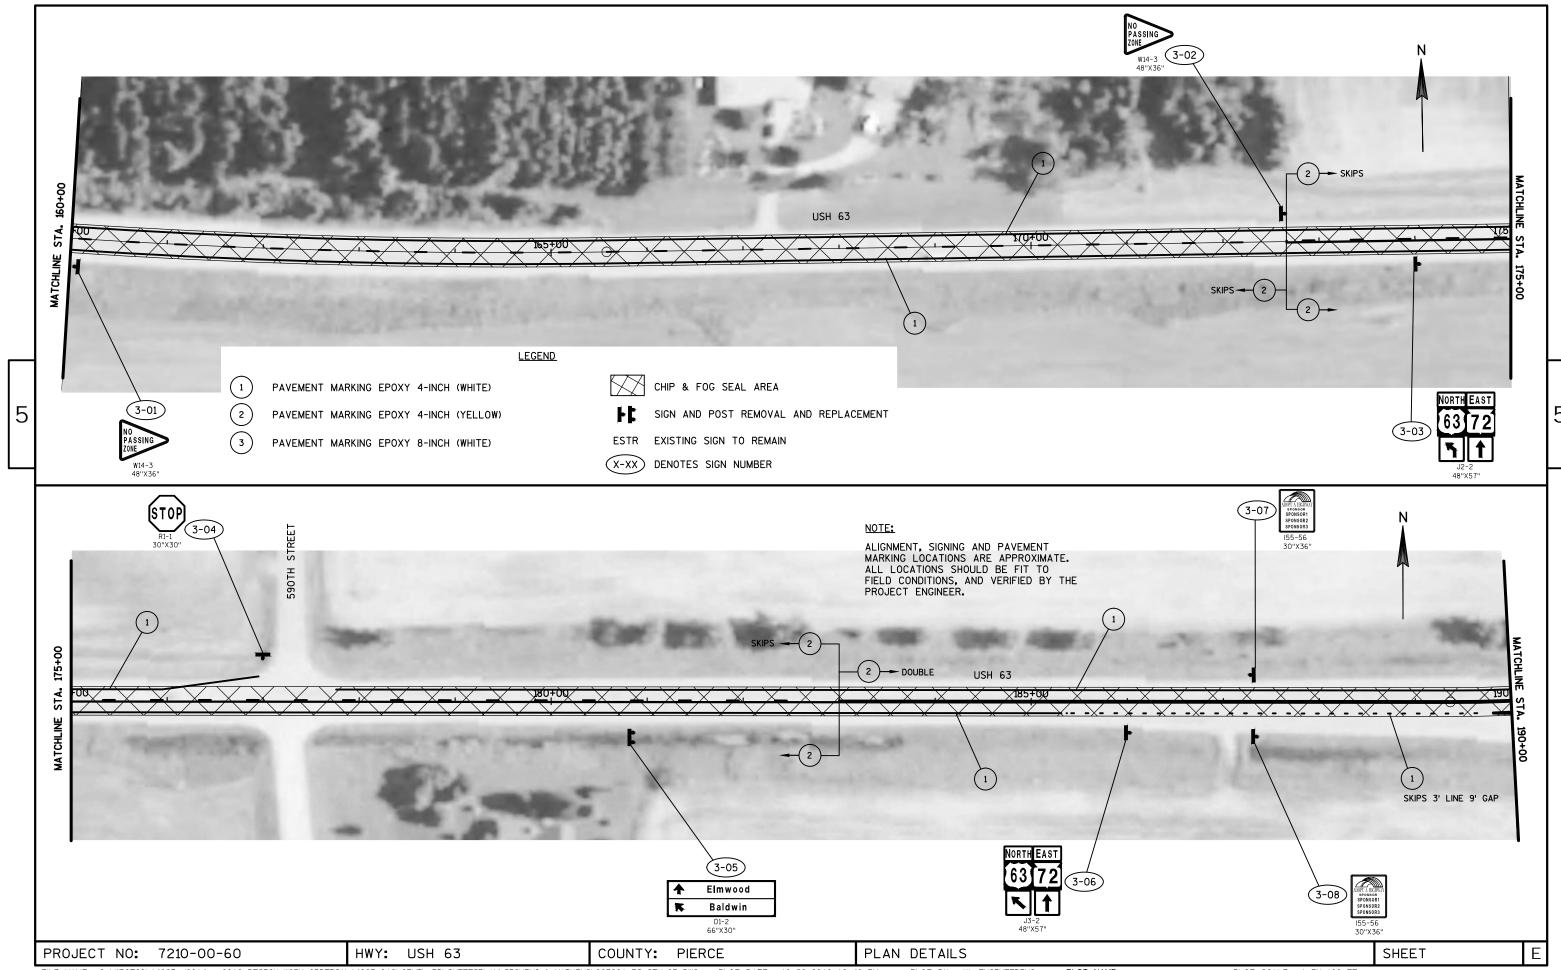


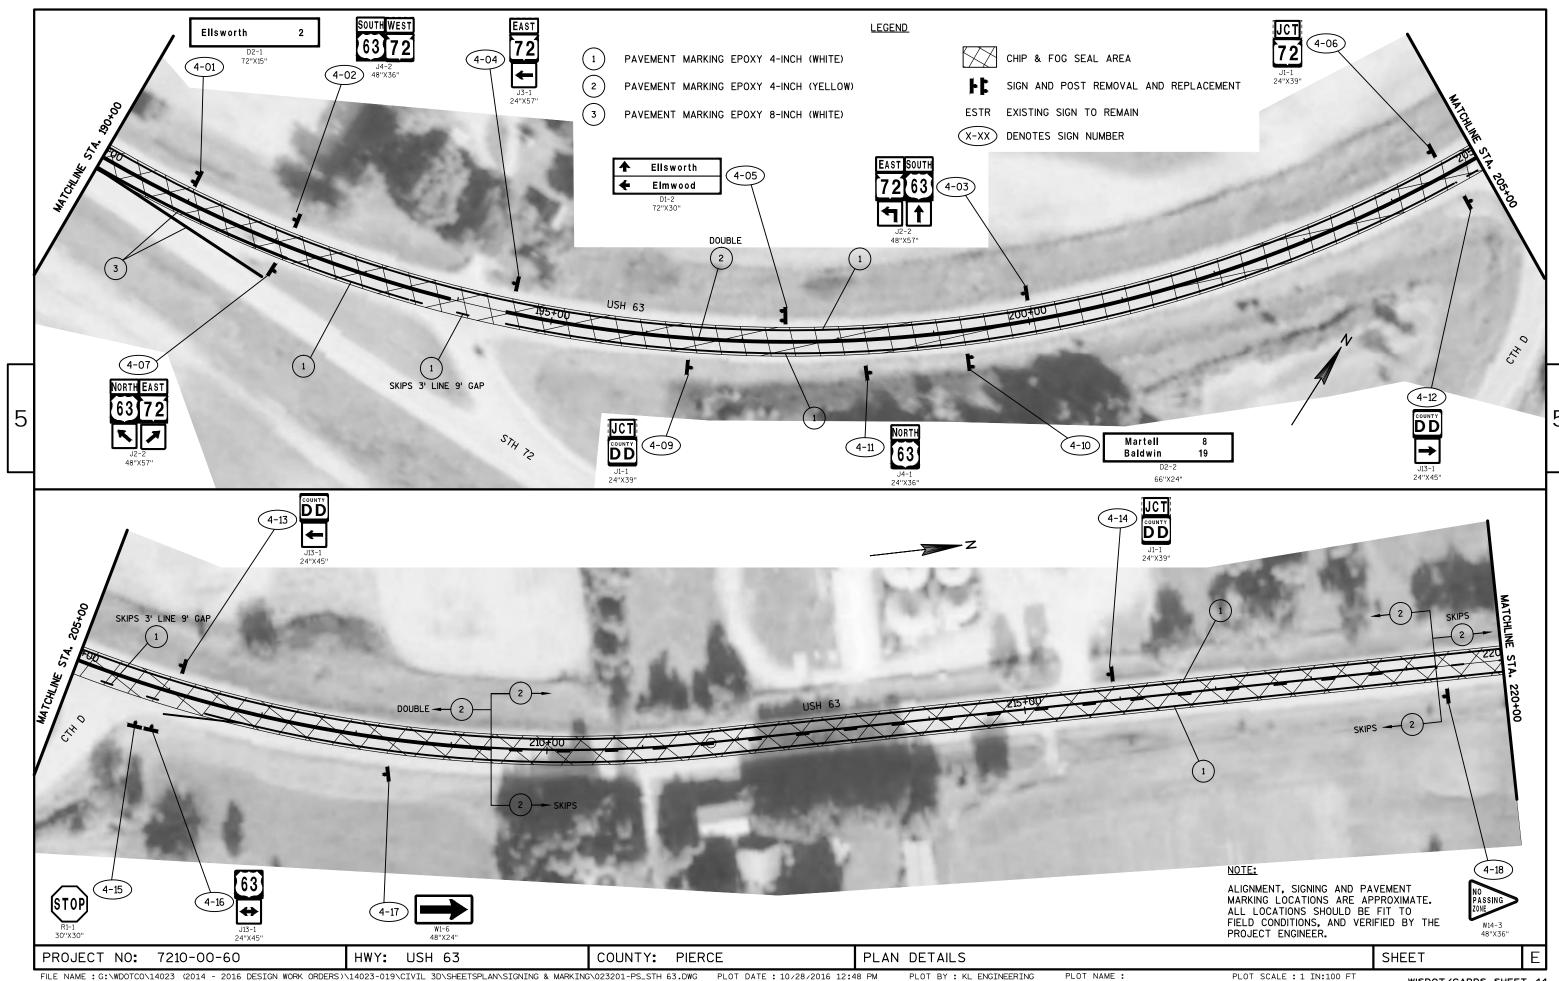


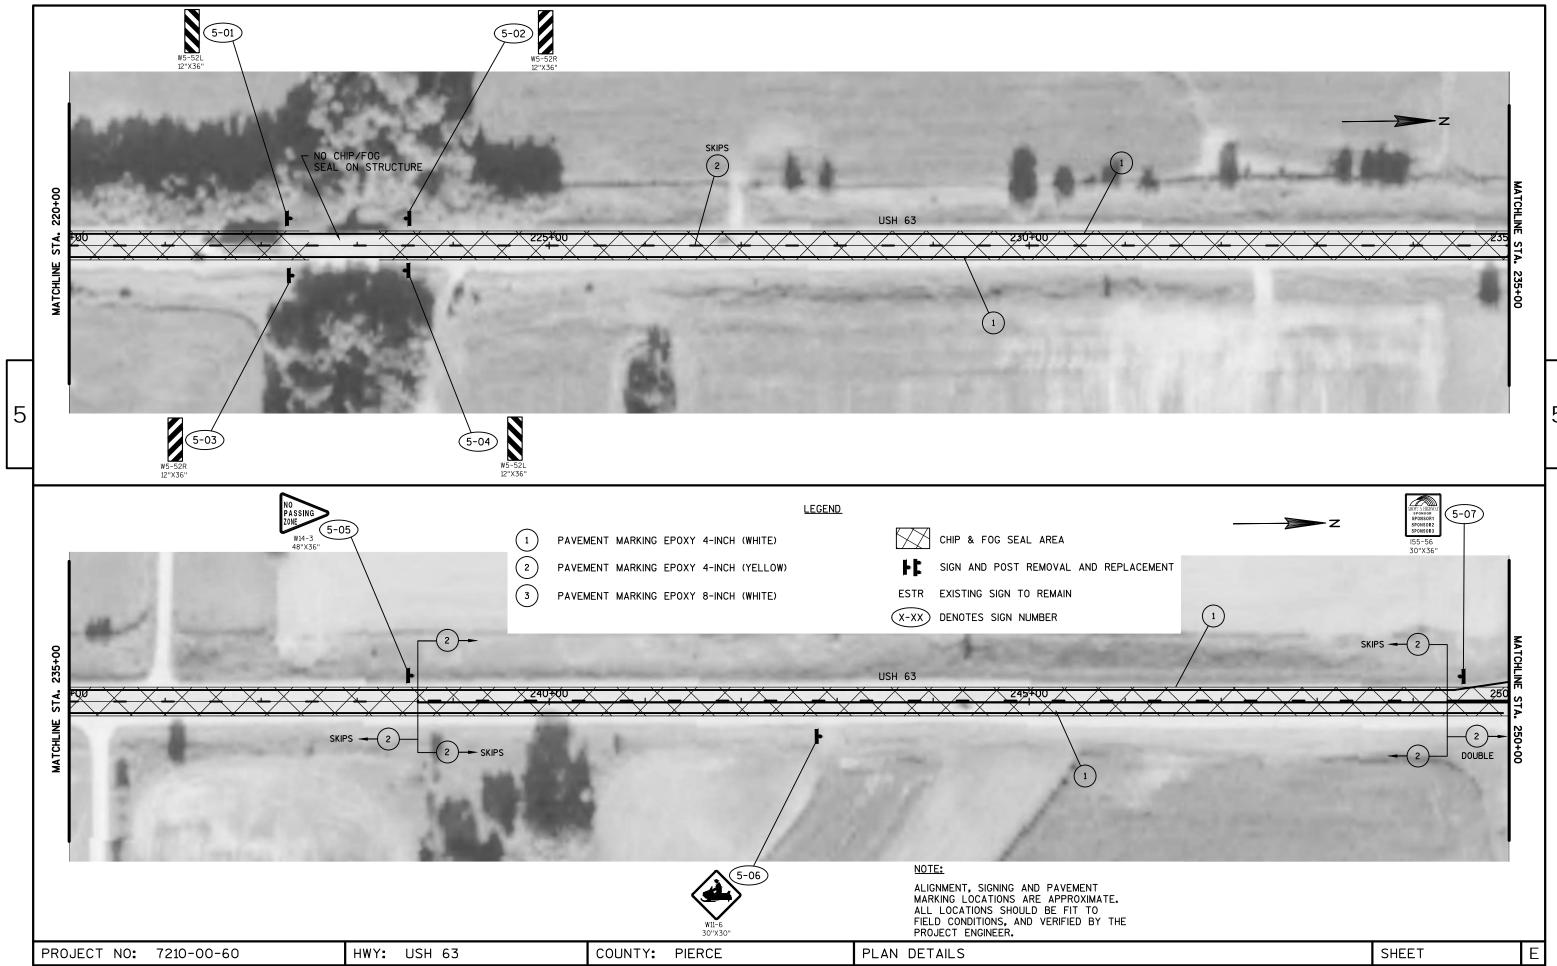


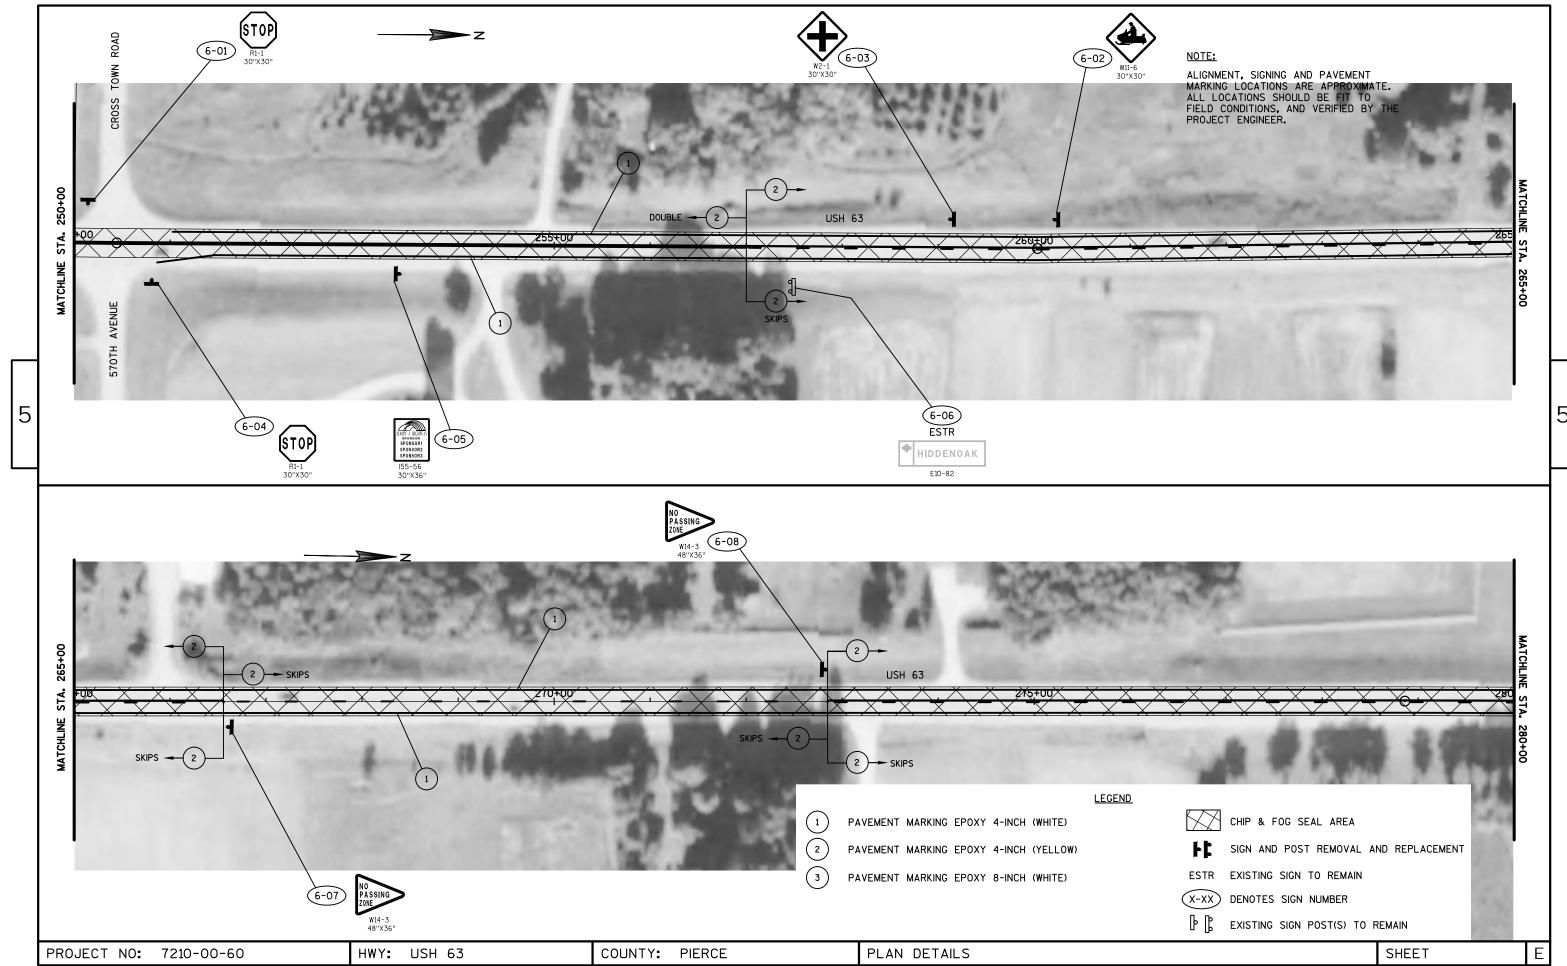


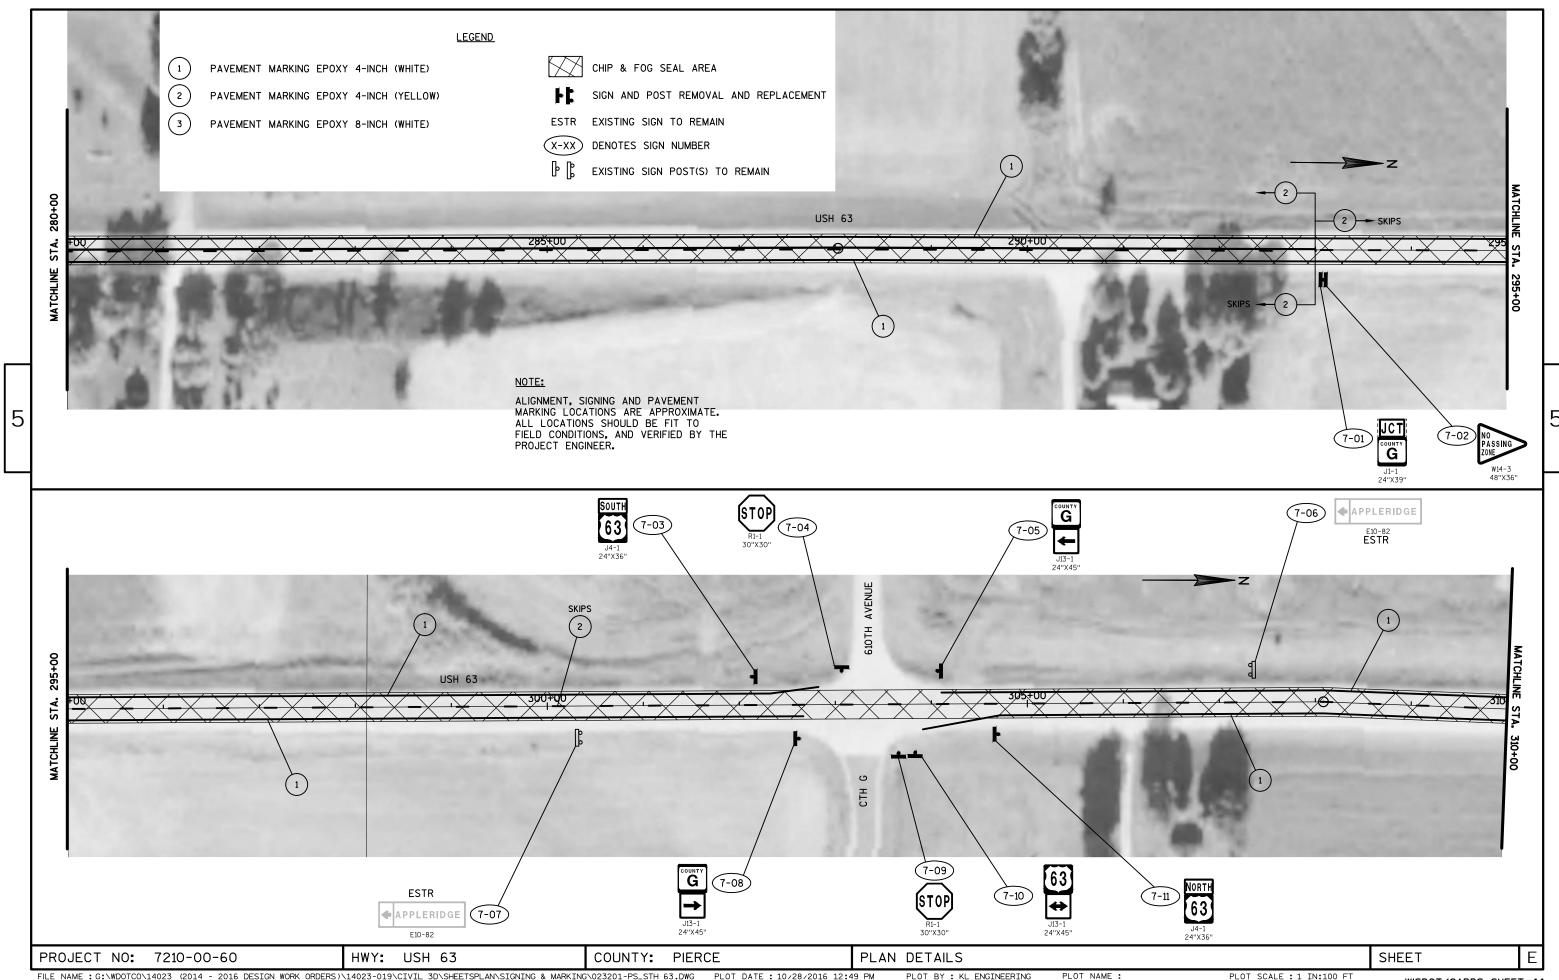


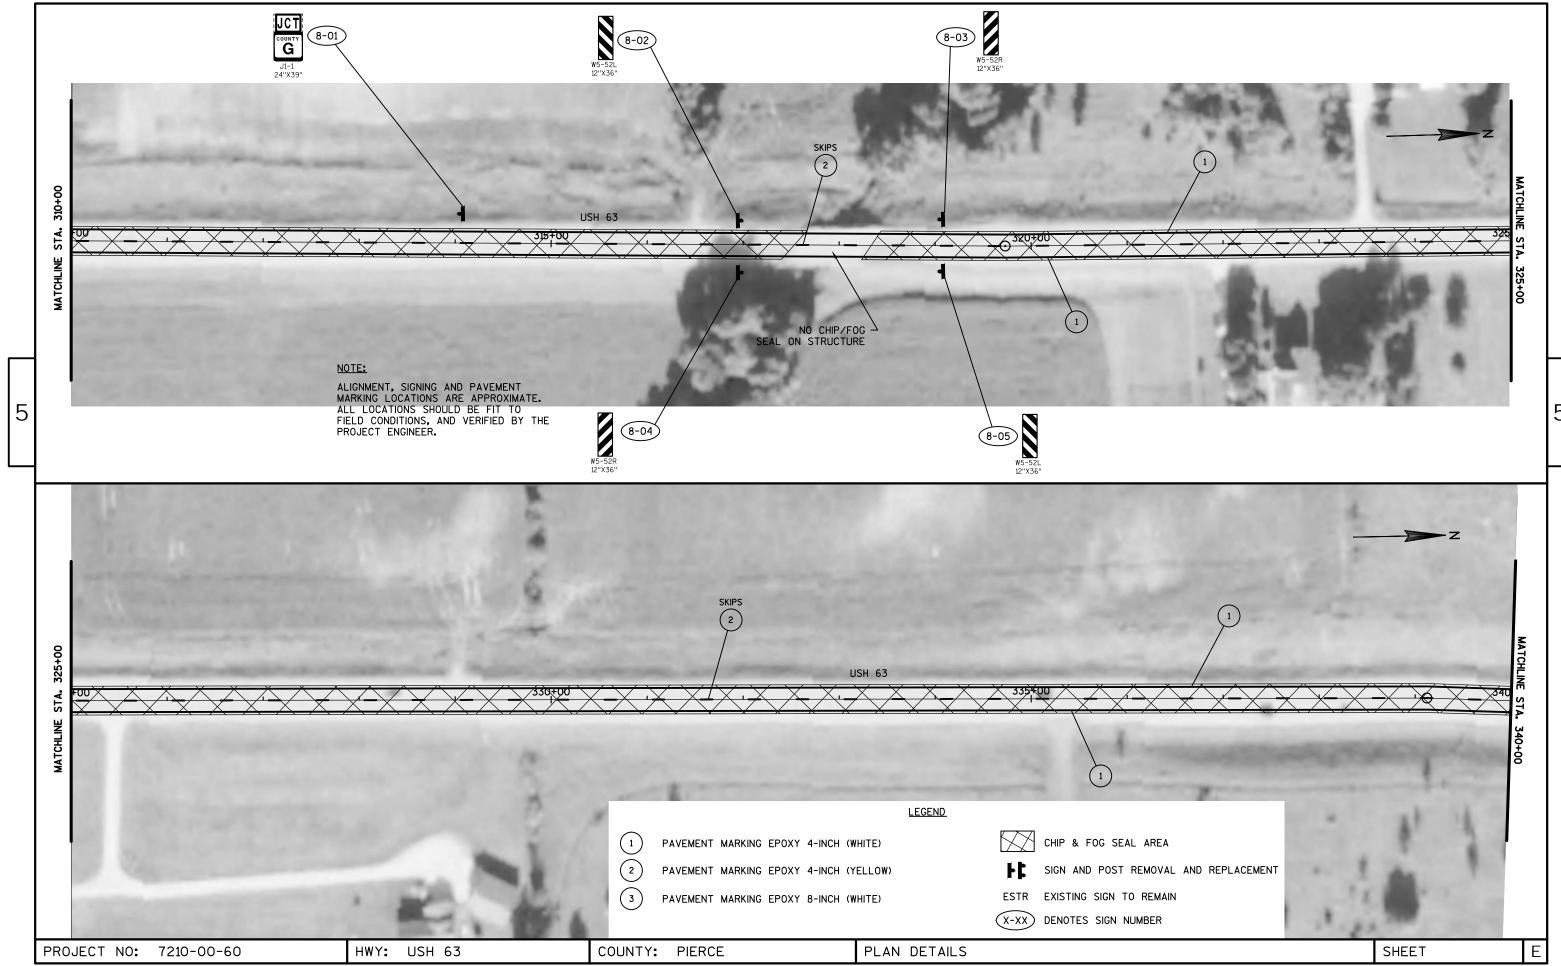


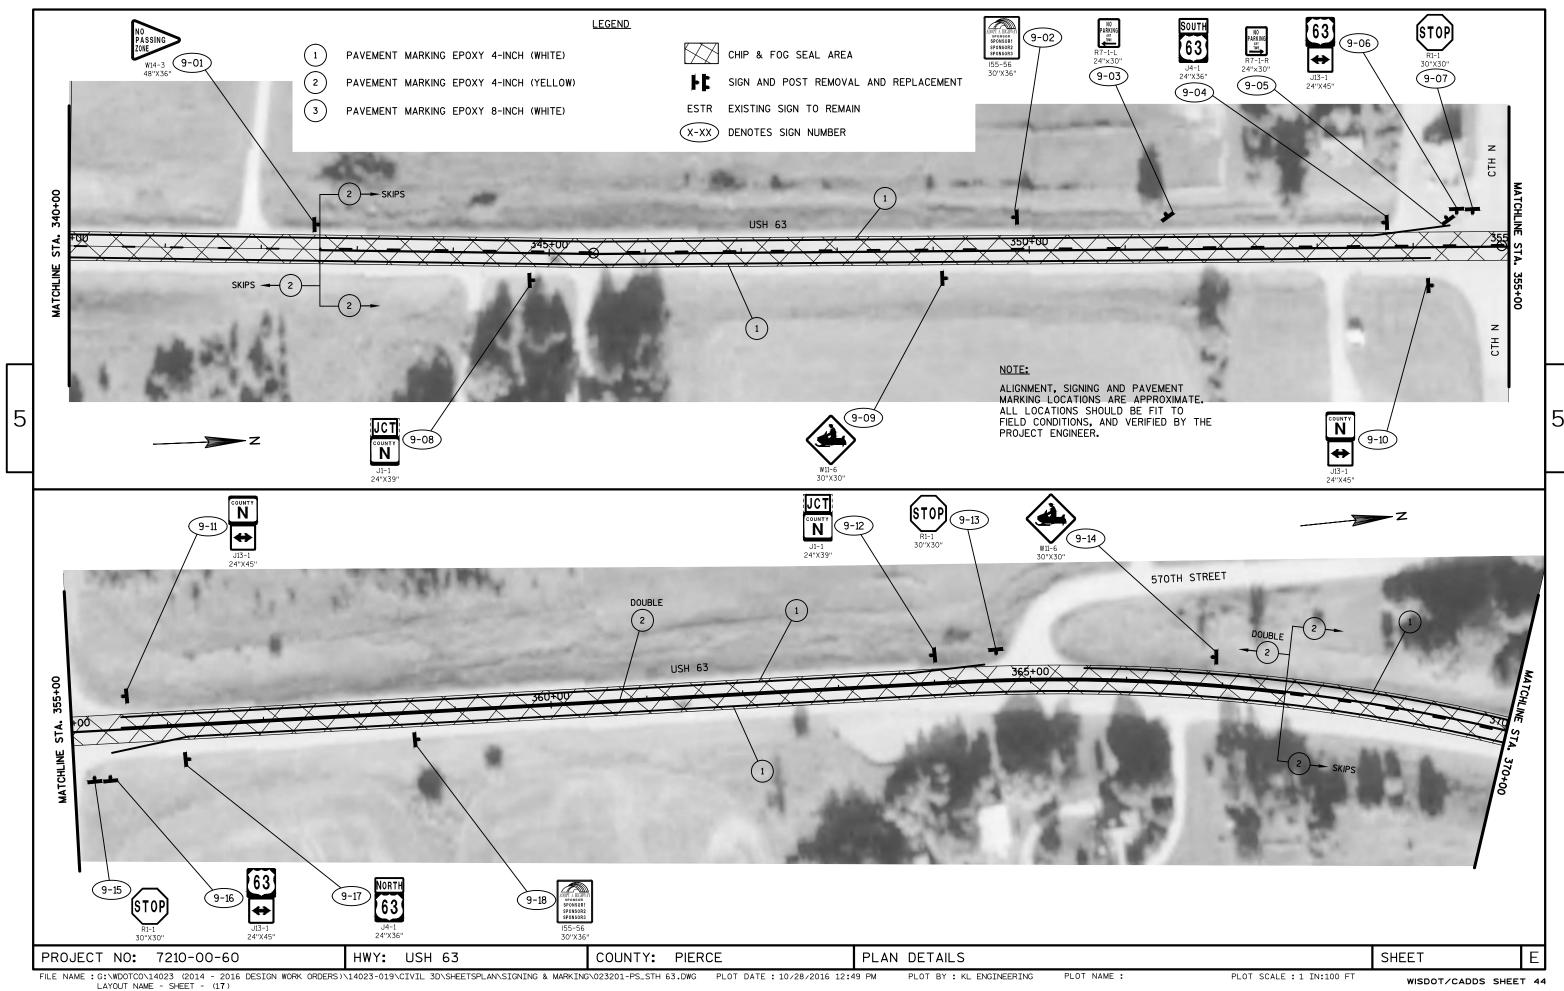


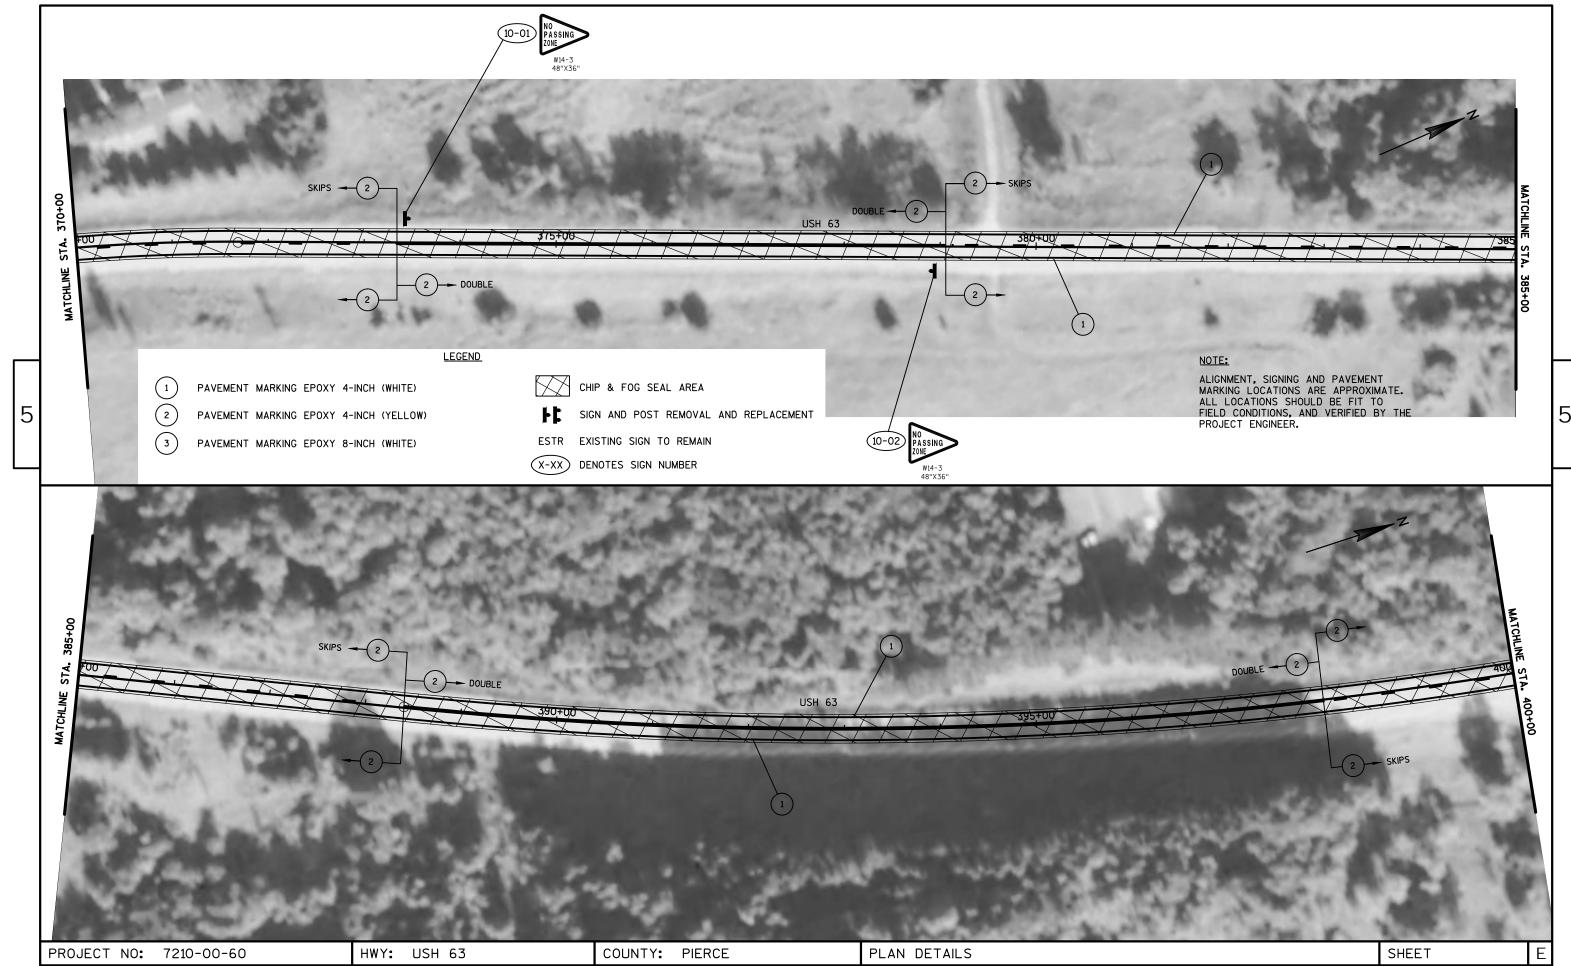


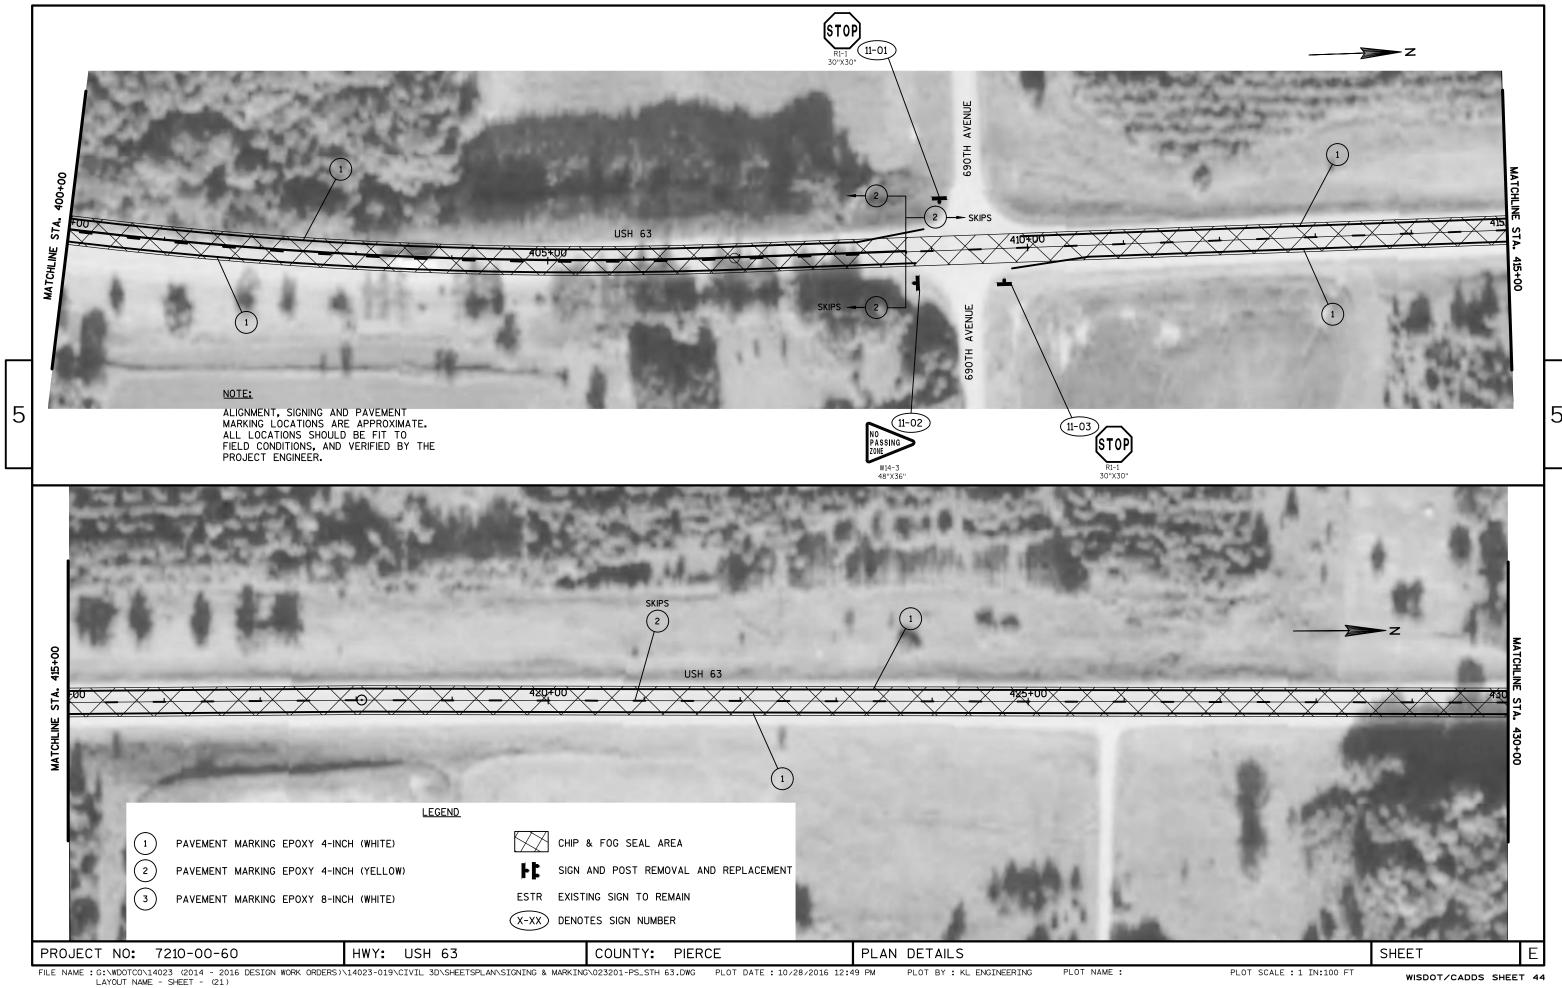


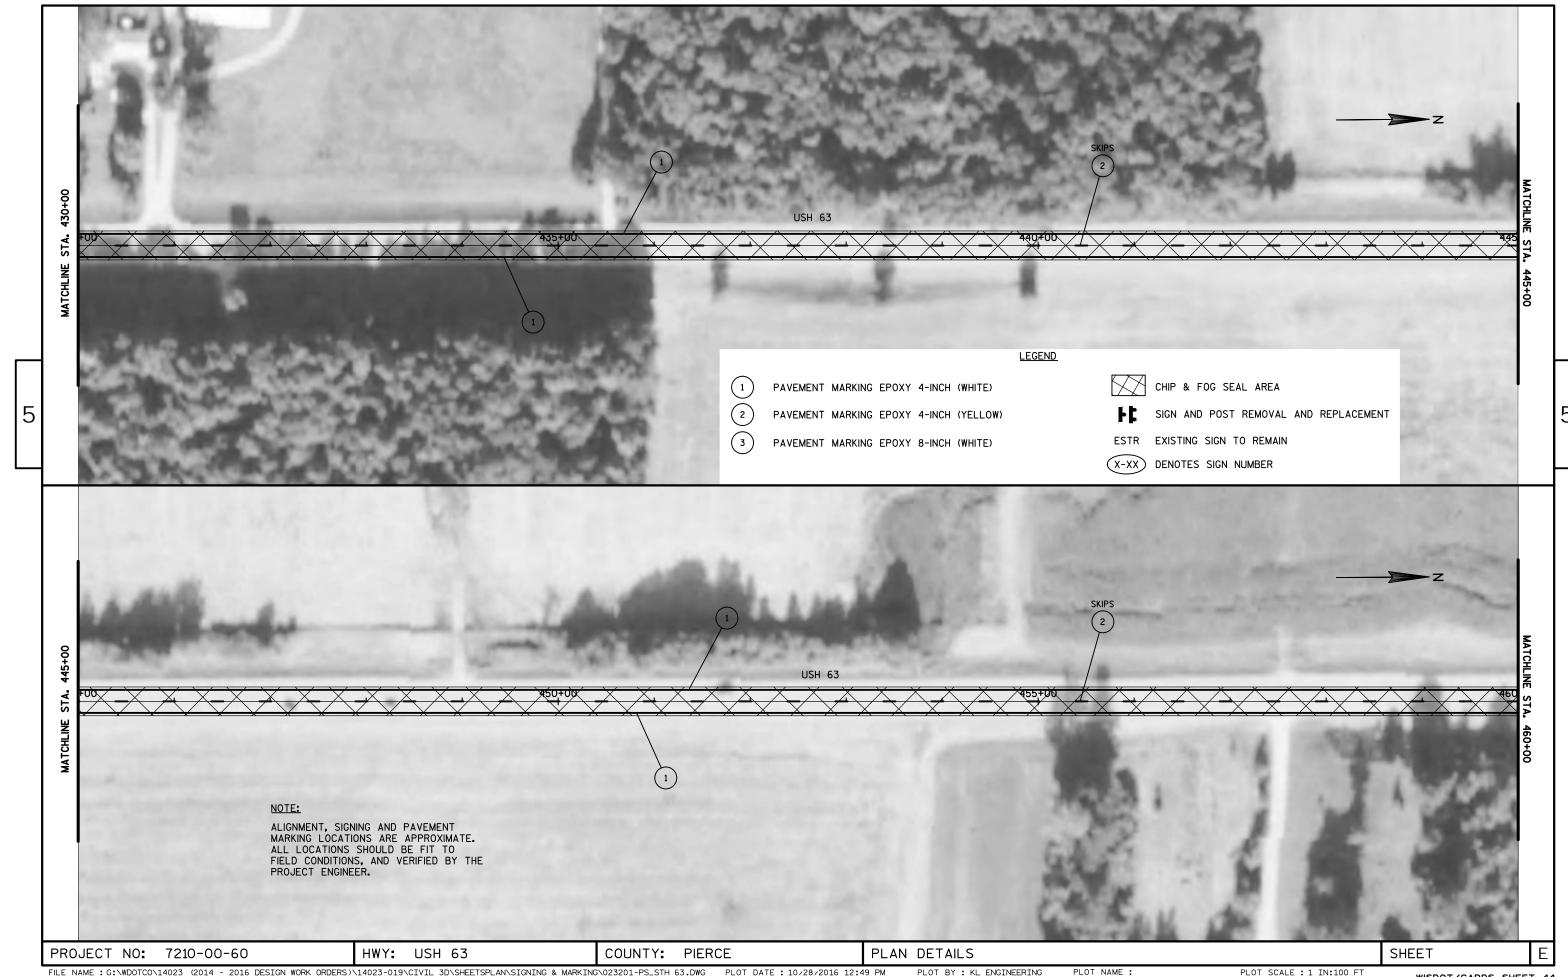


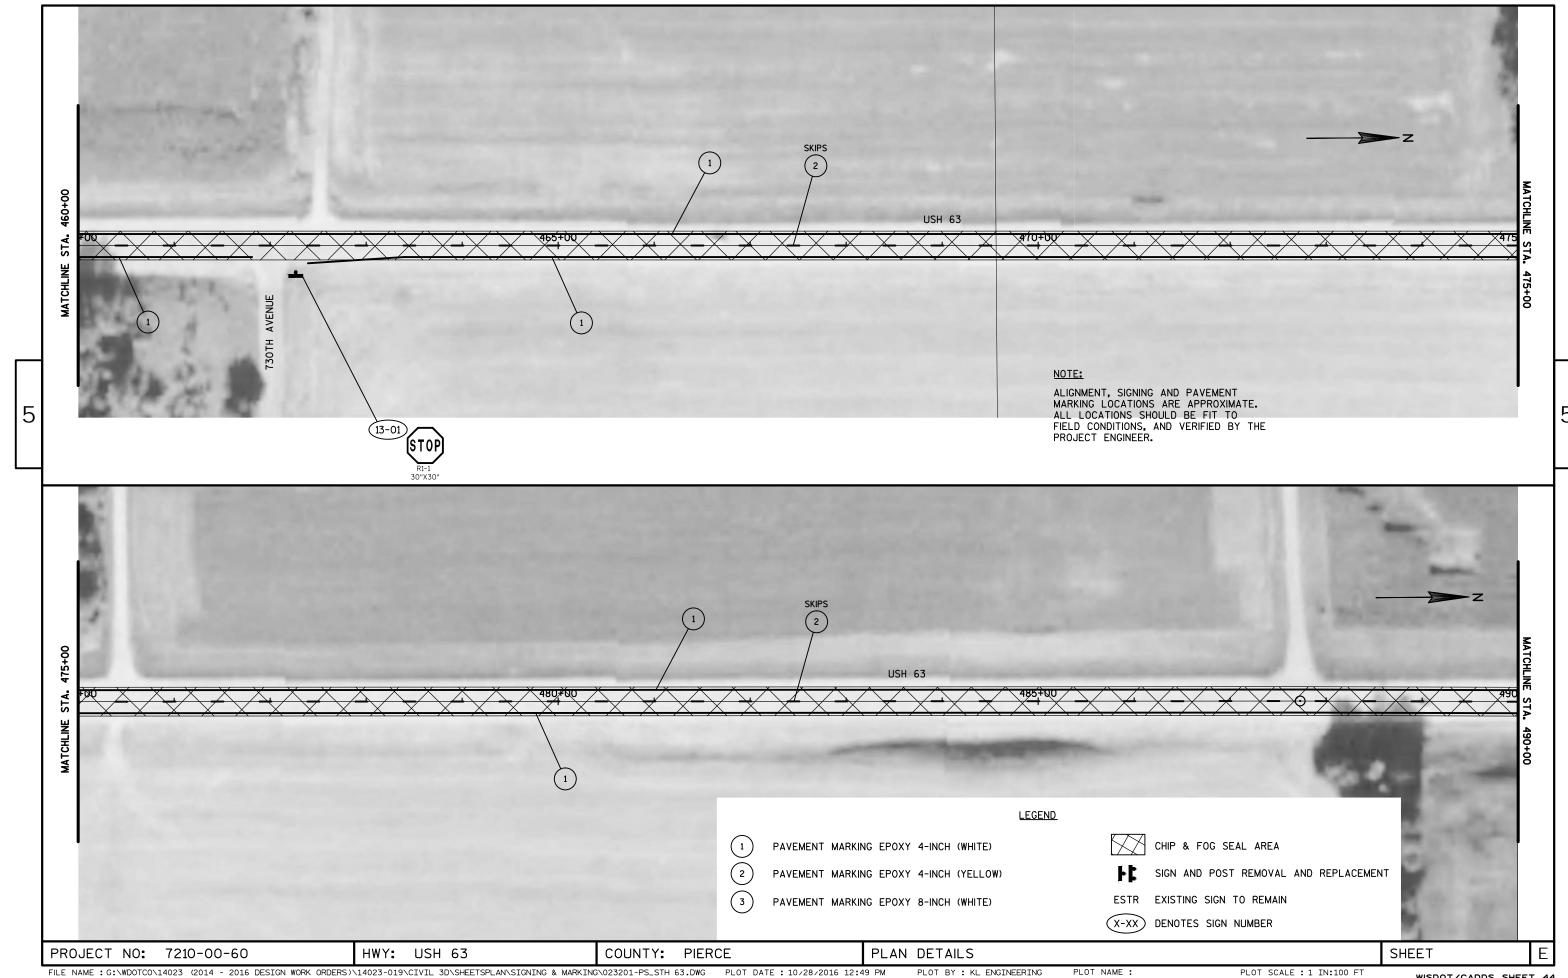


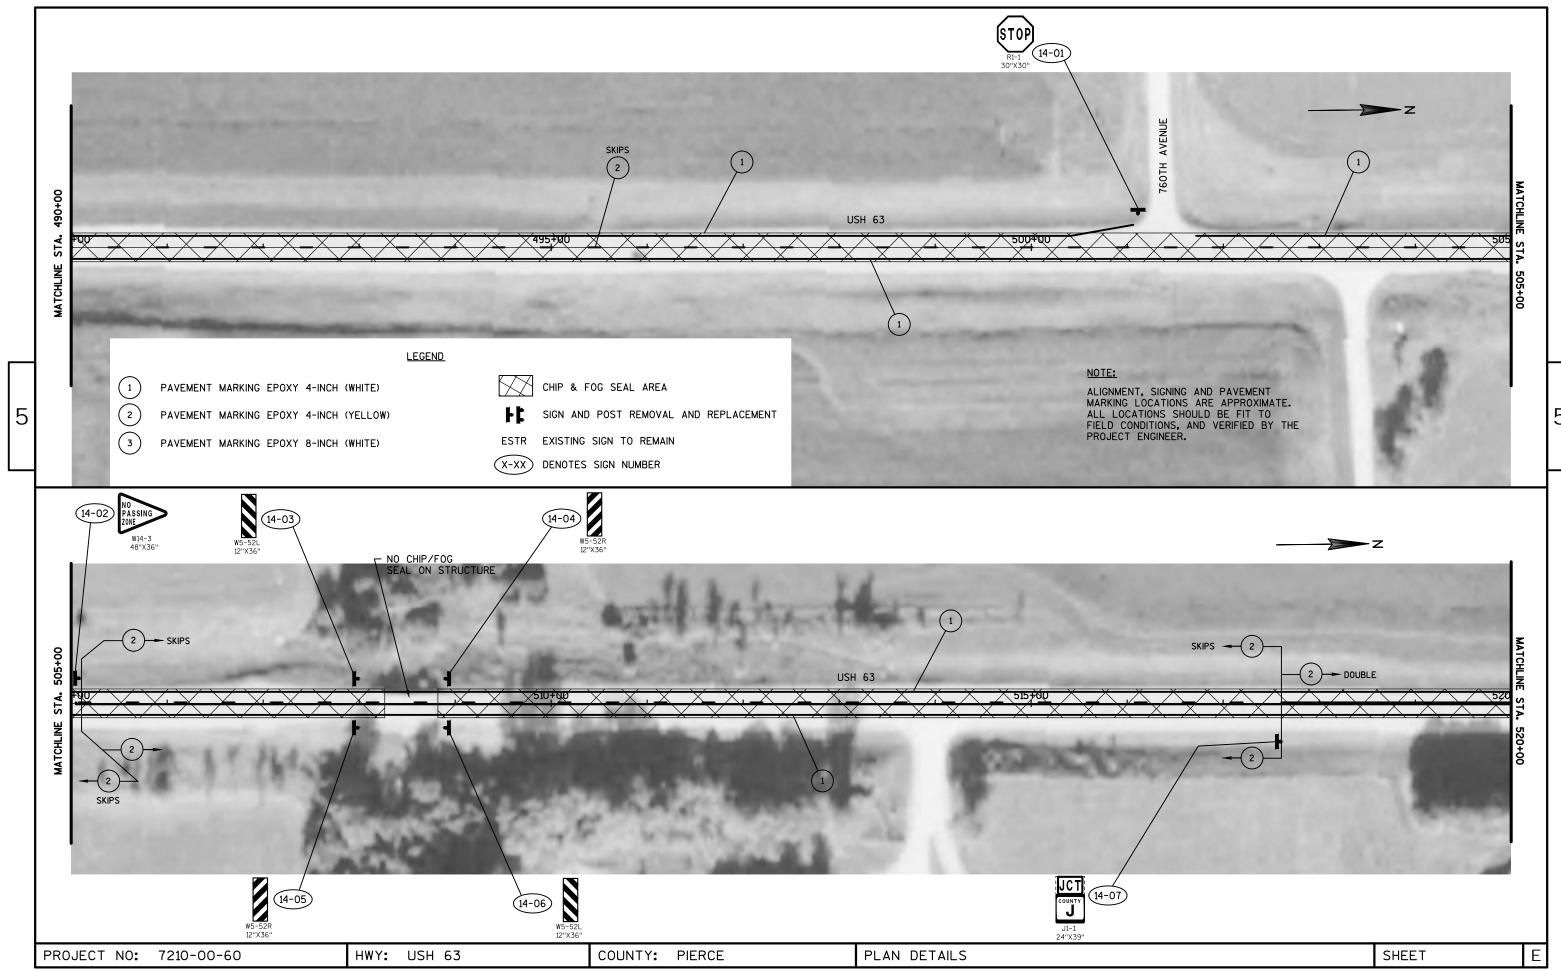


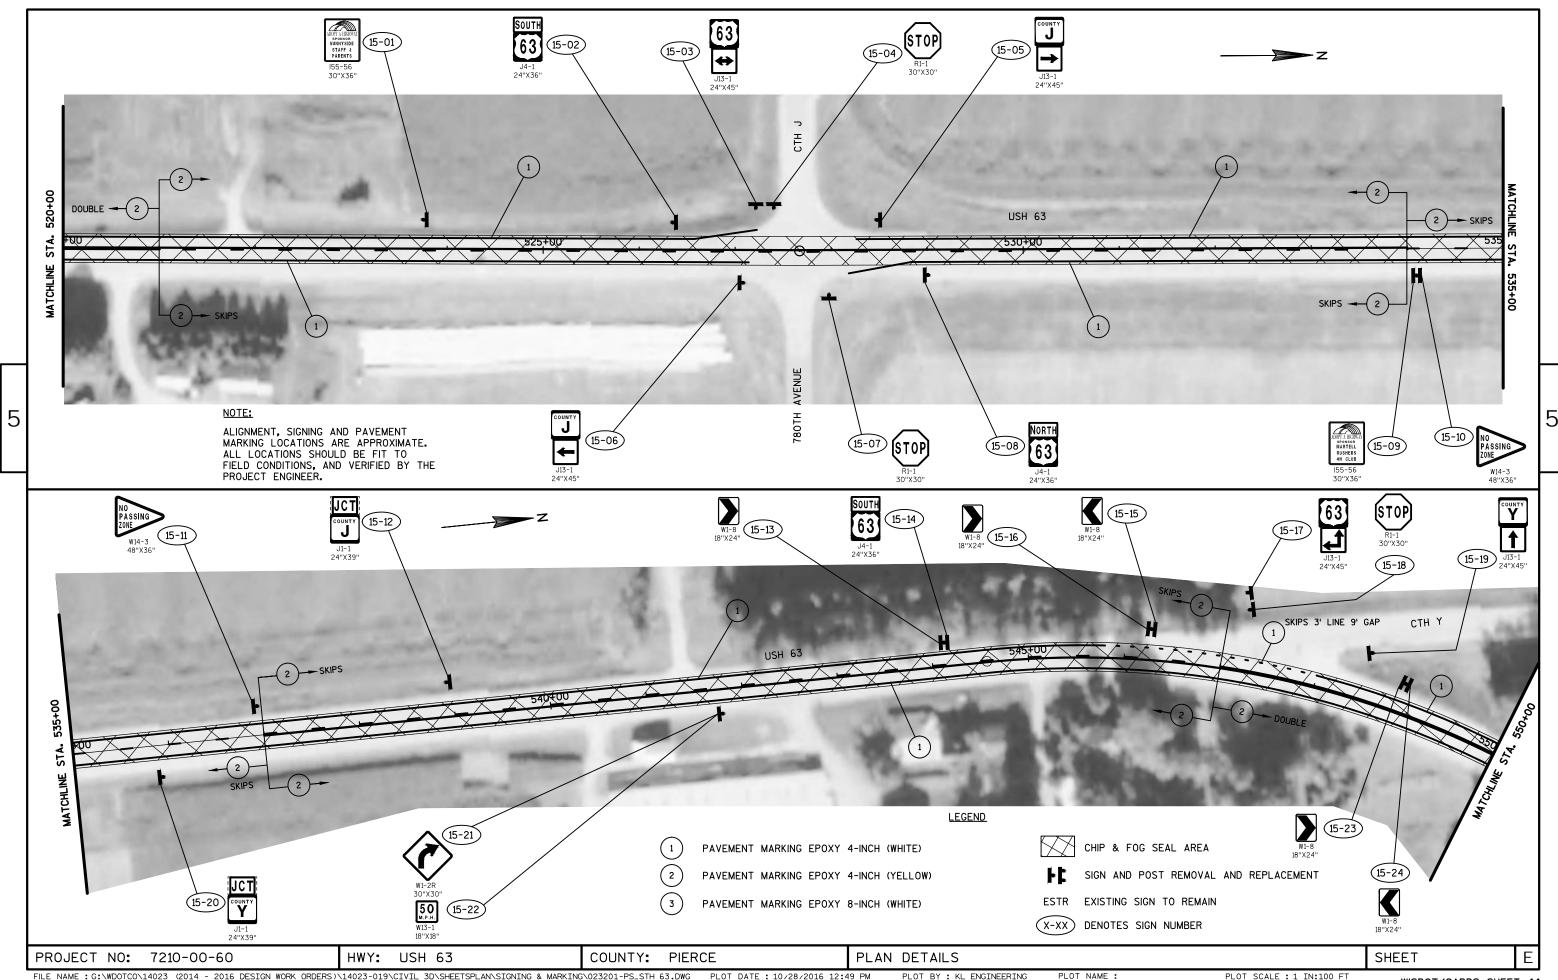

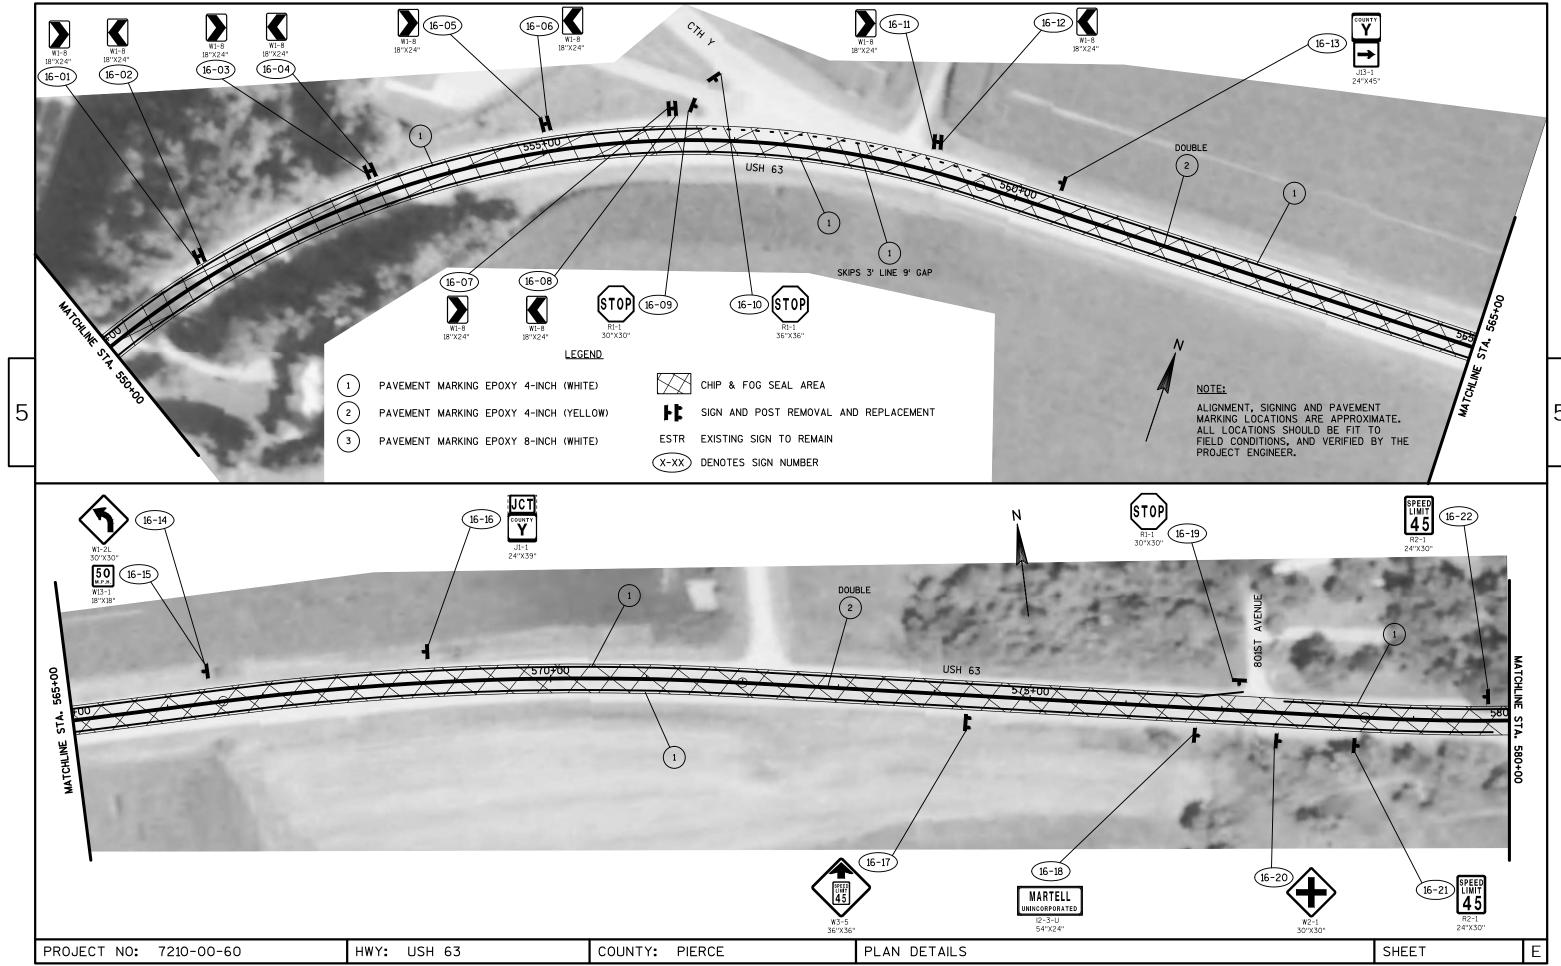

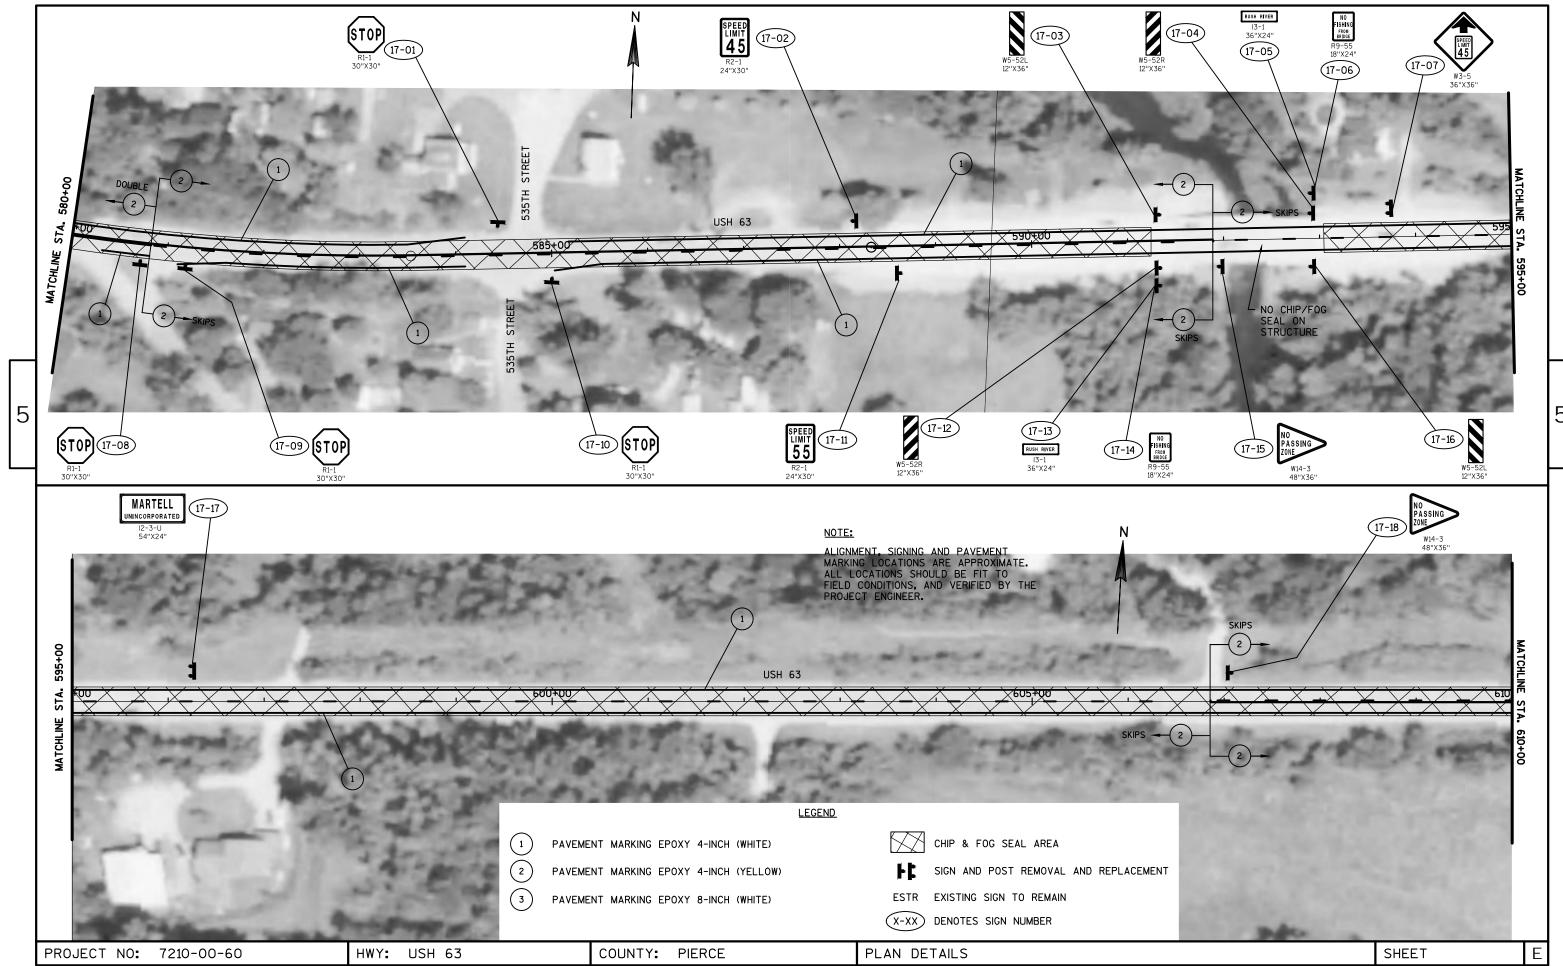

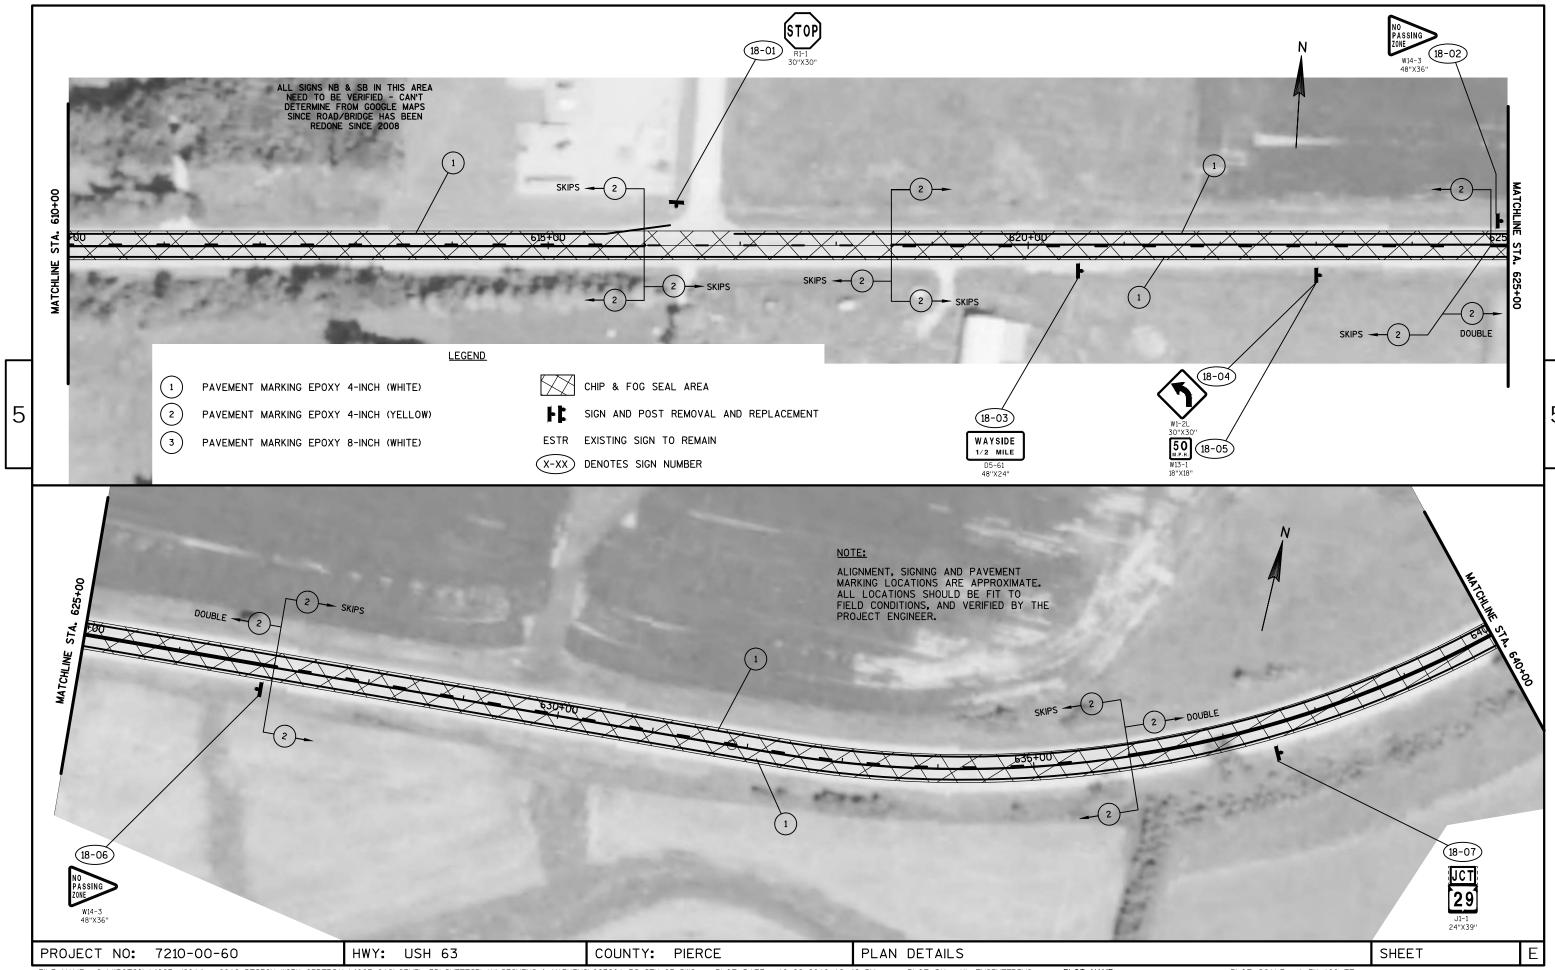

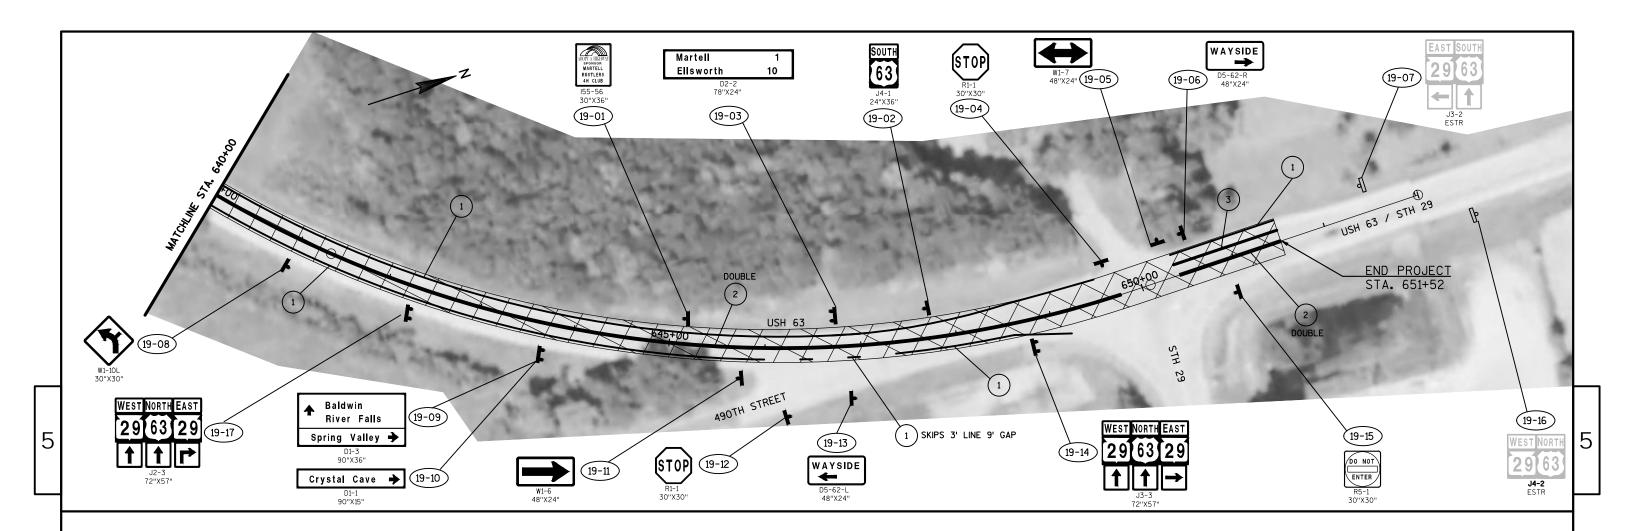

<u>LEGEND</u>

1 PAVEMENT MARKING EPOXY 4-INCH (WHITE)

PAVEMENT MARKING EPOXY 4-INCH (YELLOW)

3 PAVEMENT MARKING EPOXY 8-INCH (WHITE)

CHIP & I

CHIP & FOG SEAL AREA

|| | | |

SIGN AND POST REMOVAL AND REPLACEMENT

ESTR EXISTING SIGN TO REMAIN

X-XX DENOTES SIGN NUMBER

EXISTING SIGN POST(S) TO REMAIN

ALIGNMENT, SIGNING AND PAVEMENT MARKING LOCATIONS ARE APPROXIMATE. ALL LOCATIONS SHOULD BE FIT TO FIELD CONDITIONS, AND VERIFIED BY THE PROJECT ENGINEER.

NOTE:

PROJECT NO: 7210-00-60 HWY: USH 63 COUNTY: PIERCE PLAN DETAILS SHEET E

Standard Detail Drawing List

08E10-02	INLET PROTECTION TYPE A, B, C AND D		
15C04-03	TRAFFIC CONTROL, ADVANCE WARNING SIGNS 45 M.P.H. OR GREATER TWO-WAY UNDIVIDED ROAD OPEN TO TRAFFIC		
15C05-03	TRAFFIC CONTROL, ADVANCE WARNING SIGNS 40 M.P.H. OR LESS		
15C06-08	SIGNING & MARKING FOR TWO LANE BRIDGES		
15C07-13B	PAVEMENT MARKING WORDS		
15C07-13C	PAVEMENT MARKING ARROWS		
15C08-16A	PAVEMENT MARKING (MAINLINE)		
15C08-16B	PAVEMENT MARKING (INTERSECTIONS)		
15C08-16C	PAVEMENT MARKING (CLIMBING LANE & PASSING LANE)		
15C08-16D	PAVEMENT MARKING (CLIMBING LANE & PASSING LANE)		
15C08-16E	PAVEMENT MARKING (LEFT TURN LANE)		
15C12-04	TRAFFIC CONTROL FOR LANE CLOSURE (SUITABLE FOR MOVING OPERATIONS)		
15C19-04A	MOVING PAVEMENT MARKING OPERATION TWO-LANE TWO-WAY ROADWAY		
15C33-02	STOP LINE AND CROSSWALK PAVEMENT MARKING		
15C34-01	STANDARD APPLICATION FOR TEMPORARY RAISED PAVEMENT MARKER, TYPE 2		
15D28-03	TRAFFIC CONTROL, WORK ON SHOULDER OR PARKING LANE, UNDIVIDED ROADWAY		
15C08-16B 15C08-16C 15C08-16D 15C08-16E 15C12-04 15C19-04A 15C33-02 15C34-01	PAVEMENT MARKING (INTERSECTIONS) PAVEMENT MARKING (CLIMBING LANE & PASSING LANE) PAVEMENT MARKING (CLIMBING LANE & PASSING LANE) PAVEMENT MARKING (CLIMBING LANE & PASSING LANE) PAVEMENT MARKING (LEFT TURN LANE) TRAFFIC CONTROL FOR LANE CLOSURE (SUITABLE FOR MOVING OPERATIONS) MOVING PAVEMENT MARKING OPERATION TWO-LANE TWO-WAY ROADWAY STOP LINE AND CROSSWALK PAVEMENT MARKING STANDARD APPLICATION FOR TEMPORARY RAISED PAVEMENT MARKER, TYPE 2		

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INLET PROTECTION, TYPE A

GENERAL NOTES

INLET PROTECTION DEVICES SHALL BE MAINTAINED OR REPLACED AT THE DIRECTION OF THE ENGINEER.

MANUFACTURED ALTERNATIVES APPROVED AND LISTED ON THE DEPARTMENT'S EROSION CONTROL PRODUCT ACCEPTABILITY LIST MAY BE

WHEN REMOVING OR MAINTAINING INLET PROTECTION, CARE SHALL BE TAKEN SO THAT THE SEDIMENT TRAPPED ON THE GEOTEXTILE FABRIC DOES NOT FALL INTO THE INLET. ANY MATERIAL FALLING INTO THE INLET SHALL BE REMOVED IMMEDIATELY.

- 1) FINISHED SIZE, INCLUDING FLAP POCKETS WHERE REQUIRED, SHALL EXTEND A MINIMUM OF 10" AROUND THE PERIMETER TO FACILITATE MAINTENANCE OR REMOVAL.
- (2) FOR INLET PROTECTION, TYPE C (WITH CURB BOX), AN ADDITIONAL 18" OF FABRIC IS WRAPPED AROUND THE WOOD AND SECURED WITH STAPLES. THE WOOD SHALL NOT BLOCK THE ENTIRE HEIGHT OF THE CURB BOX OPENING.
- (3) FLAP POCKETS SHALL BE LARGE ENOUGH TO ACCEPT WOOD 2X4.



INLET PROTECTION, TYPE C (WITH CURB BOX)

INSTALLATION NOTES

TYPE B & C

TRIM EXCESS FABRIC IN THE FLOW LINE TO WITHIN 3" OF THE GRATE.

THE CONTRACTOR SHALL DEMONSTRATE A METHOD OF MAINTENANCE, USING A SEWN FLAP, HAND HOLDS OR OTHER METHOD TO PREVENT ACCUMULATED SEDIMENT FROM ENTERING THE INLET.

TYPE D

DO NOT INSTALL INLET PROTECTION TYPE D IN INLETS SHALLOWER THAN 30", MEASURED FROM THE BOTTOM OF THE INLET TO THE TOP OF THE GRATE.

TRIM EXCESS FABRIC IN THE FLOW LINE TO WITHIN 3" OF THE GRATE.

THE INSTALLED BAG SHALL HAVE A MINIMUM SIDE CLEARANCE, BETWEEN THE INLET WALLS AND THE BAG, MEASURED AT THE BOTTOM OF THE OVERFLOW HOLES, OF 3". WHERE NECESSARY THE CONTRACTOR SHALL CINCH THE BAG, USING PLASTIC ZIP TIES, TO ACHIEVE THE 3" CLEARANCE, THE TIES SHALL BE PLACED AT A MAXIMUM OF 4" FROM THE BOTTOM OF THE BAG.

INLET PROTECTION TYPE A, B, C, AND D

STATE OF WISCONSIN DEPARTMENT OF TRANSPORTATION

APPROVED

10/16/02

/S/ Beth Cannestra CHIEF ROADWAY DEVELOPMENT ENGINEER 6

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GENERAL NOTES

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THE EXACT NUMBER, LOCATION, AND SPACING OF ALL SIGNS AND DEVICES SHALL BE ADJUSTED TO FIT FIELD CONDITIONS.


THE SPACING BETWEEN TRAFFIC CONTROL SIGNS SHOULD BE ADJUSTED TO NOT CONFLICT WITH AND SHOULD PROVIDE A MINIMUM OF 200 FEET (500 FEET DESIRABLE) CLEARANCE TO EXISTING SIGNS THAT WILL REMAIN IN PLACE.

ALL SIGNS ARE 48"x48" UNLESS OTHERWISE NOTED.

SIGNS THAT WILL BE IN PLACE LESS THAN 7 CONTINUOUS DAYS AND NIGHTS MAY BE MOUNTED ON PORTABLE SUPPORTS.

IF A "STOP" SIGN MUST BE REMOVED FOR A WORK OPERATION, A TEMPORARY "STOP" SIGN SHALL BE PLACED PRIOR TO THE SIGN REMOVAL, OR A FLAGGER SHALL BE PROVIDED UNTIL THE SIGN IS RE-ESTABLISHED.

- * OMIT G20-1 SIGNS IF LENGTH OF WORK AREA IS 2 MILES OR LESS.
- * PLACE ADDITIONAL W20-1A "ROAD WORK AHEAD" SIGN IF WORK AREA WITHIN THE PROJECT IS SEPARATED BY MORE THAN 2 MILES FROM PREVIOUS WORK AREA.

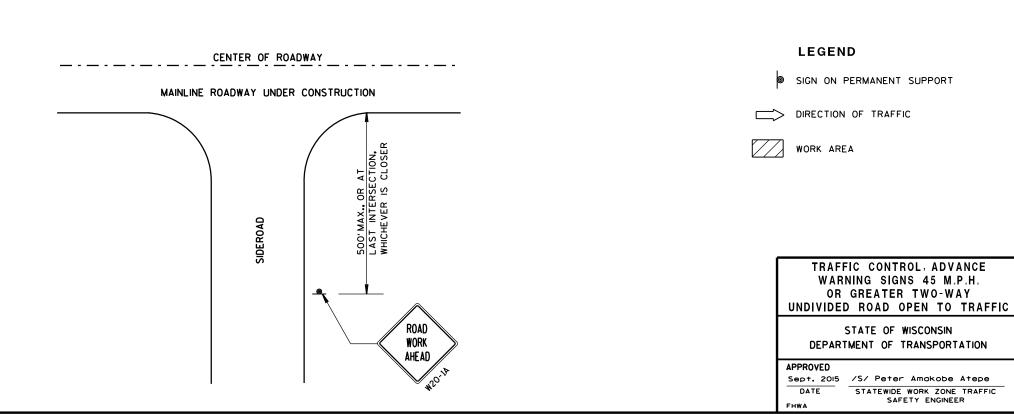

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SAFETY ENGINEER

GENERAL NOTES

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THE EXACT NUMBER, LOCATION, AND SPACING OF ALL SIGNS AND DEVICES SHALL BE ADJUSTED TO FIT FIELD CONDITIONS.


THE SPACING BETWEEN TRAFFIC CONTROL SIGNS SHOULD BE ADJUSTED TO NOT CONFLICT WITH AND SHOULD PROVIDE A DESIRABLE MINIMUM OF 200 FEET CLEARANCE TO EXISTING SIGNS THAT WILL REMAIN IN PLACE.

ALL SIGNS ARE 48"×48" UNLESS OTHERWISE NOTED. IF NECESSARY DUE TO SPACE CONSTRAINTS, 36"×36" SIGNS MAY BE USED INSTEAD OF 48"×48" SIGNS.

SIGNS THAT WILL BE IN PLACE LESS THAN 7 CONTINUOUS DAYS AND NIGHTS MAY BE MOUNTED ON PORTABLE SUPPORTS.

IF A "STOP" SIGN MUST BE REMOVED FOR A WORK OPERATION, A TEMPORARY "STOP" SIGN SHALL BE PLACED PRIOR TO THE SIGN REMOVAL, OR A FLAGGER SHALL BE PROVIDED UNTIL THE SIGN IS RE-ESTABLISHED.


★ THE THIRD W20-1 SIGN IS REQUIRED ONLY IF THERE IS AN INTERSECTION BETWEEN THE "ROAD WORK 500 FT" SIGN AND THE WORK ZONE. ADJUST THE PLACEMENT OF THIS SIGN BASED ON INTERSECTION LOCATION AND OTHER FIELD CONDITIONS.

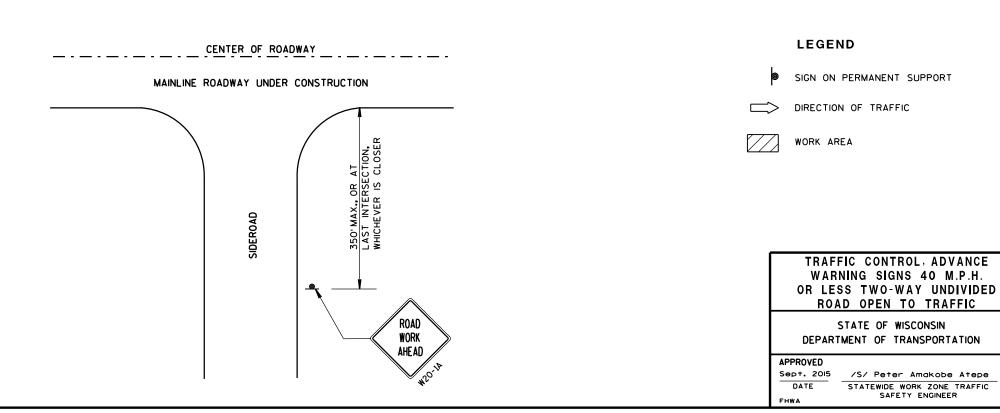



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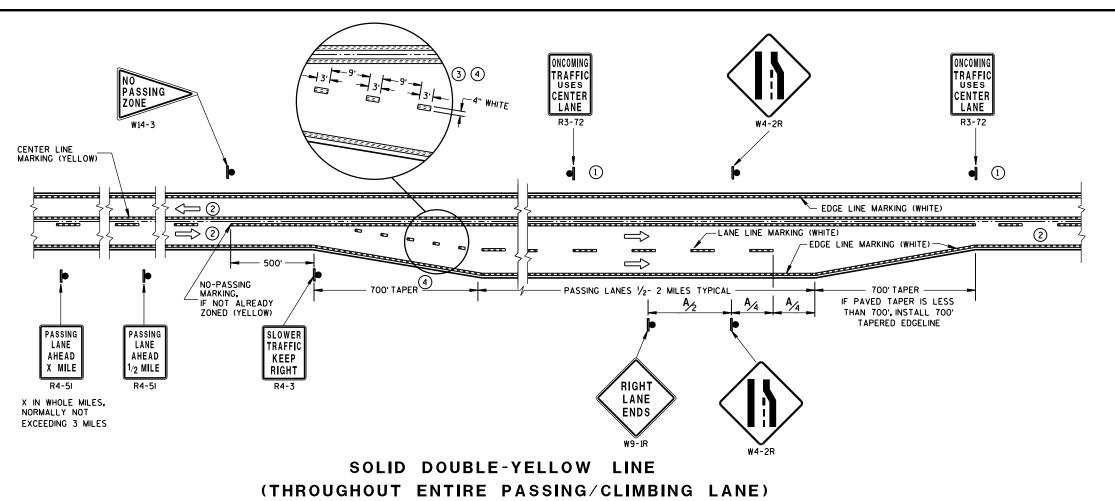






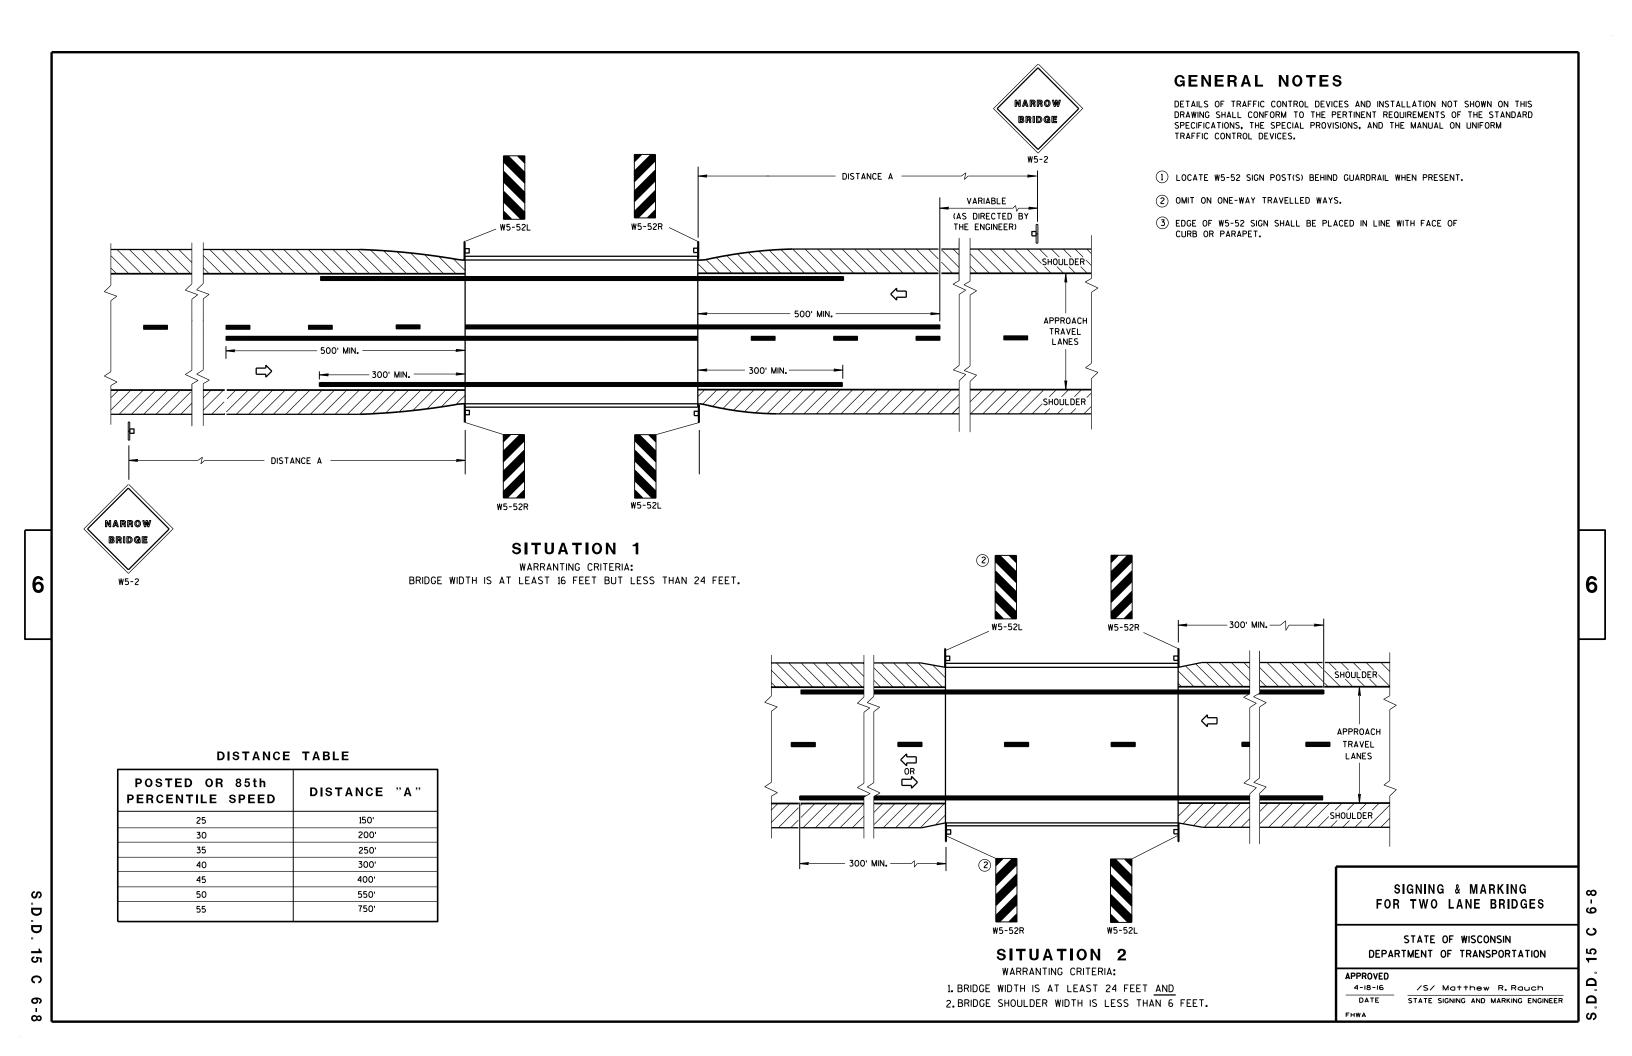

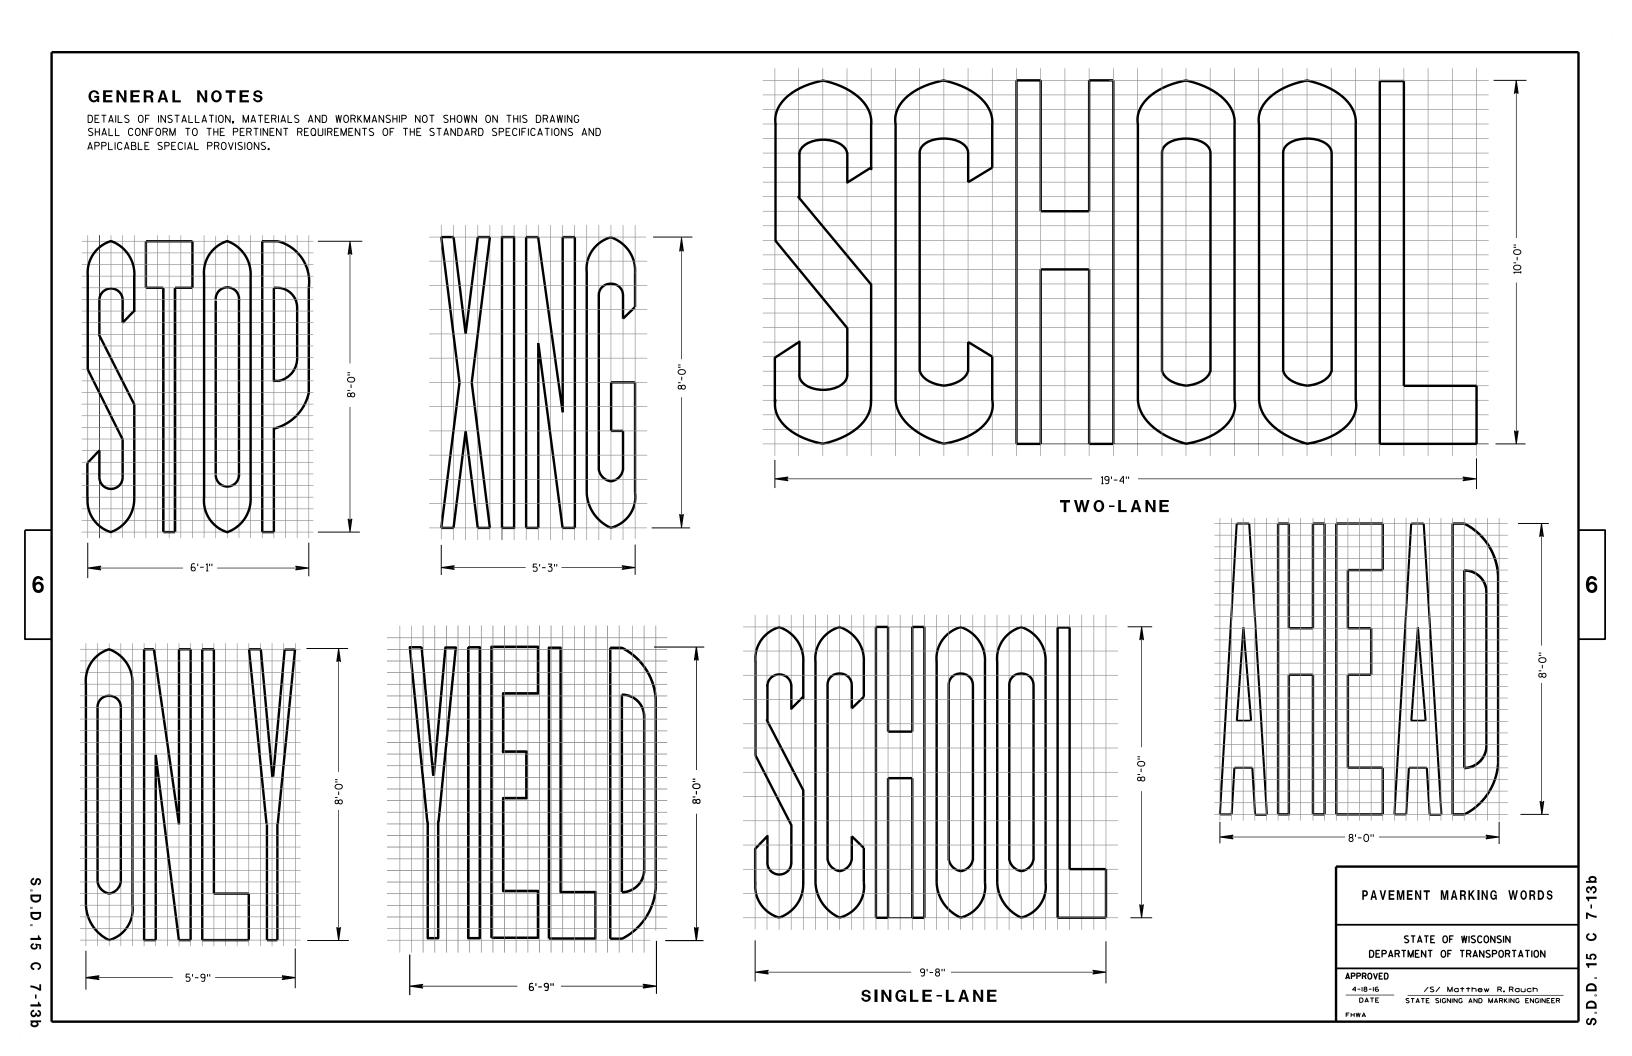

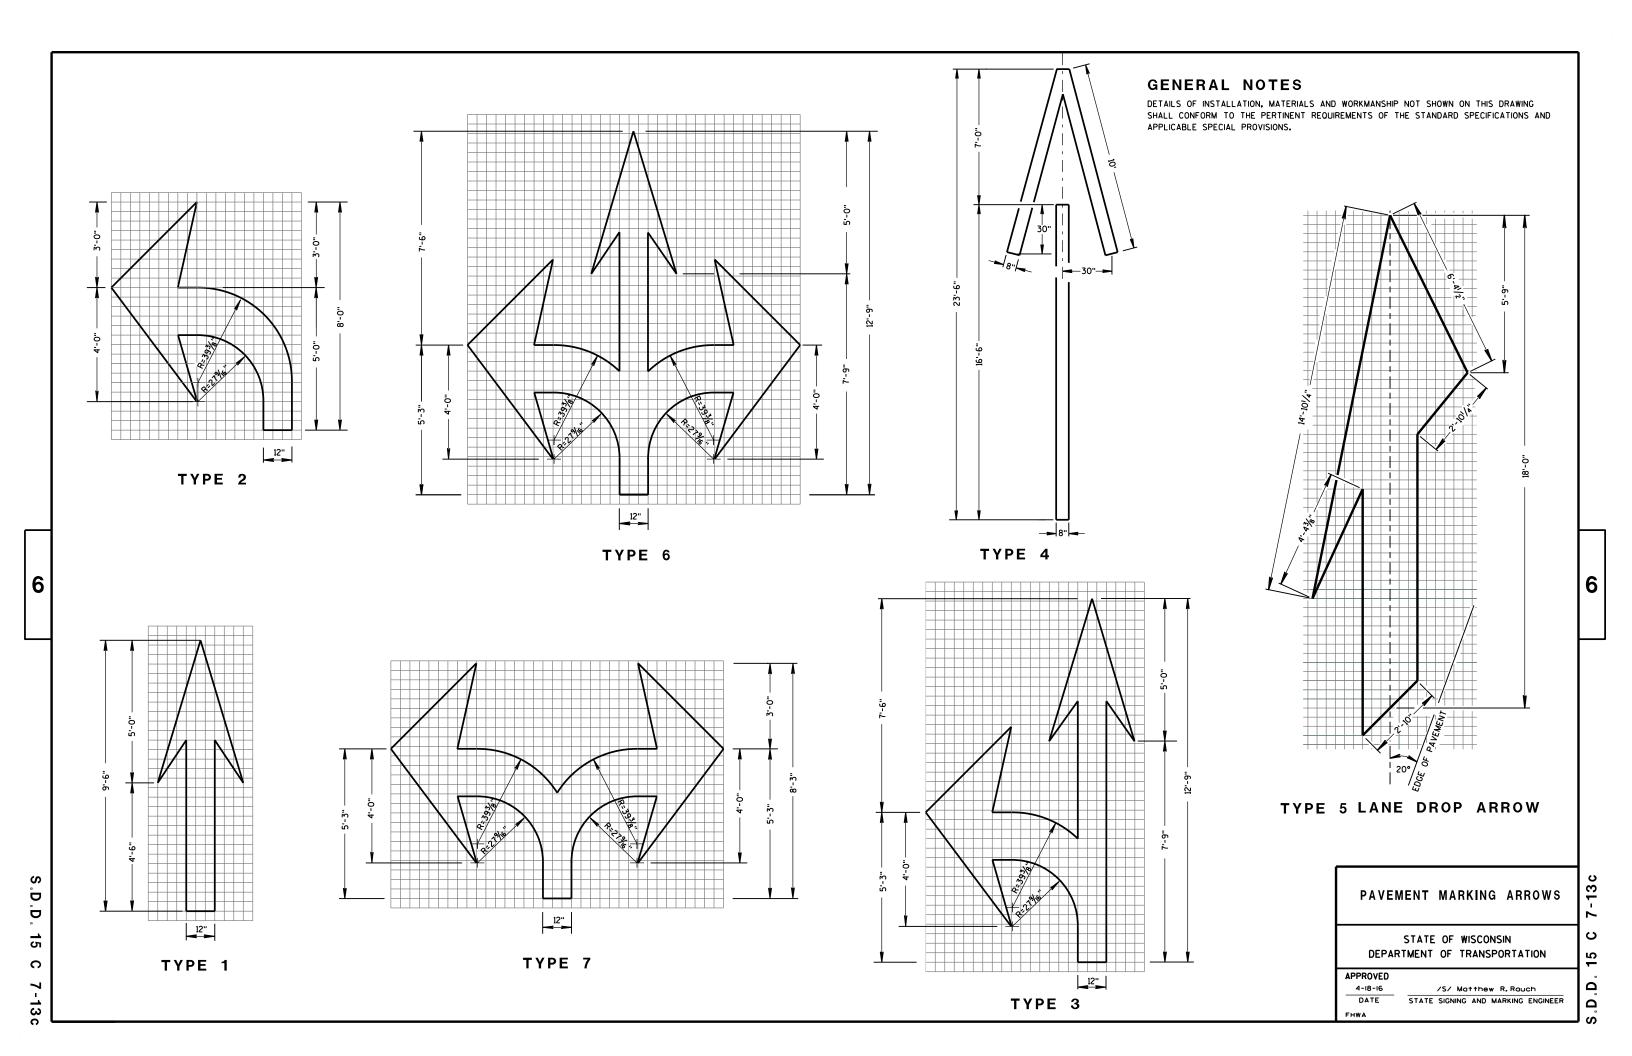


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GENERAL NOTES

- $\ensuremath{\bigcirc}$ Sign shall be repeated at 1 mile increments or at the discretion of the regional traffic engineer.
- (2) THERE MAY BE SOLID YELLOW ON THE CENTERLINE DUE TO SIGHT CONDITIONS.
- 3 THE TAPER LENGTH OF THE DOTTED LINE PAVEMENT MARKING SHALL BE 700 FEET, 3'LINE 9'GAP, EXCEPT RETRACE THE EXISTING LINE-GAP PATTERN WHERE EXISTING MARKINGS ARE IN PLACE.
- WHEN THE ENTRANCE TAPER IS LESS THAN 700 FEET OR THE SHOULDER WIDTH IN THE PASSING/CLIMBING LANE IS LESS THAN THE ADJACENT HIGHWAY, DO NOT INSTALL DOTTED LINE PAVEMENT MARKING.

ARROW SYMBOL (>>) SHOWS DIRECTION OF TRAVEL

DISTANCE TABLE

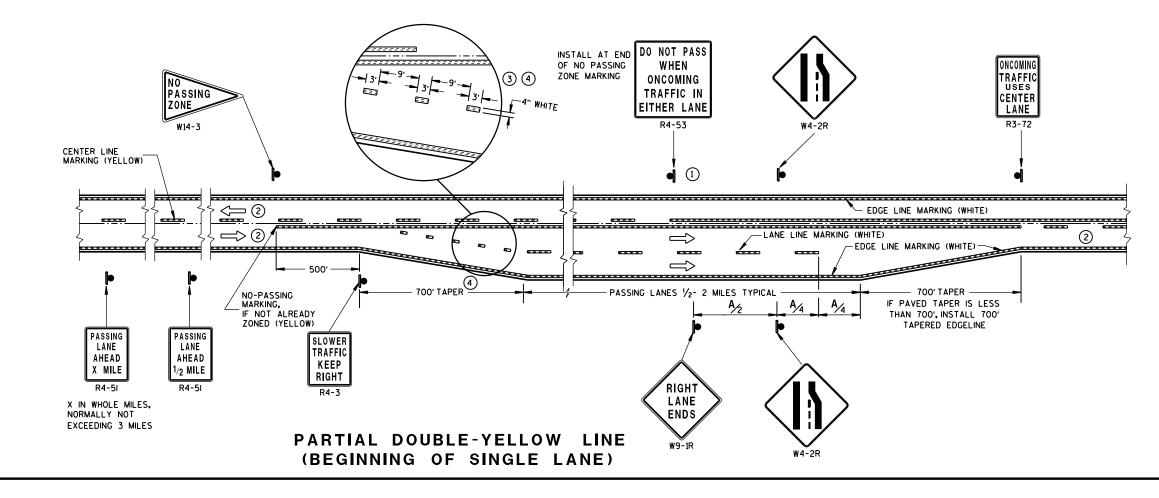POSTED OR 85th PERCENTILE SPEED	DISTANCE "A"
45	750
50	850
55	950


PAVEMENT MARKING & SIGNING
(CLIMBING LANE &
PASSING LANE)

STATE OF WISCONSIN
DEPARTMENT OF TRANSPORTATION

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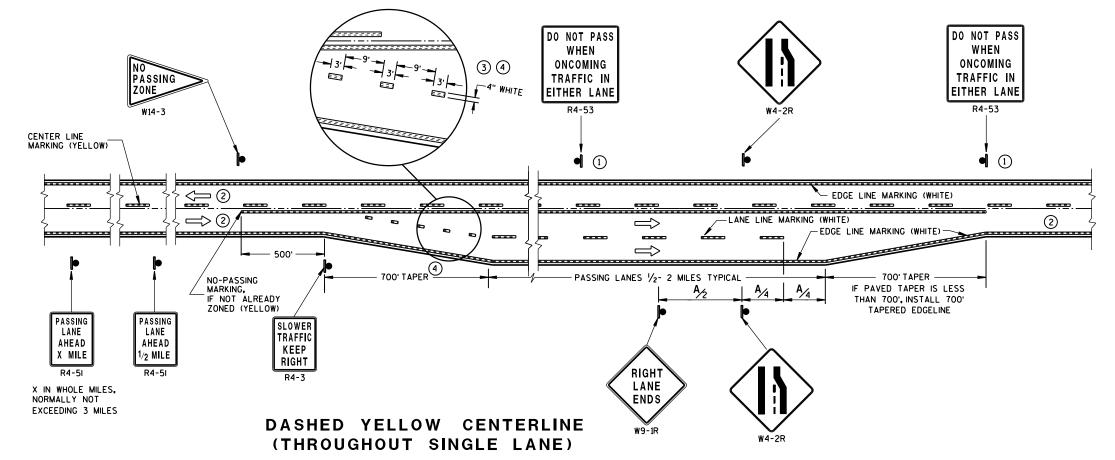
GENERAL NOTES

- \bigodot Sign shall be repeated at $\ensuremath{\mathcal{V}}_2$ mile increments or at the discretion of the regional traffic engineer.
- (2) THERE MAY BE SOLID YELLOW ON THE CENTERLINE DUE TO SIGHT CONDITIONS.
- THE TAPER LENGTH OF THE DOTTED LINE PAVEMENT MARKING SHALL BE 700 FEET, 3'LINE 9'GAP, EXCEPT RETRACE THE EXISTING LINE-GAP PATTERN WHERE EXISTING MARKINGS ARE IN PLACE.
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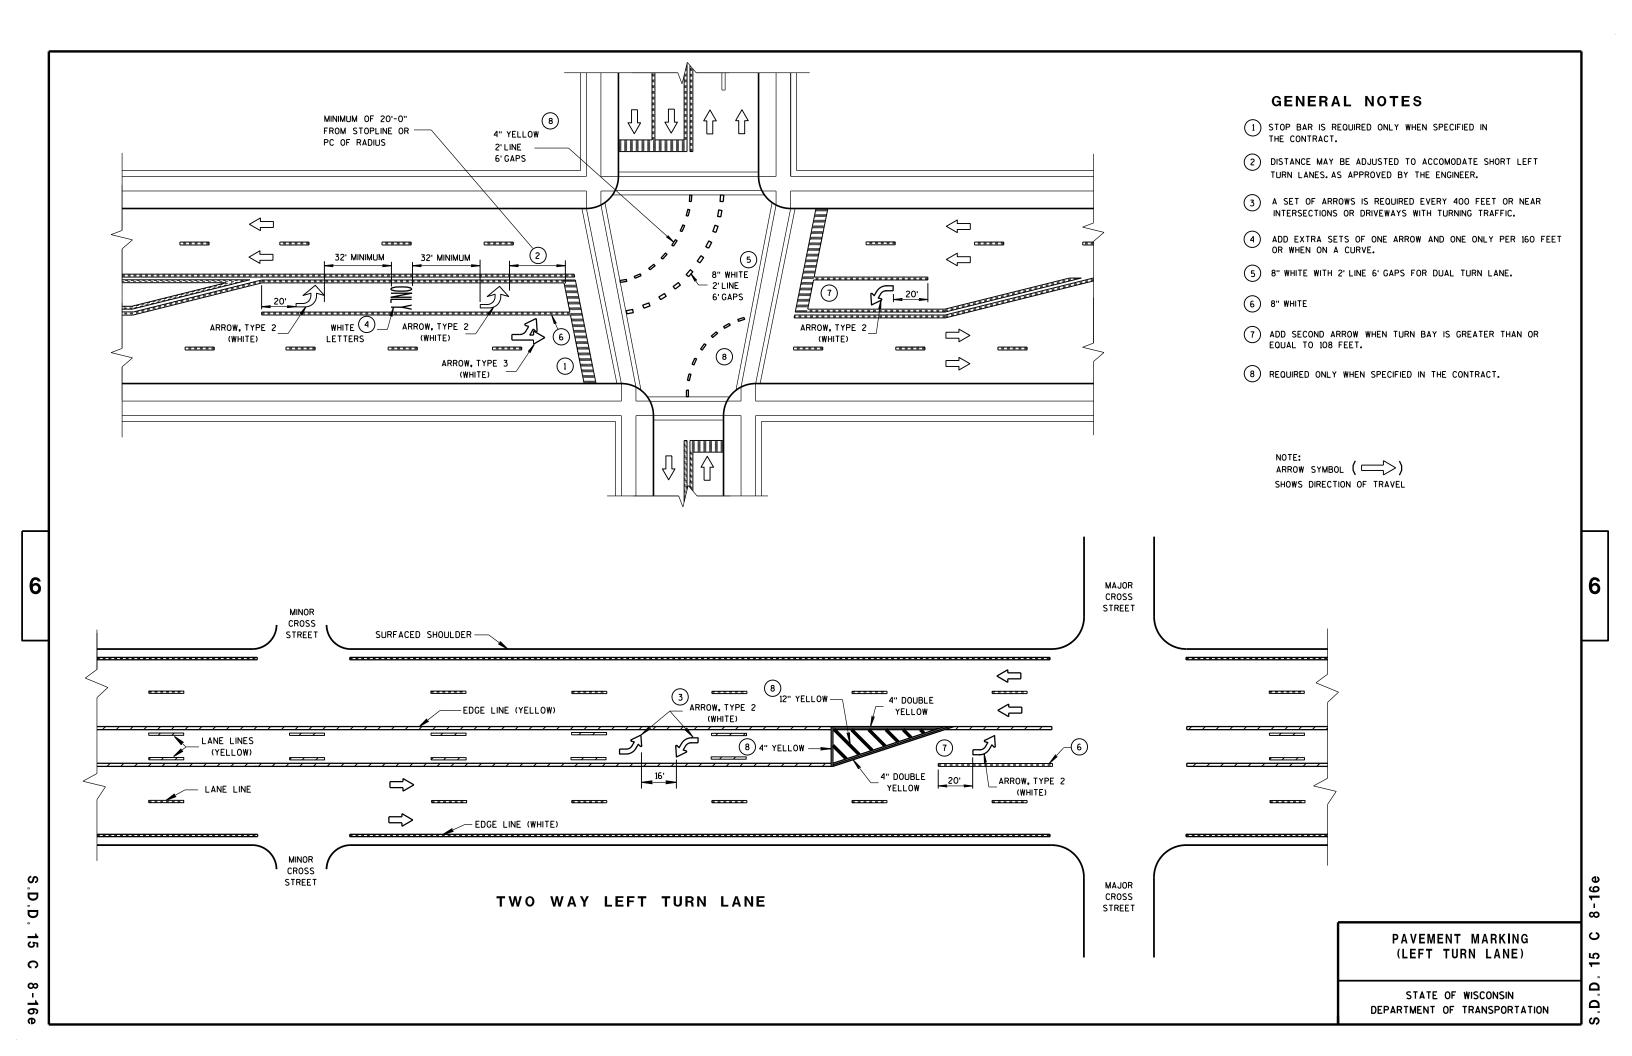


PAVEMENT MARKING & SIGNING (CLIMBING LANE & PASSING LANE)

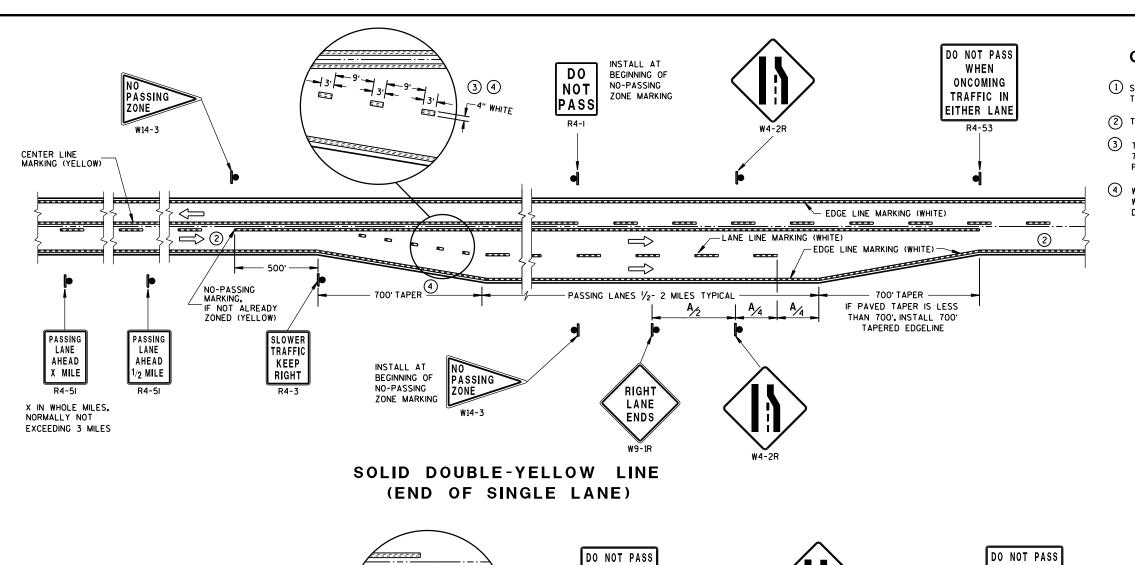
STATE OF WISCONSIN DEPARTMENT OF TRANSPORTATION


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8" CHANNELIZATION WHITE


FLANGELINE (EXTENSION)

4" WHITE EDGELINE


RI-1 STOP SIGN

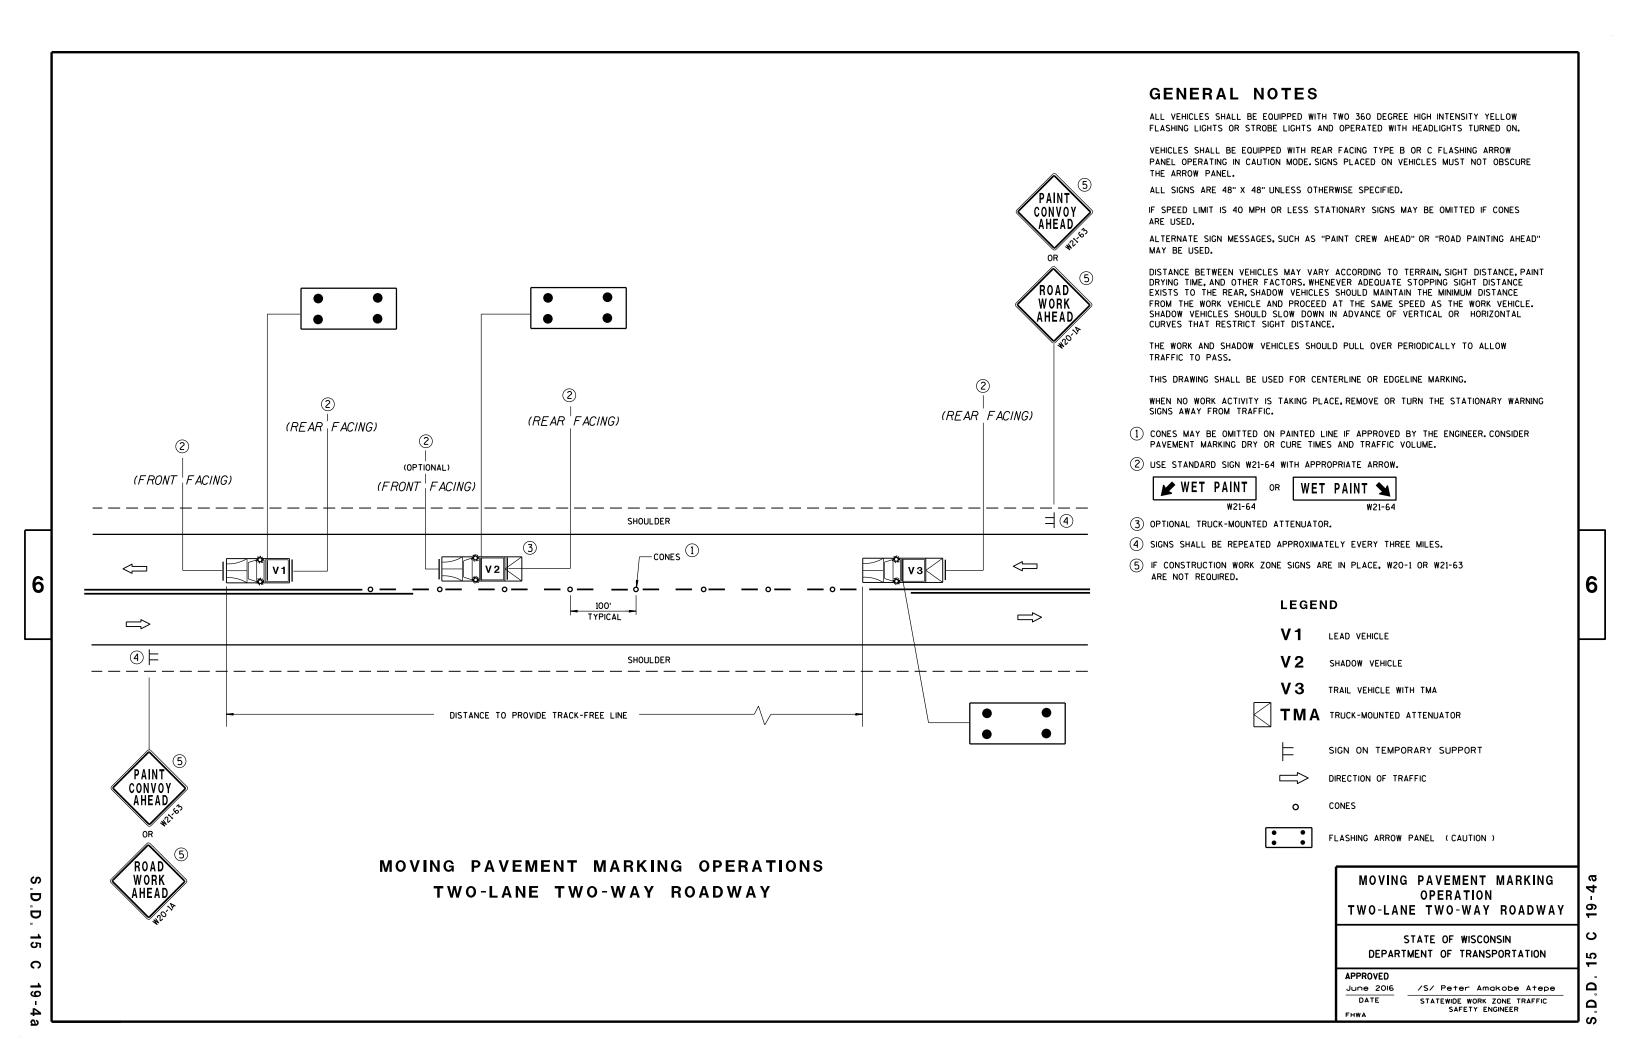TYPICAL STOP LINE PAVEMENT MARKING WITH CURB AND GUTTER

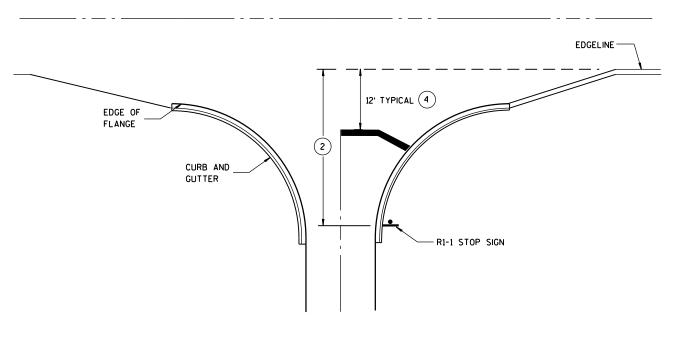TYPICAL STOP LINE PAVEMENT MARKING FOR SIDEROADS WITH RIGHT TURN LANE

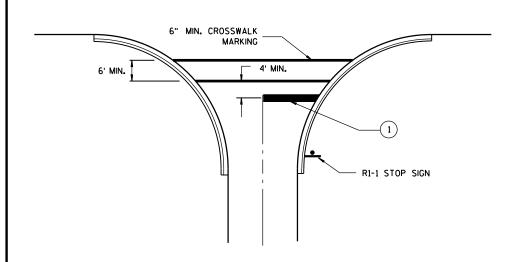

TYPICAL STOP LINE PAVEMENT MARKING FOR SIDEROADS WITH CROSSWALK MARKING

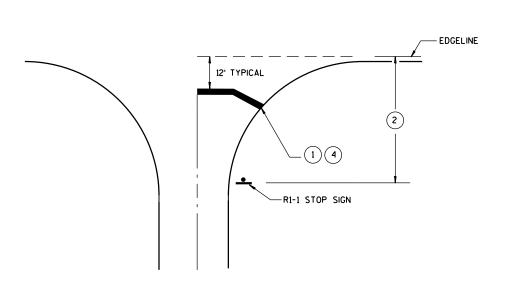

TYPICAL STOP LINE PAVEMENT MARKING WITHOUT CURB AND GUTTER

GENERAL NOTES

- 1 18-INCH STOP LINES MAY BE DELETED OR ADDED BY THE PROJECT ENGINEER BASED ON VISIBILITY AND SIGHT LINES.
- (2) IF STOP SIGN IS LESS THAN OR EQUAL TO 40 FEET FROM THE EDGELINE THAN NO STOP LINE IS REQUIRED.
- (3) IF STOP SIGN IS LESS THAN OR EQUAL TO 30 FEET FROM THE FLANGELINE EXTENSION THAN NO STOP LINE IS REQUIRED.
- MOVE CLOSER TO EDGE OF TRAVEL LANE AS NEEDED FOR VISIBILITY AND SIGHT LINES. (NO CLOSER THAN 4 FEET).

STOP LINE AND CROSSWALK PAVEMENT MARKING

STATE OF WISCONSIN
DEPARTMENT OF TRANSPORTATION

APPROVED	
4-18-2016	/S/ Matthew R. Rauch
DATE	STATE SIGNING AND MARKING ENGINEER

.D.D. 15 C 33-2


6

. D . D .


က

15

6

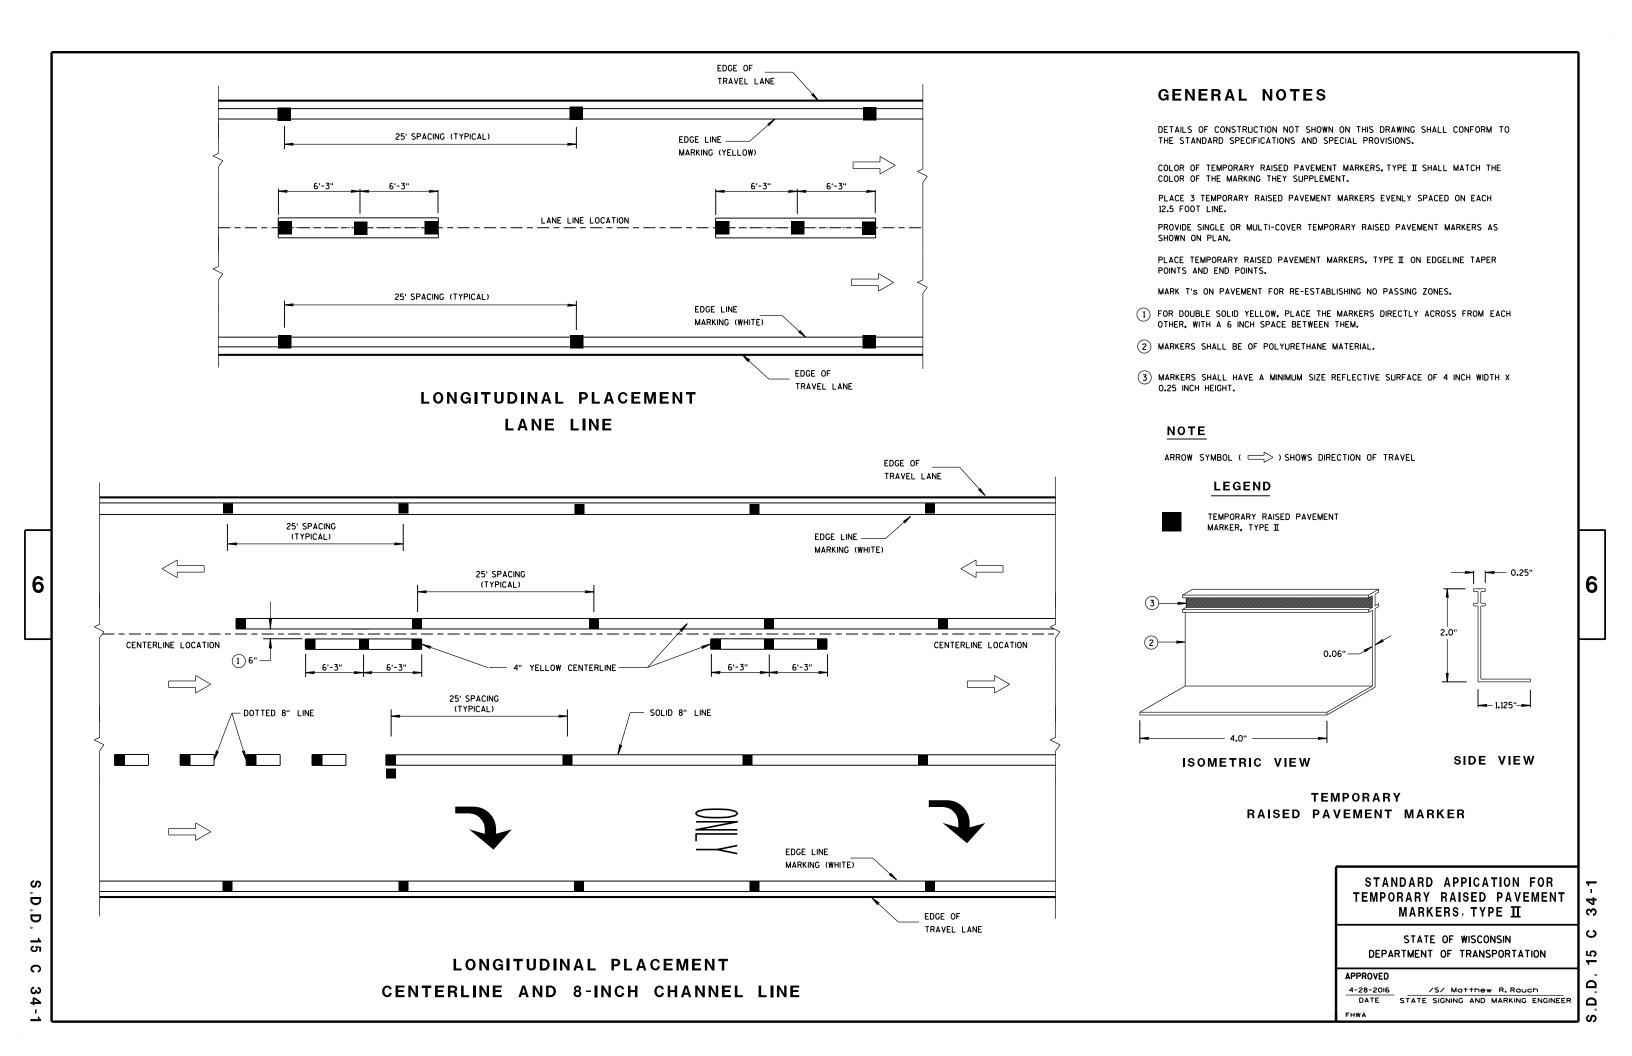



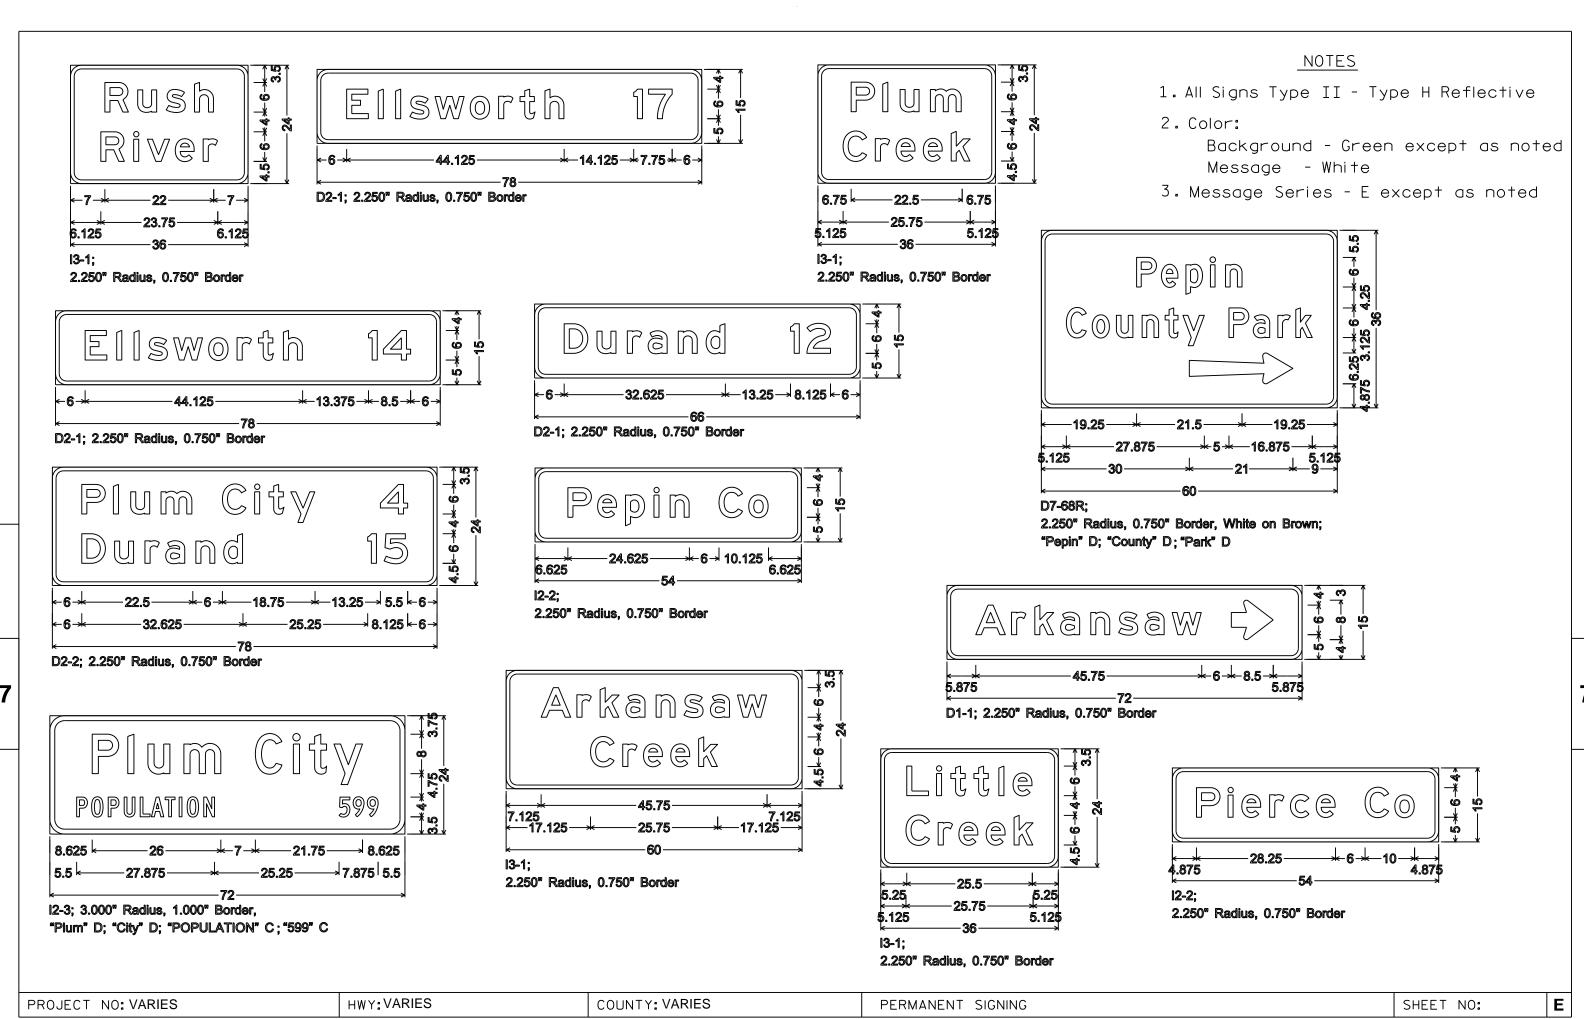


FILE NAME · C·\CAFfiles\Projects\tr d6\64740016 DGN


PLOT DATE . 02-NOV-2016 10.42

PINT RY . \$\$ NINTUSER \$\$ PINT NAME

PLOT SCALE . 19 458419.1 000000

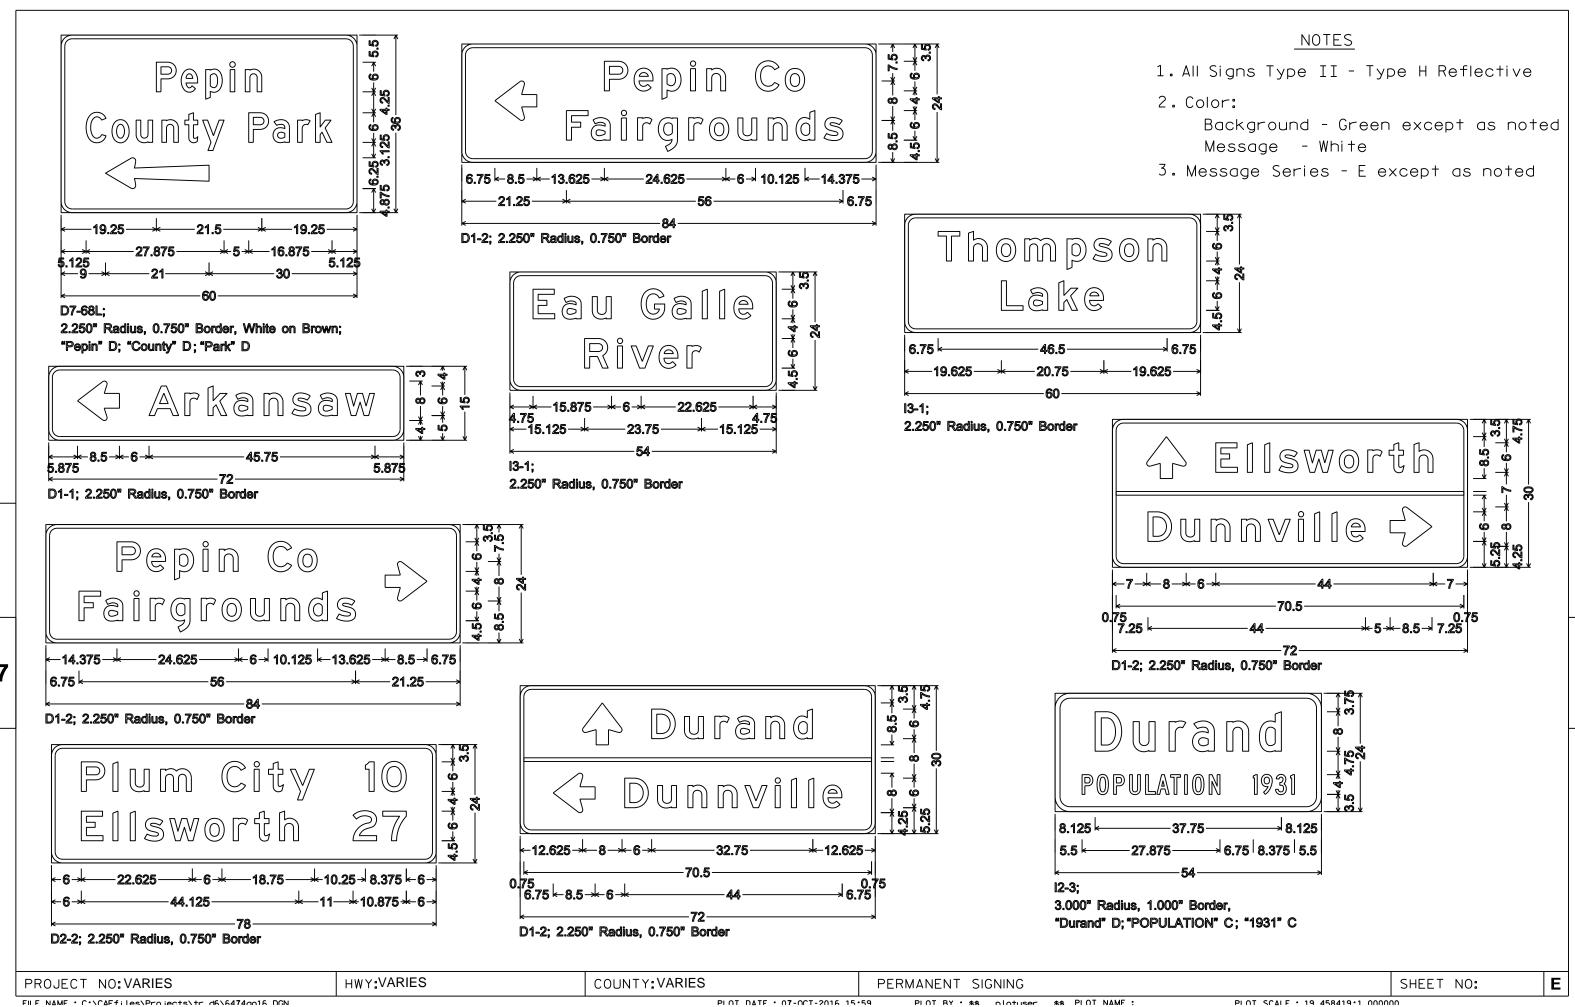


PLOT DATE . 07-001-2016 15:59

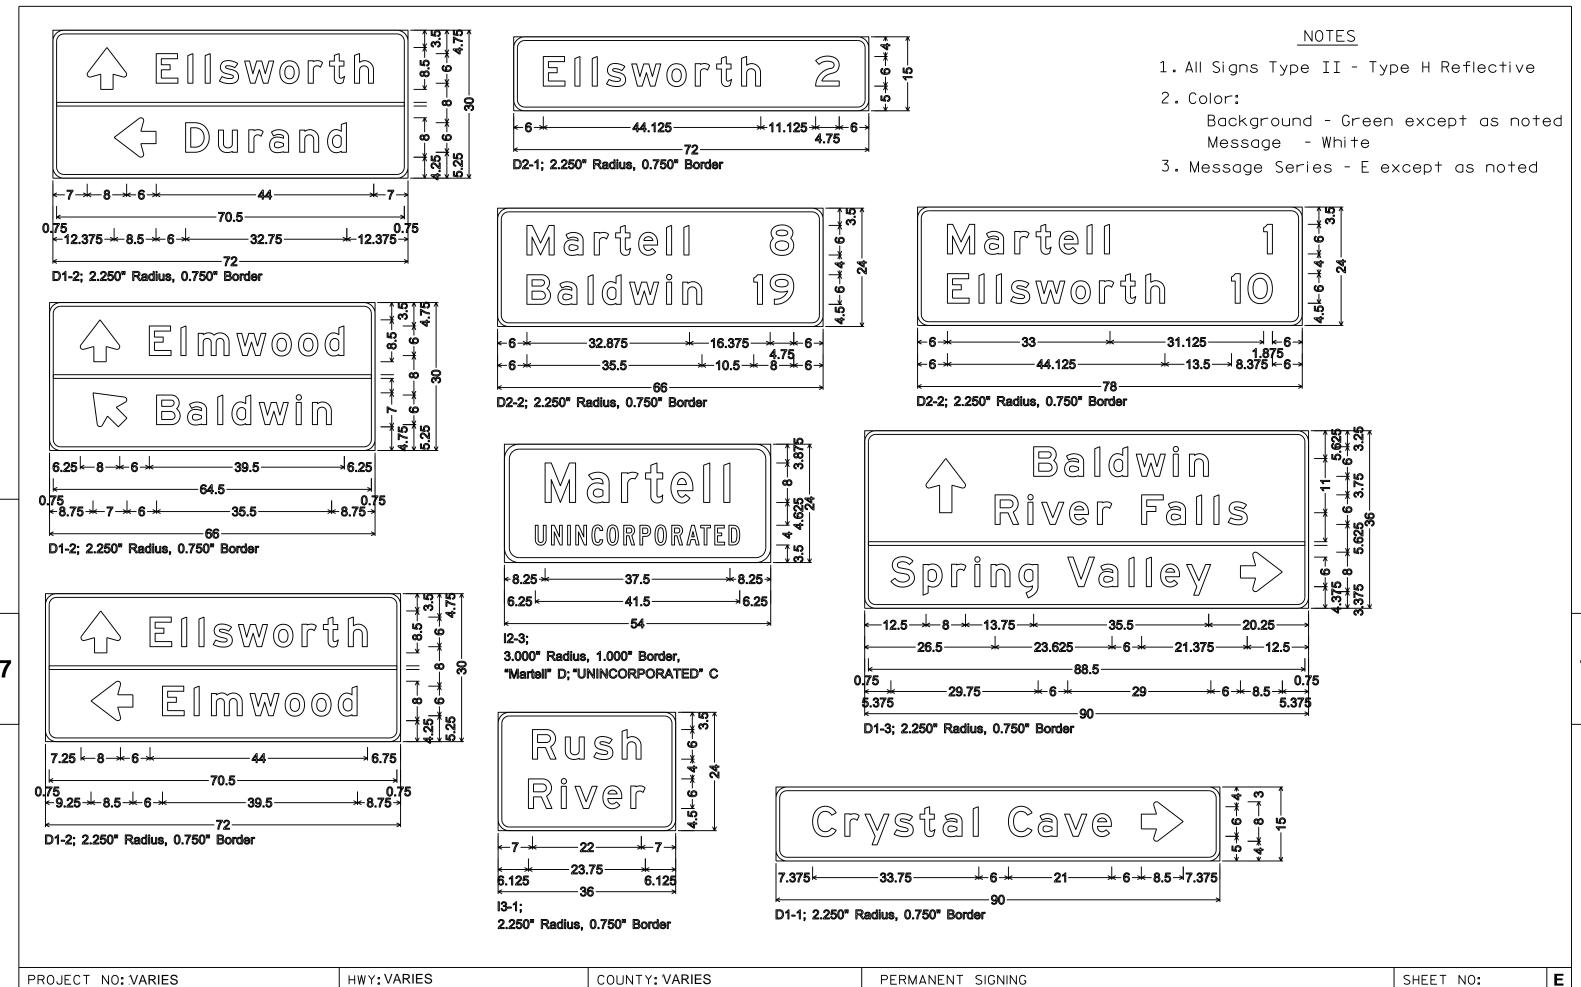

FILE NAME . C.\CAFfiles\Projects\tr d6\6474go16 DGN

PLOT DATE : 07-001-2016 16:00


PLOT SCALE . 19 458419.1 000000

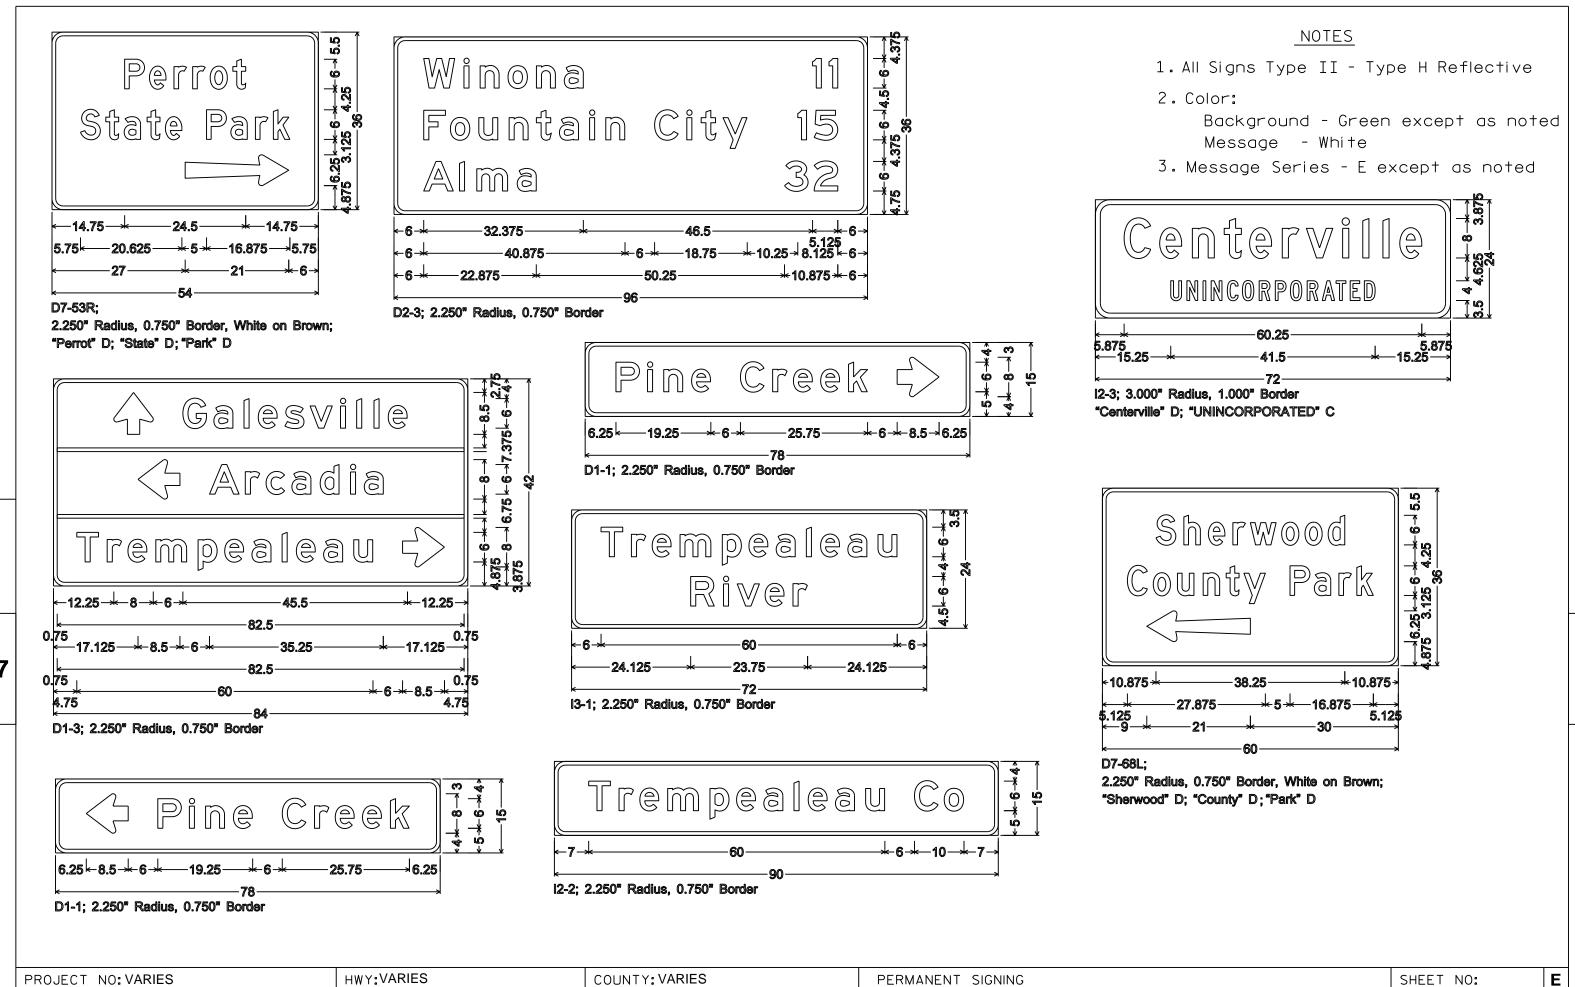


FILE NAME . C.\CAFfiles\Projects\tr d6\64740016 DCN


PLOT DATE : 07-001-2016 16:00

PLOT SCALE . 19 458419.1 000000

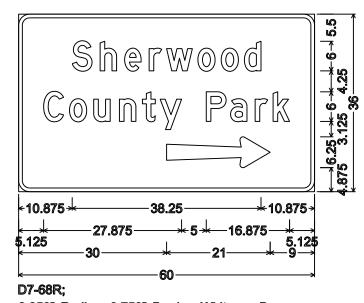

2.250" Radius, 0.750" Border, White on Brown; "Sherwood" D; "County" D; "Park" D

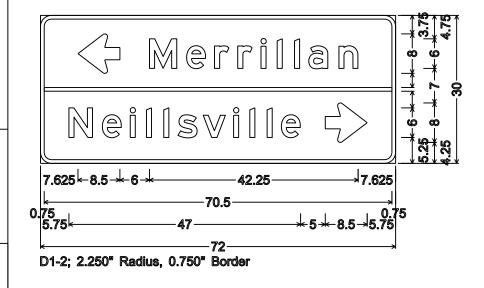

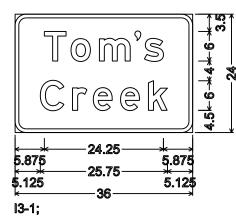


2.250" Radius, 0.750" Border

NOTES

- 1. All Signs Type II Type H Reflective
- 2. Color:

Background - Green except as noted Message - White

3. Message Series - E except as noted

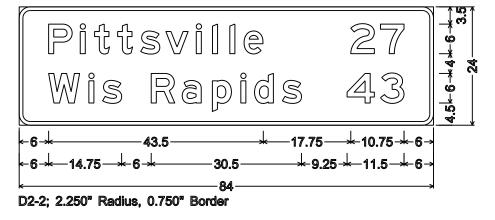


Ε

SHEET NO:

1. Signs are Type II - Type H Reflective - reference WIS DOT Standard

areater than 48 inches (both vertical and horizontal) shall have one horizontal splice between the arrows and route shields. Vertical splices shall not be used on route assemblies with a horizontal dimension of 144 inches or less. The contractor shall not use more than one vertical joint per sign and the joint shall be between route shields.

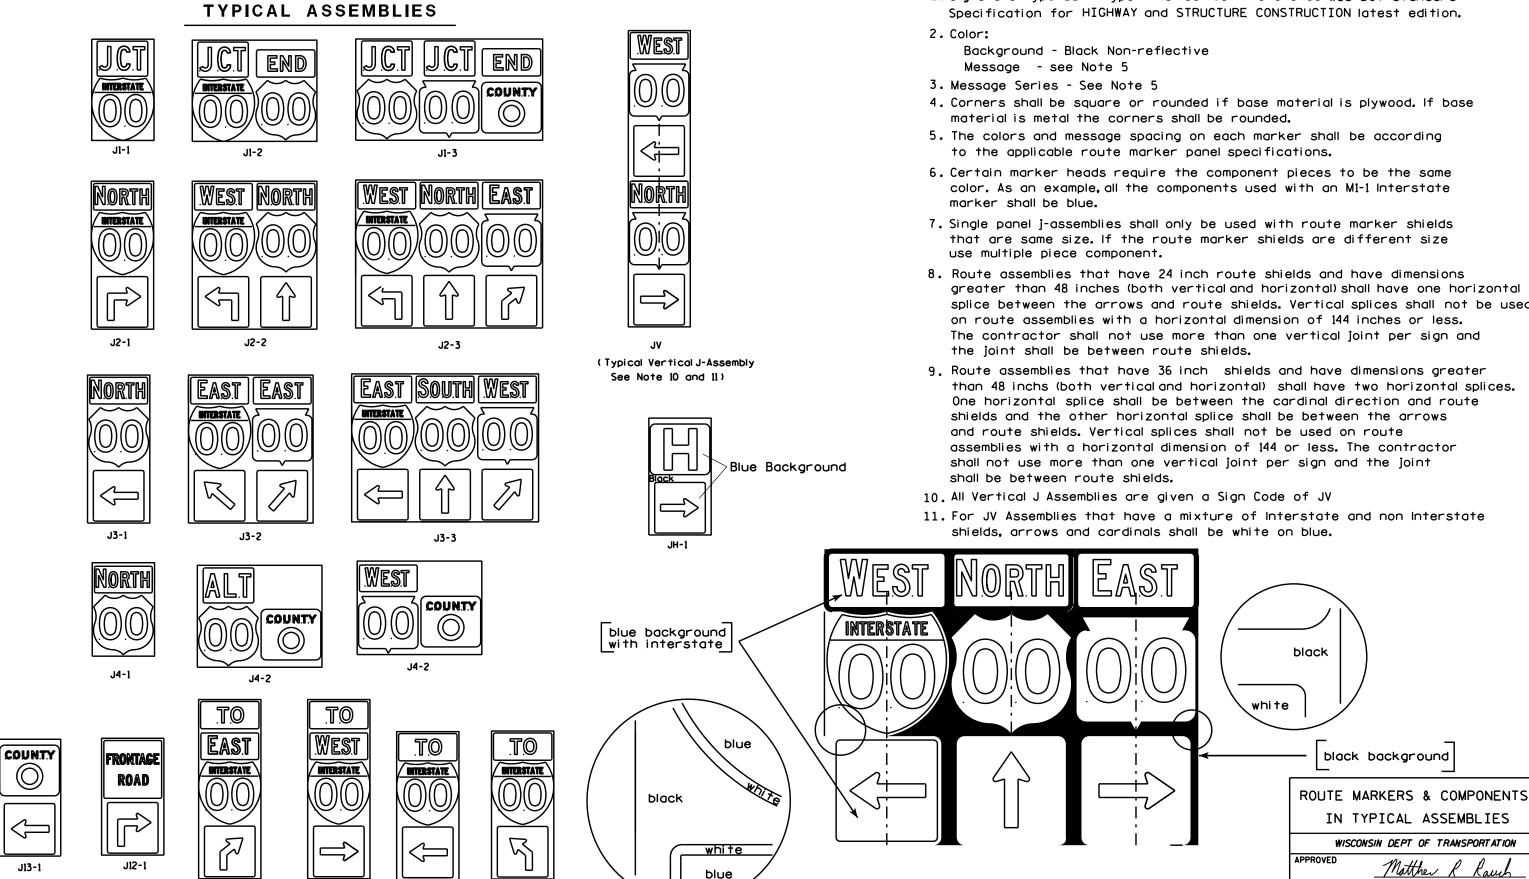

PROJECT NO:

J32-1

J22-1

J23-1

J33-1

PLOT BY: mscsja

PLATE NO. __A2-15.8

DATE 2/06/14

SHEET NO:

URBAN ARFA



RURAL AREA (See Note 2)



2' Min - 4' Max (See Note 6)



5'-3"(生) A POLICE AND A POL D^{-1} Outside Edae of Gravel

White Edgeline Location

** The existence of curb and gutter does not in itself mandate the vertical clearance illustrated. That height is typically measured where

there is sidewalk adjacent to the roadway or parking is permitted. In the absence of sidewalk vertical clearance is measured from the top of the curb. Offset of signs is measured from the flow line.

HWY:

* 6 feet from edge of a paved shoulder or 12 feet from the edge of pavement (edge line location) or 2 feet from outside edge of gravel, whichever is greater unless directed by project engineer.

PLOT BY : mscj9h

GENERAL NOTES

- 1. Signs wider than 4 feet or 20 sq.ft or larger, shall be mounted on multiple posts. Refer to plate A4-4.
- 2. If signs are mounted on barrier wall, see A4-10 sign plate.
- 3. For expressways and freeways, mounting height is $7'-3''(\pm)$ or 6'-3" (±) depending upon existence of a sub-sign.
- 4. Minimum mounting height for J assemblies (A2-1S) is $7'-3''(\pm)$ or $6'-3''(\pm)$ per urban or rural detail respectively.
- 5. Minimum mounting height for signs mounted on traffic signal poles is $5' - 3'' (\pm)$.
- 6. Offset distance shall be consistent with existing signs or consistent throughout length of project.
- 7. The (+) tolerance for mounting height is 3 inches.
- 8. Folding signs shall be mounted at a height of 5'-3'' (\pm) or as directd by the Engineer.
- 9. The Double Arrow sign (W12-1) shall be mounted at a height of 2'-3" (\pm) . The Chevron sign (W1-8), Roundabout Chevron panel (R6-4B), Enhanced Reference Markers, Clearance Markers (W5-52), Mile Markers (D10 series), In Road Object Markers (W5-54) & End of Road Markers (W5-56) shall be mounted at a height of 4'-3'' (\pm).

POST EMBEDMENT DEPTH

Area of Sign	
Installation	D
(Sq. Ft.)	(Min)
20 or Less	4'
Greater than 20	5'

TYPICAL INSTALLATION OF PERMANENT TYPE II SIGNS ON SINGLE POSTS

WISCONSIN DEPT OF TRANSPORTATION

SHEET NO:

APPROVED

for State Traffic Engineer

DATE 7/23/15

PLATE NO. <u>A4-3.20</u>

FILE NAME : C:\CAEfiles\Projects\tr_stdplate\A43.DGN

PROJECT NO:

PLOT DATE: 23-JUL-2015 15:21

COUNTY:

PLOT NAME :

PLOT SCALE: 99.237937:1.000000



NOTES: 1. ALL MATERIAL TO BE APPROVED

BY ENGINEER PRIOR TO INSTALLATION

- 2. SEE SIGN PLATE A4-8 FOR SIGN HARDWARE REQUIREMENTS
- 3. 18 INCH X 18 INCH SQUARE BOX-OUTS MAY BE USED FOR INSTALLATIONS IN EXISTING CONCRETE OR ASPHALT LOCATIONS.



ELEVATION VIEW

DETAIL OF STEEL 2 X 2 SIGN POST IN BOX-OUT



DETAIL OF WOOD 4 X 6 SIGN POST IN BOX-OUT

HWY:



PLAN VIEW

COUNTY:

FOR NEW CONCRETE/ASPHALT INSTALLATIONS

SIGN POST BOX-OUTS A4-3B

WISCONSIN DEPT OF TRANSPORTATION

For State Traffic Engineer

DATE 1/27/14 PLATE NO. A4-3B.1

SHEET NO:

FILE NAME : C:\CAEFiles\Projects\tr_stdplate\A43B.DGN

PROJECT NO:

PLOT DATE: 27-JAN-2014 09:48

PLOT NAME :

PLOT BY: mscsja

PLOT SCALE: 13.659812:1.000000

APPROVED

GENERAL NOTES

- 1. For 3 or 4 post installations, individual post spacing shall be greater than 3'-6".
- 2. See tables below for required number of posts.
- 3. For expressways and freeways, mounting height is 7'-3'' (±) or 6'-3'' (±) depending upon existence of sub-sign.
- 4. The (±) tolerance for mounting height is 3 inches.
- 5. Minimum mounting height for J assemblies (A2-1S) is 7'-3'' (±) or 6'-3'' (±) per urban or rural detail respectively.
- 6. Offset distance shall be consistent with existing signs or consistent throughout length of project.
- 7. Folding signs shall be mounted at a height of 5'-3" (±) or as directed by the engineer.
- 8. The Double Arrow sign (W12-1) shall be mounted at a height of 2'-3" (±). The Chevron sign (W1-8). Roundabout Chevron panel (R6-4B), Clearance Markers (W5-52), Mile Markers (D10 series), In Road Object Markers (W5-54) & End of Road Markers (W5-56) shall be mounted at a height of 4"-3" (±).
- * 6 feet from edge of a paved shoulder or 12 feet from the edge of pavement (edge line location) or 2 feet from outside edge of gravel, whichever is greater unless directed by project engineer.
- ** The existence of curb and gutter does not in itself mandate the vertical clearance illustrated. That height is typically measured where there is sidewalk adjacent to the roadway or parking is permitted. In the absence of sidewalk vertical clearance is measured from the top of the curb. Offset of signs is measured from the flow line.
- *** See A4-3 sign plate for signs 4' or less in width and less than 20 S.F. in area.

URBAN AREA RURAL AREA (See Note 3) 2'Min - 4'Max (See Note 6) ₩E# FF# 6'-3"(±) 6'-3"(±) 7'-3"(±) ** Curb ****\ Flowline D **7000** White Edgeline D 11 White Edgeline, Location Outside Edae Location

2'Min - 4'Max (See Note 6) 6'-3"(±) Curb Flowline. -11

48" DIAMOND WARNING SIGN

HWY:

_ 26" 5 ' - 3 "(±) White Edgeline Location Outside Edge of Gravel 48" DIAMOND WARNING SIGN

COUNTY:

Outside Edge

of Gravel

	SIGN SHAPE OTHER THAN (TWO POSTS REQUIRED		
	L	E	
* * *	Greater than 48" Less than 60"	12"	
	60" to 120"	L/5	l

SIGN SHAPE OTHER THAN (THREE POSTS REQUIR	
L	E
Greater than 120" less than 168"	12"

SIGN SHAPE OTHER THAN (FOUR POSTS REQUIRE	
L	E
168" and greater	12"

POST EMBEDMENT DEPTH

of Gravel

Area of Sign	
Installation	D
(Sq. Ft.)	(Min)
20 or Less	4'
Greater than 20	5'

TYPICAL INSTALLATION OF TYPE II SIGNS ON MULTIPLE POSTS

Matther

SHEET NO:

FILE NAME : C:\CAEfiles\Projects\tr_stdplate\A44.DGN

PROJECT NO:

PLOT DATE: 23-JUL-2015 15:23

PLOT SCALE: 107.021305:1.000000

WISDOT/CADDS SHEET 42

PLOT NAME :

PLOT BY: mscj9h

WISCONSIN DEPT OF TRANSPORTATION APPROVED

For State Traffic Engineer

PLATE NO. 44-4.14 DATE 7/23/15



Two different fastening systems are shown for illustration purposes. On any individual sign, either one or the other system shall be used. Actual number of fasteners per sign varies with the sign area, but normally there are two. For a single post installation, all signs greater than 9 sq. ft. require the use of 3 fasteners.

ATTACHMENT OF SIGNS
TO POSTS

WISCONSIN DEPT OF TRANSPORTATION

APPROVED

Nather R Raw
For State Traffic Engineer

DATE <u>8/11/16</u>

PLATE NO. <u>44-8.8</u>

PROJECT NO:

FILE NAME : C:\CAFfiles\Projects\tr stdplote\A48 DCN


PLOT DATE . 11-416-2016 11:35


PINT RY * \$\$ nintuser \$\$

SHEET NO:

| | |



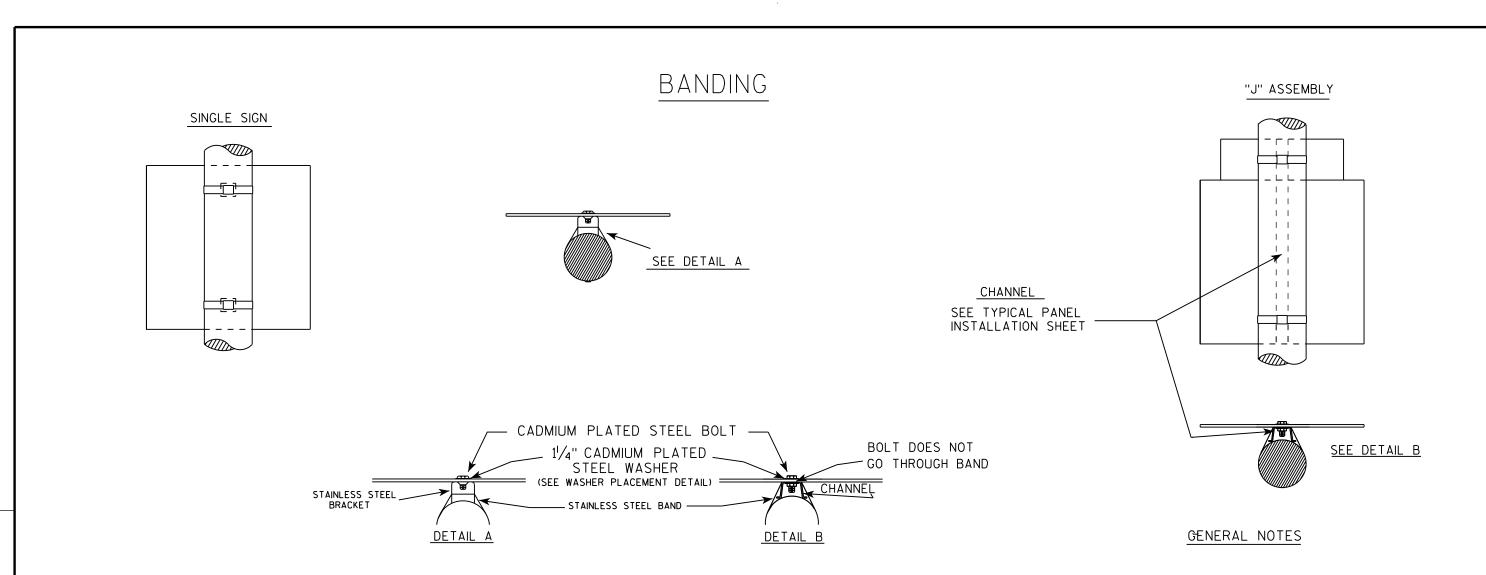

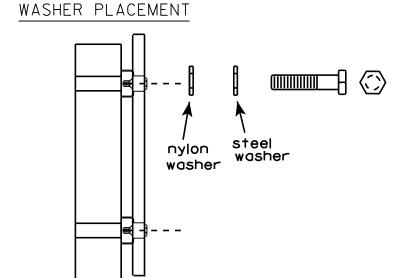

HWY:

WASHERS (ALL POSTS) -

COUNTY:

1-1/4" O.D. X3/8" I.D. X1/16" STEEL 1-1/4" O.D. X3/8" I.D. X .080 NYLON FOR ALL TYPE H SIGNS

PLOT BY: mscsja

- 1. Any sign over 3 feet in width shall use the V-Block banding method. See A5-10 standard plate.
- 2. Signs 3 feet or greater in height shall have three bracket bands installed. Signs less than 3 feet in height shall have two bracket bands installed.
- 3. Banding and assembly bracket shall be stainless steel. All bands shall be $\frac{3}{4}$ " in width and 0.025" thickness.

STANDARD SIGN SIGN BANDING DETAILS

WISCONSIN DEPT OF TRANSPORTATION

APPROVED

DATE 8/16/13

SHEET NO:

State Traffic Engineer

FILE NAME : C:\CAEFiles\Projects\tr_stdplate\A59.DGN

PROJECT NO:


PLOT DATE: 16-AUG-2013 13:27

PLOT NAME :

PLOT SCALE: 33.740899:1.000000

WISDOT/CADDS SHEET 42

PLATE NO. A5-9.3

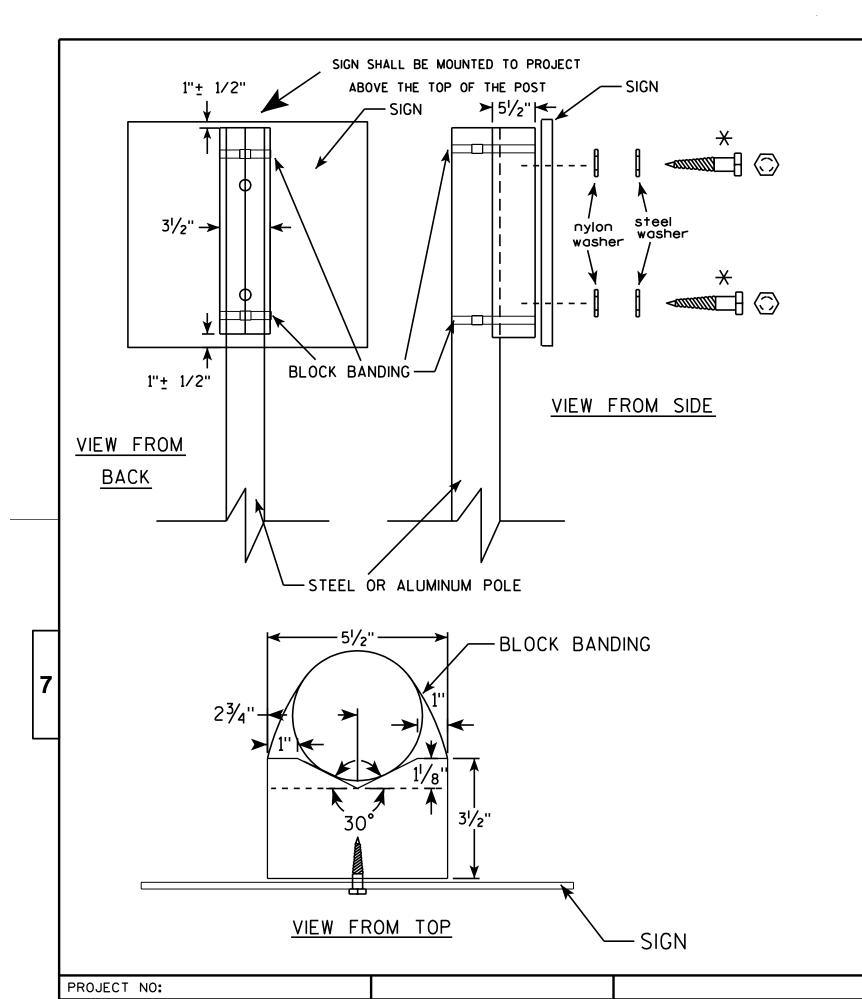

GENERAL NOTES

- 1. WOOD 4"X6" POST MATERIAL SHALL CONFORM TO 507.2.2 OF THE WISDOT STANDARD SPECIFICATIONS
- 2. BLOCK BANDING AND CLIPS SHALL BE STAINLESS STEEL, 3/4" WIDTH AND 0.025" THICKNESS
- 3. SIGNS 3' OR GREATER IN HEIGHT SHALL UTILIZE 3 BLOCK BANDS.

 SIGNS UNDER 3' IN HEIGHT SHALL UTILIZE 2 BLOCK BANDS
- 4. ACTUAL NUMBER OF FASTENERS PER SIGN VARIES WITH THE SIGN AREA, BUT NORNALLY THERE ARE TWO. FOR SIGNS GREATER THAN 9 S.F. 3 FASTENERS SHALL BE USED.
- 5. ALL SIGN MOUNTING BOLTS AND WASHERS SHALL BE EITHER:
 - a. Hot dip or mechanically galvanized in accordance with ASTM Designation: A 153, Class D, or
 - b. Cadmium plated in accordance with ASTM Designation: B 766 TYPE 3, Class 12, or
 - c. Electro-galvanized in accordance with ASTM Designation: B 633, TYPE III, SC 3.
- 6. ALL BOLTS SHALL HAVE HEXAGONAL HEADS.
- 7. STEEL WASHERS SHALL BE 11/4" O.D. X 3/8" I.D. X 1/16"
- 8. NYLON WASHERS SHALL BE $1^{1}/_{4}$ " O.D. X $3/_{8}$ " I.D. X .080 FOR TYPE H OR TYPE F FACE SIGN

X LAG BOLTS SHALL BE 3/8" X 21/2"

BLOCK BANDING DETAIL
(V-BLOCK OPTION)

WISCONSIN DEPT OF TRANSPORTATION

APPROVED


APPROVED

For State Traffic Engineer

DATE 7/12/07

PLATE NO. A5-10.1

SHEET NO:

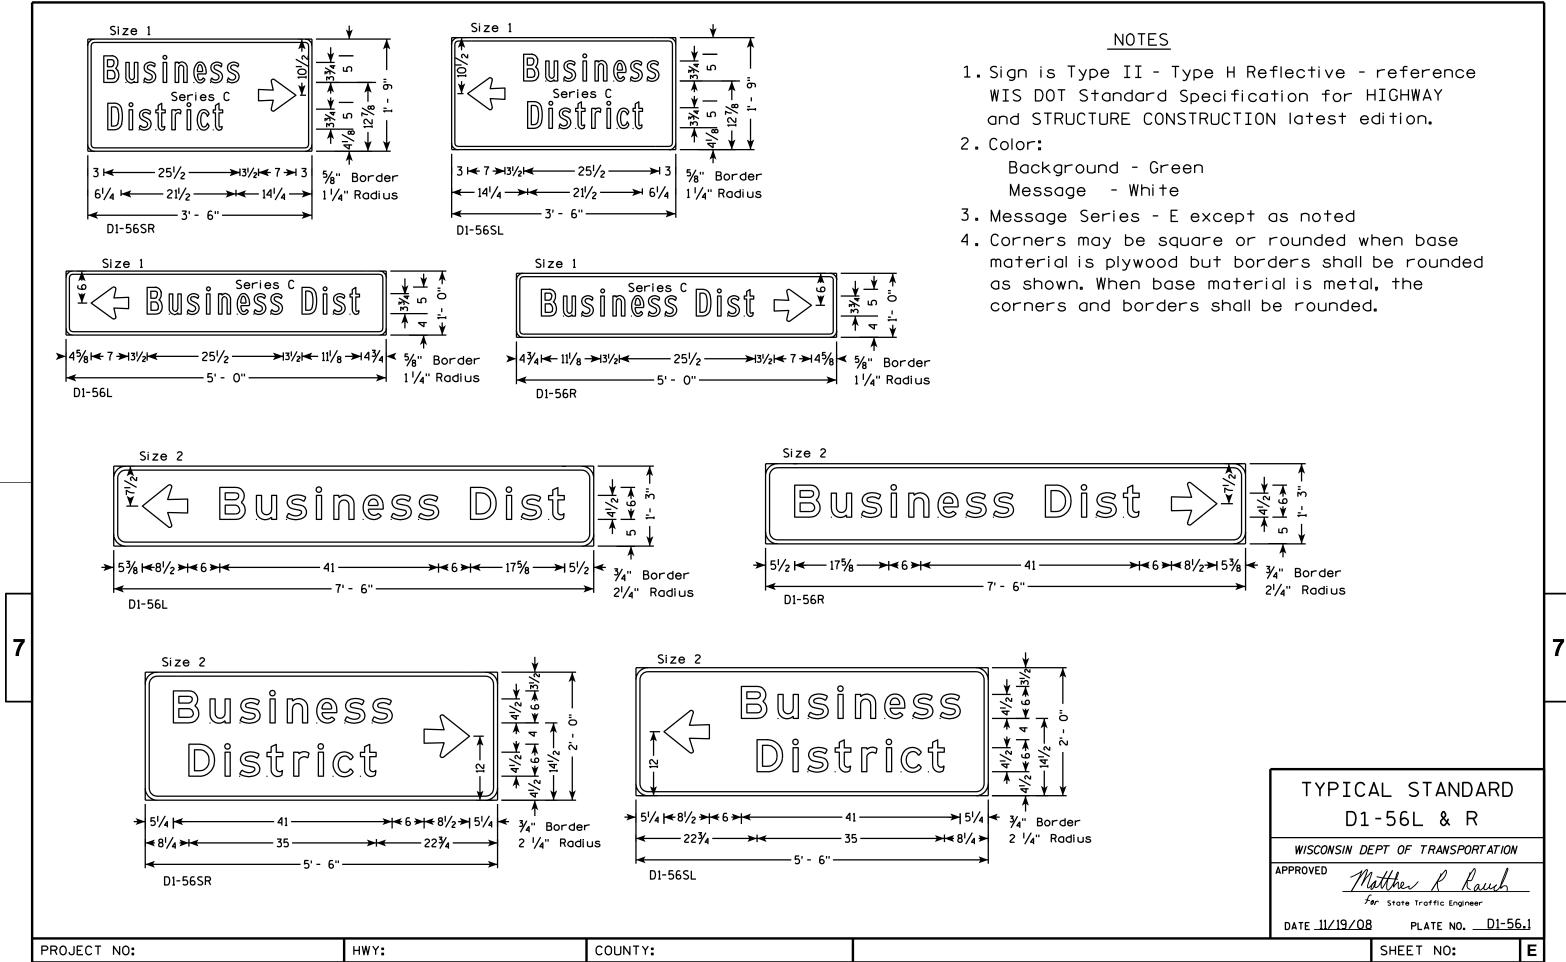


FILE NAME : C:\Users\Projects\tr_stdplate\D156.DGN


PLOT DATE: 10-DEC-2008 13:32

PLOT BY : ditjph

PLOT NAME :

PLOT SCALE: 17.988750:1.000000

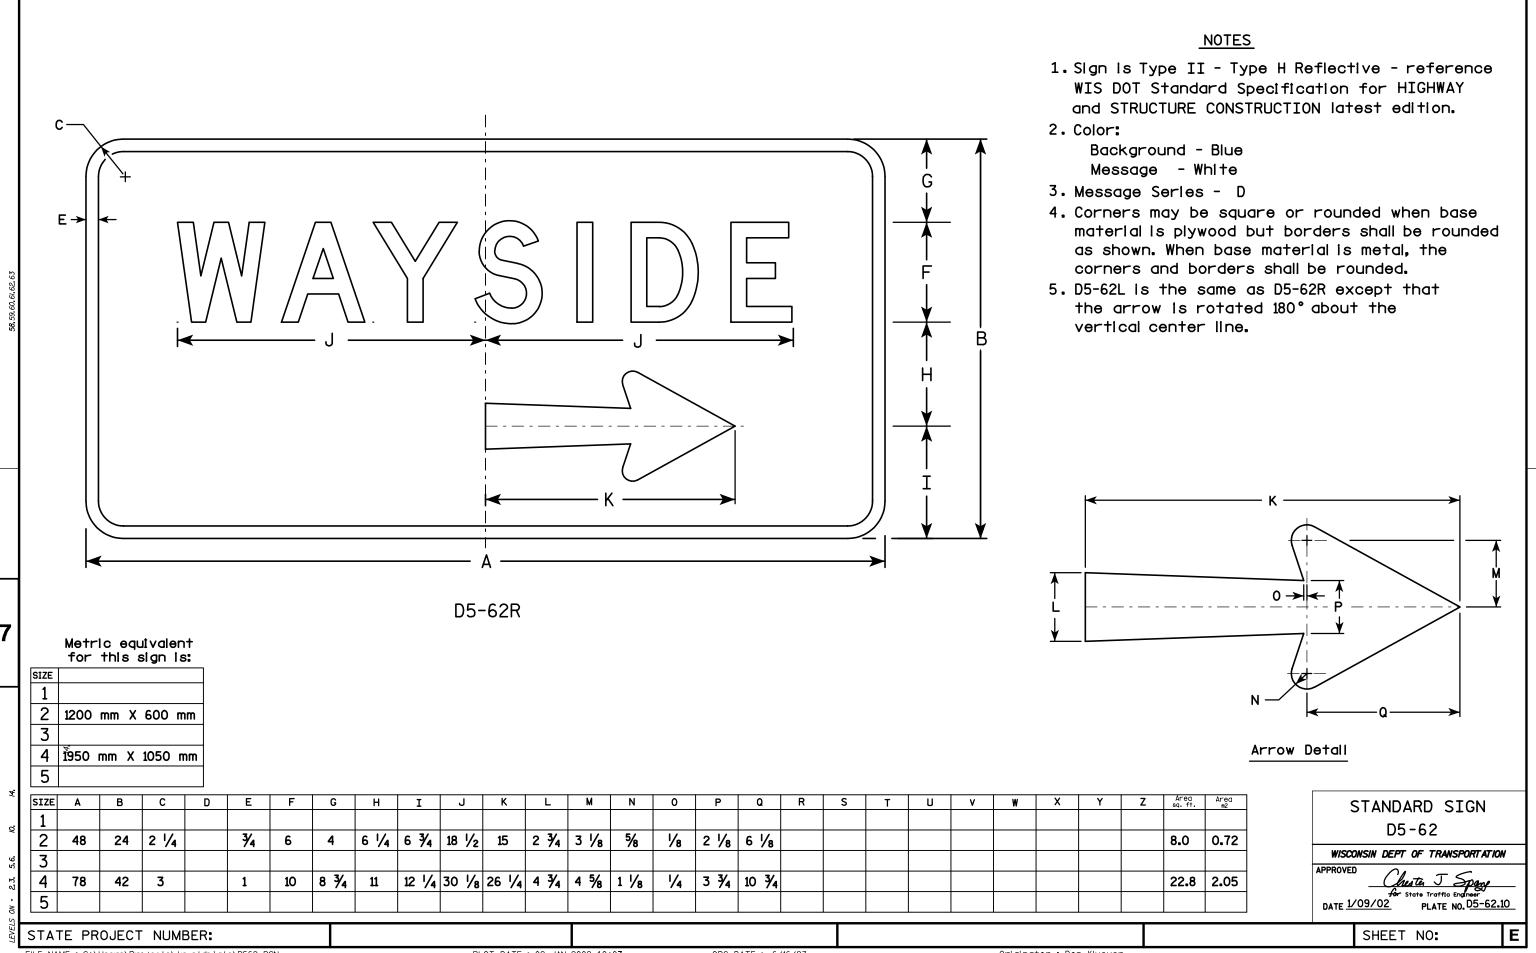

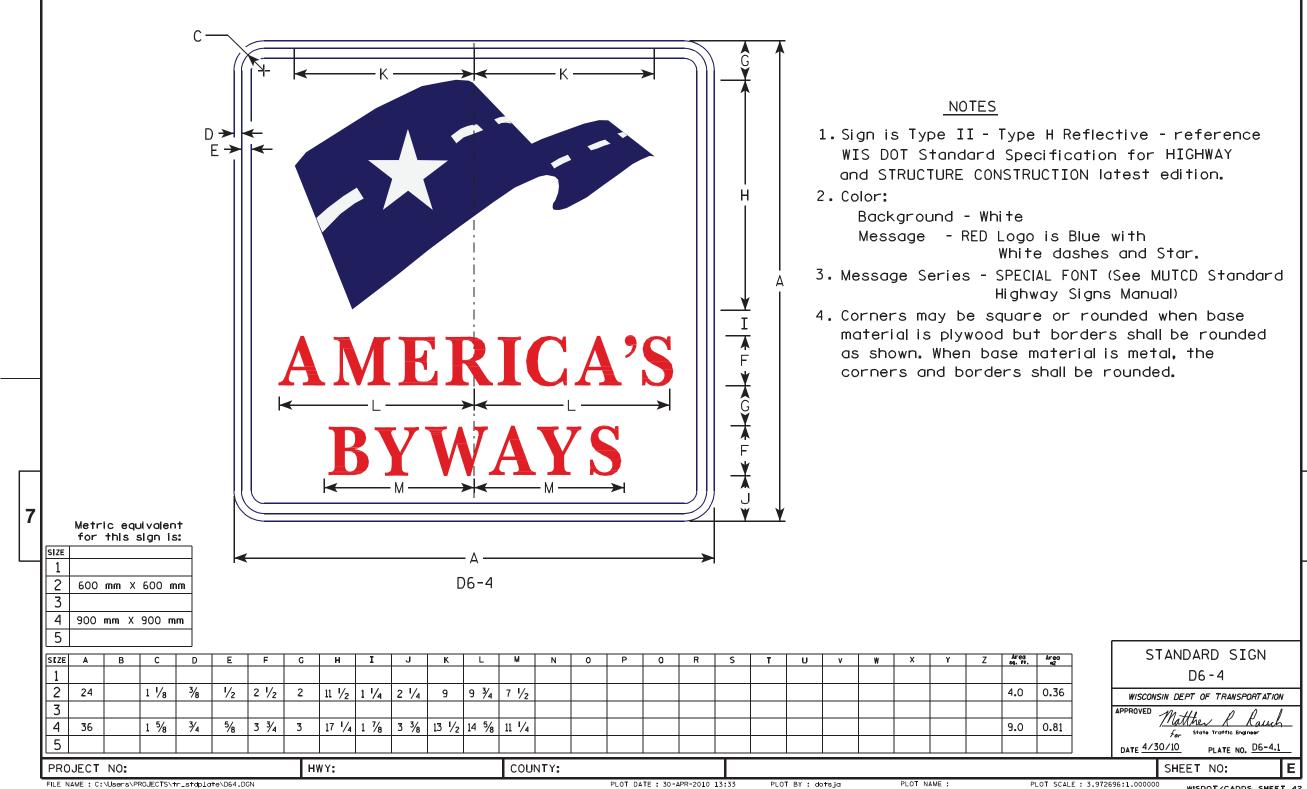

HWY:


Background Colors of Symbol*

Z F Z

A F X A

₽ 4

* VARIES

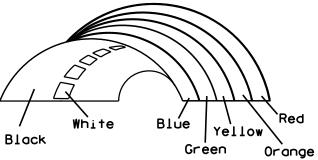

*1/4" Black Border between each color of rainbow and border of rainbow

COUNTY:

NOTES

- 1. Sign is Type II Type H Reflective reference WIS DOT Standard Specification for HIGHWAY and STRUCTURE CONSTRUCTION latest edition.
- 2. Color:

Background - White Message - (See Note 5)

- 3. Message Series (See Note 6)
- 4. Corners may be square or rounded when base material is plywood but borders shall be rounded as shown. When base material is metal, the corners and borders shall be rounded.
- 5. Border Blue

Line 1 - Red

Line 2 - Black

Line 3-5 - Blue

6. Line 1 - Dutch 8011L

Line 2 - Series E

Line 3-5 - Series C

7. Contractor shall provide and install a new post bracket in accordance with the I55-56B sign detail.

STANDARD SIGN I55-56

For State Traffic Engineer

DATE 4/27/11 PLATE NO. 15!

ATE 4/27/11 PLATE NO. 155-56.3

SHEET NO:

FILE NAME : C:\Users\PROJECTS\tr_stdplate\I5556.DGN

PROJECT NO:

PLOT DATE: 27-APR-2011 10:05


PLOT BY: mscj9h

PLOT NAME :


PLOT SCALE: 7.945391:1.000000


945391:1.000000 WISDOT/CADDS SHEET 42

ISOMETRIC VIEW

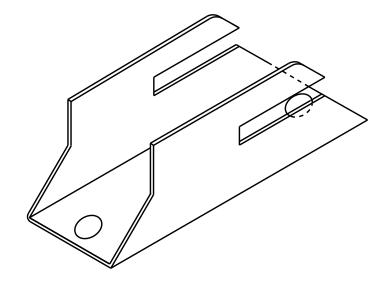


TOP VIEW

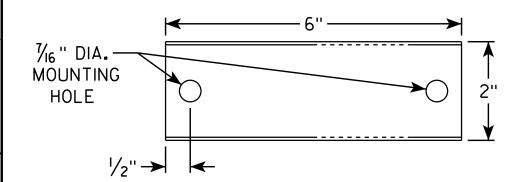

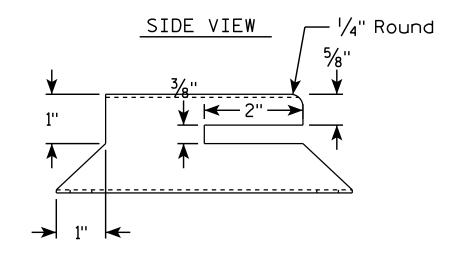

HWY:


END VIEW

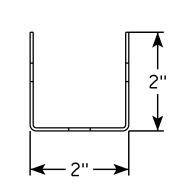

COUNTY:

NOTES

- Must be capable of permanent attachment to a wood or steel channel sign post utilizing the fastening hardware specified on the A4-8 sign plate.
- 2. Shall be entirely primed and painted with two coats of a black powder coated enamel paint.
- 3. Shall be made with 12 gauge steel, and incorporate no welds, no hinged components, no threaded lock-type components, and no parts which are loose or can be separated from the main body.
- 4. Shall have rounded edges with at least $\frac{1}{8}$ " radii.
- 5. Shall not have unrounded and uncoated metaledges which can contact the back surface of the roll-up sign.
- 6. Top of bracket shall be mounted 2' below the bottom of the 155-56 sign.
- 7. Cost of bracket and fastening hardware shall be incidental to the 155-56 sign.

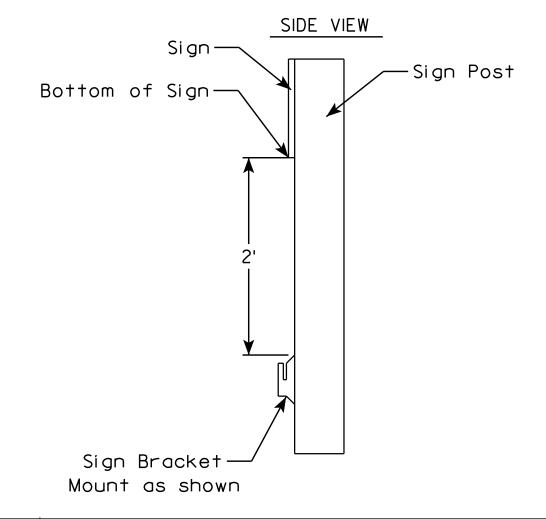

SHEET NO:

PROJECT NO:

PLOT BY : mscj9h


DATE 4/26/16

PLATE NO.155-56B.2

ROLLUP SIGN BRACKET

155-56B

WISCONSIN DEPT OF TRANSPORTATION

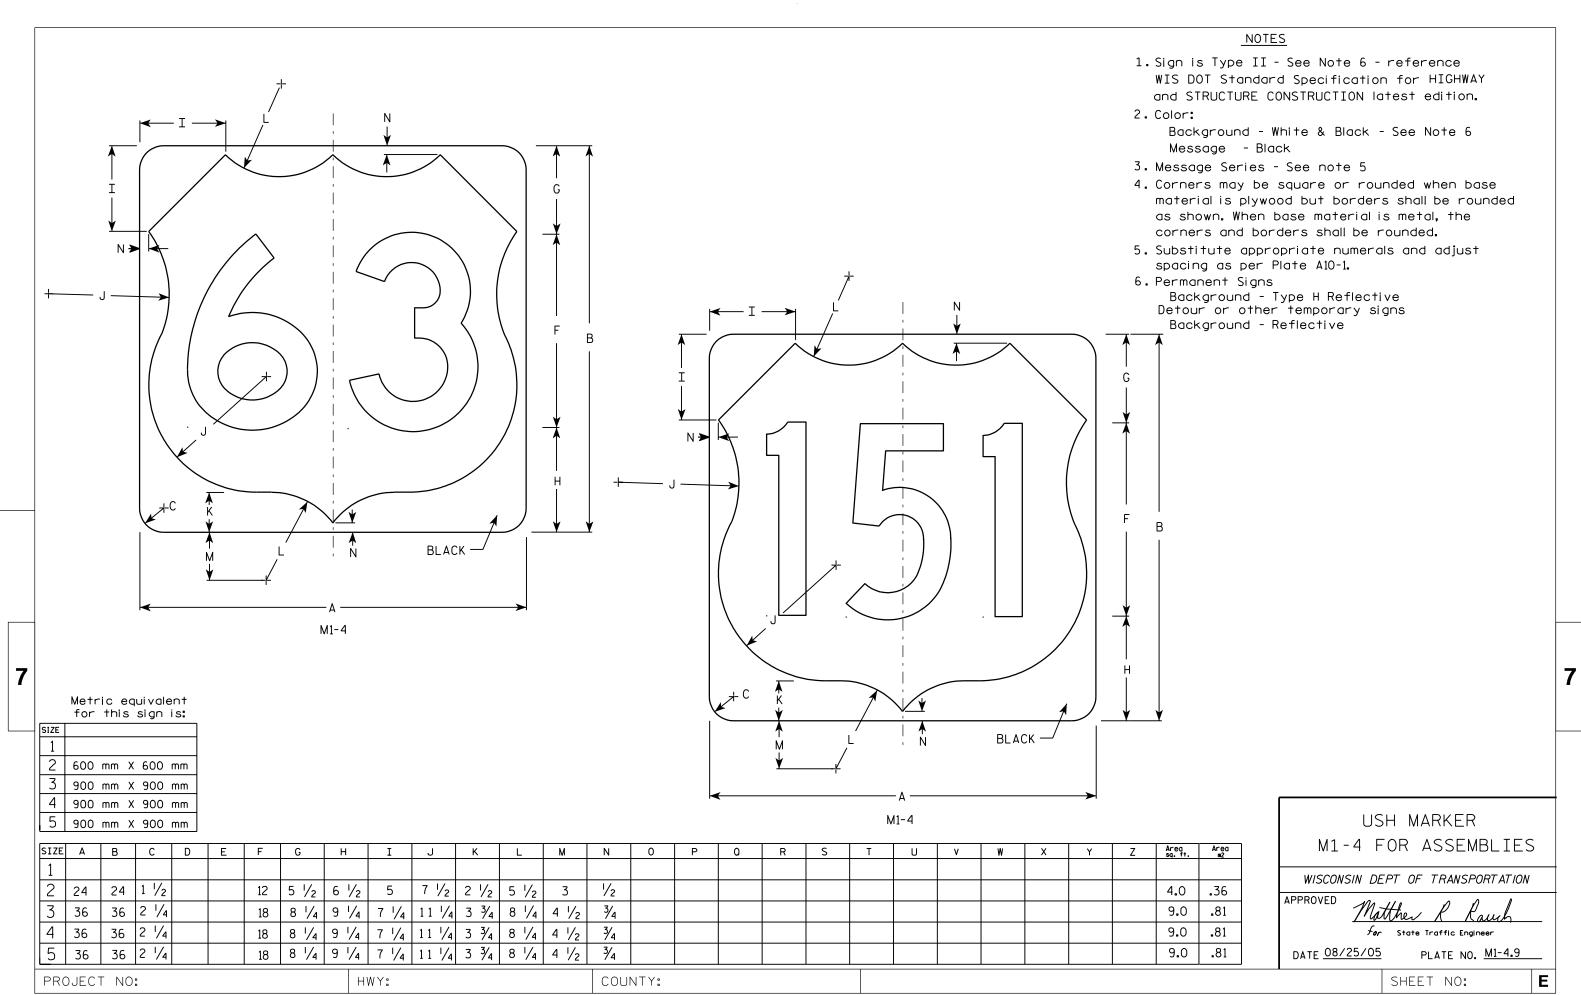


FILE NAME : C:\Users\Projects\tr_stdplate\M14.DGN


- 1. Sign is Type II see Note 7 reference WIS DOT Standard Specification for HIGHWAY and STRUCTURE CONSTRUCTION latest edition.
- 2. Color:


Background - White & Black - See Note 7 Message - Black

- 3. Message Series see Note 5
- 4. Corners may be square or rounded when base material is plywood but borders shall be rounded as shown. When base material is metal, the corners and borders shall be rounded.
- 5. Message Series E for 1 letter. Message Series D for 2 letters unless message is too big then Series C. Message Series C for 3 letters unless message is too big then Series B.
- 6. Substitute appropriate letters & optically center to achieve proper balance.
- 7. Permanent Signs

Background - Type H Reflective Detour or temporary Signs Background - Reflective

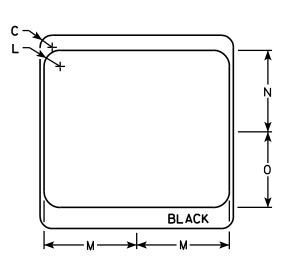

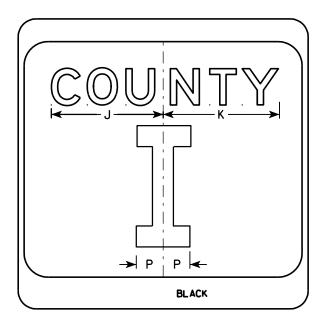

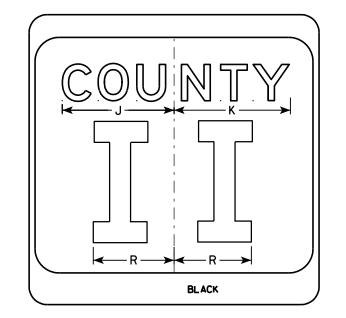

SIZE	Α	В	С	D	E	F	G	Н	I	J	K	L	M	N	0	Р	0	R	S	T	U	٧	W	X	Y	Z	Area sq. ft.
1																											
2	24		1 1/2			10	3	5 1/8	4 1/8	9 1/4	9 %	2	11 1/2	10 1/8	9 %	2 1/4		6 %									4.0
3	36		2 1/4			16	4	7 5/8	5 %	12 1/4	12 1/8	3	17 1/8	15 1/4	14	3 3/8		10									9.0
4	36		2 1/4			16	4	7 %	5 %	12 1/4	12 1/8	3	17 1/8	15 1/4	14	3 %		10									9.0
5	36		2 1/4			16	4	7 %	5 %	12 1/4	12 1/8	3	17 1/8	15 1/4	14	3 3/8		10									9.0
																			_								

COUNTY:

CTH MARKER M1-5A FOR ASSEMBLIES

WISCONSIN DEPT OF TRANSPORTATION

APPROVED

FerState Traffic Engineer PLATE NO. M1-5A.8 DATE 9/27/11

SHEET NO:

FILE NAME : C:\Users\PROJECTS\tr_stdplate\M15A.DGN

PROJECT NO:

BLACK

HWY:

M1-5A

PLOT DATE: 29-SEP-2011 11:25

PLOT NAME :

PLOT BY: mscsja

PLOT SCALE: 5.959043:1.000000

- 1. Sign is Type II See Note 6 reference WIS DOT Standard Specification for HIGHWAY and STRUCTURE CONSTRUCTION latest edition.
- 2. Color:

Background - White & Black - See Note 6 Message - Black

- 3. Message Series See note 5
- 4. Corners may be square or rounded when base material is plywood but borders shall be rounded as shown. When base material is metal, the corners and borders shall be rounded.
- 5. Substitute appropriate Series numerals and adjust spacing as per plate A10-1.
- 6. Permanent Signs Background - Type H Reflective Detour or temporary Signs Background - Reflective

	BLACK BLACK
Metric equivalent for this sign is:	>

HWY:

SIZE 600 mm X 600 mm 900 mm X 900 mm 900 mm X 900 mm 900 mm X 900 mm

PROJECT NO:

SIZE	Α	В	С	D	E	F	G	Н	I	J	К	L	М	N	0	Р	Q	R	S	T	U	٧	W	Х	Y	Z	Area sq. ft.	Area m2
1																												ļ
2	24		1 1/2			12	5 1/2	6 1/2	10 1/4	2 1/2	8 %	11 ½	1	1 %	11 1/4	21 1/8											4.0	. 36
3	36		2 1/4			18	8 3/4	9 1/4	15 3/8	5	12 %	17 1/8	1 1/2	2 1/8	16 1/8	33											9.0	.81
4	36		2 1/4			18	8 3/4	9 1/4	15 3/8	5	12 5/8	17 1/8	1 1/2	2 1/8	16 7/8	33											9.0	.81
5	36		2 1/4			18	8 3/4	9 1/4	15 3/8	5	12 5/8	17 1/8	1 1/2	2 1/8	16 1/8	33											9.0	. 81

COUNTY:

STATE ROUTE MARKER M1-6 FOR ASSEMBLIES

WISCONSIN DEPT OF TRANSPORTATION

APPROVED

DATE 3/20/02 PLATE NO. M1-6.9

SHEET NO:

FILE NAME : C:\Users\Projects\tr_stdplate\M16.DGN

PLOT DATE: 13-OCT-2005 14:55

PLOT BY : DITJPH


PLOT NAME :

PLOT SCALE : 6.715871:1.000000

- 1. Sign is Type II Type H Reflective reference WIS DOT Standard Specification for HIGHWAY and STRUCTURE CONSTRUCTION latest edition.
- 2. Color:

Background - White Message - Words - White - Graphics - Green

- 3. Message Series Special
- 4. Corners may be square or rounded when base material is plywood but borders shall be rounded as shown. When base material is metal, the corners and borders shall be rounded.

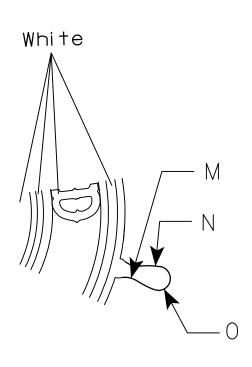

K -		C D E
	★	

SIZE	Α	В	С	D	E	F	G	Н	I	J	K	L	М	N	0	Р	0	R	S	T	U	٧	W	Х	Y	Z	Area sq. ft.
1																											
2	24		R 5	R 5 1/4	R 5 1/2		R 7 1/8	R 5 1/8	R 8 1/2	1 3/4	R 4 1/2	R 8 1/2	R 1/8	R 3 1/2	R 1/2												4.0
3																											
4	36		R 7 3/8	R 7 ¾	R 8 1/4		R 11 ¾	R 8 ¾	R 12 ¾	2 %	R 13 %	R 12 1/8	R 1 3/8	R 5 1/4	R ¾												9.0
5																											

COUNTY:

M1-96

WISCONSIN DEPT OF TRANSPORTATION

APPROVED

Matthew R Rauch

For State Traffic Engineer

DATE 2/23/10 PLATE NO. M1-96.2

STANDARD SIGN

SHEET NO:

FILE NAME : C:\Users\PROJECTS\tr_stdplate\M196.DGN

PROJECT NO:

HWY:

PLOT DATE: 28-MAY-2010 08:23

PLOT NAME :

PLOT BY : ditjph

PLOT SCALE: 5.959043:1.000000

- 1. Sign is Type II Type H
- 2. Color:

Background - See note 5 Message - See note 5

- 3. Message Series C
- 4. Corners may be square or rounded when base material is plywood but borders shall be rounded as shown. When base material is metal, the corners and borders shall be rounded.
- 5. M2-1 Background White

Message - Black

MB2-1 Background - Blue

Message - White

MK2-1 Background - Green

Message - White

MM2-1 Background - White

Message - Green

MN2-1 Background - Brown


Message - White

MP2-1 Background - White

Message - Blue

MR2-1 Background - Brown

Message - Yellow

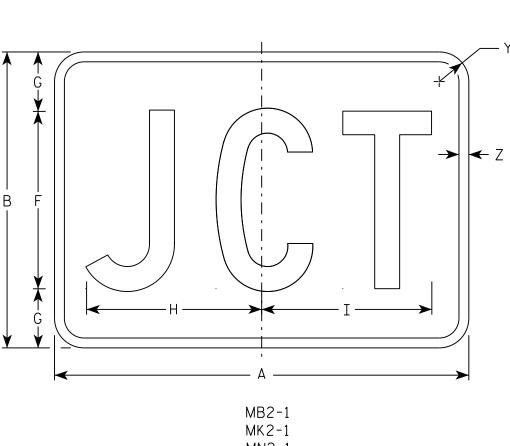

MN2-1

MR2-1

SIZE	Α	В	С	D	E	F	G	Н	I	J	K	L	М	N	0	Р	0	R	S	T	J	V	W	Х	Υ	Z	Area sq. ft.
1																											
2	21	15	1 1/8	3/8	3/8	9	3	8 1/8	8 %																1 1/2	1/2	2.20
3	30	21	1 1/8	3/8	3/8	13	4	12 1/8	12 3/8																1 1/2	1/2	4.40
4	30	21	1 1/8	3/8	3/8	13	4	12 1/8	12 3/8																1 1/2	1/2	4.40
5	30	21	1 1/8	3/8	3/8	13	4	12 1/8	12 3/8																1 1/2	1/2	4.40

COUNTY:

В

STANDARD SIGN

M2 - 1

WISCONSIN DEPT OF TRANSPORTATION

APPROVED

Matthew & Rauch f_{or} State Traffic Engineer

DATE 10/15/15

PLATE NO. M2-1.12 Ε

SHEET NO:

FILE NAME · C·\CAFfiles\Projects\tr stdplote\M21 DGN

PROJECT NO:

M2-1

HWY:

MM2-1

MP2-1

PLOT DATE . 01-DEC-2015 17:54

PLOT BY . \$\$ Diotuser \$\$ PLOT NAME :

PLOT SCALE • 4 864603•1 000000







MP3-1









HWY:



NOTES

- 1. All Signs Type II Type H
- 2. Color:

Background - See note 5 Message - See note 5

- 3. Message Series C
- 4. Corners may be square or rounded when base material is plywood but borders shall be rounded as shown. When base material is metal, the corners and borders shall be rounded.

5. M3-1 thru M3-4 Background - White Message - Black

MB3-1 thru MB3-4 Background - Blue

Message - White

MK3-1 thru MK3-4 Background - Green

Message - White

MM3-1 thru MM3-4 Background - White

Message - Green

MN3-1 thru MN3-4 Background - Brown

Message - White

MP3-1 thru MP3-4 Background - White

Message - Blue

6. Note the first letter of each direction is larger than the remainder of the message.

SIZE	Α	В	С	D	E	F	G	Н	I	J	К	L	М	N	0	Р	Q	R	S	Т	U	V	W	Х	Y	Z	Area sq. ft.
1																											
2	24	12	1 1/8	3/8	3/8	6	7	2 1/4	2 3/4	10 1/4	7 1/8	8 3/8	10 1/4	9 3/4	8 3/4			1 1/2									2.00
3	36	18	1 1/8	3/8	1/2	9	10	3 3/4	4 1/4	14 3/8	12	12 1/8	14	14 1/8	13			1 1/2									4.5
4	36	18	1 1/8	3/8	1/2	9	10	3 3/4	4 1/4	14 3/8	12	12 1/8	14	14 1/8	13			1 1/2									4.5
5	36	18	1 1/8	3/8	1/2	9	10	3 3/4	4 1/4	14 3/8	12	12 1/8	14	14 1/8	13			1 1/2									4.5

COUNTY:

STANDARD SIGNS M3-1 thur M3-4 **SERIES**

WISCONSIN DEPT OF TRANSPORTATION

APPROVED

DATE 10/15/15 PLATE NO. M3-1.14

Ε

SHEET NO:


FILE NAME · C·\CAFfiles\Projects\tr stdolote\M31 DCN

PROJECT NO:

PLOT DATE . 01-DEC-2015 17:54

PLOT RY . \$\$ plotuser \$\$ PLOT NAME :

PLOT SCALE . 11 675051.1 000000

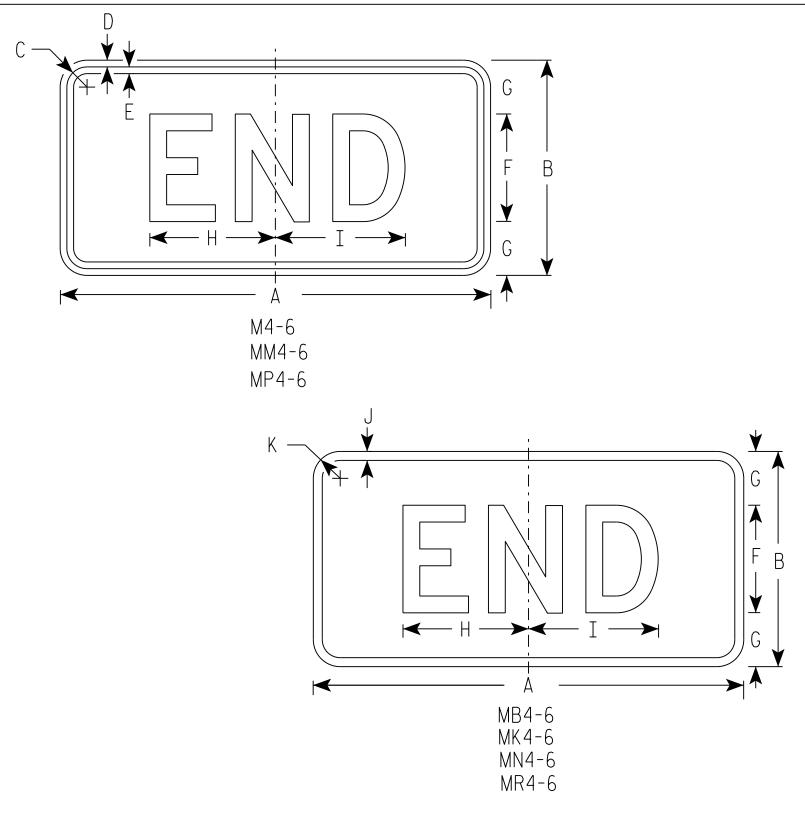

- 1. Sign is Type II Type H
- 2. Color:

Background - See note 5 Message - See note 5

- 3. Message Series D
- 4. Corners may be square or rounded when base material is plywood but borders shall be rounded as shown. When base material is metal, the corners and borders shall be rounded.
- 5. M4-6 Background White

Message - Black

MB4-6 Background - Blue

Message - White

MK4-6 Background - Green

Message - White

MM4-6 Background - White

Message - Green

MN4-6 Background - Brown

Message - White

MP4-6 Background - White

Message - Blue

MR4-6 Background - Brown

Message - Yellow

SIZE	А	В	С	D	E	F	G	Н	I	J	К	L	М	N	0	Р	Q	R	S	Т	U	٧	W	Х	Υ	Z	Area sq. ft.
1																											
2 2	24	12	1 1/8	3/8	3/8	6	3	7	7 1/4	1/2	1 1/2																2.00
3 3	36	18	1 1/8	3/8	1/2	9	4 1/2	12	11 1/8	1/2	1 1/2																4.5
4 3	36	18	1 1/8	3/8	1/2	9	4 1/2	12	11 1/8	1/2	1 1/2																4.5
5 3	36	18	1 1/8	3/8	1/2	9	4 1/2	12	11 1/8	1/2	1 1/2																4.5

STANDARD SIGN M4 - 6

WISCONSIN DEPT OF TRANSPORTATION

APPROVED

Matther & Kaus For State Traffic Engineer

DATE 10/15/15 PLATE NO. M4-7.9


SHEET NO:

FILE NAME . C.\CAFfiles\Projects\tr stdblote\M46 DGN

PLOT DATE . 01-DEC-2015 17.55

PLOT BY . \$\$ plotuser \$\$ PLOT NAME :

PLOT SCALE . 5 351066.1 000000

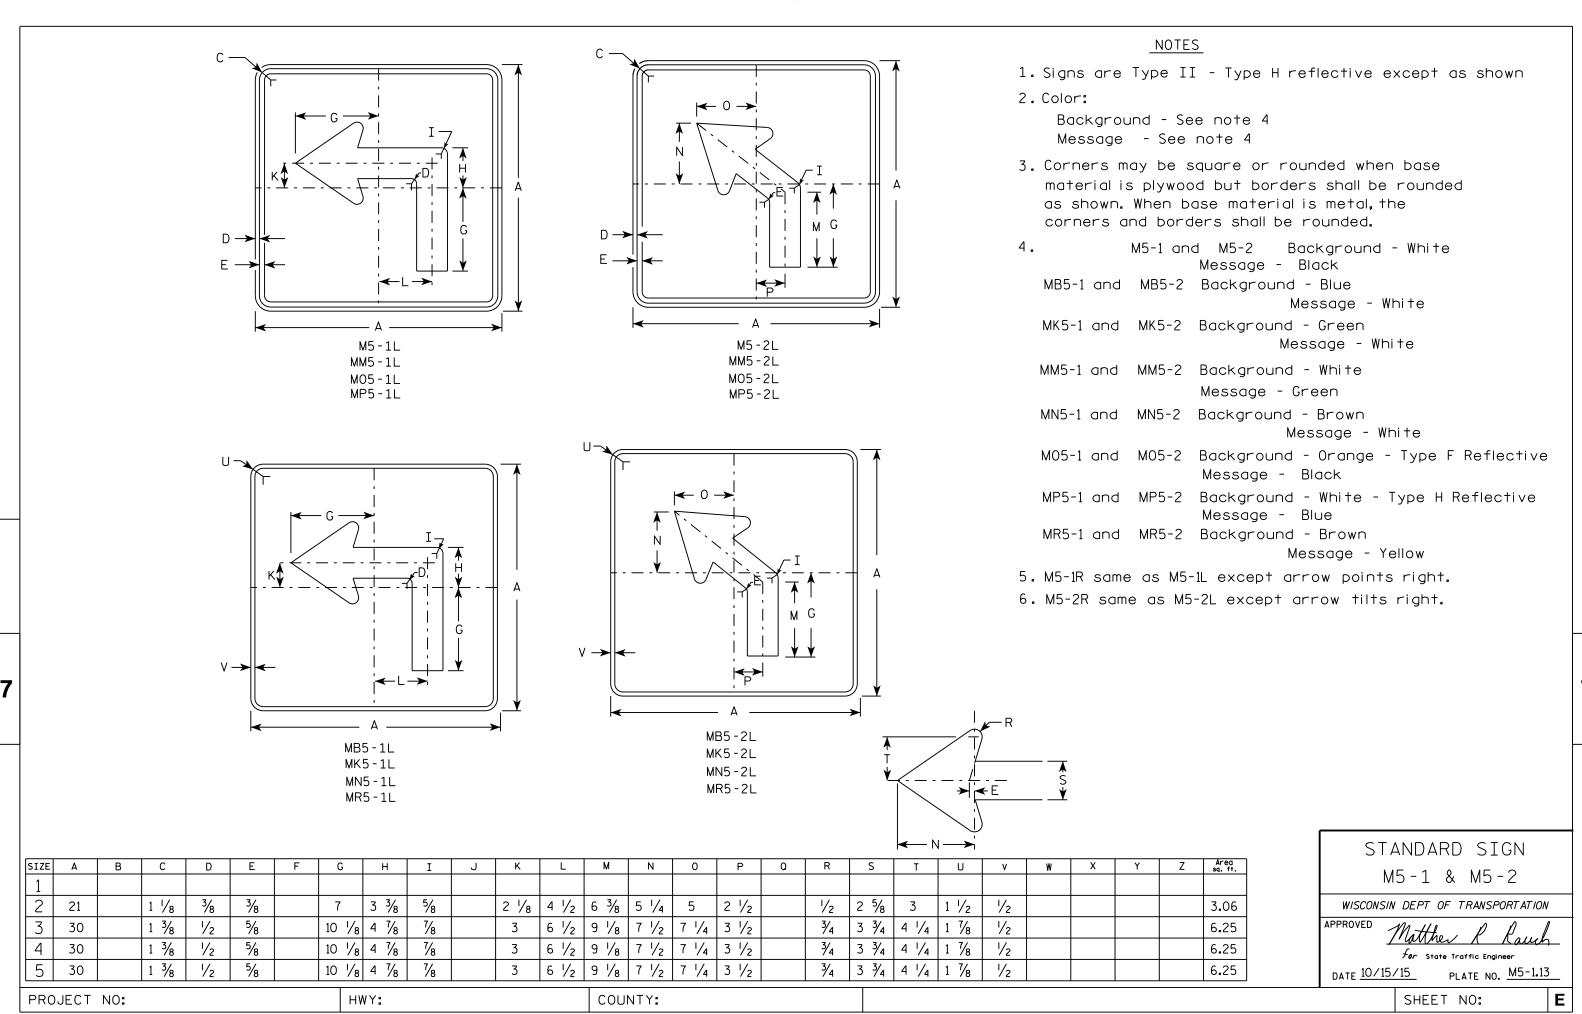



FILE NAME . C.\CAFfiles\Projects\tr stdolote\M51 DCN


PLOT DATE . 01-DEC-2015 18:07

PINT RY . \$\$ DIOTUSET \$\$ PINT NAMF :

PLOT SCALE . 11 675051.1 000000

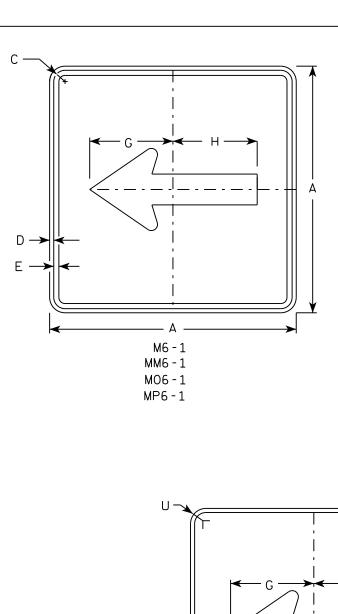


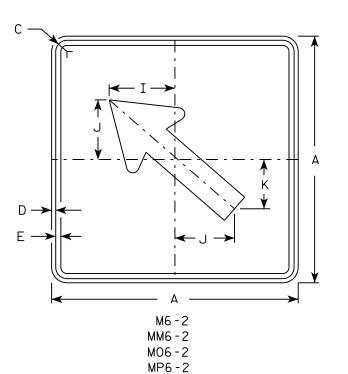

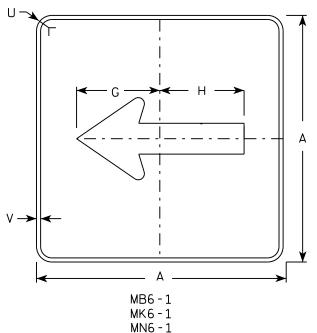

MR6-1

HWY:

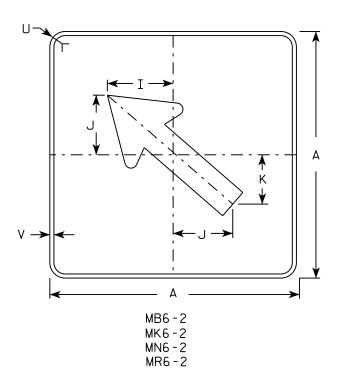

NOTES

- 1. Signs are Type II Type H except as Shown
- 2. Color:

Background - See note 4 Message - See note 4

- 3. Corners may be square or rounded when base material is plywood but borders shall be rounded as shown. When base material is metal, the corners and borders shall be rounded.
- 4. M6-1 and M6-2 Background White

Message - Black

MB6-1 and MB6-2 Background - Blue

Message - White

MK6-1 and MK6-2 Background - Green

Message - White

MM6-1 and MM6-2 Background - White

Message - Green

MN6-1 and MN6-2 Background - Brown

Message - White

M06-1 and M06-2 Background - Orange - Type F Reflective


Message - Black

MP6-1 and MP6-2 Background - White

Message - Blue

MR6-1 and MR6-2 Background - Brown

Message - Yellow

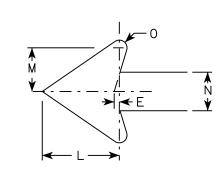

SIZE	: Α	В	С	D	E	F	G	Н	I	J	K	L	М	N	0	Р	٥	R	S	T	U	٧	W	Х	Y	Z	Area sq. ft.
1																											
2	21		1 1/8	3/8	3%		7 1/2	7 1/8	5 %	5	4 1/4	5 1/4	3	2 %	1/2						1 1/2	1/2					3.06
3	30		1 3/8	1/2	5%		10 3/4	10 1/4	8	7 1/4	6	7 1/2	4 1/4	3 3/4	3/4						1 1/8	1/2					6.25
4	30		1 3/8	1/2	5/8		10 3/4	10 1/4	8	7 1/4	6	7 1/2	4 1/4	3 3/4	3/4						1 1/8	1/2					6.25
5	30		1 3/8	1/2	5/8		10 3/4	10 1/4	8	7 1/4	6	7 1/2	4 1/4	3 3/4	3/4						1 1/8	1/2					6.25

COUNTY:

STANDARD SIGN M6-1 & M6-2 SERIES

WISCONSIN DEPT OF TRANSPORTATION

APPROVED

Matthew & Rawl For State Traffic Engineer

Ε

DATE 10/15/15 PLATE NO. M6-1.15

SHEET NO:


FILE NAME · C·\CAFfiles\Projects\tr stdplote\M61 DCN


PROJECT NO:


PLOT DATE . 01-DEC-2015 17:57

PIOT RY . \$\$ plotuser \$\$ PIOT NAMF :


PLOT SCALE . 11 675051.1 000000

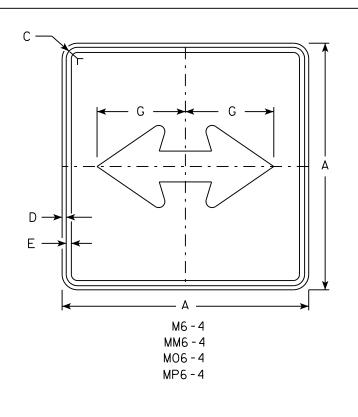

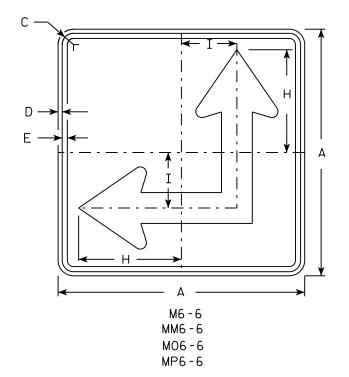

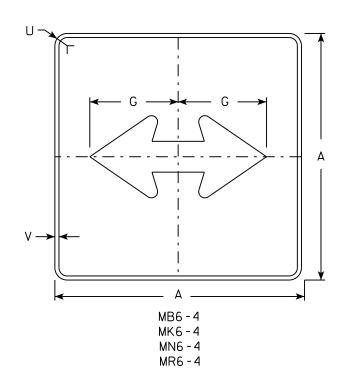

HWY:

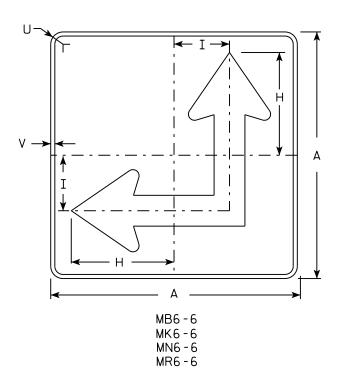

NOTES

- 1. Signs are Type II Type H except as Shown
- 2. Color:

Background - See Note 4 Message - See Note 4

- 3. Corners may be square or rounded when base material is plywood but borders shall be rounded as shown. When base material is metal, the corners and borders shall be rounded.
- 4. M6-4 and M6-6 Background White Message - Black

MB6-4 and MB6-6 Background - Blue

Message - White

MK6-4 and MK6-6 Background - Green

Message - White

and MM6-6 Background - White MM6-4

Message - Green

MN6-4 and MN6-6 Background - Brown

Message - White

M06-4 and M06-6 Background - Orange - Type F Reflective

Message - Black


MP6-4 and MP6-6 Background - White

Message - Blue

MR6-4 and MR6-6 Background - Brown

Message - Yellow

5. M6-6R same as M6-6L except arrow points ahead and right.

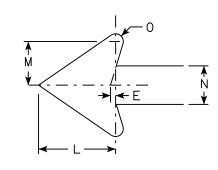

SIZE	Α	В	С	D	E	F	G	Н	I	J	K	L	М	N	0	Р	a	R	S	Т	U	٧	W	X	Y	Z	Area sq. ft.
1																											
2	21		1 1/8	3/8	3/8		7 1/2	8 3/4	4 1/4			5 1/4	3	2 5/8	1/2						1 1/2	1/2					3.06
3	30		1 3/8	1/2	5/8		10 3/4	12 1/2	6 3/4			7 1/2	4 1/4	3 3/4	3/4						1 1/8	1/2					6.25
4	30		1 3/8	1/2	5/8		10 3/4	12 1/2	6 3/4			7 1/2	4 1/4	3 3/4	3/4						1 1/8	1/2					6.25
5	30		1 3/8	1/2	5/8		10 3/4	12 1/2	6 3/4			7 1/2	4 1/4	3 3/4	3/4						1 1/8	1/2					6.25
																											==

COUNTY:

STANDARD SIGN M6-4 & M6-6 SERIES

WISCONSIN DEPT OF TRANSPORTATION

SHEET NO:

APPROVED

DATE 10/15/15

PLATE NO. M6-4.10 Ε

PLOT DATE . 01-DEC-2015 17.58

PLOT RY . \$\$ plotuser \$\$ PLOT NAME :

PLOT SCALE . 11 675051.1 000000


PROJECT NO:

NOTES 1. Sign is Type II - Type H Reflective - reference WIS DOT Standard Specification for HIGHWAY and STRUCTURE CONSTRUCTION latest edition. 2. Color: Background - Red Message - White 3. Message Series - C R1-1 SIZE A STANDARD SIGN 30 5/8 10 12 1/2 45° 12 3/4 5.18 2S 30 5/8 12 1/2 45° 12 3/4 10 5.18 R1-1 2M 36 3/4 12 15 45° 15 % 7.46 3/4 15 3/8 12 45° 36 15 7.46 WISCONSIN DEPT OF TRANSPORTATION 45° 20 1/2 48 16 20 13.25 APPROVED Matthew & Kauch 5 48 16 20 45° 20 1/2 13.25 3/8 7 3/4 45° 7 3/4 1.86 18 6 For State Traffic Engineer 12 1/4 4 45° 5 1/8 0.78 DATE <u>11/12/15</u> PLATE NO. _____R1-1.13 COUNTY: SHEET NO: PROJECT NO: HWY: PLOT SCALE • 4 378143•1 000000

FILE NAME · C·\CAFfiles\Projects\tr stdplote\R11 DGN

PLOT DATE . 01-DEC-2015 18:07

PINT RY . \$\$ plotuser \$\$ PINT NAMF :

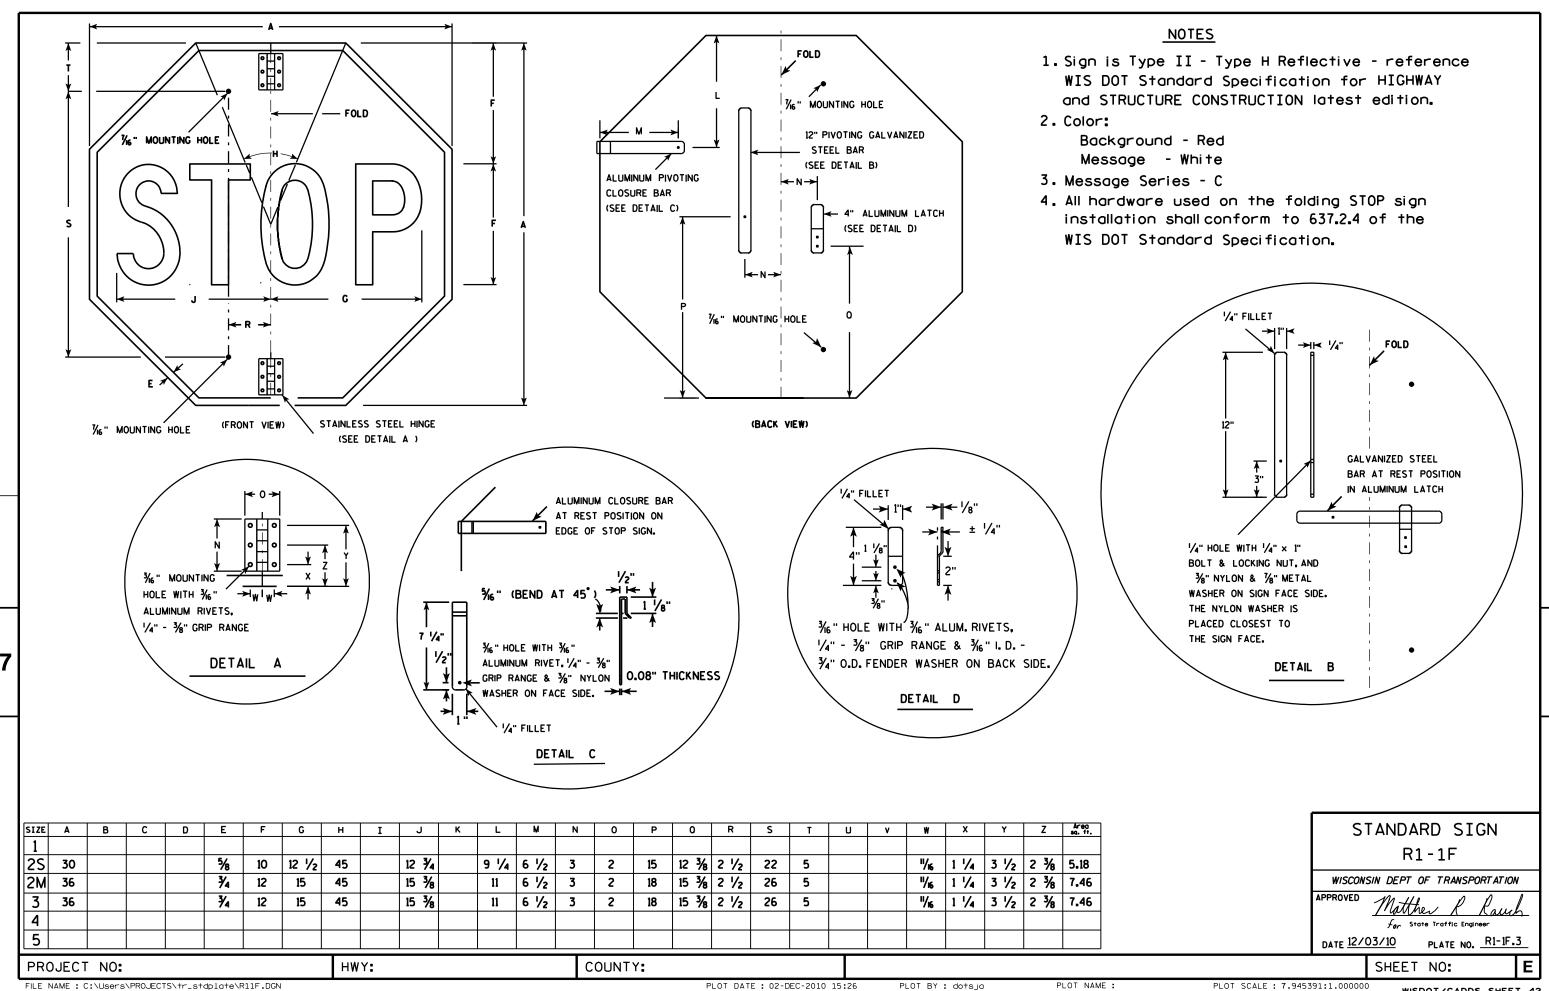

- 1. Sign is Type II Type H Reflective reference WIS DOT Standard Specification for HIGHWAY and STRUCTURE CONSTRUCTION latest edition.
- 2. Color:

Background - White Message - See note 5

- 3. Message Series C
- 4. Corners may be square or rounded when base material is plywood but borders shall be rounded as shown. When base material is metal, the corners and borders shall be rounded.
- 5. The border strip and word message are reflectorized red.

A	
c —	G
	¥ F ¥
E	
D.	
\\\\\\\\\\\\\\\\\\\\\\\\\\\\\\\\\\\\\\	
R1-2	

Areg sq. ft. K 0 0 Z SIZE С D Ε F G Н I J R S Т U Х 1 1/2 5/8 2 1/2 6 3/8 3 % 30 26 2.71 36 2 3/4 7 3/4 1 1/4 4 3/4 4 3/8 3.88 31 9 3/4 6 1/4 5 1/8 3 2 7.00 48 42 6 9 3/4 3 3 6 2 6 1/4 5 1/8 7.00 48 42 9 3/4 7.00 48 42 3 6 2 6 1/4 | 5 1/8 1 1/2 5 2 1/2 7 7/8 7 1/4 60 52 3 8 5 13 10.83 15 1/2 3/8 | 2 1/2 | 1 1/2 | 3 7/8 | 5/8 | 2 3/8 | 2 1/4 18 0.97

COUNTY:

STANDARD SIGN R1-2

WISCONSIN DEPT OF TRANSPORTATION

APPROVED

For State Traffic Engineer

PLATE NO. R1-2.12

DATE 10/13/14

SHEET NO:

FILE NAME : C:\CAEFiles\Projects\tr_stdplate\R12.DGN

HWY:

PROJECT NO:

PLOT DATE: 13-OCT-2014 15:12

PLOT NAME :

PLOT BY: mscsja

WISDOT/CADDS SHEET 42

PLOT SCALE: 5.837526:1.000000

- 1. Sign is Type II Type H Reflective
- 2. Color:

Background - Red Message - White

- 3. Message Series C
- 4. For 30"x30" R1-1 use 18"x6" R1-3P sign For 36"x36" R1-1 use 24"x9" R1-3P sign For 48"x48" R1-1 use 30"x12" R1-3P sign

E — H — — I — A —	C
R1-3	3P

7

SIZE	Α	В	С	D	E	F	G	Н	I	J	K	L	М	N	0	Р	Q	R	S	T	U	٧	W	X	Y	Z	Area sq. ft.
1	18	6	1 1/2		1/2	3		6 1/4	1 1/4	<i>7</i> ⁄8	6 3/8																0.75
25	18	6	1 1/2		1/2	3		6 1/4	1 1/4	<i>7</i> ⁄ ₈	6 3/8																1.5
2M	24	9	1 1/2		1/2	5		9 1/4	1 1/4	3/4	9 3/4																1.5
3	24	9	1 1/2		1/2	5		9 1/4	1 1/4	3∕4	9 3/4																1.5
4	30	12	2 1/4		5/8	6		11	2 1/4	1 1/2	11 3/4																2.5
5	30	12	2 1/4		5/8	6		11	2 1/4	1 1/2	11 3/4																2.5

COUNTY:

STANDARD SIGN R1-3P

WISCONSIN DEPT OF TRANSPORTATION

APPROVED

Matthew R Rauch
For State Traffic Engineer

DATE 11/29/16

PLATE NO. <u>R1-3P.3</u>

SHEET NO:

FILE NAME : C:\CAEfiles\Projects\tr_stdplate\R13P.DGN


HWY:

PROJECT NO:

PLOT DATE: 29-NOV-2016 14:03

PLOT BY: \$\$...plotuser...\$\$ PLOT NAME:

PLOT SCALE: 1.974123:1.000000

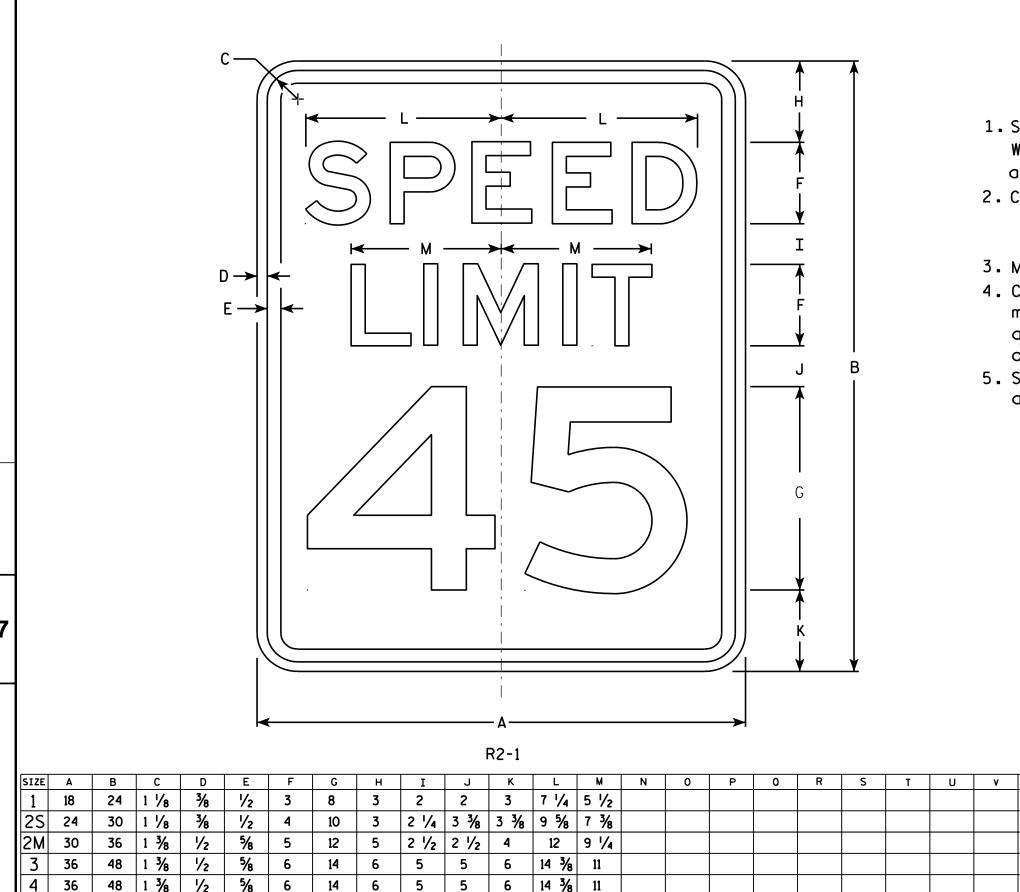

4 1/2 6 3/4 6 3/4 19 1/4 14 5/8

COUNTY:

20

HWY:

6

NOTES

- 1. Sign is Type II Type H Reflective reference WIS DOT Standard Specification for HIGHWAY and STRUCTURE CONSTRUCTION latest edition.
- 2. Color:

Background - White Message - Black

- 3. Message Series E
- 4. Corners may be square or rounded when base material is plywood but borders shall be rounded as shown. When base material is metal. the corners and borders shall be rounded.
- 5. Substitute appropriate numerals and optically adjust spacing to achieve proper balance.

3.0

5.0

7.5

12.0

12.0

20.0

STANDARD SIGN R2-1

WISCONSIN DEPT OF TRANSPORTATION APPROVED

Matther R Raus For State Traffic Engineer PLATE NO. R2-1.13

DATE <u>5/26/1</u>0

SHEET NO:

2 1/4


60

5

48

PROJECT NO:


PLOT NAME :

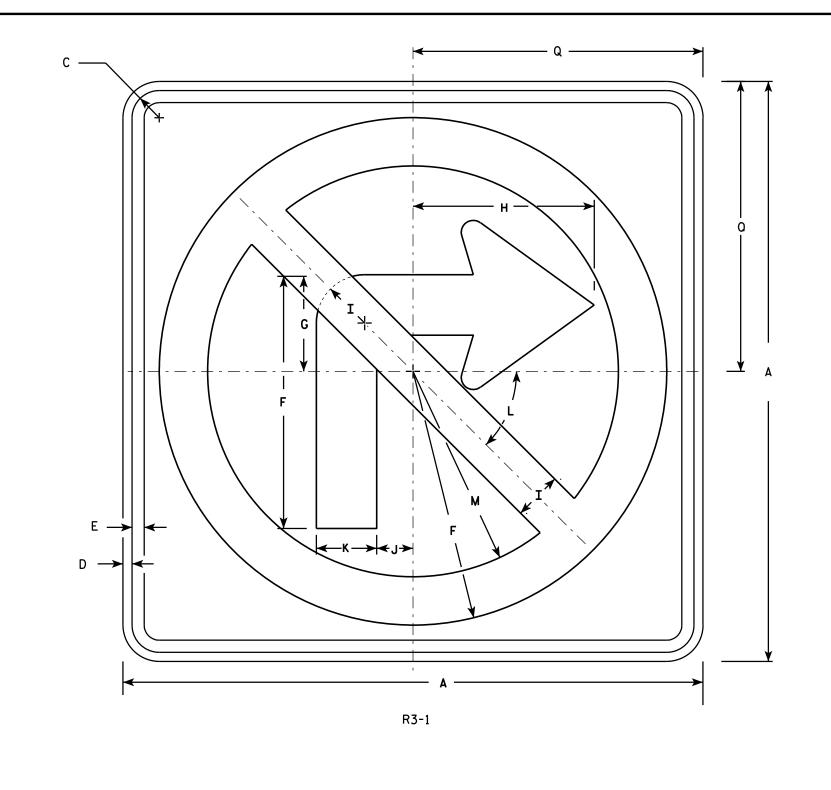

- 1. Sign is Type II Type H Reflective reference WIS DOT Standard Specification for HIGHWAY and STRUCTURE CONSTRUCTION latest edition.
- 2. Color:

Background - White Message - See note 4

- 3. Corners may be square or rounded when base material is plywood but borders shall be rounded as shown. When base material is metal, the corners and borders shall be rounded.
- 4. Border & Arrow are non reflective black, the circle with diagonal bar is reflective red.

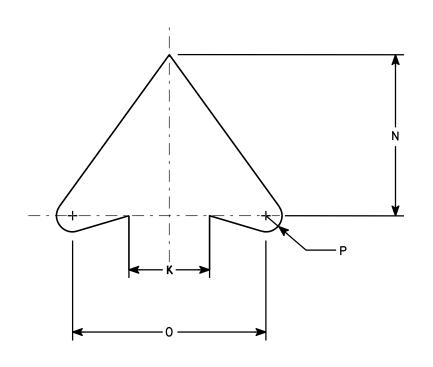

ARROW DETAIL

PLOT NAME :

SIZE	Α	В	С	D	E	F	G	Н	I	J	K	L	M	N	0	Р	0	R	S	T	U	V	W	Х	Y	Z	Area sq. ft.
1	24		1 1/8	3/8	1/2	10 1/2	4	7 1/2	2	1 1/2	2 1/2	45	8 1/2	5	6	1/2	12										4.0
2S	24		1 1/8	3/8	1/2	10 1/2	4	7 1/2	2	1 1/2	2 1/2	45 °	8 ½	5	6	1/2	12										4.0
2M	36		1 %	5/8	3/4	15 ¾	6	11 1/4	3	2 1/4	3 3/4	45	12 3/4	7 1/2	9	3/4	18										9.0
3	36		1 %	5/8	3/4	15 3/4	6	11 1/4	3	2 1/4	3 3/4	45	12 3/4	7 1/2	9	3/4	18										9.0
4	36		1 %	5/8	3/4	15 3/4	6	11 1/4	3	2 1/4	3 3/4	45°	12 3/4	7 1/2	9	3/4	18										9.0
5	48		2 1/4	3/4	1	21	8	15	4	3	5	45°	17	10	12	1	24										16.0
PRO	JECT	NO:			·		ŀ	HWY:	·			·	СО	UNTY:			·			·		·	·			·	

STANDARD SIGN R3-1


WISCONSIN DEPT OF TRANSPORTATION

APPROVED Matther

DATE12/08/10

PLATE NO. __R3-1.5

SHEET NO:

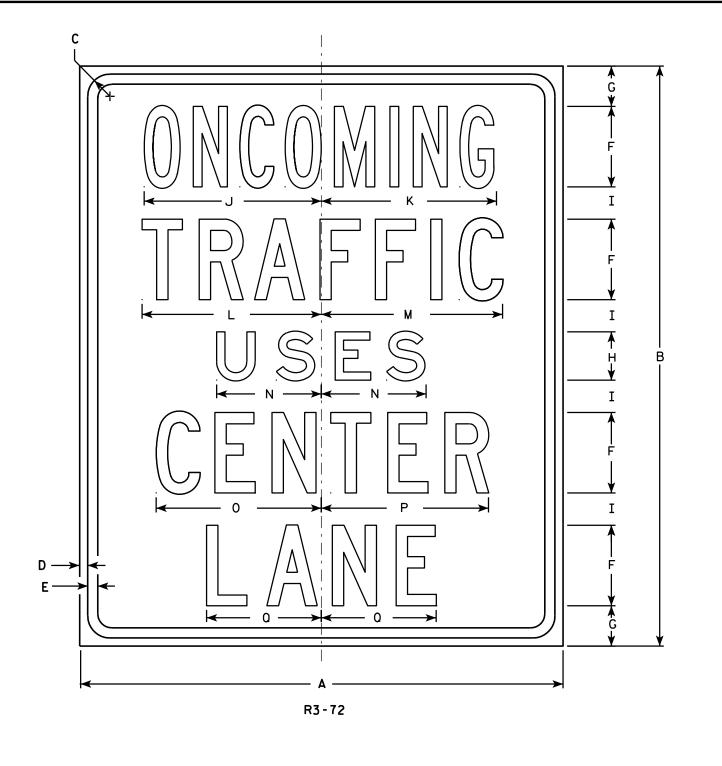

- 1. Sign is Type II Type H Reflective reference WIS DOT Standard Specification for HIGHWAY and STRUCTURE CONSTRUCTION latest edition.
- 2. Color:

Background - White Message - Black

- 3. Message Series Line 1 is Series B, Lines 2, 4 and 5 are Series C, and Line 3 is Series E.
- 4. Corners may be square or rounded when base material is plywood but borders shall be rounded as shown. When base material is metal, the corners and borders shall be rounded.

SIZE	Α	В	С	D	E	F	G	I	I	7	K	L	М	N	0	Р	0	R	S	T	U	٧	W	X	Y	Z	Area sq. ft.
1	30	36	1 3/8	1/2	5/8	5	2 1/2	3	2	11	10 %	11 1/8	11 1/4	6 1/2	10 1/4	10 3/8	7 1/8										7.50
2S	30	36	1 3/8	1/2	5/8	5	2 1/2	3	2	11	10 %	11 1/8	11 1/4	6 1/2	10 1/4	10 3/8	7 1/8										7.50
2M	30	36	1 3/8	1/2	5/8	5	2 1/2	3	2	11	10 1/8	11 1/8	11 1/4	6 1/2	10 1/4	10 3/8	7 1/8										7.50
3																											
4																											
5	·															·											

COUNTY:

STANDARD SIGN R3-72

WISCONSIN DEPT OF TRANSPORTATION

APPROVED

₹ar State Traffic Engineer

DATE 3/25/2011 PLATE NO. R3-72.5

SHEET NO:

FILE NAME : C:\Users\PROJECTS\tr_stdplate\R372.DGN

HWY:


PROJECT NO:

PLOT DATE: 25-MAR-2011 13:16

PLOT NAME :

PLOT BY: mscsja

PLOT SCALE: 5.959043:1.000000

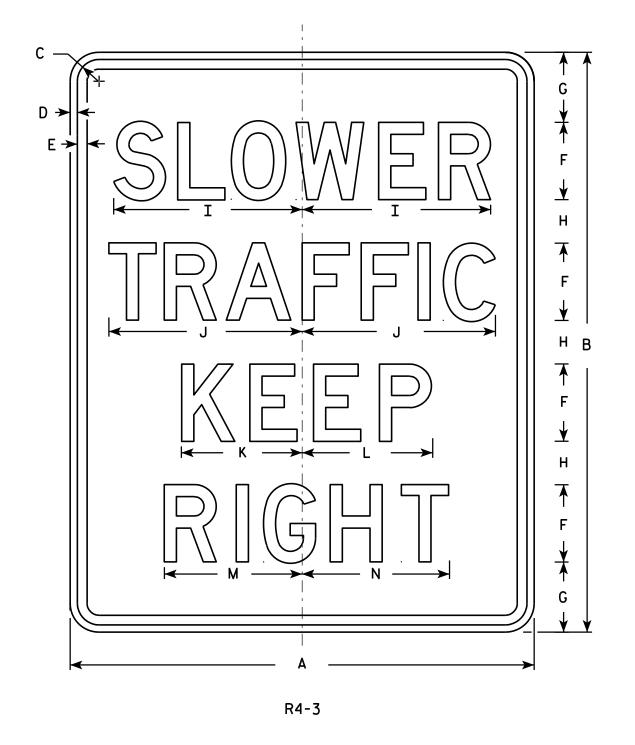

- 1. Sign is Type II Type H Reflective reference WIS DOT Standard Specification for HIGHWAY and STRUCTURE CONSTRUCTION latest edition.
- 2. Color:

Background - White Message - Black

- 3. Message Series D
- 4. Corners may be square or rounded when base material is plywood but borders shall be rounded as shown. When base material is metal, the corners and borders shall be rounded.

SIZE A В С G 2S 24 3/8 10 6 1/4 6 3/4 7 1/8 7 5/8 30 | 1 1/8 1/2 | 3 % | 2 1/4 | 9 ¾ | 5.0 3 % 2 1/4 9 3/4 10 6 1/4 6 3/4 7 1/8 7 5/8 1/2 5.0 24 30 | 1 1/8 48 1 1 1 1 1 1 1 1 1 1 1 1 1 5/8 3/4 15 9 3/8 14 % 10 10 3/4 11 3/8 12.0 36 10 3/4 11 3/8 3/4 15 9 % 10 36 1 % 12.0 48 5 7 1/4 4 1/2 19 1/2 20 12 1/2 13 1/2 14 1/4 15 1/4 48 60 2 1/4 20.0

STANDARD SIGN R4-3

WISCONSIN DEPT OF TRANSPORTATION

APPROVED

WED Matthew & Rauch

State Traffic Engineer

DATE 3/25/2011 PLATE NO. R4-3.8

SHEET NO:

FILE NAME : C:\Users\PROJECTS\tr_stdplate\R43.DGN

PROJECT NO:

PLOT DATE: 25-MAR-2011 13:40

PLOT BY: mscsja

R4-51

HWY:

NOTES

- 1. Sign is Type II Type H Reflective reference WIS DOT Standard Specification for HIGHWAY and STRUCTURE CONSTRUCTION latest edition.
- 2. Color:

Background - White Message - Black

- 3. Message Series C
- 4. Corners may be square or rounded when base material is plywood but borders shall be rounded as shown. When base material is metal, the corners and borders shall be rounded.

SIZE	Α	В	C	D	E	F	G	Н	I	J	K	L	M	N	0	Р	0	R	S	T	U	V	W	×	Y	Z	Areo sq. ft.
1																											
25	36	48	1 3/8	1/2	5/8	6	9	4 1/2	3 1/2	4	5	13 %	14 1/2	8	11 3/8	10 3/4	4	1/2	14 1/8								12.0
2M	36	48	1 3/8	1/2	5/8	6	9	4 1/2	3 1/2	4	5	13 %	14 1/2	8	11 3/8	10 ¾	4	1/2	14 1/8								12.0
3																											
4																											
5																											

COUNTY:

STANDARD SIGN R4-51

WISCONSIN DEPT OF TRANSPORTATION

PPROVED

Matthew R

Fac. State Traffic Engineer

DATE 3/29/2011 PLATE NO. R4-51.4

SHEET NO:

FILE NAME : C:\Users\PROJECTS\tr_stdplate\R451.DGN

PROJECT NO:

PLOT DATE: 29-MAR-2011 10:36

PLOT NAME :

PLOT BY: mscsja

PLOT SCALE: 8.938567:1.000000

1. Sign is Type II - Type H Reflective - reference WIS DOT Standard Specification for HIGHWAY and STRUCTURE CONSTRUCTION latest edition.

2. Color:

Background - White Message - Black

- 3. Message Series C
- 4. Corners may be square or rounded when base material is plywood but borders shall be rounded as shown. When base material is metal, the corners and borders shall be rounded.

C —	1
PASSING LANGE LANGE	★K ★ F ★ J ★ F ★ I ★ G → H ★ ★ F ★ I ★ F ★ H ★
R4-51A	

SIZE	Α	В	С	D	Ε	F	G	Н	I	J	K	L	М	N	0	Р	0	R	S	T	J	٧	W	X	Y	Z	Area sq. ft.
1																											
2S	36	48	1 3/8	1/2	5/8	6	9 1/4	4 1/2	3 1/2	4	5	13 5/8	14 1/2	8	11 3/8	10 ¾	4	5 ½	13 3/8	3 1/4							12.0
2M	36	48	1 3/8	1/2	5/8	6	9 1/4	4 1/2	3 1/2	4	5	13 %	14 1/2	8	11 3/8	10 ¾	4	5 ½	13 %	3 1/4							12.0
3																											
4																											
5																											

COUNTY:

STANDARD SIGN R4-51A

WISCONSIN DEPT OF TRANSPORTATION

APPROVED

For State Traffic Engineer
DATE 3/29/2011 PLATE NO. R4-51A.2

SHEET NO:

FILE NAME : C:\Users\PROJECTS\tr_stdplate\R451A.DGN

PROJECT NO:


HWY:

PLOT DATE: 29-MAR-2011 10:43

PLOT BY: mscsja

PLOT NAME :

PLOT SCALE: 8.938567:1.000000

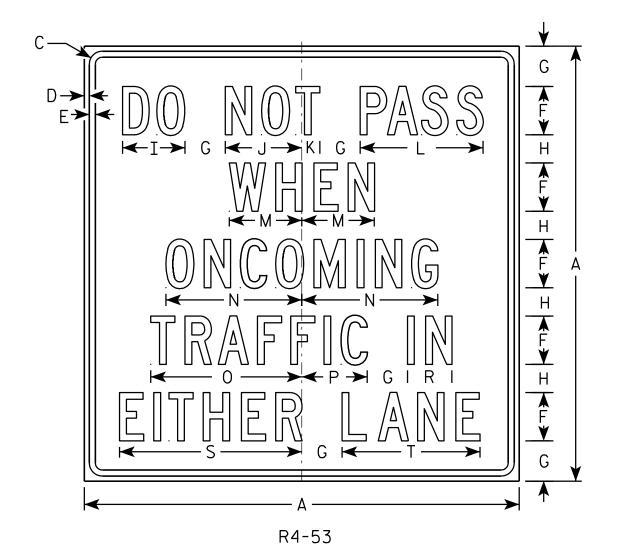

- 1. Sign is Type II Type H Reflective reference WIS DOT Standard Specification for HIGHWAY and STRUCTURE CONSTRUCTION latest edition.
- 2. Color:

Background - WHITE Message - BLACK

- 3. Message Series C
- 4. Corners may be square or rounded when base material is plywood but borders shall be rounded as shown. When base material is metal, the corners and borders shall be rounded.

2S 3 1/2 7 3/4 9 1/2 2 1/4 15 1/4 5 1/2 22 5/8 17 1/8 5/8 54 1 1/8 3/4 9 16 % 18 ¾ 8 1/8 20.25 6 2M 3 1/2 7 3/4 9 1/2 2 1/4 15 1/4 5 1/2 22 5/8 17 1/8 54 16 1/8 18 3/4 8 1/8 20.25 3 4 5 PROJECT NO: HWY: COUNTY:

STANDARD SIGN R4-53

WISCONSIN DEPT OF TRANSPORTATION

APPROVED

For State Traffic Engineer DATE 6/2/10 PLATE NO. R4-53.1

SHEET NO:

PLOT DATE: 02-JUN-2010 13:53 PLOT NAME : PLOT BY: ditjph




- 1. Sign is Type II Type H Reflective reference WIS DOT Standard Specification for HIGHWAY and STRUCTURE CONSTRUCTION latest edition.
- 2. Color:

Background - White Message - Red

- 3. Message Series See Note 5
- 4. Corners may be square or rounded when base material is plywood but borders shall be rounded as shown. When base material is metal, the corners and borders shall be rounded.
- 5. Lines 1, 3 and 4 are series C, line 2 is series B.
- 6. R7-1D (double arrow)

R7-1L (left arrow)

R7-1R (right arrow)

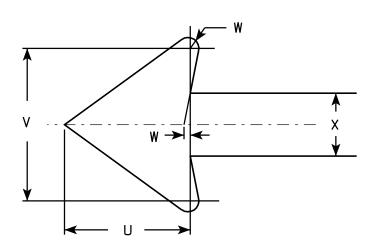

R7-1

SIZE	Α	В	С	D	E	F	G	Н	I	J	K	L	M	N	0	Р	0	R	S	Т	U	٧	W	X	Y	Z	Area sq. ft.
1	12	18	1 1/8	3/8	3/8	3	1 %	2	%	5/8	1 1/2	2 1/2	2	2	4 %	4 1/8	2 1/4	2 1/8	2 1/2	3 %	1 1/2	1 3/4	1/8	3/4			1.5
2S	18	24	1 1/8	3/8	1/2	4	2 1/2	2 1/2	1 1/4	1	2	3 1/4	2 3/4	2 %	7 1/8	7	2 3/4	2 %	3 1/8	5 %	2 1/4	2 5/8	1/4	1 1/8			3.0
2M	24	30	1 1/8	3/8	1/2	5	3	3	2	1 1/4	2 1/2	4	3 1/4	3 3/8	9 1/4	9 1/4	3 1/4	3 1/4	3 3/4	7 3/4	3	3 1/2	1/4	1 1/2			5.0
3	24	30	1 1/8	3/8	1/2	5	3	3	2	1 1/4	2 1/2	4	3 1/4	3 3/8	9 1/4	9 1/4	3 1/4	3 1/4	3 3/4	7 3/4	3	3 1/2	1/4	1 1/2			5.0
4																											
5																											

COUNTY:

STANDARD SIGN R7-1

WISCONSIN DEPT OF TRANSPORTATION

APPROVED

ROVED

Matthew Rauch

For State Traffic Engineer

DATE 3/31/2011

1 PLATE NO. R7-1.9
SHEET NO:

FILE NAME : C:\Users\PROJECTS\tr_stdplate\R71.DGN

HWY:

PROJECT NO:

PLOT DATE: 31-MAR-2011 09:20

PLOT BY: mscsja

PLOT NAME :

PLOT SCALE: 3.476110:1.000000

1. Sign is Type II - Type H Reflective - reference WIS DOT Standard Specification for HIGHWAY and STRUCTURE CONSTRUCTION latest edition.

2. Color:

Background - White Message - Black

- 3. Message Series See Note 5
- 4. Corners may be square or rounded when base material is plywood but borders shall be rounded as shown. When base material is metal, the corners and borders shall be rounded.
- 5. Line 1 is Series E.
 Lines 2, 3 and 4 are Series C.

R9-55

7

SIZE	Α	В	С	D	E	F	G	Н	I	J	K	L	М	Z	0	Р	0	R	Ŋ	T	U	٧	W	X	Y	Z	Area sq. ft.
1																											
2S	18	24	1 1/8	3/8	1/2	4	3	2 1/2	1 1/8	2 1/8	1 1/4	2 1/4	3 3/4	7 1/4	7 1/2	5 ½											3.0
2M	18	24	1 1/8	3/8	1/2	4	3	2 1/2	1 1/8	2 1/8	1 1/4	2 1/4	3 3/4	7 1/4	7 1/2	5 ½											3.0
3																											
4																											
5																											

COUNTY:

STANDARD SIGN R9-55

WISCONSIN DEPT OF TRANSPORTATION

APPROVED Matthew R Raw For State Traffic Engineer


DATE 4/4/2011 PLATE NO. R9-55.6

SHEET NO:

HWY:

PROJECT NO:

PLOT BY: mscsja

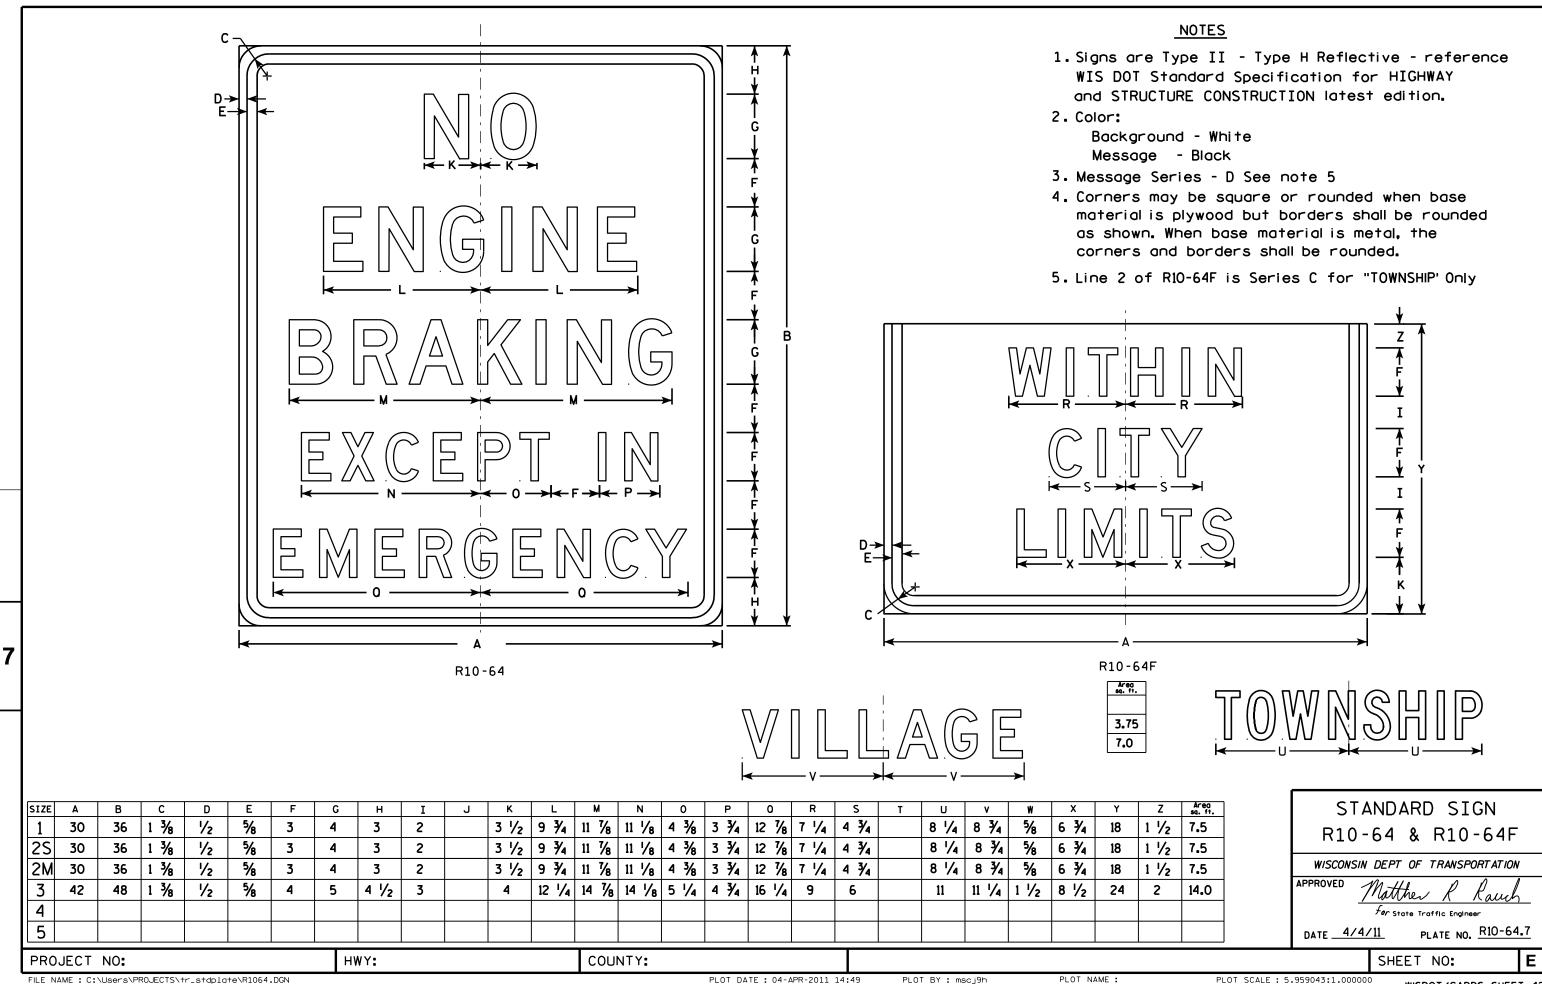


FILE NAME : C:\Users\PROJECTS\tr_stdplate\R1064.DGN

PLOT DATE: 04-APR-2011 14:49

PLOT NAME :

PLOT SCALE: 5.959043:1.000000

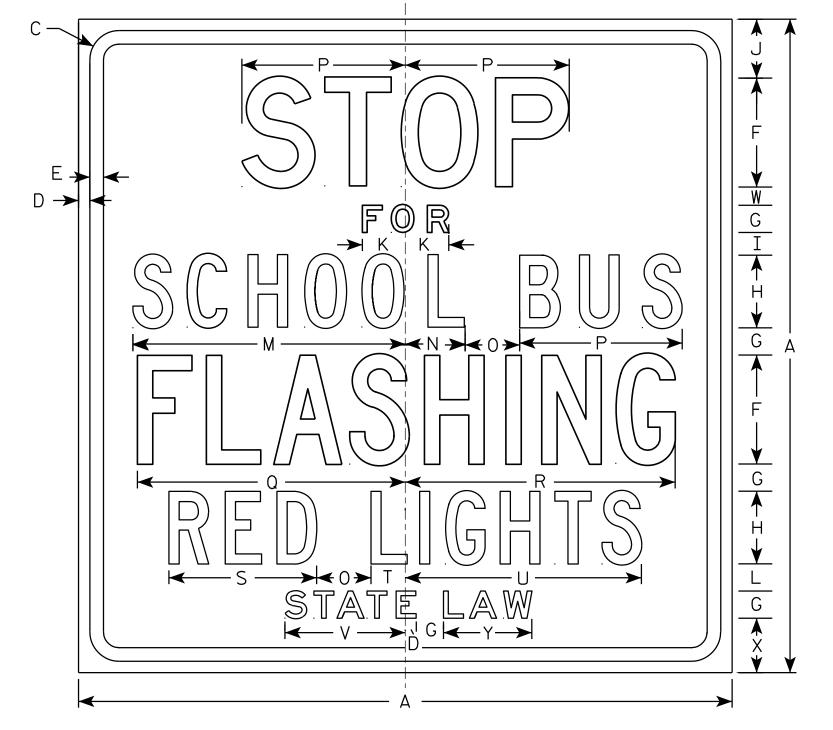

- 1. Sign is Type II Type H Reflective reference WIS DOT Standard Specification for HIGHWAY and STRUCTURE CONSTRUCTION latest edition.
- 2. Color:

Background - White Message - Black

- 3. Message Series See note 5
- 4. Corners may be square or rounded when base material is plywood but borders shall be rounded as shown. When base material is metal, the corners and borders shall be rounded.
- 5. Line 1 is Series D
 Lines 2 & 6 are Series E
 Line 3,4 & 5 are Series C

R59-51

SIZE	Α	В	C	D	E	F	G	Н	I	J	K	L	М	N	0	Р	0	R	S	T	U	V	W	X	Y	Z'	Area sq. ft.
1																											
25	36		1 %	5/8	3/4	6	1 1/2	4	1 1/4	3 1/4	2 3/8	1 1/2	15	3 1/4	3	9	14 3/4	14 %	8 1/8	1 %	13	6 %	1	3	4 %		9.0
2M	36		1 %	5/8	3/4	6	1 1/2	4	1 1/4	3 1/4	2 3/8	1 1/2	15	3 1/4	3	9	14 3/4	14 %	8 1/8	1 %	13	6 %	1	3	4 1/8		9.0
3	48		2 1/4	3/4	1	8	2	6	1 1/4	4 3/4	3 1/4	1 1/2	20 1/4	5	3 %	12	19 1/2	20	11 5/8	3 3/4	19	9 1/2	1	3 1/2	6 3/4		16.0
4	48		2 1/4	3/4	1	8	2	6	1 1/4	4 3/4	3 1/4	1 1/2	20 1/4	5	3 %	12	19 1/2	20	11 5/8	3 3/4	19	9 1/2	1	3 1/2	6 3/4		16.0
5																											
		•		•	•				-					•	-		•	•	_	•	•	•					

COUNTY:

STANDARD SIGN R59-51

WISCONSIN DEPT OF TRANSPORTATION

APPROVED

Matther R Rauch

For State Traffic Engineer

DATE 3/30/11 PLATE NO. R59-51.10

SHEET NO:

FILE NAME : C:\Users\PROJECTS\tr_stdplate\R5951.DGN

HWY:

PROJECT NO:

30-MAR-2011 09:59

PLOT DATE: 30-MAR-2011 09:59

PLOT NAME :


PLOT BY: mscj9h

PLOT SCALE: 5.287650:1.000000

- 1. Sign is Type II Type F Reflective reference WIS DOT Standard Specification for HIGHWAY and STRUCTURE CONSTRUCTION latest edition.
- 2. Color:

Background - Yellow Message - Black

- 3. Corners may be square or rounded when base material is plywood but borders shall be rounded as shown. When base material is metal, the corners and borders shall be rounded.
- 4. W1-2L is the same as W1-2R except the arrow is reversed along the vertical centerline.

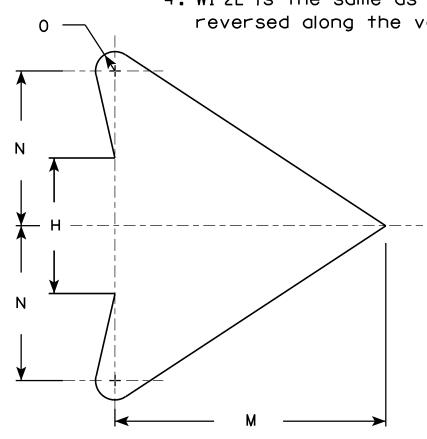

								W	1-2R													<u> </u>	11011	DLIA	<u></u>		
SIZE	Α	В	С	D	E	F	G	н	I	J	К	L	M	N	0	Р	0	R	S	Т	U	v	W	×	Y	Z	Area sq. ft.
1	24		1 1/8	3/8	1/2		8 1/4	3 1/2	4 1/2	1 3/4	2 3/8	7 1/4	7	4	1/2												4.0
25	30		1 3/8	1/2	5/8		10 1/4	4 3/8	5 %	2 1/4	3	9 1/8	8 3/4	5	5/8												6.25
2M	36		1 %	5/8	3/4		12 3/8	5 1/4	6 3/4	2 %	3 1/2	10 1/8	10 1/2	6	3/4												9.0
3	36		1 5/8	5/8	3/4		12 3/8	5 1/4	6 3/4	2 %	3 1/2	10 1/8	10 1/2	6	3/4												9.0
4	36		1 5/8	5/8	3/4		12 3/8	5 1/4	6 3/4	2 %	3 1/2	10 1/8	10 1/2	6	3/4												9.0
5	48		2 1/4	3/4	1		16 1/2	7	9	3 1/2	4 5/8	14 1/2	14	8	1												16.0
					•	·		•	•									•					•				•

COUNTY:

STANDARD SIGN W1-2

WISCONSIN DEPT OF TRANSPORTATION

APPROVED

Matther R Rauch For State Traffic Engineer

DATE <u>5/15/12</u>


PLATE NO. W1-2.10

SHEET NO:

PROJECT NO:

← H →

HWY:

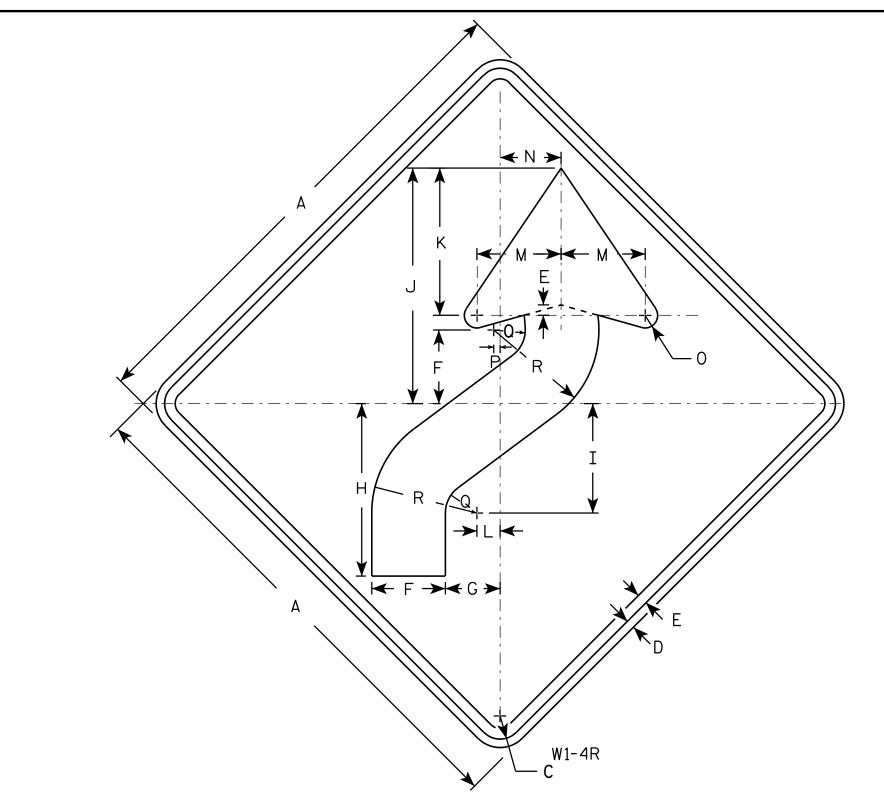

- 1. Sign is Type II Type F Reflective reference WIS DOT Standard Specification for HIGHWAY and STRUCTURE CONSTRUCTION latest edition.
- 2. Color:

Background - Yellow Message - Black

- 3. Corners may be square or rounded when base material is plywood but borders shall be rounded as shown. When base material is metal, the corners and borders shall be rounded.
- 4. W1-4L is the same as W1-4R except the arrow is reversed along the vertical centerline.

3 1/2 2 5/8 8 1/4 5 1/4 11 1/4 5/8 1/4 1 1/2 5 24 1 1/8 4.0 25 3 5/8 3/4 3/8 1 1/8 6 1/4 30 4 3/8 3 1/4 10 1/4 6 1/2 14 8 3/4 1 3/8 6.25 36 12 3/8 7 1/8 16 1/8 10 1/2 1 5/8 4 1/2 1 1/2 2 1/4 7 1/2 9.0 3 12 3/8 7 1/8 16 1/8 10 1/2 1 5/8 36 5 1/4 4 1/2 | 1 1/2 2 1/4 7 1/2 9.0 4 36 1 % 5 1/4 | 12 3/8 | 7 3/8 | 16 3/8 | 10 1/2 | 1 5/8 4 1/2 1 2 1/4 7 1/2 1/2 9.0 5 48 5 1/4 16 1/2 10 1/2 22 1/2 14 2 1/4 6 1 1/4 16.0

STANDARD SIGN W1-4

WISCONSIN DEPT OF TRANSPORTATION

APPROVED

Matthe R Raw
For State Traffic Engineer

SHEET NO:

DATE 5/17/12

PLATE NO. W1-4.11

HWY:

COUNTY:

PLOT DATE: 17-MAY-2012 13:20 PLOT BY: mscsja

PLOT NAME :

PLOT SCALE: 5.706180:1.000000

WISDOT/CADDS SHEET 42

PROJECT NO:

- 1. Sign is Type II Type F Reflective reference WIS DOT Standard Specification for HIGHWAY and STRUCTURE CONSTRUCTION latest edition.
- 2. Color:

Background - Yellow Message - Black

3. Corners may be square or rounded when base material is plywood but borders shall be rounded as shown. When base material is metal, the corners and borders shall be rounded.

c —	A A
	G
↑ ↑ ↑ ↑ ↑ ↑ ↑ ↑ ↑ ↑ ↑ ↑ ↑ ↑ ↑ ↑ ↑ ↑ ↑	_
$\begin{array}{c ccccccccccccccccccccccccccccccccccc$	
W1-6	

SIZE	Α	В	С	D	E	F	G	Н	I	J	K	L	М	N	0	Р	0	R	S	Т	U	٧	W	X	Y	Z	Area sq. ft.
1	36	18	1 1/8	3/8	3/8		9	10	3/4	5 %	4 3/4	2 3/8	14 %	29 1/4													4.5
2S	48	24	1 3/8	1/2	5/8		12	13 1/4	1	7 1/2	6 1/2	3 1/4	19 1/2	39													8.0
2M	48	24	1 3/8	1/2	5/8		12	13 1/4	1	7 1/2	6 1/2	3 1/4	19 1/2	39													8.0
3	60	30	1 3/8	1/2	5/8		15	16 1/4	1 1/4	9 1/4	8	4	24 3/8	48 3/4													12.5
4	60	30	1 3/8	1/2	5/8		15	16 1/4	1 1/4	9 1/4	8	4	24 3/8	48 ¾													12.5
5	96	48	2 1/4	3/4	1		24	26 1/2	2	15	13	6 1/2	39	78													32.0

COUNTY:

STANDARD SIGN W1-6

WISCONSIN DEPT OF TRANSPORTATION

APPROVED

For

DATE 6/7/10 PLATE NO. W1-6.8

SHEET NO:

HWY:


PROJECT NO:

PLOT NAME :

- 1. Sign is Type II Type F Reflective reference WIS DOT Standard Specification for HIGHWAY and STRUCTURE CONSTRUCTION latest edition.
- 2. Color:

Background - Yellow Message - Black

3. Corners may be square or rounded when base material is plywood but borders shall be rounded as shown. When base material is metal, the corners and borders shall be rounded.

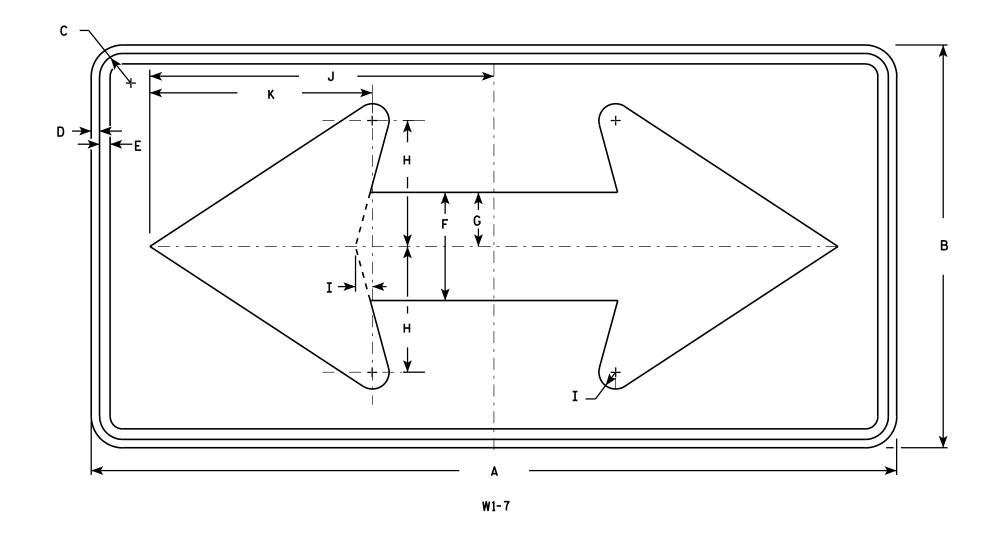

SIZE	Α	В	С	D	E	F	G	Н	I	J	K	L	М	N	0	Р	0	R	S	T	U	٧	₩	Х	Y	Z	Area sq. ft.
1	36	18	1 1/8	3⁄8	1/2	5	2 1/2	5 ¾	3/4	15 5/8	10 1/8																4.5
2S	48	24	1 3/8	1/2	5/8	6 1/2	3 1/4	7 1/2	1	20 1/2	13 1/4																8.0
2M	48	24	1 3/8	1/2	5/8	6 1/2	3 1/4	7 1/2	1	20 1/3	13 1/4																8.0
3	60	30	1 3/8	1/2	5/8	8	4	9 1/4	1 1/4	25 3/8	16 1/4																12.5
4	60	30	1 3/8	1/2	5/8	8	4	9 1/4	1 1/4	25 3/	16 1/4																12.5
5	96	48	2 1/4	3/4	1	13	6 1/2	15	2	41	26 1/2																32.0

COUNTY:

STANDARD SIGN W1-7

WISCONSIN DEPT OF TRANSPORTATION

APPROVED

Matthew R

For State Traffic Engineer

DATE 6/7/10 PLATE NO. W1-7.7

SHEET NO:

FILE NAME : C:\Users\PROJECTS\tr_stdplate\W17.DGN

PROJECT NO:


HWY:

PLOT DATE: 07-JUN-2010 12:35

PLOT BY : ditjph

PLOT NAME :

PLOT SCALE: 5.720679:1.000000

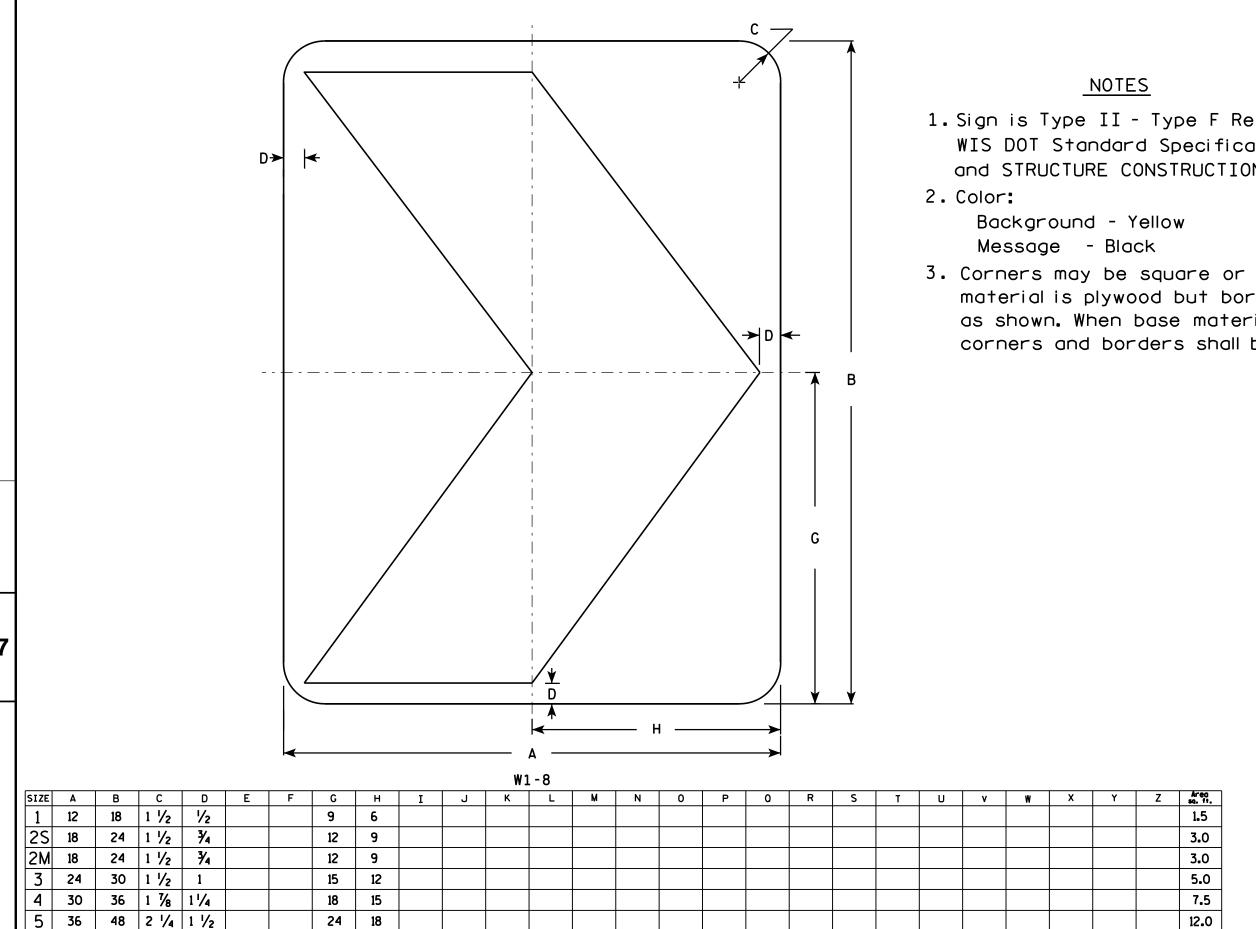

1. Sign is Type II - Type F Reflective - reference WIS DOT Standard Specification for HIGHWAY and STRUCTURE CONSTRUCTION latest edition.

3. Corners may be square or rounded when base material is plywood but borders shall be rounded as shown. When base material is metal, the corners and borders shall be rounded.

> STANDARD SIGN W1 - 8

WISCONSIN DEPT OF TRANSPORTATION

APPROVED

For State Traffic Engineer PLATE NO. W1-8.6

DATE 6/7/10


SHEET NO:

PROJECT NO:

- 1. Sign is Type II Type F Reflective reference WIS DOT Standard Specification for HIGHWAY and STRUCTURE CONSTRUCTION latest edition.
- 2. Color:

Background - Yellow Message - Black

- 3. Corners may be square or rounded when base material is plywood but borders shall be rounded as shown. When base material is metal, the corners and borders shall be rounded.
- 4. W1-10L is the same as W1-10R except the arrow is reversed along the vertical centerline.

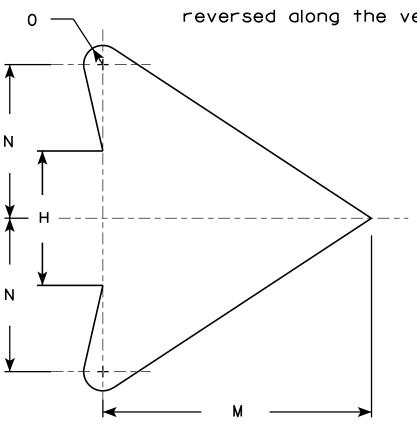

ARROW	DE	TAIL

SIZE	Δ	В	С	D	E	F	G	Н	I	7	K	L	М	N	0	Р	0	R	S	T	U	v	W	X	Y	Z	Areo sq. ft.
1	24		1 1/8	3/8	1/2		8 1/4	3 1/2	4 1/2	1 3/4	2 3/8	7 1/4	7	4	1/2	2 %	6 %	2 1/8	4 1/2	45°							4.0
25	30		1 3/8	1/2	5/8		10 1/4	4 3/8	5 %	2 1/4	3	9 1/8	8 3/4	5	5/8	3 %	8	2 %	5 ¾	45°							6.25
2M	36		1 %	5/8	3/4		12 3/8	5 1/4	6 ¾	2 %	3 1/2	10 1/8	10 1/2	6	3/4	4	10	3 1/4	6 %	45°							9.0
3	36		1 %	5/8	3/4		12 3/8	5 1/4	6 ¾	2 %	3 1/2	10 1/8	10 1/2	6	3/4	4	10	3 1/4	6 1/8	45 °							9.0
4	36		1 %	5/8	3/4		12 3/8	5 1/4	6 ¾	2 %	3 1/2	10 1/8	10 1/2	6	3/4	4	10	3 1/4	6 1/8	45°							9.0
5	48		2 1/4	₹4	1		16 1/2	7	9	3 1/2	4 %	14 1/2	14	8	1	5 3/8	13 1/4	4 1/4	9 1/8	45°							16.0

COUNTY:

W1 - 10

STANDARD SIGN

WISCONSIN DEPT OF TRANSPORTATION

For State Traffic Engineer DATE <u>5/17/12</u> PLATE NO. W1-10.3

SHEET NO:

FILE NAME : C:\CAEFiles\Projects\tr_stdplate\W110.DGN

PROJECT NO:

.|← H →|← P→

HWY:

W1-10R

PLOT DATE: 17-MAY-2012 10:14

PLOT BY: mscsja

PLOT SCALE: 6.251989:1.000000

- 1. Sign is Type II Type F Reflective reference WIS DOT Standard Specification for HIGHWAY and STRUCTURE CONSTRUCTION latest edition.
- 2. Color:

Background - Yellow Message - Black

3. Corners may be square or rounded when base material is plywood but borders shall be rounded as shown. When base material is metal, the corners and borders shall be rounded.

W2-2

SIZE	Α	В	С	D	E	F	G	Н	I	J	K	L	М	N	0	Ρ	0	R	S	T	د	V	W	X	Y	Z	Areo sq. 11.
1	24		1 1/8	3∕8	1/2	20	2	4	10	8																	4.0
25	30		1 3/8	1/2	5/8	25	2 1/2	5	12 1/2	10																	6.25
2M	30		1 3/8	1/2	5/8	25	2 1/2	5	12 1/2	10																	6.25
3	36		1 5/8	5/8	3/4	30	3	6	15	12																	9.0
4	48		2 1/4	3/4	1	40	4	8	20	16																	16.0
5																											

COUNTY:

STANDARD SIGN W2-2

WISCONSIN DEPT OF TRANSPORTATION

APPROVED

Matthew R Rauch For State Traffic Engineer

SHEET NO:

DATE 5/29/12

PLATE NO. <u>W2-2.6</u>

FILE NAME : C:\CAEFiles\Projects\tr_stdplate\W22.DGN

PROJECT NO:


HWY:

PLOT DATE: 29-MAY-2012 10:18

PLOT NAME :

PLOT BY: mscsja

PLOT SCALE: 6.202372:1.000000

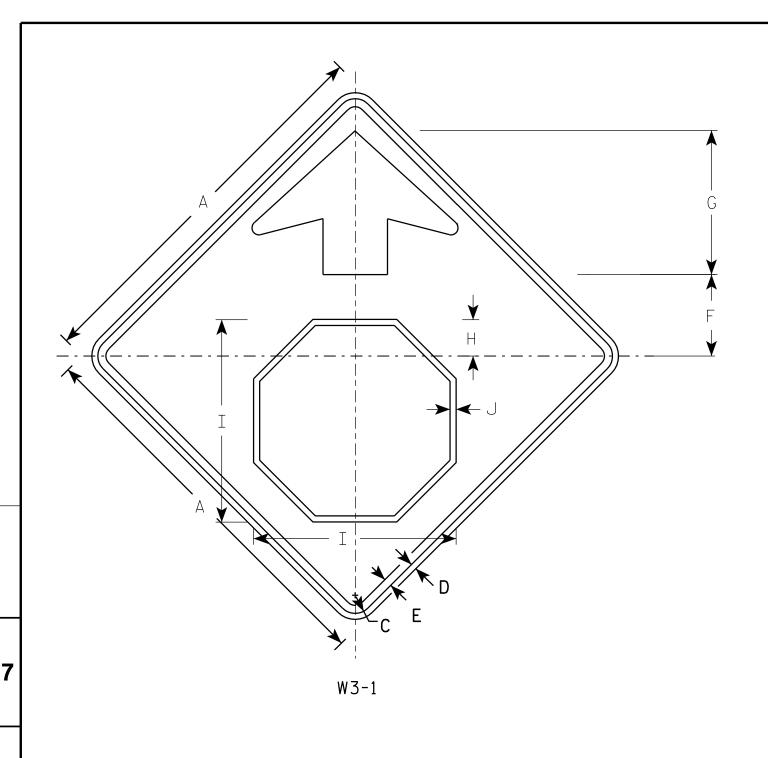


- 1. All Signs Type II Type F Reflective reference WIS DOT Standard Specification for HIGHWAY and STRUCTURE CONSTRUCTION latest edition.
- 2. Color:

Background - YELLOW

Arrow & Border - BLACK

Stop Symbol - WHITE BORDER ON RED BACKGROUND

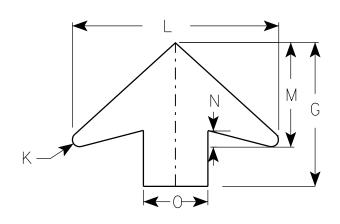

ARROW	DFTAII
$\neg \cdots $	

SIZE	Α	В	С	D	E	F	G	Н	I	J	K	L	М	N	0	Ρ	0	R	S	T	U	٧	W	X	Y	Z	Area sq. ft.
1	30		1 3/8	1/2	5/8	6 1/4	11 1/4	2 1/8	15 ¾	1/2	1/2	16	8	1 1/4	5												6.25
2S	36		1 %	5/8	3/4	7 1/2	13 1/2	3 1/2	19	5/8	5/8	19 1/4	9 3/4	1 %	6												9.0
2M	36		1 %	5/8	3/4	7 1/2	13 1/2	3 1/2	19	5/8	5/8	19 1/4	9 3/4	1 %	6												9.0
3	36		1 1/8	5/8	3/4	7 1/2	13 1/2	3 1/2	19	5/8	5/8	19 1/4	9 3/4	1 %	6												9.0
4	48		2 1/4	3/4	1	10	17 1/8	4 1/2	25 1/8	3/4	7 ⁄8	25 %	13	2	8												16.0
5	48		2 1/4	3/4	1	10	17 1/8	4 1/2	25 1/8	₹4	7 /8	25 %	13	2	8												16.0

STANDARD SIGN W3-1

WISCONSIN DEPT OF TRANSPORTATION

APPROVED Matthew

For State Traffic Engineer

DATE 6/7/10 PLATE NO. W3-1.12

SHEET NO:


PROJECT NO:

- 1. Sign is Type II Type F Reflective reference WIS DOT Standard Specification for HIGHWAY and STRUCTURE CONSTRUCTION latest edition.
- 2. Color: *

 Background YELLOW*

 Message BLACK
- 3. Message Series C for numbers Series E for wording
- 4. Substitute appropriate numerals and optically adjust spacing to achieve proper balance

*Speed Limit Sign shall have a White Background

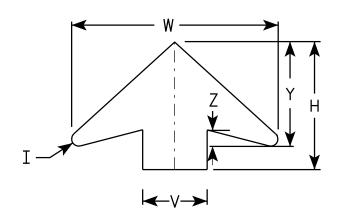

ARROW DETAIL

SIZE	Α	В	С	D	E	F	G	н	I	J	K	L	М	N	0	Р	0	R	S	T	U	٧	W	X	Y	Z	Area sq. ft
1																											
25	36		1 1/8	5/8	3/4	14 1/2	9 1/2	11 1/2	5/8	24	2	3	1	12	7 1/8	1 1/2	3/8	5 3/4	7 1/4	7 1/8	9	6	19 1/4	3/8	9 3/4	1 %	9.0
2M	36		1 %	5/8	3/4	14 1/2	9 1/2	11 1/2	5/8	24	2	3	1	12	7 1/8	1 1/2	3/8	5 3/4	7 1/4	7 1/8	9	6	19 1/4	3/8	9 3/4	1 %	9.0
3	36		1 %	5/8	3/4	14 1/2	9 1/2	11 1/2	5/8	24	2	3	1	12	7 1/8	1 1/2	3∕8	5 3/4	7 1/4	7 1/8	9	6	19 1/4	3/8	9 3/4	1 %	9.0
4	48		2 1/4	3/4	1	19 1/4	10 3/4	17 3/8	1 /8	30	2 1/4	4	1 1/4	15	10	1 %	1/2	8	9 1/4	9 3/8	12	8	25 %	3∕8	13	2	16.0
5	48		2 1/4	3/4	1	19 1/4	10 3/4	17 3/8	⅓	30	2 1/4	4	1 1/4	15	10	1 5/8	1/2	8	9 1/4	9 3/8	12	8	25 5/8	3/8	13	2	16.0

STANDARD SIGN W3-5

WISCONSIN DEPT OF TRANSPORTATION

APPROVED

Matther R Rauch.

DATE 5/29/12 PLATE NO. W3-5.5


SHEET NO:

PROJECT NO:

- 1. Sign is Type II Type F Reflective reference WIS DOT Standard Specification for HIGHWAY and STRUCTURE CONSTRUCTION latest edition.
- 2. Color:

Background - Yellow Message - Black

- 3. Corners may be square or rounded when base material is plywood but borders shall be rounded as shown. When base material is metal, the corners and borders shall be rounded.
- 4. W4-2L is the same as W4-2R except the symbolis reversed along the vertical centerline.

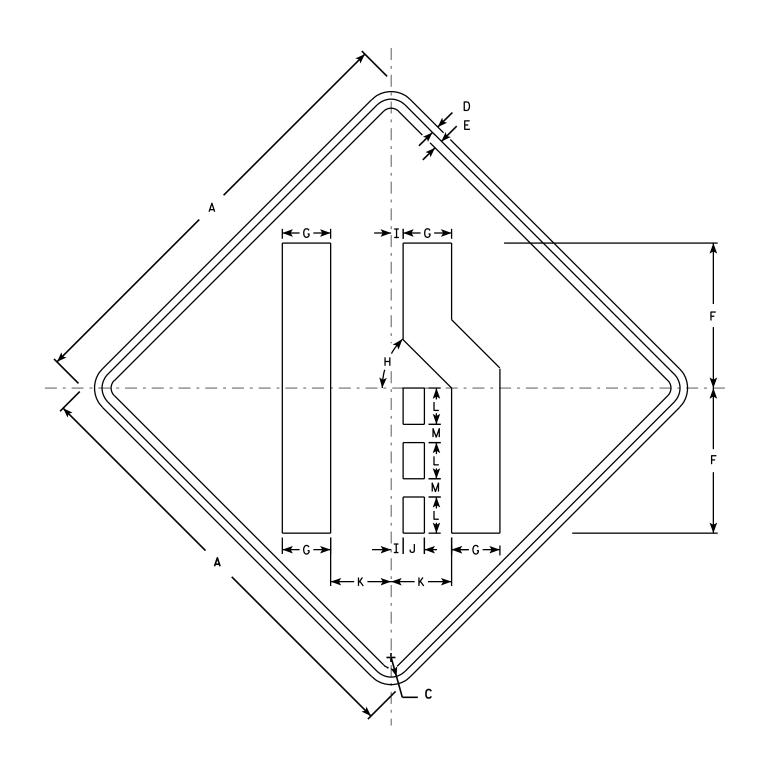

W4-2R

Z	Y	Х	W	٧	U	T	S	R	0	Р	0	N	M	L	K	J	I	Н	G	F	E	D	С	В	Α	SIZE
													1 1/4	2 1/2	4 1/4	1 1/2	1 / ₈	45°	3 %	10	5/8	1/2	1 3/8		30	1
	1												1 1/2	3	5	1 3/4	1	45°	4	12	3/4	5/8	1 %		36	25
	1												1 1/2	3	5	1 3/4	1	45°	4	12	3/4	5/8	1 %		36	2M
9													1 1/2	3	5	1 3/4	1	45°	4	12	3/4	5/8	1 1/8		36	3
1													2	4	6 ¾	2 3/8	1 1/4	45°	5	16	1	3/4	2 1/4		48	4
	1												2	4	6 3/4	2 3/8	1 1/4	45°	5	16	1	3/4	2 1/4		48	5
=	=												2	4	6 3/4	2 3/8	1 1/4	45°	5 3/8	16	1	3 /4	2 1/4	NO:	48 JECT	

STANDARD SIGN W4-2

WISCONSIN DEPT OF TRANSPORTATION

APPROVED

DATE 3/12/13

PLATE NO. W4-2.14 SHEET NO:


For State Traffic Engineer

FILE NAME : C:\CAEFiles\Projects\tr_stdplate\W42.DGN

PLOT DATE: 12-MAR-2013 11:09

PLOT BY: mscsja



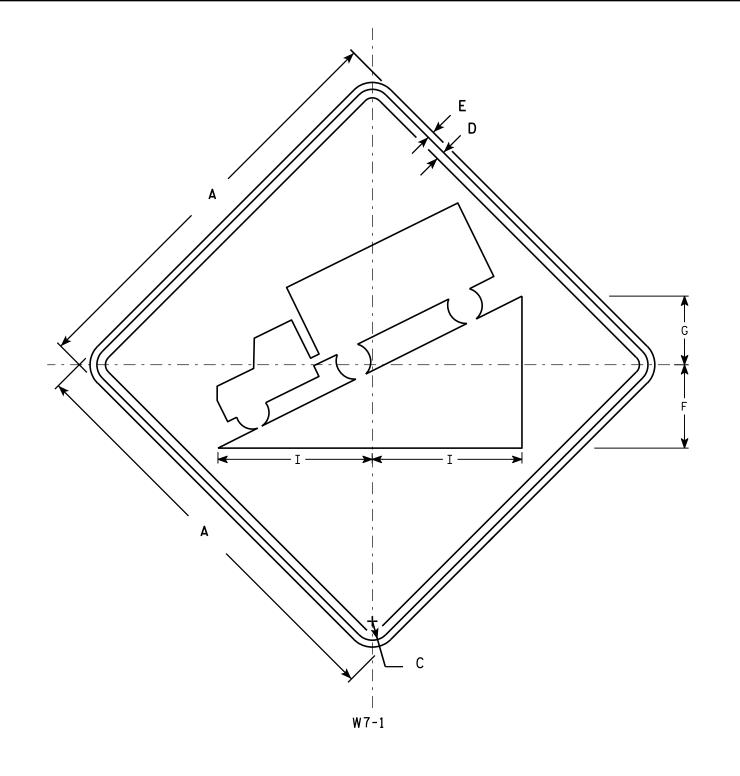

<u>NOTES</u>

- 1. Sign is Type II Type F Reflective reference WIS DOT Standard Specification for HIGHWAY and STRUCTURE CONSTRUCTION latest edition.
- 2. Color:

Background - Yellow Message - Black

- 3. Message Series D
- 4. Corners may be square or rounded when base material is plywood but borders shall be rounded as shown. When base material is metal, the corners and borders shall be rounded.

SIZE	A	В	С	D	Ε	F	G	Н	I	J	K	L	М	N	0	Р	0	R	S	T	U	٧	W	X	Y	Z	Area sq. ft.
1	24		1 1/8	3/8	3/8	5	4		8 3/4																		4.0
2S	30		1 3/8	1/2	5/8	6	5		11																		6.25
2M	36		1 %	5/8	3/4	7 1/4	6		13 1/4																		9.0
3	36		1 %	5/8	3/4	7 1/4	6		13 1/4																		9.0
4	36		1 %	5/8	3/4	7 1/4	6		13 1/4																		9.0
5	48		2 1/4	3/4	1	9 3/4	8		17 1/2											·		·					16.0

COUNTY:

STANDARD SIGN W7-1

WISCONSIN DEPT OF TRANSPORTATION

APPROVED

for St

DATE 03/12/13 PLATE NO. W7-1.13

SHEET NO:

FILE NAME : C:\CAEFiles\Projects\tr_stdplate\W71.DGN

PROJECT NO:

HWY:

PLOT DATE: 12-MAR-2013 14:38

PLOT BY: mscsja


PLOT NAME :

PLOT SCALE : 6.946657:1.000000

- 1. Sign is Type II Type F Reflective reference WIS DOT Standard Specification for HIGHWAY and STRUCTURE CONSTRUCTION latest edition.
- 2. Color:

Background - Yellow Message - Black

- 3. Corners may be square or rounded when base material is plywood but borders shall be rounded as shown. When base material is metal, the corners and borders shall be rounded.
- 4. Substitute appropriate numeral and optically adjust spacing to achieve proper balance.

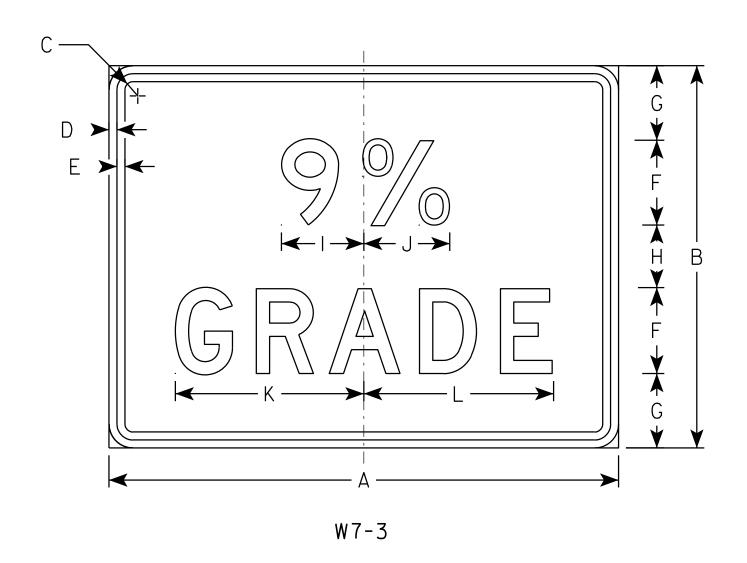

SIZE	Α	В	С	D	E	F	G	Н	I	J	К	L	М	N	0	Р	0	R	S	Т	U	v	w	x	Y	Z	Area sq. ft.
1																											
25	24	18	1 1/8	3/8	3/8	4	3 1/2	3	3 1/8	4	8 %	9															3.0
2M	24	18	1 1/8	3/8	3/8	4	3 1/2	3	3 %	4	8 %	9															3.0
3																											
4																											
5																											
PROJ	ECT	NO:					HW	/Y:					COUN	ITY:													

STANDARD SIGN W7-3

WISCONSIN DEPT OF TRANSPORTATION

APPROVED

Matthew R

For State Traffic Engineer

DATE 03/12/13 PLATE NO. W7-3.4

SHEET NO:

FILE NAME : C:\CAEFiles\Projects\tr_stdplate\W73.DGN

PLOT DATE: 12-MAR-2013 14:48

PLOT BY: mscsja

PLOT NAME :

PLOT SCALE: 4.521529:1.000000



- 1. Sign is Type II Type F Reflective reference WIS DOT Standard Specification for HIGHWAY and STRUCTURE CONSTRUCTION latest edition.
- 2. Color:

Background - Yellow Message - Black

- 3. Message Series D
- 4. Corners may be square or rounded when base material is plywood but borders shall be rounded as shown. When base material is metal, the corners and borders shall be rounded.

W8-14

SIZE	Α	В	С	D	Е	F	G	Н	I	J	K	L	М	N	0	Р	0	R	S	T	U	٧	W	Х	Y	Z	Area sq. ft.
1																											
25	30		1 3/8	1/2	5/8	5	1 1/8	2 1/2	11 3/4	10 1/8																	6.25
2M	36		1 %	5⁄8	3/4	6	1 3/8	3	14	12 1/8																	9.0
3	36		1 5/8	5⁄8	3/4	6	1 3/8	3	14	12 1/8																	9.0
4	36		1 5/8	5⁄8	3/4	6	1 3/8	3	14	12 1/8																	9.0
5	48		2 1/4	3/4	1	8	1 3/4	4	18 ¾	16 1/4				·							·						16.0

COUNTY:

W8 - 14WISCONSIN DEPT OF TRANSPORTATION APPROVED

STANDARD SIGN

For State Traffic Engineer

DATE 03/14/13

SHEET NO:

FILE NAME: C:\CAEFiles\Projects\tr_stdplate\W814.DGN

HWY:

PROJECT NO:

PLOT DATE: 14-MAR-2013 10:51

PLOT BY: mscsja

PLOT NAME :

PLOT SCALE: 6.276799:1.000000

WISDOT/CADDS SHEET 42

PLATE NO. W8-14.2



- 1. Sign is Type II Type F Reflective reference WIS DOT Standard Specification for HIGHWAY and STRUCTURE CONSTRUCTION latest edition.
- 2. Color:

Background - Yellow Message - Black

- 3. Message Series D
- 4. Corners may be square or rounded when base material is plywood but borders shall be rounded as shown. When base material is metal, the corners and borders shall be rounded.
- 5. W9-1L same as W9-1R except the word Left replaces Right.

	I -			J —							-1R						G A	F F F F F F F F F F F F F F F F F F F	
+	C 3/	D I/-	E 5/	F	G	9 1/-	I	J	K	L	M	N	0	Р	0	R	S	T	U

SIZE	Α	В	С	D	E	F	G	Н	I	J	К	L	M	N	0	Р	0	R	S	Т	U	v	W	Х	Y	Z	Area sq. ft.
1	30		1 3/8	1/2	5/8	5	1 1/2	2 1/2	7 1/8	7 %	9 1/4	8 1/8	7 %	8 %													6.25
2S	36		1 5/8	5/8	3/4	6	2	3	8 1/2	9 1/8	11	9 3/4	9	10 3/8													9.0
2M	36		1 5/8	5/8	3/4	6	2	3	8 1/2	9 1/8	11	9 3/4	9	10 3/8													9.0
3	36		1 5/8	5/8	3/4	6	2	3	8 1/2	9 1/8	11	9 3/4	9	10 3/8													9.0
4	36		1 5/8	5/8	3/4	6	2	3	8 ½	9 1/8	11	9 3/4	9	10 3/8													9.0
5	48		2 1/4	3/4	1	8	3	4	11 1/4	12 1/4	14 3/4	12 1/8	12 1/4	13 %													16.0
PRO.	JECT	NO:																									

STANDARD SIGN W9-1

WISCONSIN DEPT OF TRANSPORTATION

APPROVED

For State Traffic Engineer

DATE 03/18/13

PLATE NO. W9-1.8

SHEET NO:

1. Sign is Type II - Type F Reflective - reference WIS DOT Standard Specification for HIGHWAY and STRUCTURE CONSTRUCTION latest edition.

2. Color:

Background - Yellow Message - Black

3. Corners may be square or rounded when base material is plywood but borders shall be rounded as shown. When base material is metal, the corners and borders shall be rounded.

W11-6	

3/8 9 1/2 4 1/2 10 1/4 1 1/8 24 4.0 25 11 1/2 5 5/8 12 3/4 1 3/8 1/2 5/8 6.25 30 2M 1 3/8 1/2 11 1/2 5 5/8 12 3/4 30 6.25 3 1 1/8 5/8 3/4 14 1/8 6 3/4 15 1/4 9.0 36 4 3/4 48 2 1/4 19 9 20 1/2 16.0 5

COUNTY:

STANDARD SIGN W11-6

WISCONSIN DEPT OF TRANSPORTATION

APPROVED Matther R Rauch ∱er State Traffic Engineer DATE 3/13/13 PLATE NO. W11-6.8

SHEET NO:

FILE NAME : C:\CAEFiles\Projects\tr_stdplate\W116.DGN

HWY:

PROJECT NO:

PLOT DATE: 13-MAR-2013 12:57

PLOT BY : mscj9h

PLOT NAME :

PLOT SCALE : 5.954276:1.000000


WISDOT/CADDS SHEET 42

Ε

- 1. Sign is Type II Type F Reflective reference WIS DOT Standard Specification for HIGHWAY and STRUCTURE CONSTRUCTION latest edition.
- 2. Color:

Background - Yellow Message - Black

3. Corners may be square or rounded when base material is plywood but borders shall be rounded as shown. When base material is metal, the corners and borders shall be rounded.

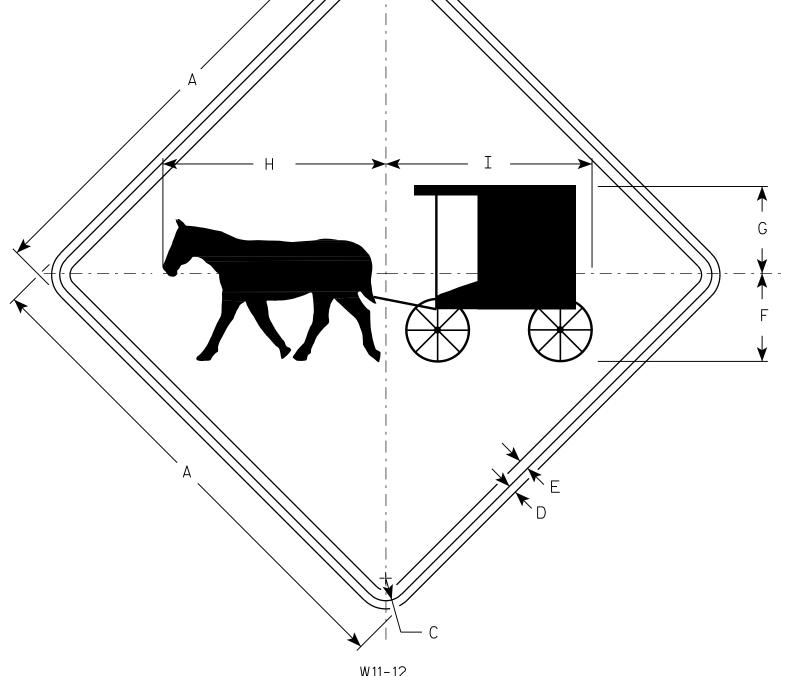

W 11-12	-
---------	---

HWY:

/4 13 5/8 12 5/8 3/8 16 3/8 15 1/8	J K	L M	N O	P 0	R	S	T U	V	W	X	Y	Z Area sq. ft. 6.25
3/ ₈ 16 3/ ₈ 15 1/ ₈												
3/ 45 3/ 45 1/												9.0
3 ₈ 16 3 ₈ 15 1/ ₈												9.0
/2 21 1/8 20 1/8												16.0
-												

COUNTY:

STANDARD SIGN W11-12

WISCONSIN DEPT OF TRANSPORTATION


APPROVED

DATE 3/13/13 PLATE NO. W11-12.4

SHEET NO:

PROJECT NO:

PLOT NAME :

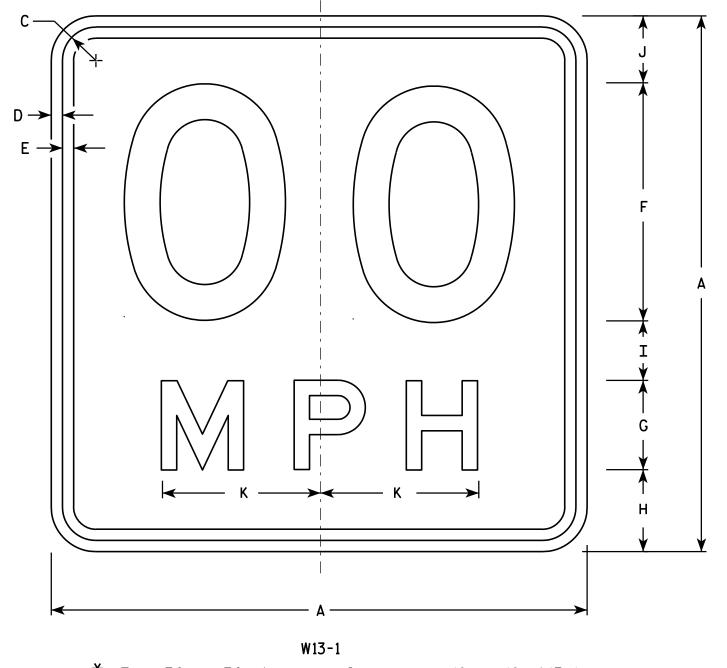

- 1. Sign is Type II Type F Reflective reference WIS DOT Standard Specification for HIGHWAY and STRUCTURE CONSTRUCTION latest edition.
- 2. Color:

Background - Yellow Message - Black

- 3. Message Series See Note 6
- 4. Corners may be square or rounded when base material is plywood but borders shall be rounded as shown. When base material is metal, the corners and borders shall be rounded.
- 5. Substitute appropriate numerals and optically space about centerline to achieve proper balance.
- 6. Line 1 is Series D Line 2 is Series E

* For 30" \times 30" Warning Signs, use 18" \times 18" W13-1 signs. For 36" \times 36" Warning Signs, use 24" \times 24" W13-1 signs.

SIZE	A	В	С	D	E	F	G	Н	I	J	K	L	М	N	0	Р	0	R	S	T	U	٧	W	X	Y	Z	Area sq. ft.
1	18		1 1/8	3∕8	3/8	8	3	2 3/4	2	2 1/4	5 3/8																2.25
* 2S	18		1 1/8	3∕8	3/8	8	3	2 3/4	2	2 1/4	5 %																2.25
* 2M	18		1 1/8	3/8	3/8	8	3	2 3/4	2	2 1/4	5 3/8																2.25
3	24		1 1/8	3/8	1/2	10	4	4	2 3/4	3 1/4	6 5/8																4.00
4	36		1 1/8	5/8	3/4	16	6	5 1/2	4	4 1/2	10 %																9.00
5	36		1 5/8	5/8	3/4	16	6	5 1/2	4	4 1/2	10 %																9.00

STANDARD SIGN W13-1

WISCONSIN DEPT OF TRANSPORTATION

APPROVED

Matthew & Ram

 f_{or} State Traffic Engineer S1/12 PLATE NO. W13-1.16

DATE <u>5/31/12</u>

SHEET NO:


FILE NAME : C:\CAEFiles\Projects\tr_stdplate\W131.DGN


PLOT DATE: 31-MAY-2012 10:57

PLOT NAME :

PLOT BY: mscsja

PLOT SCALE: 3.225232:1.000000

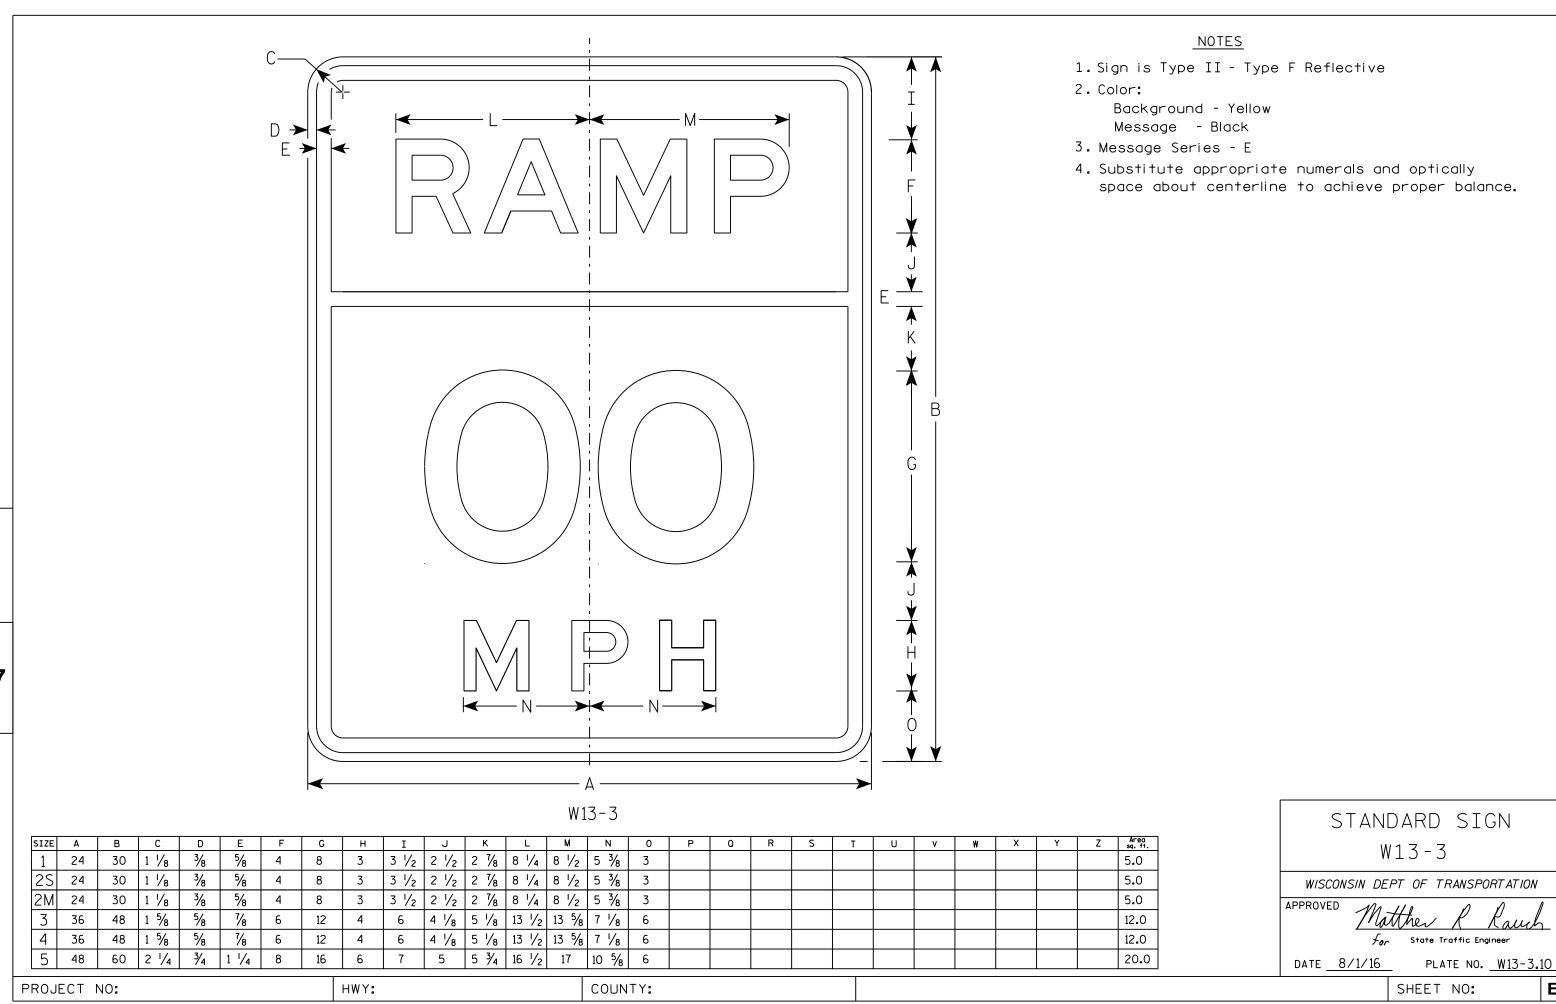

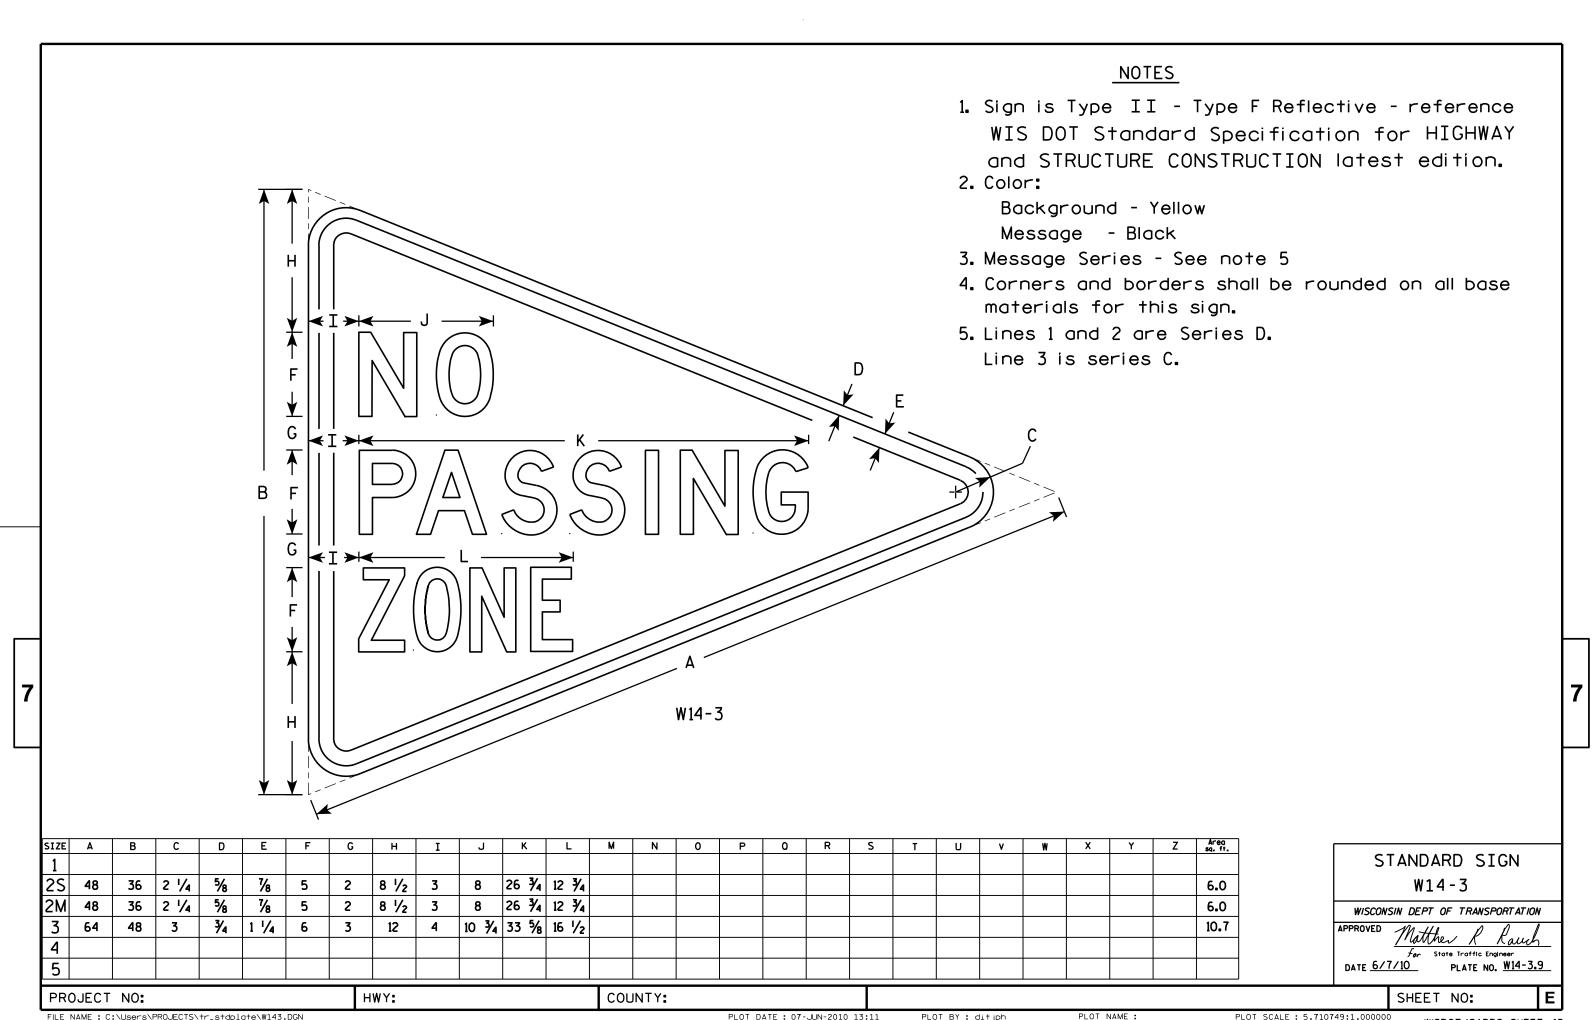

FILE NAME : C:\Users\PROJECTS\tr_stdplate\W143.DGN

PLOT DATE: 07-JUN-2010 13:11

PLOT BY: ditjph

PLOT SCALE: 5.710749:1.000000



Wisconsin Department of Transportation

Dedicated people creating transportation solutions through innovation and exceptional service.

http://www.dot.wisconsin.gov