MAR 2017

ORDER OF SHEETS

Section No. 1 Section No. 2 Typical Sections and Details Section No. 3 Estimate of Quantitles Miscellaneous Quantitles Section No. 3 Section No. 4 Right of Way Plat

Section No. 5 Plan and Profile Section No. 6 Standard Detail Drawings

Section No. 7 Sign Plates Section No. 8 Structure Plans

Section No. 9 Computer Earthwork Data Section No. 9 Cross Sections

TOTAL SHEETS = 170



DESIGN DESIGNATION

A.A.D.T.	=	NZZ
A.A.D.T.	=	Nzz
D.H.V.	=	NZZ
D.D.	=	Nz
T.	=	Nzz
DESIGN SPEED	=	Nz

= N/A

ESALS

STATE OF WISCONSIN DEPARTMENT OF TRANSPORTATION

STATE HIGHWAY REHABILITATION-MAINTENANCE PROJECT

STATE PROJECT	FEDERAL PROJECT				
STATE PROJECT	PRDJECT	CONTRACT			
1180-00-63					
1540-00-60		_			
1550-01-60		_			
8070-00-60	-				
8120-00-60					
8510-01-60	_				

AMERY - MILLTON

(YORK PARK ENTRANCE TO USH 8)

STH 46 POLK COUNTY

STATE PROJECT NUMBER 8070-00-60

RIVER FALLS - NEW RICHMOND

(USH 12 TO CTH G) **STH 65** ST. CROIX COUNTY

> STATE PROJECT NUMBER 1540-00-60

BRULE - INO

(SZNAIDER ROAD TO CTH A) USH 2

BAYFIELD COUNTY

STATE PROJECT NUMBER 1180-00-63

PORT WING - SUPERIOR

(EAST COUNTY LINE TO CTH F) **STH 13**

DOUGLAS COUNTY

STATE PROJECT NUMBER 8510-01-60

C CUMBERLAND, ELM ST AND 2ND AVE

(WEST JUNCTION STH 48 TO CHARRIE LN)

USH 63 BARRON COUNTY

> STATE PROJECT NUMBER 1550-01-60

MCKINLEY - RICE LAKE


(STH 25 TO WEST AVENUE)

STH 48 BARRON COUNTY

> STATE PROJECT NUMBER 8120-00-60

TDTAL NET LENGTH OF CENTERLINE = PROJECT 1180-00-63: 5.69 MI PROJECT 1550-01-60: PROJECT 8510-01-60: PROJECT 8070-00-60: PROJECT 8120-00-60; 3.86 MI PROJECT 1540-00-60; 5.47 MI

BAYFIELD DOUGLAS ASHLAND SAWYER BURNETT RUSK TAYLOR LAYOUT

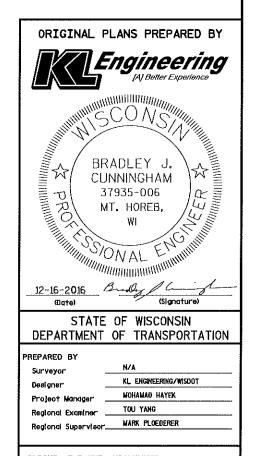

4.95 MI

= 37.98 MI

2|

GENERAL NOTES

THE ENGINEER WILL DETERMINE ANY DETAILS OF CONSTRUCTION NOT SHOWN ON THE PLAN.

ALL WASTE MATERIAL RESULTING FROM THE VARIOUS OPERATIONS UNDER THIS CONTRACT SHALL BE COLLECTED TO BE PROPERLY DISPOSED OF PRIOR TO REOPENING LANES TO TRAFFIC.

THE LOCATION OF EXISTING AND PROPOSED UTILITY INSTALLATIONS AS SHOWN ON THE PLANS ARE APPROXIMATE. THERE MAY BE OTHER UTILITY INSTALLATIONS WITHIN THE PROJECT AREA THAT ARE NOT SHOWN.

WHEN AN EXISTING STOP SIGN/SUPPORT IS TO BE REMOVED AND A NEW STOP SIGN/SUPPORT ERECTED, THE WORK SHALL BE DONE CONCURRENTLY. FOR ALL OTHER SIGNS THE REMOVAL OF THE EXISTING SIGN/SUPPORT AND ERECTION OF THE NEW SIGN/SUPPORT SHOULD BE DONE AS CONCURRENTLY AS POSSIBLE. IN NO CASE SHALL A NEW SIGN/SUPPORT BE DOWN FOR MORE THAN 24 HOURS AND THERE SHALL NOT BE MORE THAN ONE SIGN OF THE SAME LEGEND MISSING IN A ROW.

WOOD POST SIZES, FOR TYPE II SIGNING, ARE ESTIMATED LENGTHS AND THE ACTUAL LENGTH WILL BE DETERMINED IN THE FIELD.

THE NUMBER OF "NO PASSING ZONE" SIGNS (W-14-3) ARE ESTIMATED AND THE ACTUAL NUMBER WILL BE DETERMINED AFTER THE ROADWAYS HAVE BEEN SPOTTED.

NORTHWEST REGION TRAFFIC CONTACT

CHLOE ANDERSON
WISCONSIN DEPARTMENT OF TRANSPORTATION
5009 USH 53 SOUTH
EAU CLAIRE, WI 54701
PHONE: (715) 855-7672
CELL: (715) 577-4493

NORTHWEST REGION DNR CONTACTS

(ST. CROIX COUNTY)
CHRIS WILLGER
DNR WEST CENTRAL REGION HQ
1300 W. CLAIREMONT STREET
EAU CLAIRE, WI 54702
PHONE: (715) 839-1609

(BARRON, DOUGLAS, POLK COUNTY) AMY CRONK DNR NORTHERN REGION HQ 810 WEST MAPLE STREET SPOONER, WI 54801 PHONE: (715) 635-4229

(BAYFIELD COUNTY) SHAWN HASELEU DNR NORTHERN REGION HQ 810 WEST MAPLE STREET SPOONER, WI 54801 PHONE: (715) 635-4228



PROJECT NO: VARIOUS HWY: VARIOUS COUNTY: VARIOUS GENERAL NOTES SHEET E

VARIES DRIVING DRIVING SHLD LANE LANE 4.0% EXISITING BASE AGGREGATE (SHOULDER) - EXISTING BASE COURSE └ EXISTING ASPHALT PAVEMENT IN FILL IN CUT EXISTING TYPICAL SECTION - RURAL USH 63 STH 48 USH 2 STH 13 STH 46 STH 65 * EXISTING CENTER RUMBLE STRIPS - STH 65 ONLY **VARIES** VARIES SHOULDER DRIVING DRIVING SHOULDER LANE LANE LEXISTING BASE COURSE EXISTING ASPHALT PAVEMENT EXISTING CURB & GUTTER (TYP.) EXISTING TYPICAL SECTION - URBAN USH 63

FILE NAME : G:\WDOTCO\14023 (2014 - 2016 DESIGN WORK ORDERS)\14023-018\CIVIL 3D\SHEETSPLAN\PLAN DETAILS\020301-TS.DWG

HWY: VARIOUS

PROJECT NO: VARIOUS


PLOT DATE: 10/27/2016 1:59 PM


COUNTY: VARIOUS


PLOT BY : BRAD CUNNINGHAM

TYPICAL SECTIONS

PLOT SCALE : 1 IN:10 FT

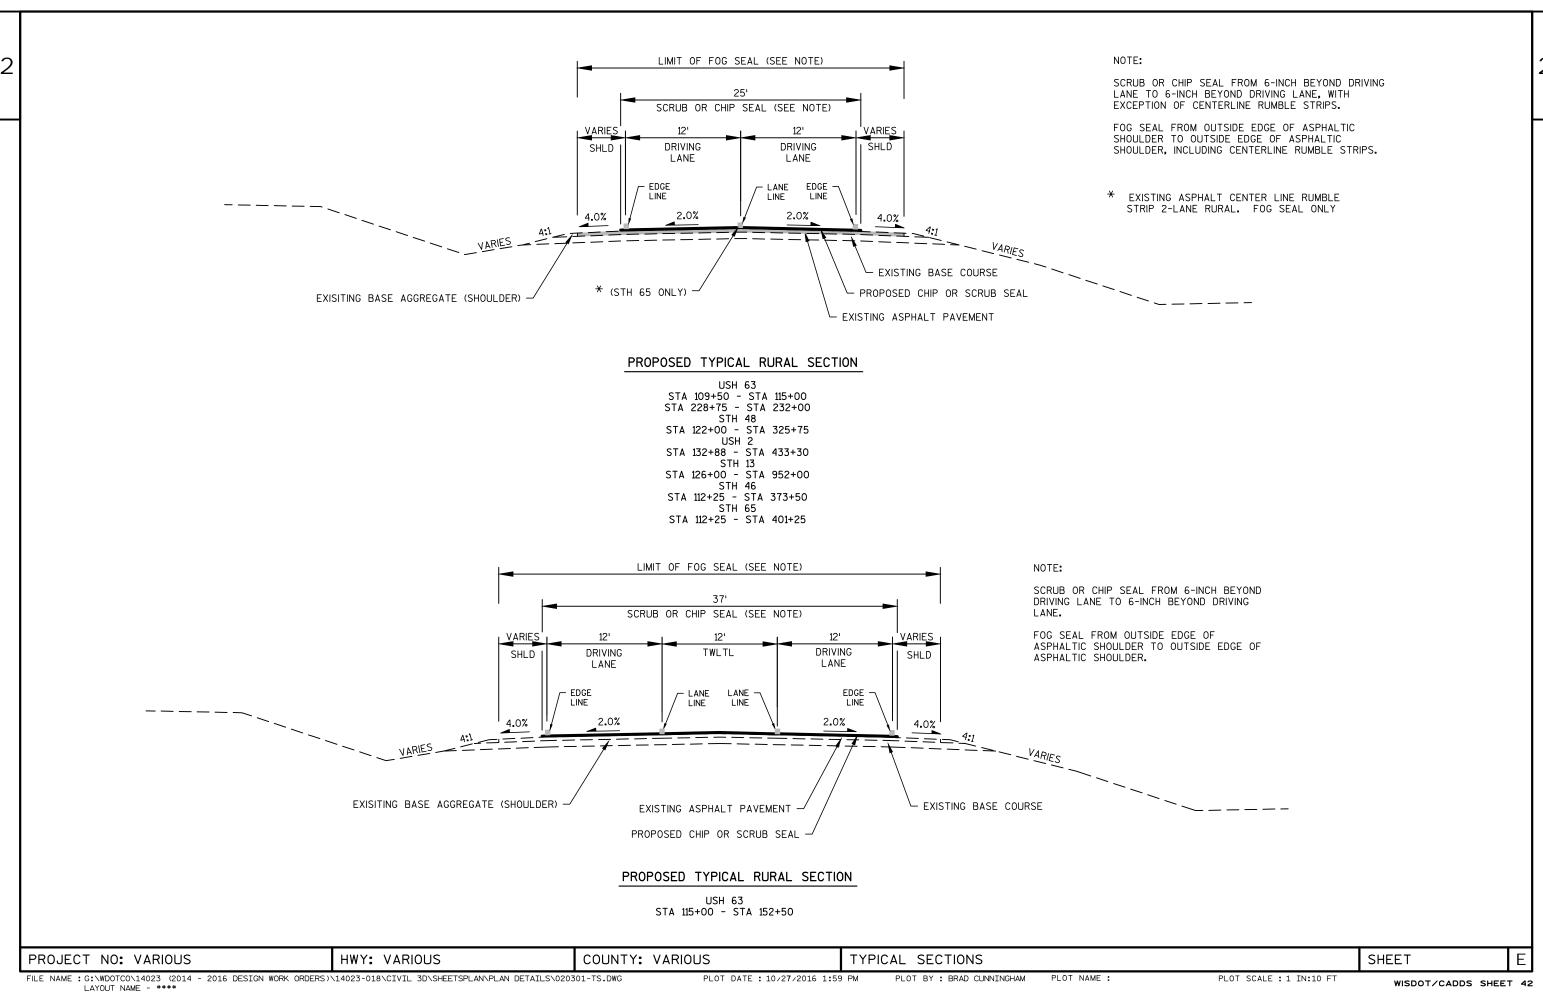

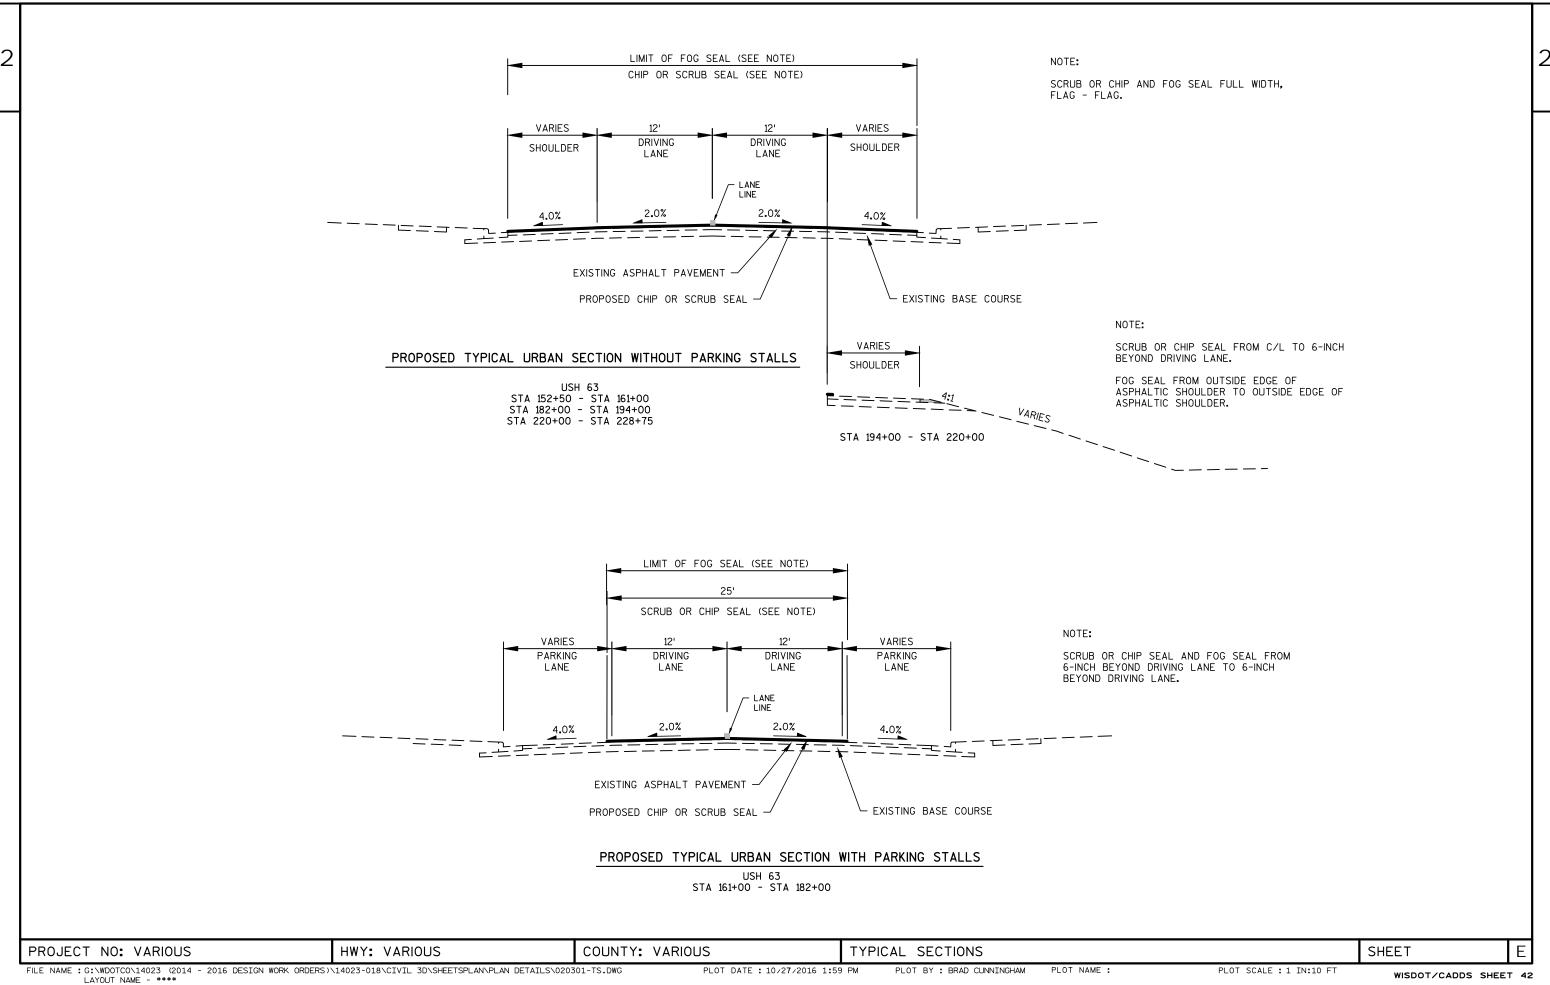

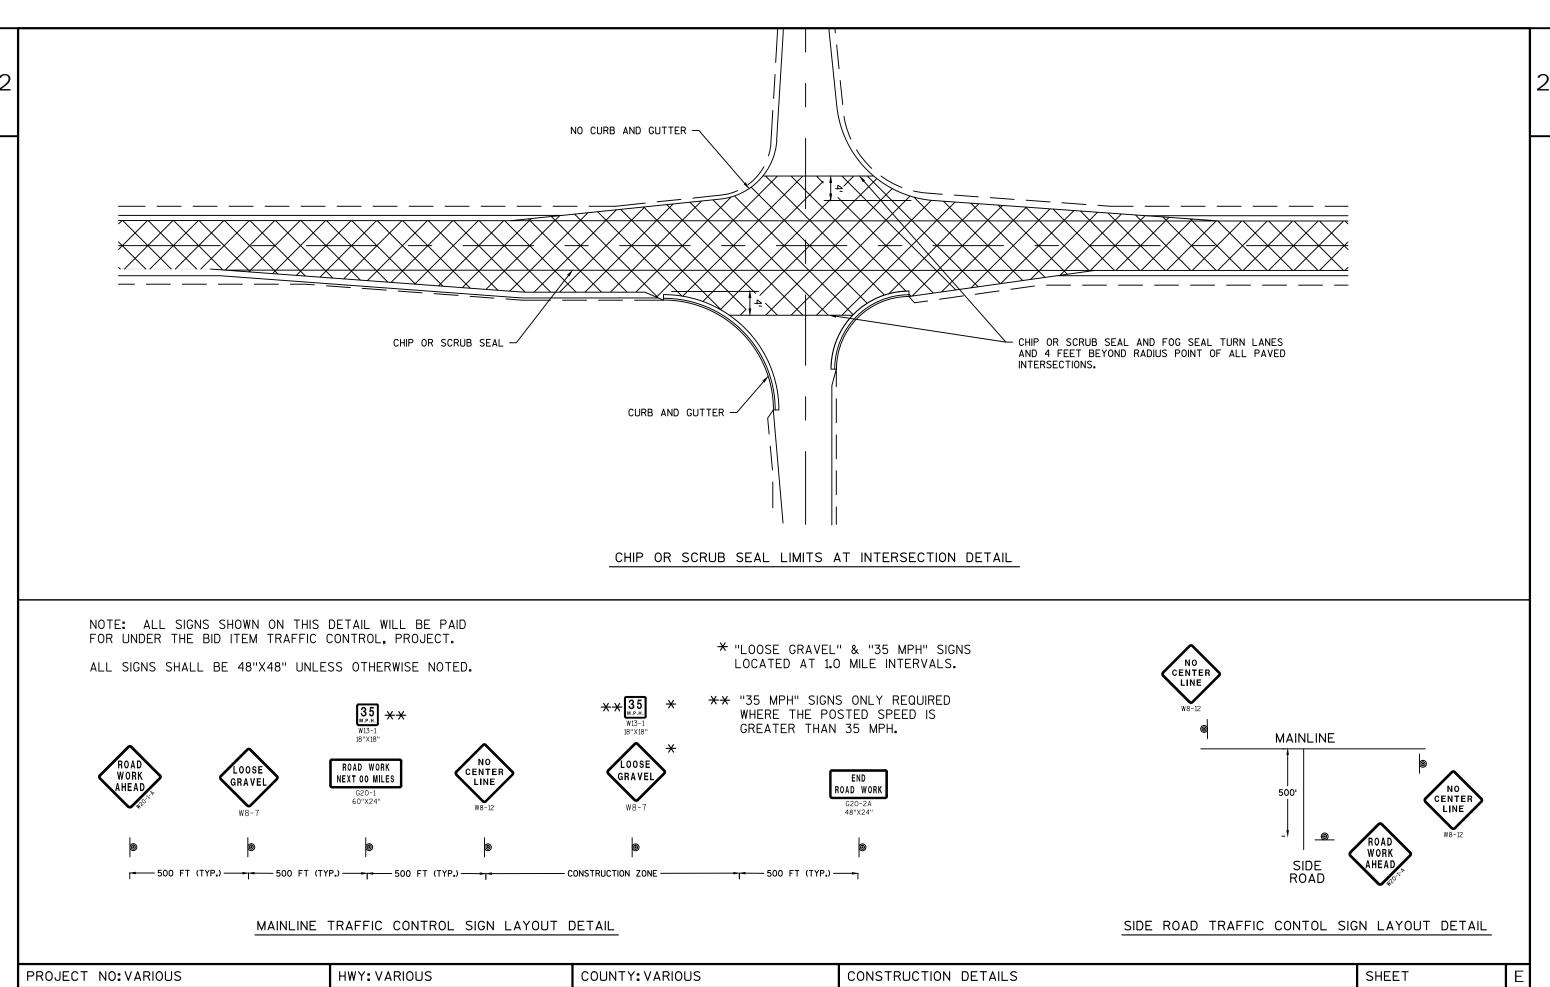


FILE NAME : G:\WDOTCO\14023 (2014 - 2016 DESIGN WORK ORDERS)\14023-018\CIVIL 3D\SHEETSPLAN\PLAN DETAILS\021001-CD.DWG

PLOT DATE: 10/25/2016 8:11 AM

PLOT BY : KL ENGINEERING

PLOT SCALE : 1" = 1'

WISDOT/CADDS SHEET 42

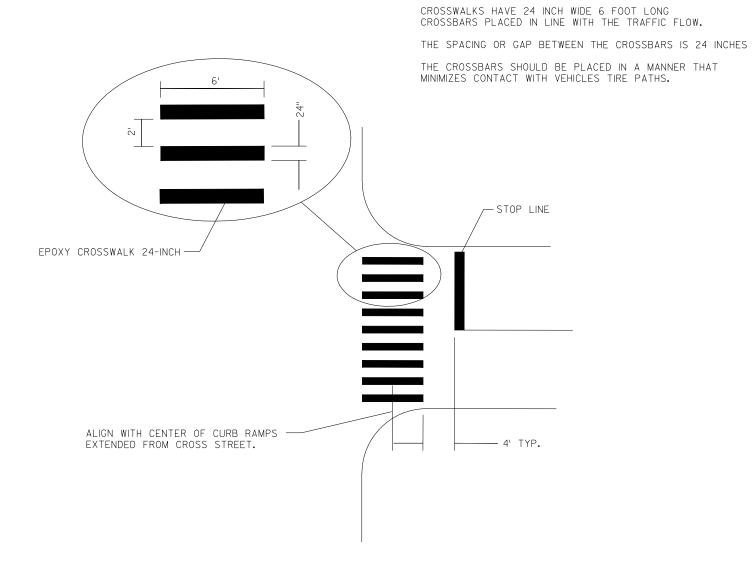

CROSS WALK & STOP LINES MARKING DETAIL
SEE PAVEMENT MARKING PLANS FOR LOCATIONS

PROJECT NO: VARIOUS HWY: VARIOUS COUNTY: VARIOUS CONSTRUCTION DETAILS SHEET E

Estimate Of Quantities

					1180-00-63	1540-00-60	1550-01-60	8070-00-60	8120-00-60	8510-01-60	
Line	Item	Item Description	Unit	Total	Qty	Qty	Qty	Qty	Qty	Qty	
0010	213.0100	Finishing Roadway (project) 01. 1180-00-63	EACH	1.000	1.000						
0020	213.0100	Finishing Roadway (project) 02. 1540-00-60	EACH	1.000		1.000					
0030	213.0100	Finishing Roadway (project) 03. 1550-01-60	EACH	1.000			1.000				
0040	213.0100	Finishing Roadway (project) 04. 8070-00-60	EACH	1.000				1.000			
0050	213.0100	Finishing Roadway (project) 05. 8120-00-60	EACH	1.000					1.000		
0060	213.0100	Finishing Roadway (project) 06. 8510-01-60	EACH	1.000						1.000	
0070	618.0100	Maintenance And Repair of Haul Roads (project) 01. 1180-00-63	EACH	1.000	1.000						
0800	618.0100	Maintenance And Repair of Haul Roads (project) 02. 1540-00-60	EACH	1.000		1.000					
0090	618.0100	Maintenance And Repair of Haul Roads (project) 03. 1550-01-60	EACH	1.000			1.000				
0100	618.0100	Maintenance And Repair of Haul Roads (project) 04. 8070-00-60	EACH	1.000				1.000			
0110	618.0100	Maintenance And Repair of Haul Roads (project) 05. 8120-00-60	EACH	1.000					1.000		
0120	618.0100	Maintenance And Repair of Haul Roads (project) 06. 8510-01-60	EACH	1.000						1.000	
0130	619.1000	Mobilization	EACH	1.000	0.190	0.110	0.070	0.130	0.110	0.390	
0140	628.7015	Inlet Protection Type C	EACH	55.000	5.000	5.000	30.000	5.000	5.000	5.000	
0150	634.0614	Posts Wood 4x6-Inch X 14-FT	EACH	147.000	32.000	10.000	48.000	30.000	27.000		
0160	634.0616	Posts Wood 4x6-Inch X 16-FT	EACH	165.000	46.000	21.000	14.000	40.000	44.000		
0170	634.0618	Posts Wood 4x6-Inch X 18-FT	EACH	17.000	10.000		4.000		3.000		
0180	637.2210	Signs Type II Reflective H	SF	1,676.700	414.800	159.220	536.700	331.120	234.860		
0190	637.2230	Signs Type II Reflective F	SF	646.000	153.750	42.000	171.000	95.500	183.750		
0200	638.2602	Removing Signs Type II	EACH	355.000	69.000	32.000	116.000	71.000	67.000		
0210	638.3000	Removing Small Sign Supports	EACH	301.000	71.000	31.000	66.000	65.000	68.000		
0220	643.0100	Traffic Control (project) 01. 1180-00-63	EACH	1.000	1.000						
0230	643.0100	Traffic Control (project) 02. 1540-00-60	EACH	1.000		1.000					
0240	643.0100	Traffic Control (project) 03. 1550-01-60	EACH	1.000			1.000				
0250	643.0100	Traffic Control (project) 04. 8070-00-60	EACH	1.000				1.000			
0260	643.0100	Traffic Control (project) 05. 8120-00-60	EACH	1.000					1.000		
0270	643.0100	Traffic Control (project) 06. 8510-01-60	EACH	1.000						1.000	
0280	643.0410	Traffic Control Barricades Type II	DAY	20.000			20.000				
0290	643.0705	Traffic Control Warning Lights Type A	DAY	20.000			20.000				
0300	643.0900	Traffic Control Signs	DAY	20.000			20.000				
0310	646.0103	Pavement Marking Paint 4-Inch	LF	598,600.000	106,300.000	90,200.000	32,300.000	76,600.000	63,100.000	230,100.000	
0320	646.0123	Pavement Marking Paint 8-Inch	LF	2,620.000	1,300.000	660.000	450.000	100.000		110.000	
0330	646.0600	Removing Pavement Markings	LF	607,300.000	108,900.000	91,600.000	36,500.000	76,800.000	63,100.000	230,400.000	
0340	647.0166	Pavement Marking Arrows Epoxy Type 2	EACH	25.000	2.000		22.000	1.000			
0350	647.0356	Pavement Marking Words Epoxy	EACH	3.000	2.000			1.000			

Estimate Of Quantities Page 2

					1180-00-63	1540-00-60	1550-01-60	8070-00-60	8120-00-60	8510-01-60	
Line	Item	Item Description	Unit	Total	Qty	Qty	Qty	Qty	Qty	Qty	
0360	647.0566	Pavement Marking Stop Line Epoxy 18-Inch	LF	58.000			46.000			12.000	
0370	647.0606	Pavement Marking Island Nose Epoxy	EACH	1.000			1.000				
0380	647.0726	Pavement Marking Diagonal Epoxy 12-Inch	LF	86.000			86.000				
0390	647.0796	Pavement Marking Crosswalk Epoxy 24-Inch	LF	546.000			546.000				
0400	647.0955	Removing Pavement Markings Arrows	EACH	25.000	2.000		22.000	1.000			
0410	647.0965	Removing Pavement Markings Words	EACH	3.000	2.000			1.000			
0420	648.0100	Locating No-Passing Zones	MI	35.110	5.680	5.470	0.230	4.910	3.860	14.960	
0430	649.0402	Temporary Pavement Marking Paint 4-Inch	LF	154,900.000	47,600.000	33,700.000	24,600.000	25,900.000	23,100.000		
0440	649.2102	Temporary Raised Pavement Markers Type II	EACH	55,800.000	11,500.000	9,200.000	2,300.000	7,700.000	6,500.000	18,600.000	
0450	SPV.0180	Special 01. Chip Seal	SY	136,500.000		83,200.000	53,300.000				
0460	SPV.0180	Special 02. Scrub Seal	SY	458,000.000	104,800.000			73,500.000	57,800.000	221,900.000	
0470	SPV.0180	Special 03. Fog Seal	SY	707,500.000	120,800.000	99,100.000	56,400.000	87,800.000	69,200.000	274,200.000	

FINISHING ROADWAY (1180-00-63)	MAINTENANCE AND REPAIR OF HAUL ROADS (1180-00-63)	TRAFFIC CONTROL (1180-00-63)
213.0100 CAT STATION TO STATION LOCATION EACH REMARKS	618.0100 CAT STATION TO STATION LOCATION EACH REMARKS	643.0100 CAT STATION TO STATION LOCATION EACH REMARKS
0010 133+00 - 433+00 USH 2 1	0010 133+00 - 433+00 USH 2 1	0010 133+00 - 433+00 USH 2 1
TOTAL PROJECT ID 1180-00-63 1	TOTAL PROJECT ID 1180-00-63 1	TOTAL PROJECT ID 1180-00-63 1
FINISHING ROADWAY (1540-00-60)	MAINTENANCE AND REPAIR OF HAUL ROADS (1540-00-60)	<u>TRAFFIC CONTROL (1540-00-60)</u>
213.0100 CAT STATION TO STATION LOCATION EACH REMARKS	618.0100	643.0100 CAT STATION TO STATION LOCATION EACH REMARKS
0010 112+25 - 401+25 STH 65 1	CAT STATION TO STATION LOCATION EACH REMARKS 0010 112+25 - 401+25 STH 65 1	0010 112+25 - 401+25 STH 65 1
TOTAL PROJECT ID 1540-00-60 1	TOTAL PROJECT ID 1540-00-60	TOTAL PROJECT ID 1540-00-60
	TOTAL PROBLEM IS 1040 00 00	
FINISHING ROADWAY (1550-01-60)	MAINTENANCE AND REPAIR OF HAUL ROADS (1550-01-60)	TRAFFIC CONTROL (1550-01-60)
213.0100 CAT STATION TO STATION LOCATION EACH REMARKS	618.0100 CAT STATION TO STATION LOCATION EACH REMARKS	643.0100 CAT STATION TO STATION LOCATION EACH REMARKS
0010 109+50 - 232+00 USH 63 1	0010 109+50 - 232+00 USH 63 1	0010 109+50 - 232+00 USH 63 1
TOTAL PROJECT ID 1550-01-60 1	TOTAL PROJECT ID 1550-01-60 1	TOTAL PROJECT ID 1550-01-60 1
FINISHING ROADWAY (8070-00-60)	MAINTENANCE AND REPAIR OF HAUL ROADS (8070-00-60)	TRAFFIC CONTROL (8070-00-60)
213.0100	618.0100	643.0100
CAT STATION TO STATION LOCATION EACH REMARKS	CAT STATION TO STATION LOCATION EACH REMARKS	CAT STATION TO STATION LOCATION EACH REMARKS
0010 113+00 - 372+40 STH 46 1	0010 113+00 - 372+40 STH 46 1	0010 113+00 - 372+40 STH 46 1
TOTAL PROJECT ID 8070-00-60 1	TOTAL PROJECT ID 8070-00-60 1	TOTAL PROJECT ID 8070-00-60 1
FINISHING ROADWAY (8120-00-60)	MAINTENANCE AND REPAIR OF HAUL ROADS (8120-00-60)	TRAFFIC CONTROL (8120-00-60)
213.0100 CAT STATION TO STATION LOCATION EACH REMARKS	618.0100 CAT STATION TO STATION LOCATION EACH REMARKS	643.0100 CAT STATION TO STATION LOCATION EACH REMARKS
0010 122+00 - 325+75 STH 48 1	0010 122+00 - 325+75 STH 48 1	0010 122+00 - 325+75 STH 48 1
TOTAL PROJECT ID 8120-00-60 1	TOTAL PROJECT ID 8120-00-60 1	TOTAL PROJECT ID 8120-00-60 1
FINISHING ROADWAY (8510-01-60)	MAINTENANCE AND REPAIR OF HAUL ROADS (8510-01-60)	TRAFFIC CONTROL (8510-01-60)
213.0100 CAT STATION TO STATION LOCATION EACH REMARKS	618.0100 CAT STATION TO STATION LOCATION EACH REMARKS	643.0100 CAT STATION TO STATION LOCATION EACH REMARKS
0010 126+00 - 915+75 STH 13 1	0010 126+00 - 915+75 STH 13 1	0010 126+00 - 915+75 STH 13 1
TOTAL PROJECT ID 8510-01-60	TOTAL PROJECT ID 8510-01-60 1	TOTAL PROJECT ID 8510-01-60 1

HWY: VARIES

PROJECT NO: VARIES

COUNTY: VARIES

MISCELLANEOUS QUANTITIES

PAVEMENT MARKING PAINT

CAT 0010	STATION 133+00	TO -	STATION 433+00	LOCATION USH 2	646.0103 PAVEMENT MARKING PAINT 4-INCH (YELLOW) LF 40,200	646.0103 PAVEMENT MARKING PAINT 4-INCH (WHITE) LF 66,100	646.0123 PAVEMENT MARKING PAINT 8-INCH (WHITE) LF 1,300	REMARKS
			TOTAL PRO	ECT ID 1180-00-63	106,3	00	1,300	=
0010	112+25	-	401+25	STH 65	33,700	56,500	660	
			TOTAL PROJECT ID 1540-00-60		90,200		660	=
0010	109+50	-	232+00	USH 63	24,600	7,700	450	
			TOTAL PRO	JECT ID 1550-01-60	32,3	32,300		=
0010	113+00	-	372+40	STH 46	25,800	50,800	100	
			TOTAL PRO	JECT ID 8070-00-60	76,6	00	100	=
0010	122+00	-	325+75	STH 48	23100	40000		
			TOTAL PRO	ECT ID 8120-00-60	6310	00	0	=
0010	126+00	-	915+75	STH 13	75,500	154,600	110	
			TOTAL PRO	ECT ID 8510-01-60	230,1	00	110	=
				GRAND TOTAL	598,6	600	2,620	

REMOVING PAVEMENT MARKING

					646.0600 REMOVING PAVEMENT	647.0955 REMOVING PAVEMENT MARKING	647.0965 REMOVING PAVEMENT MARKING	
0.17	07471011	TO	OT A TION	LOCATION	MARKING	ARROWS	WORDS	DE144.DV0
CAT	STATION	ТО	STATION	LOCATION	LF 400,000	EACH	EACH	REMARKS
0010	133+00	-	433+00	USH 2	108,900	2	2	
			TOTAL PRO	JECT ID 1180-00-63				
0010	112+25	-	401+25	STH 65	91,600			
			TOTAL PRO	JECT ID 1540-00-60				
0010	109+50	-	232+00	USH 63	36,500	22		
			TOTAL PRO	JECT ID 1550-01-60				
0010	113+00	-	372+40	STH 46	76,800	1	1	
			TOTAL PRO	JECT ID 8070-00-60				
0010	122+00	_	325+75	STH 48	63100			
			TOTAL PRO	JECT ID 8120-00-60				
0010	126+00		915+75	STH 13	230,400			
			TOTAL PRO	JECT ID 8510-01-60				
				GRAND TOTAL	607,300	25	3	

INLET PROTECTION TYPE C

			628.7015	
CAT		LOCATION	EACH	REMARKS
0010	UNDISTRIBUTED	USH 2	5	PROJECT ID 1180-00-63
0010	UNDISTRIBUTED	STH 65	5	PROJECT ID 1540-00-60
0010	UNDISTRIBUTED	USH 63	30	PROJECT ID 1550-01-60
0010	UNDISTRIBUTED	STH 46	5	PROJECT ID 8070-00-60
0010	UNDISTRIBUTED	STH 48	5	PROJECT ID 8120-00-60
0010	UNDISTRIBUTED	STH 13	5	PROJECT ID 8510-01-60
		TOTAL	55	

TRAFFIC CONTROL

0.17	07471011	T 0	07171011	LOCATION	643.0410 TRAFFIC CONTROL BARRICADES TYPE II	643.0705 TRAFFIC CONTROL WARNING LIGHTS TYPE A	643.0900 TRAFFIC CONTROL SIGNS	DTMDVO
CAT	STATION	TO	STATION	LOCATION	DAYS	DAYS	DAYS	REMARKS
0010	109+50	-	232+00	USH 63	20	20	20	USE FOR PEDESTRIAN ACCOMMODATIONS
	TO	TAL PRO	JECT ID 1550-0	01-60	20	20	20	

* NOTE: TRAFFIC CONTROL ITEMS FOR CROSSWALK CLOSURES DURING CHIP AND FOG SEALING OPERATIONS.

COUNTY: VARIES MISCELLANEOUS QUANTITIES PROJECT NO: VARIES HWY: VARIES

SHEET Ε

PLOT DATE : 11/1/2016

PLOT BY : KL ENGINEERING PLOT NAME :PLOT SCALE : 1:1.185

		T MARKING (SPECIAL MARKINGS)				
COUNTY	BARRON					
PROJECT ID	1550-01-60					
MAP REFERENCE HWY	USH 63					
MAP REFERENCE SITE ID	700 FT NORTH OF STH 48 WEST - CUMBERLAND			USH 63	USH 63	TOTAL
BID ITEM #	DESCRIPTION	MARKING LOCATION	UNIT	NB	SB	QUANTITY
647.0726	PAVEMENT MARKING, DIAGONAL, EPOXY, 12-INCH	MEDIAN ISLAND	L.F.	50	36	86
			TOTA	AL PROJECT ID 159	50-01-60	86
PROJECT ID	1550-01-60					
MAP REFERENCE HWY	USH 63					
MAP REFERENCE SITE ID	900 FT NORTH OF STH 48 WEST - CUMBERLAND			USH 63	USH 63	TOTAL
	***************************************	MARKING LOCATION	UNIT			
BID ITEM #	DESCRIPTION	MARKING LOCATION	UNIT	NB	SB	QUANTITY
647.0166	PAVEMENT MARKING, ARROWS, EPOXY, TYPE 2	TWLTL - TWO WAY LEFT TURN LANE	EACH	11	11	22
			TOTA	AL PROJECT ID 155	50-01-60	22
PROJECT ID	1550-01-60					
MAP REFERENCE HWY	USH 63					
MAP REFERENCE SITE ID	5TH AVE - CUMBERLAND			USH 63	USH 63	TOTAL
BID ITEM #	DESCRIPTION	MARKING LOCATION	UNIT	NB	SB	QUANTITY
647.0606	PAVEMENT MARKING, ISLAND NOSE, EPOXY	MEDIAN ISLAND	EACH	1		1
			TOTA	AL PROJECT ID 159	50-01-60	1
PROJECT ID	1550-01-60		1017			
MAP REFERENCE HWY	USH 63					
MAP REFERENCE SITE ID	STH 48 EAST - CUMBERLAND			USH 63	USH 63	
				USH 63		TOTAL
BID ITEM #	DESCRIPTION	MARKING LOCATION	UNIT	NB	SB	QUANTITY
647.0566	PAVEMENT MARKING, STOP LINE, EPOXY, 18-INCH	MAINLINE	L.F.	21	25	46
			TOTA	AL PROJECT ID 155	50-01-60	46
PROJECT ID	1550-01-60					
MAP REFERENCE HWY	USH 63			USH 63	USH 63	TOTAL
BID ITEM #	DESCRIPTION	LOCATION	UNIT	NB	SB	QUANTITY
647.0796	PAVEMENT MARKING, CROSSWALK, EPOXY, 24-INCH	USH 63 / EIGHTH ST - CUMBERLAND	L.F.	78		78
647.0796	PAVEMENT MARKING, CROSSWALK, EPOXY, 24-INCH	USH 63 / ELM ST - CUMBERLAND	L.F.	48	42	90
			L.F.			
647.0796	PAVEMENT MARKING, CROSSWALK, EPOXY, 24-INCH	USH 63 / SORENSEN ST - CUMBERLAND		42	42	84
647.0796	PAVEMENT MARKING, CROSSWALK, EPOXY, 24-INCH	USH 63 / GROVE ST - CUMBERLAND	L.F.	42	42	84
647,0796	PAVEMENT MARKING, CROSSWALK, EPOXY, 24-INCH	USH 63 / FOSTER ST - CUMBERLAND	L.F.		42	42
647.0796	PAVEMENT MARKING, CROSSWALK, EPOXY, 24-INCH	USH 63 / WATER ST - CUMBERLAND	L.F.	42	42	84
647.0796	PAVEMENT MARKING, CROSSWALK, EPOXY, 24-INCH	USH 63 / MIDBLOCK - CUMBERLAND	L.F.	42		42
647.0796	PAVEMENT MARKING, CROSSWALK, EPOXY, 24-INCH	USH 63 AND VETERANS ST CUMBERLAND	L.F.	42		42
			TOTA	AL PROJECT ID 159	50-01-60	546
COUNTY	POLK					
PROJECT ID	8070-00-60					
MAP REFERENCE HWY	STH 46					
	310 40			OTIL 40	OT11 40	
MAP REFERENCE SITE ID				STH 46	STH 46	TOTAL
BID ITEM #	DESCRIPTION	MARKING LOCATION	UNIT	WB	EB	QUANTITY
647.0166	PAVEMENT MARKING, ARROWS, EPOXY, TYPE 2	RIGHT TURN LANE	E.A.	1		1
647.0356	PAVEMENT MARKING, WORDS, EPOXY "ONLY"	RIGHT TURN LANE	E.A.	1		1
			TOTA	AL PROJECT ID 807	70-00-60	:
COUNTY	BAYFIELD					
PROJECT ID	1180-00-63					
MAP REFERENCE HWY	USH 2					
MAP REFERENCE SITE ID	HUGHES TOWN HALL ROAD & RANGE LINE ROAD			USH 2	USH 2	TOTAL
		MARKING				
BID ITEM #	DESCRIPTION	MARKING LOCATION	UNIT	WB	EB	QUANTITY
647.0166	PAVEMENT MARKING, ARROWS, EPOXY, TYPE 2	RIGHT TURN LANES	E.A.	1	1	2
	PAVEMENT MARKING, WORDS, EPOXY "ONLY"	RIGHT TURN LANES	E.A.	1	1	2
647.0356			TOTA	AL PROJECT ID 118	30-00-63	
647.0356						
647.0356 COUNTY	DOUGLAS					
COUNTY	DOUGLAS 8510-01-60					
COUNTY PROJECT ID	8510-01-60			STH 13	STH 13	ΤΟΤΑΙ
COUNTY PROJECT ID MAP REFERENCE HWY MAP REFERENCE SITE ID	8510-01-60 STH 13 STH 13 & CTH H INTERSECTION	MARKING LOCATION	HNIT			TOTAL
COUNTY PROJECT ID MAP REFERENCE HWY MAP REFERENCE SITE ID BID ITEM #	8510-01-60 STH 13 STH 13 & CTH H INTERSECTION DESCRIPTION	MARKING LOCATION	UNIT	STH 13 NB	SB	QUANTITY
COUNTY PROJECT ID MAP REFERENCE HWY MAP REFERENCE SITE ID	8510-01-60 STH 13 STH 13 & CTH H INTERSECTION	MARKING LOCATION MAINLINE	L.F.		SB 12	

LOCATING NO-PASSING ZONES

CAT	STATION	то	STATION	LOCATION	648.0100 MI	REMARKS
0010	133+00	-	433+00	USH 2	5.68	REWARNS
			TOTAL PRO	= JECT ID 1180-00-63	5.68	
0010	112+25	-	401+25	STH 65	5.47	
			TOTAL PRO	JECT ID 1540-00-60	5.47	
0010	109+50	-	220+00	USH 63		
0010	220+00	-	232+00	USH 63	0.23	
			TOTAL PRO	JECT ID 1550-01-60	0.23	
0010	113+00	-	372+40	STH 46	4.91	
			TOTAL PRO	JECT ID 8070-00-60	4.91	
0010	122+00	-	325+75	STH 48	3.86	
			TOTAL PRO	JECT ID 8120-00-60	3.86	
0010	126+00	-	915+75	STH 13	14.96	
			TOTAL PRO	JECT ID 8510-01-60	14.96	

PAVEMENT MARKING SUMMARY (SPECIAL MARKINGS)

CAT	ITEM NUMBER	BID ITEM DESCRIPTION	UNIT	TOTALS
0010	647.0166	PAVEMENT MARKING, ARROW, EPOXY, TYPE 2	EACH	25
0010	647.0356	PAVEMENT MARKING, EPOXY, WORDS "ONLY"	EACH	3
0010	647.0566	PAVEMENT MARKING, STOP LINE, EPOXY, 18-INCH	L.F.	58
0010	647.0606	PAVEMENT MARKING, ISLAND NOSE, EPOXY	EACH	1
0010	647.0726	PAVEMENT MARKING, DIAGONAL, EPOXY, 12-INCH	L.F.	86
0010	647.0796	PAVEMENT MARKING, CROSSWALK, EPOXY, 24-INCH	L.F.	546

COUNTY: VARIES MISCELLANEOUS QUANTITIES SHEET PROJECT NO: VARIES HWY: VARIES

TEMPORARY PAVEMENT MARKING 4-INCH

CAT	STATION	то	STATION	LOCATION		649.0402 (YELLOW) LF	649.0402 (WHITE) LF	REMARKS
0010	133+00	-	433+00	USH 2	*	40,200		CENTERLINE
0010	100100		400100	00112			7,400	CLIMBING LANE SKIPS
			TOTAL PRO	JECT ID 1180-00-63		47,	600	=
0010	112+25	-	401+25	STH 65	*	33,700		CENTERLINE
			TOTAL PRO	JECT ID 1540-00-60		33,	700	=
0010	109+50	-	232+00	USH 63	*	24,600		CENTERLINE
			TOTAL PRO	JECT ID 1550-01-60		24,	600	=
0010	113+00		372+40	STH 46	*	25,800		CENTERLINE
							100	BYPASS LANE SKIPS
			TOTAL PRO	JECT ID 8070-00-60		25,9	900	=
0010	122+00	-	325+75	STH 48	*	23,100		CENTERLINE
			TOTAL PRO	JECT ID 8120-00-60		23,	100	=
0010	126+00	-	915+75	STH 13	**			
			TOTAL PRO	JECT ID 8510-01-60		()	=
				GRAND TOTAL		154,	900	

^{*} TEMPORARY RAISED PAVEMENT MARKERS ARE ACCEPTABLE FOR A MAXIMUM OF 3 DAYS AFTER THE SEAL COAT IS PLACED. UNTIL THE PERMANENT MARKINGS ARE PLACED, TEMPORARY PAVEMENT MARKINGS ARE REQUIRED FOR CENTER LINES, LANE LINES AND EDGE LINES. (DUE TO AADT LESS THAN 3,500)

HWY: VARIES

TEMPORARY RAISED PAVEMENT MARKERS TYPE II

					649.2102	
CAT	STATION	TO	STATION	LOCATION	EACH	REMARKS
0010	133+00	-	433+00	USH 2	7,500	YELLOW
0010	133+00	-	433+00	USH 2	4,000	WHITE
			TOTAL PRO	JECT ID 1180-00-63	11,500	
0010	112+25	-	401+25	STH 65	6,900	YELLOW
0010	112+25	-	401+25	STH 65	2,300	WHITE
			TOTAL PRO	JECT ID 1540-00-60	9,200	
0010	109+50	-	232+00	USH 63	2,000	YELLOW
0010	109+50	-	232+00	USH 63	300	WHITE
			TOTAL PRO	JECT ID 1550-01-60	2,300	
0010	113+00	-	372+40	STH 46	5,600	YELLOW
0010	113+00	-	372+40	STH 46	2,100	WHITE
			TOTAL PRO	JECT ID 8070-00-60	7,700	
0010	122+00	-	325+75	STH 48	4,900	YELLOW
0010	122+00	-	325+75	STH 48	1,600	WHITE
			TOTAL PRO	JECT ID 8120-00-60	6,500	
0010	126+00	-	915+75	STH 13	12,400	YELLOW
0010	126+00	-	915+75	STH 13 _	6,200	WHITE
			TOTAL PRO	JECT ID 8510-01-60	18,600	
				GRAND TOTAL	55,800	

CHIP/SCRUB/FOG SEAL

					SPV.0180.01	SPV.0180.02	SPV.0180.03	
CAT	STATION	то	STATION	LOCATION	CHIP SEAL SY	SCRUB SEAL SY	FOG SEAL SY	REMARK
0010	133+00	-	433+00	USH 2		104,800	120,800	KEWAKK
			TOTAL PRO	JECT ID 1180-00-63		104,800	120,800	=
0010	112+25	-	401+25	STH 65	83,200		99,100	
			TOTAL PRO	JECT ID 1540-00-60	83,200		99,100	=
0010	109+50	-	232+00	USH 63	53,300		56,400	
			TOTAL PRO	JECT ID 1550-01-60	53,300		56,400	=
0010	113+00	-	372+40	STH 46		73,500	87,800	
			TOTAL PRO	JECT ID 8070-00-60		73,500	87,800	=
0010	122+00	-	325+75	STH 48		57,800	69,200	
			TOTAL PRO	JECT ID 8120-00-60		57,800	69,200	=
0010	126+00	-	915+75	STH 13		221,900	274,200	
			TOTAL PRO	JECT ID 8510-01-60		221,900	274,200	=
				GRAND TOTAL	136,500	458,000	707,500	

FILE NAME : G:\WDOTCO\14023 (2014 - 2016 DESIGN WORK ORDERS)\14023-018\CIVIL 3D\SHEETSPLAN\MQ\030201-MQ.DWG

PROJECT NO: VARIES

COUNTY: VARIES

MISCELLANEOUS QUANTITIES

^{**} TEMPORARY RAISED PAVEMENT MARKINGS NOT REQUIRED UNTIL PERMANENT PAVEMENT MARKINGS ARE PLACED. (DUE TO AADT LESS THAN 3,500)

USH 2 PERMANENT SIGNING TYPE II

				SIGN SIZE		637.2210 SIGNS TYPE II REFLECTIVE	637.2230 SIGNS TYPE II REFLECTIVE	634.0614 WOO	634.0616 OD POST 4X6-	634.0618 -INCH	638.2602 REMOVING SIGNS	638.3000 REMOVING SMALL SIGN	SIGN MOUNTED	
	SIGN	SIGN	W	Χ	Н	Н	F	14 FT	16 FT	18 FT	TYPE II	SUPPORTS	ON SAME	
CATEGORY	#	CODE	IN		IN	SF	SF	EACH	EACH	EACH	EACH	EACH	POST AS	REMARKS
0010														
-	1-01	D1-1		ESTR										ONE DESTINATION (ARROW)
	1-02	R1-1	30	Χ	30	5.18		1			1	1		STOP SIGN
	1-03	155-56	30	Χ	36	7.50			1		1	1		ADOPT A HIGHWAY SPONSOR
	1-04	R3-55R	24	Χ	30	5.00		1			1	1		RIGHT TURN LANE W/DOWN LEFT ARROW
-	1-05	W11-6	30	Х	30		6.25		1		1	1		SNOWMOBILE CROSSING SYMBOL
	1-06	D1-1		ESTR										ONE DESTINATION (ARROW)
	1-07	R4-51-A	36	Х	48	12.00			1					PASSING LANE AHEAD 2 MILES
	1-08	W14-3	48	Х	36		6.00		1		1	1		NO PASSING ZONE
	2-01	D1-1	90	X	15	9.38		2			1	2		ONE DESTINATION (ARROW)
-	2-02	R1-1	30	X	30	5.18		1			1	1		STOP SIGN
	2-03	W14-3	48	X	36		6.00		1		1	1		NO PASSING ZONE ONE DESTINATION (ARROW)
	3-01	D1-1	90	X	15	9.38		2			1	2		ONE DESTINATION (ARROW)
	3-02	D1-1	20	ESTR	20	 F 40								• • • • • • • • • • • • • • • • • • • •
	3-03 4-01	R1-1	30 48	X	30 36	5.18	6.00	1			1	1		STOP SIGN NO PASSING ZONE
-	4-01	W14-3 D1-1	40	X ESTR	30				1		1 	1 		ONE DESTINATION (ARROW)
	4-02	W14-3	48	X	36		6.00		1		1	1		NO PASSING ZONE
	4-03 4-04	155-56	30	X	36	7.50			1		1	1		ADOPT A HIGHWAY SPONSOR
	4-05	R1-1	30	X	30	5.18		1			1	1		STOP SIGN
	4-06	R4-51	36	X	48	12.00			1					PASSING LANE AHEAD 1/2 MILE
-	5-01	W14-3	48	X	36		6.00		1		1	1		NO PASSING ZONE
	5-02	W14-3	48	Х	36		6.00		1		1	1		NO PASSING ZONE
	5-03	R4-3	24	Х	30	5.00		1			1	1		SLOWER TRAFFIC KEEP RIGHT
	5-04	R2-1	24	Х	30	5.00		1			1	1		SPEED LIMIT 55 MPH
	5-05	R2-1	24	Х	30	5.00		1			1	1		SPEED LIMIT 55 MPH
-	6-01	D1-1		ESTR										ONE DESTINATION (ARROW)
	6-02	155-56	30	Χ	36	7.50			1		1	1		ADOPT A HIGHWAY SPONSOR
	6-03	R4-53	54	Χ	54	20.25				2	1	1		DO NOT PASS WHEN ONCOMING TRAFFIC IN EITHER LANE
	6-04	155-56	30	Χ	36	7.50			1		1	1		ADOPT A HIGHWAY SPONSOR
_	6-05	R1-1	30	Χ	30	5.18		1			1	1		STOP SIGN
	6-06	R1-1	30	Χ	30	5.18		1			1	1		STOP SIGN
	6-07	D1-1		ESTR										ONE DESTINATION (ARROW)
	6-08	W14-3	48	Χ	36		6.00		1		1	1		NO PASSING ZONE
	6-09	R4-1	24	Χ	30	5.00		1						DO NOT PASS
	7-01	R4-53	54	Х	54	20.25				2	1	1		DO NOT PASS WHEN ONCOMING TRAFFIC IN EITHER LANE
	7-02	D2-2		ESTR										DESTINATION/DISTANCE (TWO DESTINATION)
	7-03	W9-1R	36	Х	36		9.00		2		1	1		RIGHT LANE ENDS
	7-04	R1-1	30	Х	30	5.18		1			1	1		STOP SIGN
	7-05	R1-1	30	X	30	5.18		1			1	1		STOP SIGN
-	7-06	W4-2R	36	X	36		9.00		2		1	1		LANE REDUCTION TRANSITION SYMBOL (RIGHT)
	7-07	W4-2R	36	X	36		9.00		2		1	1		LANE REDUCTION TRANSITION SYMBOL (RIGHT) TWO DESTINATION (ARROWS)
	7-08	D1-2	96	X	30	20.00		2			1	2		, ,
	7-09	R4-53	54	X	54	20.25				2	1	2		DO NOT PASS WHEN ONCOMING TRAFFIC IN EITHER LANE ONE DESTINATION (ARROW)
	8-01 8-02	D1-1 W14-3	48	ESTR X	36		6.00		 1		1	1		NO PASSING ZONE
-	8-02	W14-3 W4-2R	36	X	36		9.00		2		1	1		LANE REDUCTION TRANSITION SYMBOL (RIGHT)
	8-03 8-04	W4-2R W4-2R	36	X	36		9.00		2		1	1		LANE REDUCTION TRANSITION SYMBOL (RIGHT)
	8-05	R3-72	30	X	36	7.50	9.00		1		1	1		ONCOMING TRAFFIC USES CENTER LANE
	8-06	R1-1	30	X	30	5.18		1			1	1		STOP SIGN
	8-07	R4-53	54	X	54	20.25				2				DO NOT PASS WHEN ONCOMING TRAFFIC IN EITHER LANE
-		TOTAL				252.87	99.25	20	26	8	38	42		
	235	2 · · · · ·					33.20			ŭ	30			

FILE NAME : G:\WDOTCO\14023 (2014 - 2016 DESIGN WORK ORDERS)\14023-018\CIVIL 3D\SHEETSPLAN\MQ\030201-MQ.DWG

PROJECT NO: 1180-00-63

HWY: USH 2

PLOT DATE : 11/1/2016

COUNTY: BAYFIELD

MISCELLANEOUS QUANTITIES

WISDOT/CADDS SHEET 42

SHEET

PLOT BY : KL ENGINEERING PLOT NAME :PLOT SCALE : 1:1.185

USH 2 PERMANENT SIGNING TYPE II (CONTINUED)

			SIGN		637.2210 SIGNS TYPE II	637.2230 SIGNS TYPE II	634.0614	634.0616	634.0618	638.2602 REMOVING	638.3000 REMOVING	SIGN		
	01011	01011		SIZE		REFLECTIVE	REFLECTIVE		OD POST 4X6-		SIGNS	SMALL SIGN	MOUNTED	
04750000	SIGN 	SIGN	W	Х	Н	Н	F	14 FT	16 FT	18 FT	TYPE II	SUPPORTS	ON SAME	DEMANA
CATEGORY	#	CODE	IN		IN	SF	SF	EACH	EACH	EACH	EACH	EACH	POST AS	REMARKS
0010	SUB	TOTAL				252.87	99.25	20	26	8	38	42		
-	8-08	W9-1R	36	Х	36		9.00		2		1	1		RIGHT LANE ENDS
	8-09	D1-1	30	ESTR	50		3.00							ONE DESTINATION (ARROW)
	9-01	W11-6	30	X	30		6.25		1		1	1		SNOWMOBILE CROSSING SYMBOL
	9-02	W14-3	48	Х	36		6.00		1		1	1		NO PASSING ZONE
	9-03	R4-1	24	Х	30	5.00		1				· 		DO NOT PASS
-	9-04	D1-1		ESTR										ONE DESTINATION (ARROW)
	9-05	R3-72	30	Х	36	7.50			1		1	1		ONCOMING TRAFFIC USES CENTER LANE
	9-06	W11-6	30	Х	30		6.25		1		1	1		SNOWMOBILE CROSSING SYMBOL
	9-07	R1-1	30	Х	30	5.18		1			1	1		STOP SIGN
	9-08	155-56	30	Х	36	7.50			1		1	1		ADOPT A HIGHWAY SPONSOR
•	9-09	R4-53	54	Х	54	20.25				2				DO NOT PASS WHEN ONCOMING TRAFFIC IN EITHER LAN
	9-10	D1-1		ESTR										ONE DESTINATION (ARROW)
	10-01	W14-3	48	Х	36		6.00		1		1	1		NO PASSING ZONE
	10-02	D1-1		ESTR										ONE DESTINATION (ARROW)
	10-03	D1-1		ESTR										ONE DESTINATION (ARROW)
-	10-04	R4-3	24	Х	30	5.00		1			1	1		SLOWER TRAFFIC KEEP RIGHT
	10-05	R1-1	30	Х	30	5.18		1			1	1		STOP SIGN
	10-06	D1-1		ESTR										ONE DESTINATION (ARROW)
	10-07	D1-1		ESTR										ONE DESTINATION (ARROW)
	10-08	W3-5	36	Х	36		9.00		2		1	1		SPEED LIMIT 25 AHEAD (ARROW)
-	10-09	W5-52R	12	Х	36		3.00	1			1	1		CLEARANCE STRIPER DOWN LEFT
	10-10	13-1	36	Х	24	6.00					1		10-11	LAKE OR RIVER NAME
	10-11	R9-56	18	Х	24	3.00			1		1	1	10-10	NO FISHING OR DIVING FROM BRIDGE
	10-12	W5-52L	12	Х	36		3.00	1			1	1		CLEARANCE STRIPER DOWN RIGHT
	10-13	13-1	36	Х	24	6.00					1		10-14	LAKE OR RIVER NAME
-	10-14	R9-56	18	X	24	3.00			1		1	1	10-13	NO FISHING OR DIVING FROM BRIDGE
	10-15	W5-52L	12	Х	36		3.00	1			1	1		CLEARANCE STRIPER DOWN RIGHT
	10-16	W5-52R	12	X	36		3.00	1			1	1		CLEARANCE STRIPER DOWN LEFT
	10-17	R1-1	30	X	30	5.18		1			1	1		STOP SIGN
	10-17	J1-1	24	X	39	6.50			1		1	1		JUNCTION OR END ASSEMBLY
-	10-10	J4-1	24	X	36	6.00			<u>'</u> 1		1			REASSURANCE ASSEMBLY
	10-19	D2-2	72	X	24	12.00			2		1	2		DESTINATION/DISTANCE (TWO DESTINATION)
	10-20	12-3	12	ESTR	27									IRON RIVER UNINCORPORATED
	10-21	R59-51	36	X	36	9.00			1		1	1		STOP FOR BUS FLASHING LIGHTS
		R2-1	24	X	30						1	1		SPPED LIMIT 25 MPH
-	10-23	R2-1	24	X	30	5.00		1			1	1		SPEED LIMIT 25 MPH
	10-24		24	ESTR	30	5.00								ONE DESTINATION (ARROW)
	10-25 10-26	D1-1 R4-51	36	X	48	12.00			1			1		PASSING LANE AHEAD 1/2 MILE
	10-26 11-01					12.00						1		
	11-01	W11-2		REMOVI		7.50					1	1	11.02	PEDESTRIAN CROSSING SYMBOL
	11-02	J13-1	24		45	7.50					1		11-03	DIRECTIONAL WITHOUT CARDINAL ONE DESTINATION (ARROW)
	11-03	D1-1		ESTR	4-	7.50							11-02	
	11-04	J13-1	24	X	45	7.50			1		1	1		DIRECTIONAL WITHOUT CARDINAL
	11-05	R1-1	30	X	30	5.18		1			1	1		STOP SIGN
	11-06	R1-1	36	Х	36	7.46			1		1	1		STOP SIGN

HWY: USH 2 COUNTY: BAYFIELD MISCELLANEOUS QUANTITIES SHEET PROJECT NO: 1180-00-63

STH 65 PERMANENT SIGNING TYPE II

				SIGN		637.2210 SIGNS TYPE II	637.2230 SIGNS TYPE II	634.0614	634.0616	638.2602 REMOVING	638.3000 REMOVING	SIGN	
				SIZE		REFLECTIVE	REFLECTIVE		OD 4X6-INCH	SIGNS	SMALL SIGN	MOUNTED	
	SIGN	SIGN	W	Х	Н	Н	F	14 FT	16 FT	TYPE II	SUPPORTS	ON SAME	
CATEGORY	#	CODE	IN		IN	SF	SF	EACH	EACH	EACH	EACH	POST AS	REMARKS
0010													
	1-01	J4-1		ESTR									REASSURANCE ASSEMBLY
	1-02	R5-1A		ESTR									WRONG WAY
	1-03	155-56		ESTR									ADOPT A HIGHWAY SPONSOR
	1-04	R5-1A		ESTR									WRONG WAY
	1-05	R2-1		ESTR									SPEED LIMIT 25 MPH
	1-06	12-3		ESTR									ROBERTS POPULATION 1651
	1-07	J1-1		ESTR									JUNCTION OR END ASSEMBLY
	1-08	W14-3		ESTR									NO PASSING ZONE
	1-09	D1-1		ESTR									ONE DESTINATION (ARROW)
	2-01	R1-1	30	X	30	5.18		1		1	1		STOP SIGN
	2-02	R1-1	30	Х	30	5.18		1		1	1		STOP SIGN
	4-01	155-56	30	Х	36	7.50			1	1	1		ADOPT A HIGHWAY SPONSOR
	4-02	W14-3	48	Х	36		6.00		1	1	1		NO PASSING ZONE
	4-03	R1-1	30	Х	30	5.18		1		1	1		STOP SIGN
	4-04	R1-1	30	Х	30	5.18		1		1	1		STOP SIGN
	5-01	W14-3	48	X	36		6.00		1	1	 1		NO PASSING ZONE
	5-02	W14-3	48	Х	36		6.00		1	1	1		NO PASSING ZONE
	6-01	J1-1	24	Х	39	6.50			1	1	1		JUNCTION OR END ASSEMBLY
	6-02	155-56	30	X	36	7.50			1	1	1		ADOPT A HIGHWAY SPONSOR
	6-03	J4-1	24	X	36	6.00			1	1	1		REASSURANCE ASSEMBLY
	6-04	J13-1	24	X	45	7.50			<u>.</u> 1	1	1		DIRECTIONAL WITHOUT CARDINAL
	6-05	J13-1	24	X	45	7.50			1	1	1		DIRECTIONAL WITHOUT CARDINAL
	6-06	R1-1	36	X	36	7.46			1	1	1		STOP SIGN
	6-07	R1-1	36	X	36	7.46			1	1	1		STOP SIGN
	6-08	J13-1	24	X	45	7.50			1	1	1		DIRECTIONAL WITHOUT CARDINAL
	6-09	J13-1	24	X	45	7.50			<u>'</u> 1	1	1		DIRECTIONAL WITHOUT CARDINAL
	6-10	J4-1	24	X	36	6.00			1	1	1		REASSURANCE ASSEMBLY
	6-11	155-56	30	X	36	7.50			1	1	1	6-12	ADOPT A HIGHWAY SPONSOR
	6-12	W14-3	48	X	36		6.00			1		6-11	NO PASSING ZONE
	6-13	J1-1	24	X	39	6.50			1	1	1		JUNCTION OR END ASSEMBLY
	8-01	W14-3	48	X	36		6.00		<u>'</u> 1	1	<u>'</u> 1		NO PASSING ZONE
	8-02	R1-1	30	X	30	5.18	0.00	1		1	1		STOP SIGN
	8-03	R1-1	30	X	30	5.18		1		1	1		STOP SIGN
	10-01	155-56	30	X	36	7.50			1	1	1		ADOPT A HIGHWAY SPONSOR
	10-01	R1-1	30	X	30	5.18		1		1	1		STOP SIGN
	10-02	R1-1	30	X	30	5.18		1		1	1		STOP SIGN
	10-03	155-56	30	X	36	7.50			1	1	1		ADOPT A HIGHWAY SPONSOR
	10-04	W14-3	48	X	36		6.00		1	1	1		NO PASSING ZONE
	11-01	W14-3 W14-3	48	X	36		6.00		1	1	1		NO PASSING ZONE
	11-01	R1-1	30	X	30	5.18	6.00	1		1	1		STOP SIGN
	11-02	R1-1	30	X	30	5.18		1		1	<u></u>		STOP SIGN
	11-03	J1-1	30	ESTR	30	5.16							JUNCTION OR END ASSEMBLY
	11704	31-1		LOIK			.	J		y 		J	JOHO HON ON LIND AGGLIVIBLE
	PROJECT 15	540-00-60 TO	TAL			159.22	42.00	10	21	32	31		
											**		

COUNTY: ST. CROIX HWY: STH 65 MISCELLANEOUS QUANTITIES PROJECT NO: 1540-00-60

FILE NAME : G:\WDOTCO\14023 (2014 - 2016 DESIGN WORK ORDERS)\14023-018\CIVIL 3D\SHEETSPLAN\MQ\030201-MQ.DWG

PLOT BY : KL ENGINEERING PLOT NAME :PLOT SCALE : 1:1.185

USH 63 PERMANENT SIGNING TYPE II

				SIGN		637.2210 SIGNS TYPE II	637.2230 SIGNS TYPE II	634.0614	634.0616	634.0618	638.2602 REMOVING	638.3000 REMOVING	SIGN	
	SIGN	SIGN	W	SIZE X	Н	REFLECTIVE H	REFLECTIVE F	14 FT	16 FT	18 FT	SIGNS TYPE II	SMALL SIGN SUPPORTS	MOUNTED ON SAME	
CATEGORY	#	CODE	IN		IN	SF	SF	EACH	EACH	EACH	EACH	EACH	POST AS	REMARKS
0010														
	1-01	J4-1		ESTR									1-02	REASSURANCE ASSEMBLY
	1-02	D2-1		ESTR									1-01	DESTINATION/DISTANCE (ONE DESTINATION)
	1-03	R2-1		ESTR										SPEED LIMIT 55 MPH
	1-04	R5-1		ESTR										DO NOT ENTER
	1-05	R1-1		ESTR										STOP SIGN
	1-06	J3-3		ESTR										DIRECTIONAL ASSEMBLY
	1-07	R4-7		ESTR										KEEP RIGHT NIGHT ARROW (DOUBLE)
	1-08	W1-7		ESTR										
	1-09 1-10	JH-1 R2-1	24	ESTR X	30	5.00		1				 1		HOSPITAL ROUTE ASSEMBLY SPEED LIMIT 35 MPH
	1-10	J4-2	48	X	36	12.00			1		1	1		REASSURANCE ASSEMBLY
	1-12	J3-2	48	X	57	19.00				1	1	1		DIRECTIONAL ASSEMBLY
	1-13	D1-2	84	Х	30	17.50		2			1	2		TWO DESTINATION (ARROWS)
	1-14	R3-9B	24	Х	36	6.00			1		1	1		CENTER LANE LEFT TURN ONLY SYMBOL
	1-15	J2-2	48	Х	57	19.00				1	1	1		ROUTE TURN ASSEMBLY
	1-16	R2-1	24	Х	30	5.00		1			1	1		SPEED LIMIT 35 MPH
	2-01	R2-1	24	Х	30	5.00		1			1	1		SPEED LIMIT 35 MPH
	2-02	R1-1	30	Χ	30	5.18		1			1	1		STOP SIGN
	2-03	R7-66		ESTR										NO PARKING CITY STREETS _HR TO _HR
	2-04	S1-1	36	Χ	36		6.75			1	1	1	2-05, 2-06	SCHOOL ADVANCE
	2-05	S16-9P	30	Х	18		3.75				1		2-04, 2-06	AHEAD PLAQUE (FLUORESCENT YELLOW GREEN)
	2-06	R2-6P	24	Х	18		3.00				1		2-04, 2-05	FINES HIGHER PLAQUE
	2-07	E10-82		ESTR										MIDDLE & HIGH SCHOOL/ICE ARENA/BASEBALL FIELDS
	2-08	D2-18	40	ESTR										NORTHERN LAKES CHURCH
	2-09	W14-3	48	X	36	 F 00	6.00		1		1	1	2-10	NO PASSING ZONE SPEED LIMIT 35 MPH
	2-10 2-11	R2-1 R2-1	24 24	X X	30 30	5.00 5.00		1			1	1	2-09	SPEED LIMIT 35 MPH
	2-11	S5-2	24	X	30	5.00		1			1	1		END SCHOOL ZONE
	2-13	S1-1	36	X	36		6.75	· 	1		1	1	2-14	SCHOOL ADVANCE
	2-14	S16-7L	30	Х	18		3.75				1		2-13	LEFT DIAGONAL DOWNWARD ARROW (FLUORESCENT YELLOW GREEN)
	2-15	R1-1	30	Х	30	5.18		1			1	1		STOP SIGN
	2-16	R1-1	30	Х	30	5.18		1			1	1		STOP SIGN
	2-17	S1-1	36	Х	36		6.75		1		1	1	2-18	SCHOOL ADVANCE
	2-18	S16-7L	30	Х	18		3.75				1		2-17	LEFT DIAGONAL DOWNWARD ARROW (FLUORESCENT YELLOW GREEN)
	2-19	W54-59		REMOV	E						1	1		HOSPITAL ENTRANCE
	2-20	R3-9B	24	Х	36	6.00			1		1	1		CENTER LANE LEFT TURN ONLY SYMBOL
	2-21	JH-1	24	Х	45	7.50			1		1	1		HOSPITAL ROUTE ASSEMBLY
	2-22	R3-9B	24	Х	36	6.00			1		1	1		CENTER LANE LEFT TURN ONLY SYMBOL
	2-23	S5-2	24	Х	30	5.00		1			1	1		END SCHOOL ZONE
	2-24	R1-1	30		30	5.18		1			1	1	 DOLE 0.00 0.07	STOP SIGN
	2-25	S1-1	36	X	36		6.75				1		POLE, 2-26, 2-27 POLE, 2-25, 2-27	SCHOOL ADVANCE AHEAD PLAQUE (FLUORESCENT YELLOW GREEN)
	2-26 2-27	S16-9P R2-6P	30 24		18 18		3.75 3.00				1		POLE, 2-25, 2-27 POLE, 2-25, 2-26	FINES HIGHER PLAQUE
	2-27 2-28	W54-59		REMOV			3.00				1	 1	FOLE, 2-25, 2-26	HOSPITAL ENTRANCE
	2-28	W54-59 JH-1	24		⊑ 45	7.50			1		1	1		HOSPITAL ENTRANCE HOSPITAL ROUTE ASSEMBLY
	2-29	R1-1	30	X	30	5.18		1			1	1		STOP SIGN
	2-31	R1-1	30	X	30	5.18		1			1	1		STOP SIGN
	2-32	R3-9B	24	Х	36	6.00					1		POLE	CENTER LANE LEFT TURN ONLY SYMBOL
	2-33	R2-1	24	Х	30	5.00		1			1	1		SPEED LIMIT 35 MPH
	2-34	R1-1	30		30	5.18		1			1	1		STOP SIGN
	SUB	TOTAL				182.76	54.00	16	9	3	38	30		

FILE NAME : G:\WDOTCO\14023 (2014 - 2016 DESIGN WORK ORDERS)\14023-018\CIVIL 3D\SHEETSPLAN\MQ\030201-MQ.DWG

PROJECT NO: 1550-01-60

HWY: USH 63

COUNTY: BARRON

MISCELLANEOUS QUANTITIES

PLOT BY : KL ENGINEERING PLOT NAME :PLOT SCALE : 1:1.185

USH 63 PERMANENT SIGNING TYPE II (CONTINUED)

				SIGN		637.2210 SIGNS TYPE II	637.2230 SIGNS TYPE II	634.0614	634.0616	634.0618	638.2602 REMOVING	638.3000 REMOVING	SIGN	
				SIZE		REFLECTIVE	REFLECTIVE	-	S WOOD 4X6		SIGNS	SMALL SIGN	MOUNTED	
	SIGN	SIGN	W	Х	Н	Н	F	14 FT	16 FT	18 FT	TYPE II	SUPPORTS	ON SAME	
CATEGORY	#	CODE	IN		IN	SF 100 TO	SF	EACH	EACH	EACH	EACH	EACH	POST AS	REMARKS
0010	SUB	TOTAL				182.76	54.00	16	9	3	38	30		
	2-35	R2-1	24		30	5.00		1			1	1		SPEED LIMIT 25 MPH
	2-36	R1-1	30	Х	30	5.18		1			1	1		STOP SIGN
	2-37	J2-2	48	Х	57	19.00				1	1	1		ROUTE TURN ASSEMBLY
	3-01	J4-2	48	X	36	12.00			1		1	1		REASSURANCE ASSEMBLY
-	3-02	W3-1	36	X	36		9.00		2		1	1		STOP AHEAD
	3-03	R2-1	24	X	30	5.00		1			1 1	1		SPEED LIMIT 25 MPH TWO DESTINATION (ARROWS)
	3-04	D1-2	72	X	30	15.00		2			•	1		
	3-05	R1-1	30	X	30	5.18		1			1	1	POLE, 3-07	STOP SIGN
	3-06	R1-1	36	X X	36 9	7.46					1		POLE, 3-06	STOP SIGN ALL WAY
=	3-07 3-08	R1-3P J2-1	24	X	57	1.50					1		POLE	ROUTE TURN ASSEMBLY
	3-09	JH-1	24	X	45	9.50 7.50			1		1	1		HOSPITAL ROUTE ASSEMBLY
	3-09	J13-2	48	X	45	15.00					1		POLE	DIRECTIONAL WITHOUT CARDINAL
	3-10	R1-1	36	X	36	7.46					1		POLE, 3-12	STOP SIGN
	3-11	R1-3P	24	X	9	1.50					1		POLE, 3-11	ALL WAY
-	3-12	R1-1	36	X	36	7.46					1		POLE, 3-14	STOP SIGN
	3-13	R1-3P	24	X	9	1.50					1		POLE, 3-13	ALL WAY
	3-14	J12-2	48	X	45	15.00			1		1	1		ROUTE TURN WITHOUT CARDINAL
	3-16	R1-1	36	X	36	7.46					1		POLE, 3-17	STOP SIGN
	3-17	R1-3P	24	X	9	1.50					1		POLE, 3-16	ALL WAY
-	3-18	R7-5D		ESTR										2 HOUR PARKING 9AM TO 5PM (DOUBLE ARROW)
	3-19	R2-1	24	Х	30	5.00					1		POLE	SPEED LIMIT 25 MPH
	3-20	W3-1	36	Х	36		9.00				1		POLE	STOP AHEAD
	3-21	R7-5D	00	ESTR	00									2 HOUR PARKING 9AM TO 5PM (DOUBLE ARROW)
	3-22	J1-1	24	Х	39	6.50					1		POLE	JUNCTION OR END ASSEMBLY
_	3-23	R1-1	30	X	30	5.18		1			1	1		STOP SIGN
	4-01	R1-1	30	Х	30	5.18		1			1	1		STOP SIGN
	4-02	R7-5D		ESTR									POLE, 4-03	2 HOUR PARKING 9AM TO 5PM (DOUBLE ARROW)
	4-03	R2-1	24	Х	30	5.00					1		POLE, 4-02	SPEED LIMIT 25 MPH
	4-04	R7-5D		ESTR									POLE, 4-05	2 HOUR PARKING 9AM TO 5PM (DOUBLE ARROW)
-	4-05	R2-1	24	Х	30	5.00					1		POLE, 4-04	SPEED LIMIT 25 MPH
	4-06	R1-1	30	Χ	30	5.18		1			1	1		STOP SIGN
	4-07	R7-5D		ESTR							1		POLE, 4-08	2 HOUR PARKING 9AM TO 5PM (DOUBLE ARROW)
	4-08	R3-4	24	X	24	4.00					1		POLE, 4-07	NO U TURN SYMBOL
	4-09	R1-1	30	X	30	5.18		1			1	1		STOP SIGN
-	4-10	S4-52		ESTR									ROAD MOUNT	SCHOOL YIELD TO PEDESTRIANS WITHIN CROSSWALK
	4-11	S4-52		ESTR									ROAD MOUNT	SCHOOL YIELD TO PEDESTRIANS WITHIN CROSSWALK
	4-12	R7-5D		ESTR									POLE, 4-13	2 HOUR PARKING 9AM TO 5PM (DOUBLE ARROW)
	4-13	S5-2	24	Х	30	5.00					1		POLE, 4-12	END SCHOOL ZONE
	4-14	R1-1	30	X	30	5.18		1			1	1		STOP SIGN
_	4-15	R7-5D		ESTR									POLE	2 HOUR PARKING 9AM TO 5PM (DOUBLE ARROW)
	4-16	S1-1	36	Х	36		6.75				1		POLE, 4-17, 4-18	SCHOOL ADVANCE
	4-17	S16-9P	30	Χ	18		3.75				1		POLE, 4-16, 4-18	AHEAD PLAQUE (FLUORESCENT YELLOW GREEN)
	4-18	R2-6P	24	Х	18		3.00				1		POLE, 4-16, 4-17	FINES HIGHER PLAQUE
	4-19	R7-5D		ESTR									POLE, 4-20	2 HOUR PARKING 9AM TO 5PM (DOUBLE ARROW)
_	4-20	R2-1	24	Х	30	5.00					1		POLE, 4-19	SPEED LIMIT 25 MPH
	4-21	R1-1	30	Χ	30	5.18		1			1	1		STOP SIGN
	4-22	R1-1	30	Χ	30	5.18		1			1	1		STOP SIGN
	4-23	S4-51	24	Χ	48	8.00					1		POLE	SCHOOL SPEED LIMIT
	4-24	R7-5D		ESTR										2 HOUR PARKING 9AM TO 5PM (DOUBLE ARROW)

FILE NAME : G:\WDOTCO\14023 (2014 - 2016 DESIGN WORK ORDERS)\14023-018\CIVIL 3D\SHEETSPLAN\MQ\030201-MQ.DWG

PROJECT NO: 1550-01-60

HWY: USH 63

COUNTY: BARRON

PLOT DATE: 11/1/2016

MISCELLANEOUS QUANTITIES

USH 63 PERMANENT SIGNING TYPE II (CONTINUED)

				SIGN SIZE		637.2210 SIGNS TYPE II REFLECTIVE	637.2230 SIGNS TYPE II REFLECTIVE	634.0614 POS	634.0616 STS WOOD 4X6	634.0618 6-INCH	638.2602 REMOVING SIGNS	638.3000 REMOVING SMALL SIGN	SIGN MOUNTED	
	SIGN	SIGN	W		Н	Н	F	14 FT	16 FT	18 FT	TYPE II	SUPPORTS	ON SAME	
CATEGORY	#	CODE	IN		IN	SF	SF	EACH	EACH	EACH	EACH	EACH	POST AS	REMARKS
0010	SUE	STOTAL				411.72	85.50	29	14	4	78	47		
	4-25	R7-5D		ESTR										2 HOUR PARKING 9AM TO 5PM (DOUBLE ARROW)
	4-26	S1-1	36	Х	36		6.75				1		POLE, 4-27	SCHOOL ADVANCE
	4-27	S16-7L	30		18		3.75				1		POLE, 4-26	LEFT DIAGONAL DOWNWARD ARROW (FLUORESCENT YELLOW GREEN)
	4-28	S1-1	36	Х	36		6.75				1		POLE, 4-29	SCHOOL ADVANCE
	4-29	S16-7L	30	Х	18		3.75				1		POLE, 4-28	LEFT DIAGONAL DOWNWARD ARROW (FLUORESCENT YELLOW GREEN)
	4-30	S4-52		ESTR									ROAD MOUNT	SCHOOL YIELD TO PEDESTRIANS WITHIN CROSSWALK
	4-31	S4-52		ESTR									ROAD MOUNT	SCHOOL YIELD TO PEDESTRIANS WITHIN CROSSWALK
	4-32	W1-1R	36	Х	36		9.00				1		POLE	RIGHT TURN
	4-33	W13-1	24	Х	24		4.00				1		POLE	ADVISORY SPEED (YELLOW BACK)
	4-34	R7-5D		ESTR									POLE	2 HOUR PARKING 9AM TO 5PM (DOUBLE ARROW)
	4-35	S4-51	24	Х	48	8.00					1		POLE	SCHOOL SPEED LIMIT
	4-36	R1-1	30	Х	30	5.18		1			1	1		STOP SIGN
	4-37	S1-1	36	Х	36		6.75				1		POLE, 4-38, 4-39	SCHOOL ADVANCE
	4-38	S16-9P	30	Х	18		3.75				1		POLE, 4-37, 4-39	AHEAD PLAQUE (FLUORESCENT YELLOW GREEN)
	4-39	R2-6P	24	Х	18		3.00				1		POLE, 4-37, 4-38	FINES HIGHER PLAQUE
	4-40	W1-6	48	Х	24		8.00	1			1	1	4-41	NIGHT ARROW (SINGLE)
	4-41	W1-6	48	Х	24		8.00				1		4-40	NIGHT ARROW (SINGLE)
	4-42	R1-1	30	Х	30	5.18		1			1	1		STOP SIGN
	4-43	S5-2	24	Х	30	5.00					1		POLE	END SCHOOL ZONE
	4-44	R2-1	24	Х	30	5.00		1			1	1		SPEED LIMIT 25 MPH
	4-45	R2-1	24	Х	30	5.00					1		POLE	SPEED LIMIT 25 MPH
	4-46	W1-1L	36	X	36		9.00				1		POLE	LEFT TURN
	4-47	W13-1	24	X	24		4.00				1		POLE	ADVISORY SPEED (YELLOW BACK)
	5-01	R2-1	24	X	30	5.00		1			1	1		SPEED LIMIT 25 MPH
	5-02	R2-1	24	Х	30	5.00		1			1	1	5-03	SPEED LIMIT 25 MPH
	5-03	D11-6		ESTR									5-02	SNOWMOBILE ROUTE W/SYMBOL
	5-04	R1-1	30	Х	30	5.18		1			1	1		STOP SIGN
	5-05	R2-1	24	Х	30	5.00					1		POLE	SPEED LIMIT 25 MPH
	5-06	R2-1	24	Х	30	5.00					1		POLE	SPEED LIMIT 40 MPH
	5-07	R1-1	30	Х	30	5.18		1			1	1		STOP SIGN
	5-08	R1-1	30	X	30	5.18		1			1	1		STOP SIGN
	5-09	R1-1	30	Х	30	5.18					1		POLE	STOP SIGN
	5-10	W3-5	36	Х	36		9.00				1		POLE, 5-11	SPEED LIMIT 25 AHEAD (ARROW)
	5-11	D11-6		ESTR									POLE, 5-10	SNOWMOBILE ROUTE W/SYMBOL
	5-12	R1-1	30	Х	30	5.18		1			1	1		STOP SIGN
	5-13	R2-1	24	X	30	5.00		1			1	1		SPEED LIMIT 40 MPH
	5-14	R1-1	30		30	5.18		1			1	1		STOP SIGN
	5-15	R1-1	30		30	5.18		1			1	1		STOP SIGN
	5-16	R2-1	24		30	5.00		1			1	1		SPEED LIMIT 40 MPH
	5-17	R2-1	24		30	5.00		1			1	1		SPEED LIMIT 40 MPH
	5-18	R1-1	30		30	5.18		1			1	1		STOP SIGN
	6-01	R2-1	24		30	5.00		1			1	1		SPEED LIMIT 40 MPH
	6-02	R1-1	30		30	5.18		1			1	1		STOP SIGN
	6-03	R2-1	24	Х	30	5.00		1			1	1		SPEED LIMIT 55 MPH
	PROJECT 1	550-01-60 TO	TAL			536.70	171.00	48	14	4	116	66		

HWY: USH 63 COUNTY: BARRON MISCELLANEOUS QUANTITIES SHEET PROJECT NO: 1550-01-60

STH 46 PERMANENT SIGNING TYPE II

						637.2210 SIGNS	637.2230 SIGNS	634.0614	634.0616	638.2602	638.3000		
				SIGN		TYPE II	TYPE II			REMOVING	REMOVING	SIGN	
				SIZE		REFLECTIVE	REFLECTIVE .		OD 4X6-INCH	_ SIGNS	SMALL SIGN	MOUNTED	
0475000	SIGN 	SIGN	W	Х	Н	Н	F	14 FT	16 FT	TYPE II	SUPPORTS	ON SAME	DEMARKO
CATEGORY	#	CODE	IN		IN	SF	SF	EACH	EACH	EACH	EACH	POST AS	REMARKS
0010													
	1-01	R7-66		ESTR									NO PARKING ON ANY CITY STREET 2AM TO 8AM
	1-02	R1-1		ESTR									STOP SIGN
	1-03	R1-1	30	Х	30	5.18		1		1	1		STOP SIGN
	1-04	R2-1	24	Х	30	5.00			1	1	1	1-05	SPEED LIMIT 40 MPH
	1-05	R7-1L	18	X	24	3.00		1		1		1-04	NO PARKING ANY TIME (LEFT ARROW)
	1-06	R2-1	24	Х	30	5.00			1	1	1	1-07	SPEED LIMIT 55 MPH
	1-07	R7-1R	18	X	24	3.00		1		1		1-06	NO PARKING ANY TIME (RIGHT ARROW)
	1-08	12-3	60	X	24	10.00		2		1	1		AMERY POPULATION 2092
	1-09	155-56	30	X	36	7.50			1	1	1		ADOPT A HIGHWAY SPONSOR
	1-10	W3-5	36	Х	36		9.00		2	1	1		SPPED LIMIT 40 AHEAD (ARROW)
	1-11	R10-64	30	X	36	7.50			1	1	1	1-12	NO ENGINE BREAKING EXCEPT IN EMERGENCY
	1-12	R10-64F	30	X	18	3.75				1		1-11	WITHIN CITY OR VILLAGE LIMITS
	1-13	W14-3	48	X	36		6.00		1	1	1		NO PASSING ZONE
	1-14	W14-3	48	X	36		6.00		1	1	1		NO PASSING ZONE
	2-01	J1-1	24	X	39	6.50			1	1	1		JUNCTION OR END ASSEMBLY
	2-02	E10-82		ESTR									TOURIST ORIENTED DIRECTIONAL SIGNS
	2-03	R1-1	30	X	30	5.18		1		1	1		STOP SIGN
	2-04	J12-1	24	X	45	7.50			1	1	1		ROUTE TURN WITHOUT CARDINAL
	2-05	R1-1	36	X	36	7.46			1	1	1		STOP SIGN
	2-06	J12-1	24	X	45 30	7.50		1	1	1 1	1 1		ROUTE TURN WITHOUT CARDINAL
	2-07	R3-55R		REMOVE		5.00				1	1	2-09	RIGHT TURN LANE W/DOWN LEFT ARROW STATE ROUTE MARKER (2-3 DIGITS)
	2-08 2-09	M1-6 W1-7	48	X	24		8.00			1		2-09	NIGHT ARROW (DOUBLE)
	2-09	E10-82	40	ESTR	24		6.00					2-00	TOURIST ORIENTED DIRECTIONAL SIGNS
	2-10	W14-3	48	X	36		6.00		1	1	1		NO PASSING ZONE
	2-12	J1-1	24	X	39	6.50			1	1	1		JUNCTION OR END ASSEMBLY
	2-13	W14-3	48	X	36		6.00		1	1	1		NO PASSING ZONE
	2-14	J4-1	24	Х	36	6.00			1				REASSURANCE ASSEMBLY
	2-15	J4-1	24	Х	36	6.00			1				REASSURANCE ASSEMBLY
	2-16	J12-1	24	Х	45	7.50			1				ROUTE TURN WITHOUT CARDINAL
	3-01	R1-1	30	Х	30	5.18		1		1	1		STOP SIGN
	3-02	W14-3	48	Х	36				1	1	1		NO PASSING ZONE
	3-03	W14-3	48	Х	36		6.00		1	1	1		NO PASSING ZONE
	4-01	E10-82		ESTR									TOURIST ORIENTED DIRECTIONAL SIGNS
	4-02	155-56	30	X	36	7.50			1	1	1		ADOPT A HIGHWAY SPONSOR
	4-03	155-56	30	X	36	7.50			1	1	1		ADOPT A HIGHWAY SPONSOR
	4-04	R1-1	30	X	30	5.18		1		1	1		STOP SIGN
	4-05	W14-3	48	X	36		6.00		1	1	1		NO PASSING ZONE
	5-01	R1-1	30	Х	30	5.18		1		1	1		STOP SIGN
	5-02	W14-3	48	X	36		6.00		1	1	1		NO PASSING ZONE
	6-01	R1-1	30	Х	30	5.18		1		1	1		STOP SIGN
	6-02	R7-1L	24	Х	30	5.00		1		1	1		NO PARKING ANY TIME (LEFT ARROW)
	6-03	W14-3	48	Х	36		6.00		1	1	1		NO PASSING ZONE
	6-04	R7-1R	24	X	30	5.00		1		1	1		NO PARKING ANY TIME (RIGHT ARROW) NO PARKING ANY TIME (DOUBLE ARROW)
	6-05	R7-1D	24	X	30	5.00		1		1	1		NO PARKING ANY TIME (DOUBLE ARROW)
	6-06 6-07	R7-1D R7-1D	24 24	X X	30 30	5.00 5.00		1 1		1 1	1 1		NO PARKING ANY TIME (DOUBLE ARROW)
	6-08	R7-1D	24	X	30	5.00		1		1	1		NO PARKING ANY TIME (DOUBLE ARROW)
	6-08	R7-1D R7-1D	24	X	30	5.00		1		1	1		NO PARKING ANY TIME (DOUBLE ARROW)
	6-10	I3-1	36	X	24	6.00			1	1	1	6-11	LAKE OR RIVER NAME
	6-11	R9-56	18	X	24	3.00				1		6-10	NO FISHING OR DIVING FROM BRIDGE
	6-12	I3-1	36	X	24	6.00			1	1	1	6-13	LAKE OR RIVER NAME
	6-13	R9-56	18	X	24	3.00				1		6-12	NO FISHING OR DIVING FROM BRIDGE
		TOTAL				203.79	65.00	18	27	45	39		
	-												

FILE NAME : G:\WDOTCO\14023 (2014 - 2016 DESIGN WORK ORDERS)\14023-018\CIVIL 3D\SHEETSPLAN\MQ\030201-MQ.DWG

PROJECT NO: 8070-00-60

HWY: STH 46

COUNTY: POLK PLOT DATE: 11/1/2016 MISCELLANEOUS QUANTITIES

SHEET

WISDOT/CADDS SHEET 42

STH 46 PERMANENT SIGNING TYPE II (CONTINUED)

				SIGN SIZE		637.2210 SIGNS TYPE II REFLECTIVE	637.2230 SIGNS TYPE II REFLECTIVE	634.0614 POSTS WO	634.0616 OD 4X6-INCH	638.2602 REMOVING SIGNS	638.3000 REMOVING SMALL SIGN	SIGN MOUNTED	
	SIGN	SIGN	W	Х	Н	н	F	14 FT	16 FT	TYPE II	SUPPORTS	ON SAME	
CATEGORY	#	CODE	IN		IN	SF	SF	EACH	EACH	EACH	EACH	POST AS	REMARKS
0010	SUB	TOTAL				203.79	65.00	18	27	45	39		
	6-14	R7-1D	24	Х	30	5.00		1		1	1		NO PARKING ANY TIME (DOUBLE ARROW)
	6-15	R7-1D	24	Χ	30	5.00		1		1	1		NO PARKING ANY TIME (DOUBLE ARROW)
	6-16	R7-1D	24	Χ	30	5.00		1		1	1		NO PARKING ANY TIME (DOUBLE ARROW)
	7-01	R7-1D	24	Χ	30	5.00		1		1	1		NO PARKING ANY TIME (DOUBLE ARROW)
	7-02	R1-1	30	Х	30	5.18		1		1	1		STOP SIGN
,	7-03	R7-1R	24	Х	30	5.00		1		1	1		NO PARKING ANY TIME (RIGHT ARROW)
	7-04	155-56	30	Х	36	7.50			1	1	1		ADOPT A HIGHWAY SPONSOR
	7-05	R7-1L	24	Х	30	5.00		1		1	1		NO PARKING ANY TIME (LEFT ARROW)
	7-06	155-56	30	Х	36	7.50			1	1	1		ADOPT A HIGHWAY SPONSOR
	7-07	W14-3	48	Х	36		6.00		1	1	1		NO PASSING ZONE
•	7-08	R1-1	30	Х	30	5.18		1		1	1		STOP SIGN
	7-09	W2-2	30	Χ	30		6.25		1	1	1		SIDE ROAD (90 DEGREES)
	8-01	D7-68		REMOV	Ε					1	1		ROAD TO POLK COUNTY PARK 1 MILE
	8-02	W14-3	48	Χ	36		6.00		1	1	1		NO PASSING ZONE
	8-03	R1-1	30	Х	30	5.18		1		1	1		STOP SIGN
•	8-04	R1-1	30	Х	30	5.18		1		1	1		STOP SIGN
	8-05	W14-3	48	Х	36		6.00		1	1	1		NO PASSING ZONE
	9-01	MR2-1		REMOV	E					1	1	9-02, 9-03	JCT RUSTIC ROAD (BROWN)
	9-02	MR1-99		REMOV	Ε							9-01, 9-03	RUSTIC ROAD MARKER
	9-03	MR4-53		REMOV	Ε							9-01, 9-02	RUSTIC ROAD ROUTE NUMBER PANEL
•	9-04	W2-1	30	Х	30	6.25	6.25		1	1	1		CROSS ROAD
	9-05	D7-68L	60	Χ	36	15.00			2	1	1		POLK COUNTY PARK (LEFT ARROW)
	9-06	DR1-53D		REMOV	E					1	1		RUSTIC ROAD (DOUBLE ARROW)
	9-07	R1-1	30	Χ	30	5.18		1		1	1		STOP SIGN
	9-08	R1-1	30	Χ	30	5.18		1		1	1		STOP SIGN
,	9-09	DR1-53D		REMOV	E					1	1		RUSTIC ROAD (DOUBLE ARROW)
	9-10	D7-68R	60	Χ	36	15.00			2	1	1		POLK COUNTY PARK RIGHT ARROW)
	9-11	J13-1	24	Χ	45	7.50			1				POLK COUNTY PARK RIGHT ARROW)
	9-12	J13-1	24	Х	45	7.50			1				POLK COUNTY PARK RIGHT ARROW)
	10-01	MR2-1		REMOV	Ε					1	1	10-02,10-03	JCT RUSTIC ROAD (BROWN)
	10-02	MR1-99		REMOV	E							10-01,10-03	RUSTIC ROAD MARKER
	10-03	MR4-53		REMOV	E							10-01,10-02	RUSTIC ROAD ROUTE NUMBER PANEL
	10-04	J1-1		ESTR									JUNCTION OR END ASSEMBLY
	10-05	W2-6		ESTR									CIRCULAR INTERSECTION SIGN
	10-06	D1-3		ESTR									THREE DESTINATION (ARROWS)
	10-07	W3-2		ESTR									YIELD AHEAD
	10-08	D1-3		ESTR									THREE DESTINATION (ARROWS)
	10-09	155-56		ESTR									ADOPT A HIGHWAY SPONSOR
		070-00-60 TOT	· A I			331.12	95.50	30	40	71	65		ASS. TATASAWAY OF ORGOT

COUNTY: POLK HWY: STH 46 MISCELLANEOUS QUANTITIES SHEET PROJECT NO: 8070-00-60

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TH 48	PFRM	ANFNT	SIGNING	TYPF II

				SIGN		637.2210 SIGNS TYPE II	637.2230 SIGNS TYPE II	634.0614	14 634.0616 634.06 ⁻		638.2602 REMOVING	638.3000 REMOVING	SIGN	
				SIZE		REFLECTIVE	REFLECTIVE	POST	S WOOD 4X6	-INCH	SIGNS	SMALL SIGN	MOUNTED	
	SIGN	SIGN	W	Х	Н	н	F	14 FT	16 FT	18 FT	TYPE II	SUPPORTS	ON SAME	
ATEGORY	#	CODE	IN		IN	SF	SF	EACH	EACH	EACH	EACH	EACH	POST AS	REMARKS
0010														
	1-01	J4-1	24	Х	36	6.00			1		1			REASSURANCE ASSEMBLY
	1-02	D2-1	90	Х	15	9.38			2		1	2		DESTINATION/DISTANCE (ONE DESTINATION
	1-03	R1-1	30	Х	30	5.18		1			1	1		STOP SIGN
	1-04	J3-1	24	Х	57	9.50				1	1	1		DIRECTIONAL ASSEMBLY
	1-05	J3-1	24	Х	57	9.50				1	1	1		DIRECTIONAL ASSEMBLY
	1-06	D2-1	72	Χ	15	7.50			2		1	2		DESTINATION/DISTANCE (ONE DESTINATION)
	1-07	J4-1	24	Χ	36	6.00			1		1			REASSURANCE ASSEMBLY
	1-08	D1-2	84	Х	30	17.50		2			1	2		TWO DESTINATION (ARROWS)
	1-09	J2-2	48	Х	57	19.00				1	1	1		ROUTE TURN ASSEMBLY
	1-10	J1-1	30	Х	36	7.50			1		1	1		JUNCTION OR END ASSEMBLY
	1-11	W14-3	48	X	36		6.00		1		1	1		NO PASSING ZONE
	1-12	W14-3	48	X	36		6.00		1		1	1		NO PASSING ZONE
	2-01	S3-1	36	X	36		9.00		2		1	1		SCHOOL BUS STOP AHEAD
	2-02	J1-1	24	X	39	6.50			1		1	1		JUNCTION OR END ASSEMBLY
	2-03 2-04	W5-2 MR5-54L	36	X REMOVI	36		9.00		2		1 1	1 1		NARROW BRIDGE WORD MESSAGE TO RUSTIC ROAD [1] MILE/LEFT ARROV
	2-04	W54-58	30	X	30		6.25		 1		1	1		CHURCH ENTRANCE
	2-06	W5-52L	12	X	36		3.00	1			1	1		CLEARANCE STRIPER DOWN RIGHT
	2-07	W5-52R	12	X	36		3.00	1			1	1		CLEARANCE STRIPER DOWN LEFT
	2-08	W5-52R	12	X	36		3.00	1			1	1		CLEARANCE STRIPER DOWN LEFT
	2-09	W5-52L	12	Х	36		3.00	1			1	1		CLEARANCE STRIPER DOWN RIGHT
	3-01	J12-1	24	Х	45	7.50			1		1	1		ROUTE TURN WITHOUT CARDINAL
	3-02	R1-1	30	Х	30	5.18		1			1	1		STOP SIGN
	3-03	J13-1	24	Х	45	7.50			1		1	1		DIRECTIONAL WITHOUT CARDINAL
	3-04	J13-1	24	Х	45	7.50			1		1	1		DIRECTIONAL WITHOUT CARDINAL
•	3-05	R1-1	30	Х	30	5.18		1			1	1		STOP SIGN
	3-06	W5-2	36	Χ	36		9.00		2		1	1		NARROW BRIDGE WORD MESSAGE
	3-07	MR5-54R	F	REMOV	E						1	1		TO RUSTIC ROAD [1] MILE/RIGHT ARROY
	3-08	W14-3	48	Х	36		6.00		1		1	1	3-09	NO PASSING ZONE
	3-09	J1-1	24	Х	39	6.50					1		3-08	JUNCTION OR END ASSEMBLY
	3-10	W14-3	48	Χ	36		6.00		1		1	1		NO PASSING ZONE
	3-11	W2-1	30	Χ	30		6.25		1		1	1		CROSS ROAD
	3-12	155-56	30	Χ	36	7.50			1		1	2		ADOPT A HIGHWAY SPONSOR
	3-13	R1-1	30	Х	30	5.18		1			1	1		STOP SIGN
	3-14	R1-1	30	Х	30	5.18		1			1	1		STOP SIGN
	3-15	J4-1	24	Х	36	6.00			1					REASSURANCE ASSEMBLY
	3-16	J4-1	24	Х	36	6.00			1					REASSURANCE ASSEMBLY
	4-01	W5-52L	12	Х	36		3.00	1			1	1		CLEARANCE STRIPER DOWN RIGHT
	4-02	W5-52R	12	X	36		3.00	1			1	1		CLEARANCE STRIPER DOWN LEFT
	4-03	W5-52R	12	X	36		3.00	1			1 1	11		CLEARANCE STRIPER DOWN LEFT
	4-04	W5-52L	12	X	36		3.00	1	4		1	1		CLEARANCE STRIPER DOWN RIGHT
	4-05	W14-3	48 12	X X	36 36		6.00	1	1		1 1	1 1		NO PASSING ZONE
	4-06 4-07	W5-52L W5-52R	12	X	36		3.00 3.00	1			1	1		CLEARANCE STRIPER DOWN RIGHT CLEARANCE STRIPER DOWN LEFT
	4-07	W5-52R W5-52R	12	X	36		3.00	1			1	1		CLEARANCE STRIPER DOWN LEFT
	4-09	W5-52L	12	X	36		3.00	1			1	1		CLEARANCE STRIPER DOWN RIGHT
	4-09	R1-1	30	X	30	5.18		1			1	1		STOP SIGN
	5-01	W14-3	48	X	36		6.00		1		1	1		NO PASSING ZONE
	5-02	W14-3	48	X	36		6.00		1		1	1		NO PASSING ZONE
	5-03	W14-3	48	X	36		6.00		1		1	1		NO PASSING ZONE
	6-01	W14-3	48	X	36		6.00		1		1	<u>·</u>		NO PASSING ZONE
	6-02	W14-3	48	X	36		6.00		1		1	1		NO PASSING ZONE
		TOTAL			-	177.96	135.50	20	32	3	50	51		

FILE NAME : G:\WDOTCO\14023 (2014 - 2016 DESIGN WORK ORDERS)\14023-018\CIVIL 3D\SHEETSPLAN\MQ\030201-MQ.DWG

PROJECT NO: 8120-00-60

HWY: STH 48


COUNTY: BARRON


MISCELLANEOUS QUANTITIES


PLOT BY : KL ENGINEERING PLOT NAME :PLOT SCALE : 1:1.185


						637.2210	637.2230	634.0614	634.0616	634.0618	638.2602	638.3000		
						SIGNS	SIGNS							
				SIGN		TYPE II	TYPE II	D00	TO WOOD 4VO	INOLI	REMOVING	REMOVING	SIGN	
	01011	01011	147	SIZE		REFLECTIVE	REFLECTIVE		TS WOOD 4X6		SIGNS	SMALL SIGN	MOUNTED	
	SIGN	SIGN	W	Х	Н	H	F	14 FT	16 FT	18 FT	TYPE II	SUPPORTS	ON SAME	
CATEGORY	#	CODE	IN		IN	SF	SF	EACH	EACH	EACH	EACH	EACH	POST AS	REMARKS
0010	SUB	TOTAL				177.96	135.50	20	32	3	50	51		
	6-03	R1-1	30	Х	30	5.18		1			1	1		STOP SIGN
	6-04	R1-1	30	Χ	30	5.18		1			1	1		STOP SIGN
	7-01	W2-1	30	Х	30		6.25		1		1	1		CROSS ROAD
	7-02	J4-1	24	Х	36	6.00			1		1	1		REASSURANCE ASSEMBLY
	7-03	W14-3	48	Х	36		6.00		1		1	1		NO PASSING ZONE
	7-04	W14-3	48	Х	36		6.00		1		1	1		NO PASSING ZONE
	7-05	155-56	30	Χ	36	7.50			1		1	1		ADOPT A HIGHWAY SPONSOR
	7-06	R1-1	30	Χ	30	5.18		1			1	1		STOP SIGN
	7-07	R1-1	30	Х	30	5.18		1			1	1		STOP SIGN
	7-08	155-56	30	Х	36	7.50			1		1	1		ADOPT A HIGHWAY SPONSOR
	8-01	W14-3	48	Х	36		6.00		1		1	1		NO PASSING ZONE
	8-02	W14-3	48	Χ	36		6.00		1		1	1		NO PASSING ZONE
	8-03	R1-1	30	Χ	30	5.18		1			1	1		STOP SIGN
	8-04	W3-5	36	Χ	36		9.00		2		1	1		SPEED LIMIT 45 AHEAD (ARROW)
	8-05	W12-2	36	Χ	36		9.00		2		1	1		LOW CLEARANCE SYMBOL
	8-06	R2-1	24	Х	30	5.00		1			1	1		SPEED LIMIT 45 MPH
	8-07	R2-1	24	Χ	30	5.00		1			1	1		SPEED LIMIT 55 MPH
	8-08	R4-7		ESTR										KEEP RIGHT
	8-09	R5-1A		ESTR										WRONG WAY
	8-10	W6-3		ESTR										TWO WAY TRAFFIC
	8-11	J1-1		ESTR										JUNCTION OR END ASSEMBLY
	8-12	R5-1A		ESTR										WRONG WAY
	8-13	R5-1A		ESTR										WRONG WAY
	8-14	J2-3		ESTR										ROUTE TURN ASSEMBLY
	PROJECT 8	120-00-60 TO	TAL			234.86	183.75	27	44	3	67	68		


HWY: STH 48 COUNTY: BARRON MISCELLANEOUS QUANTITIES SHEET PROJECT NO: 8120-00-60

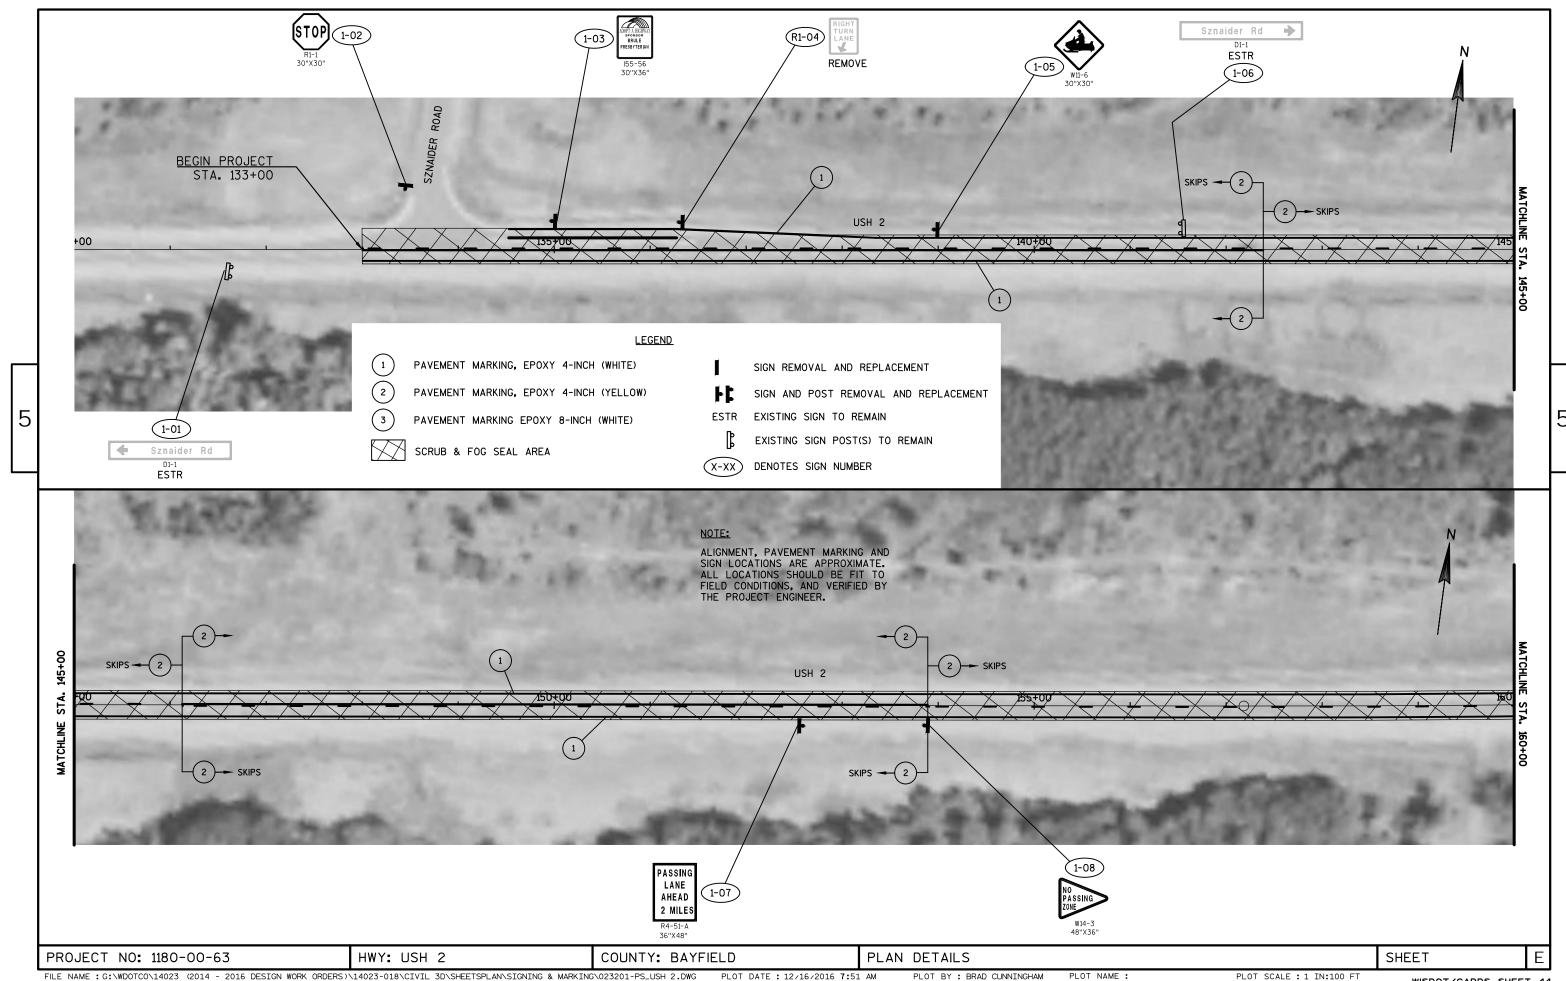


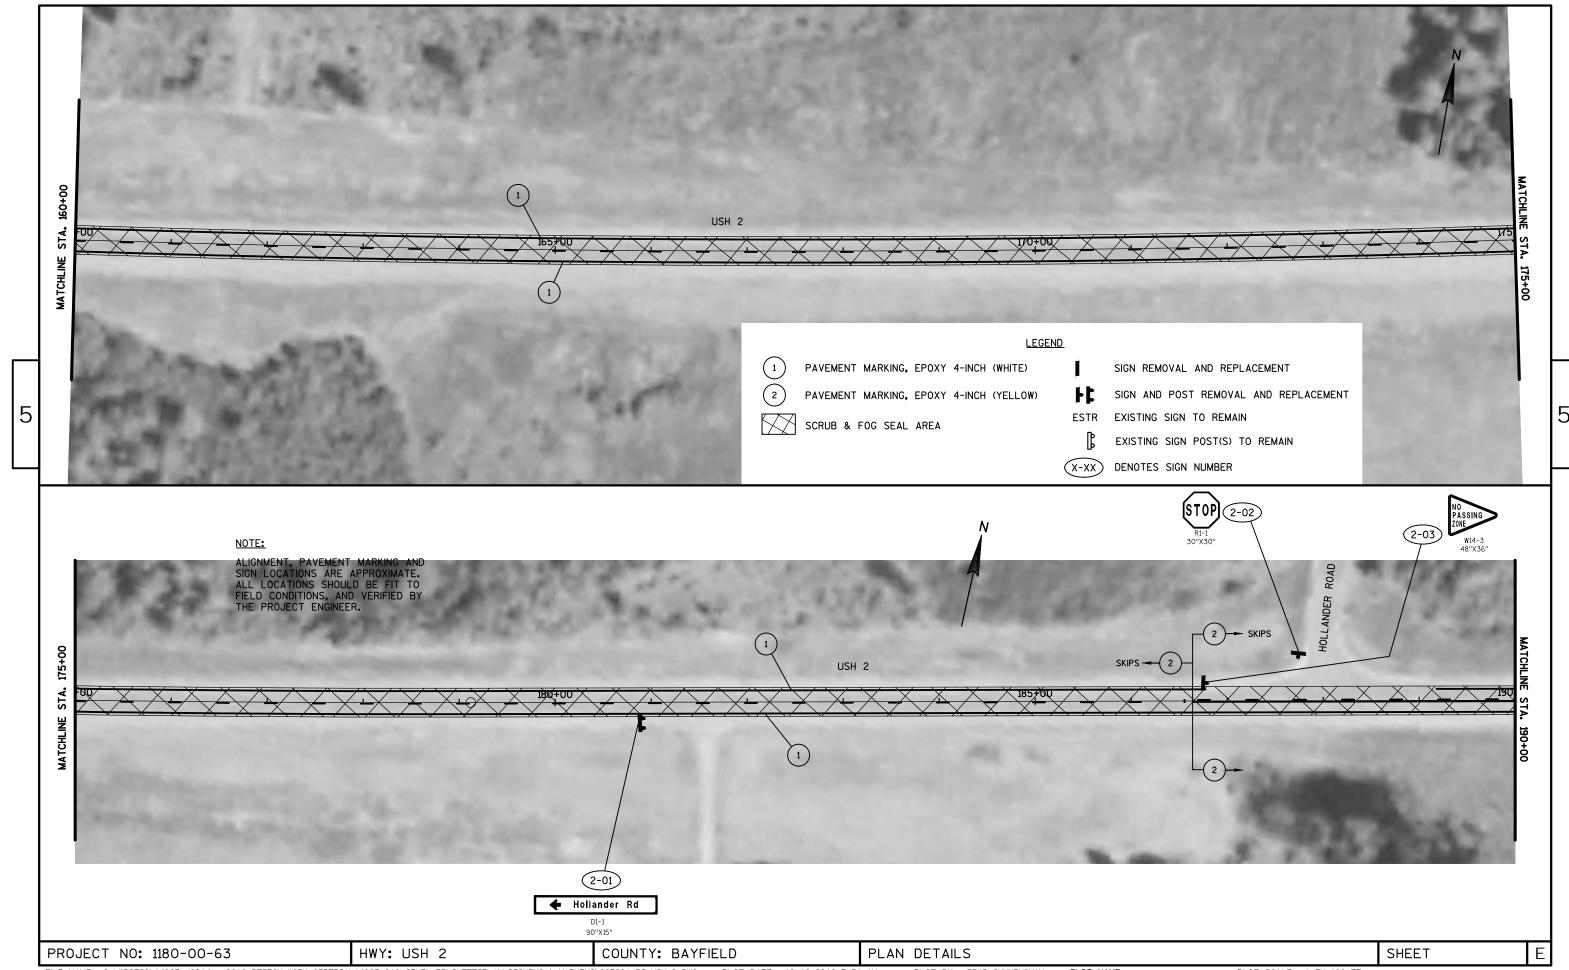


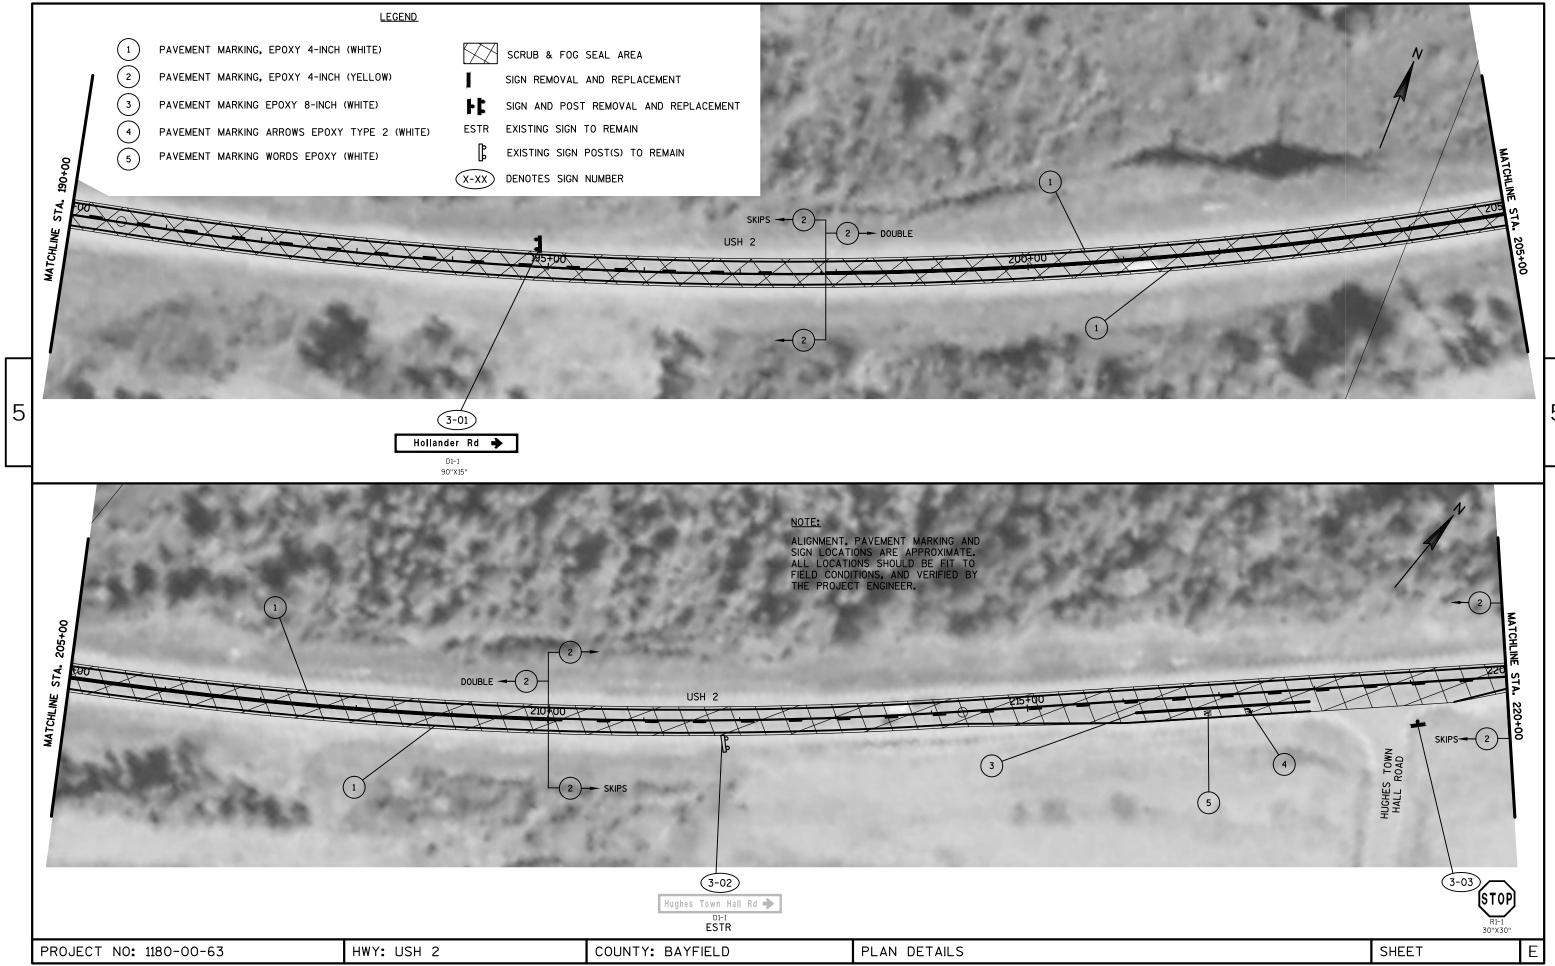


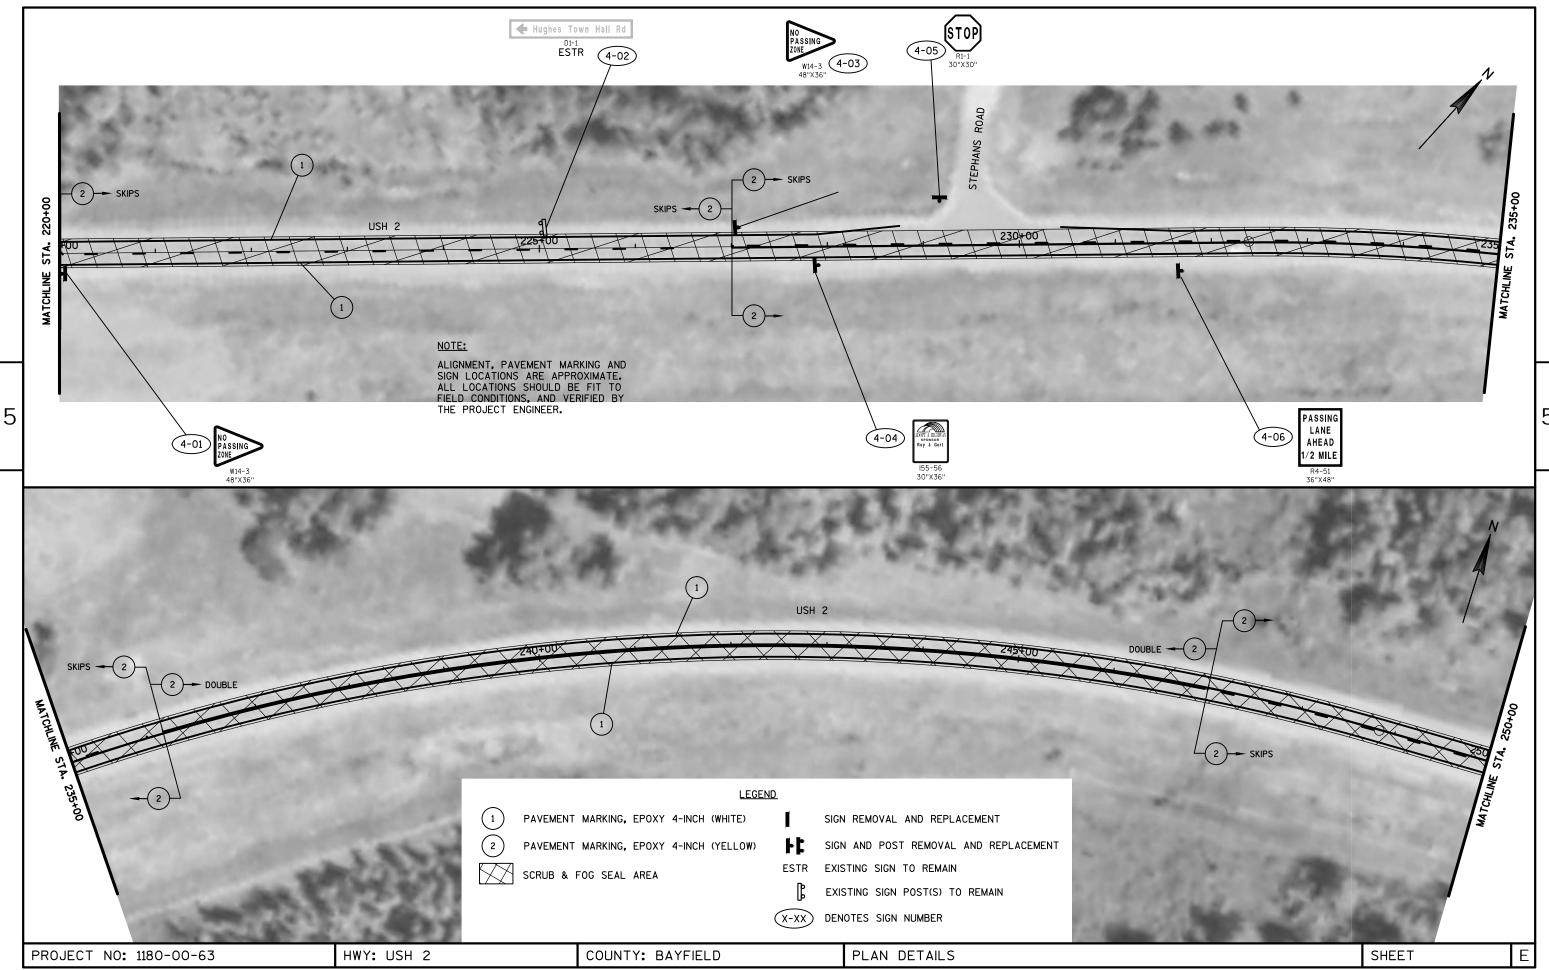


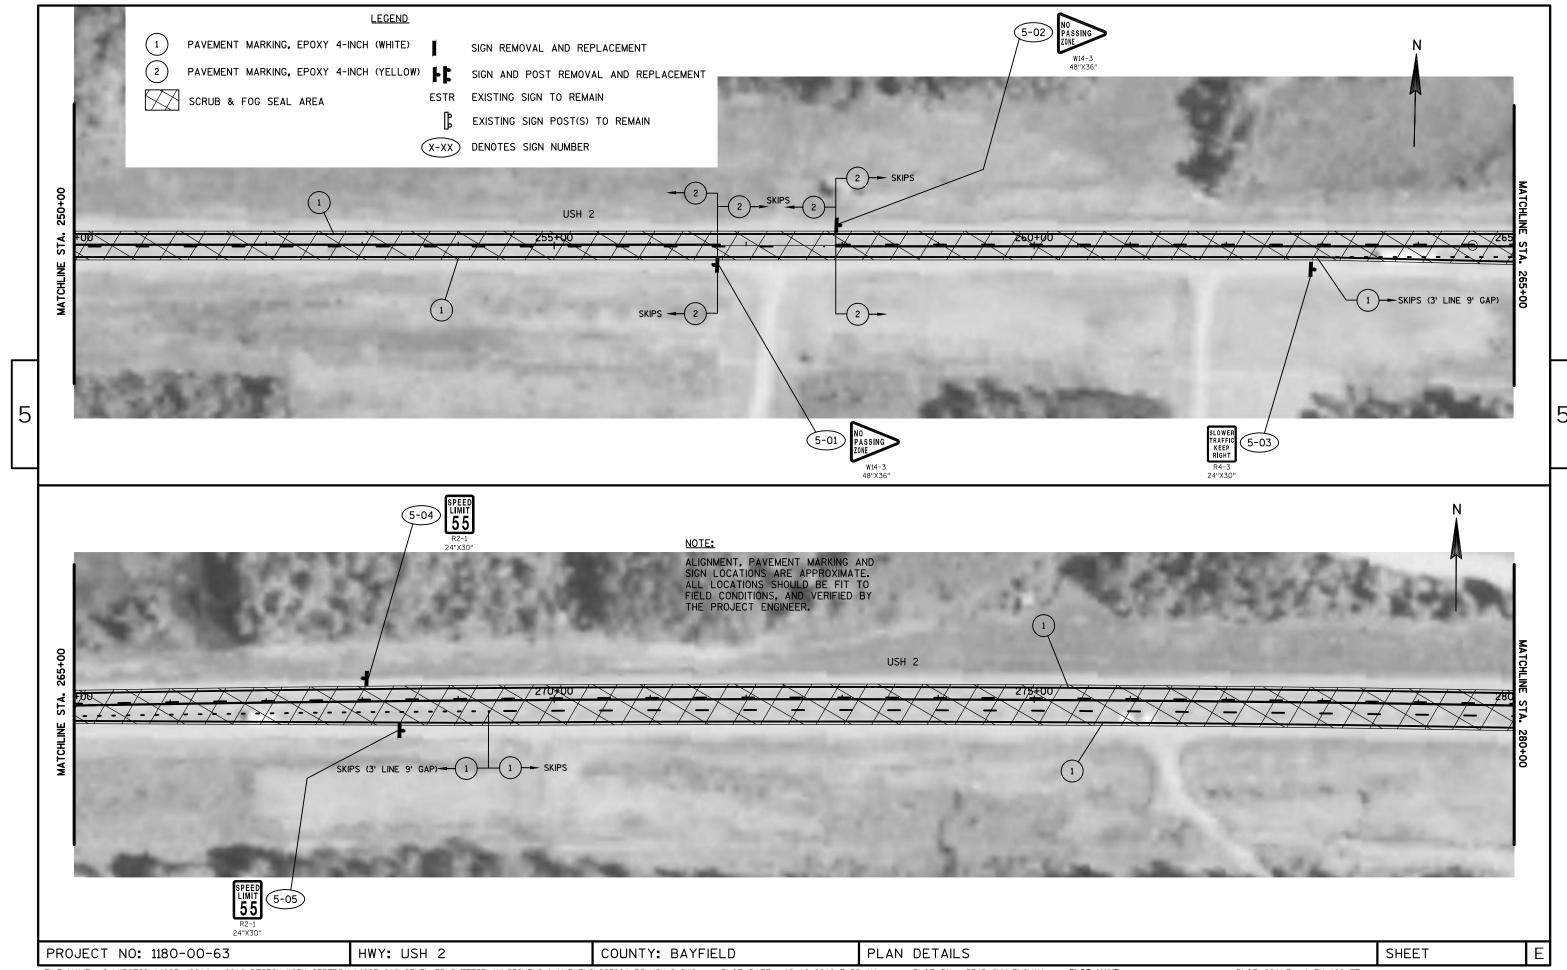


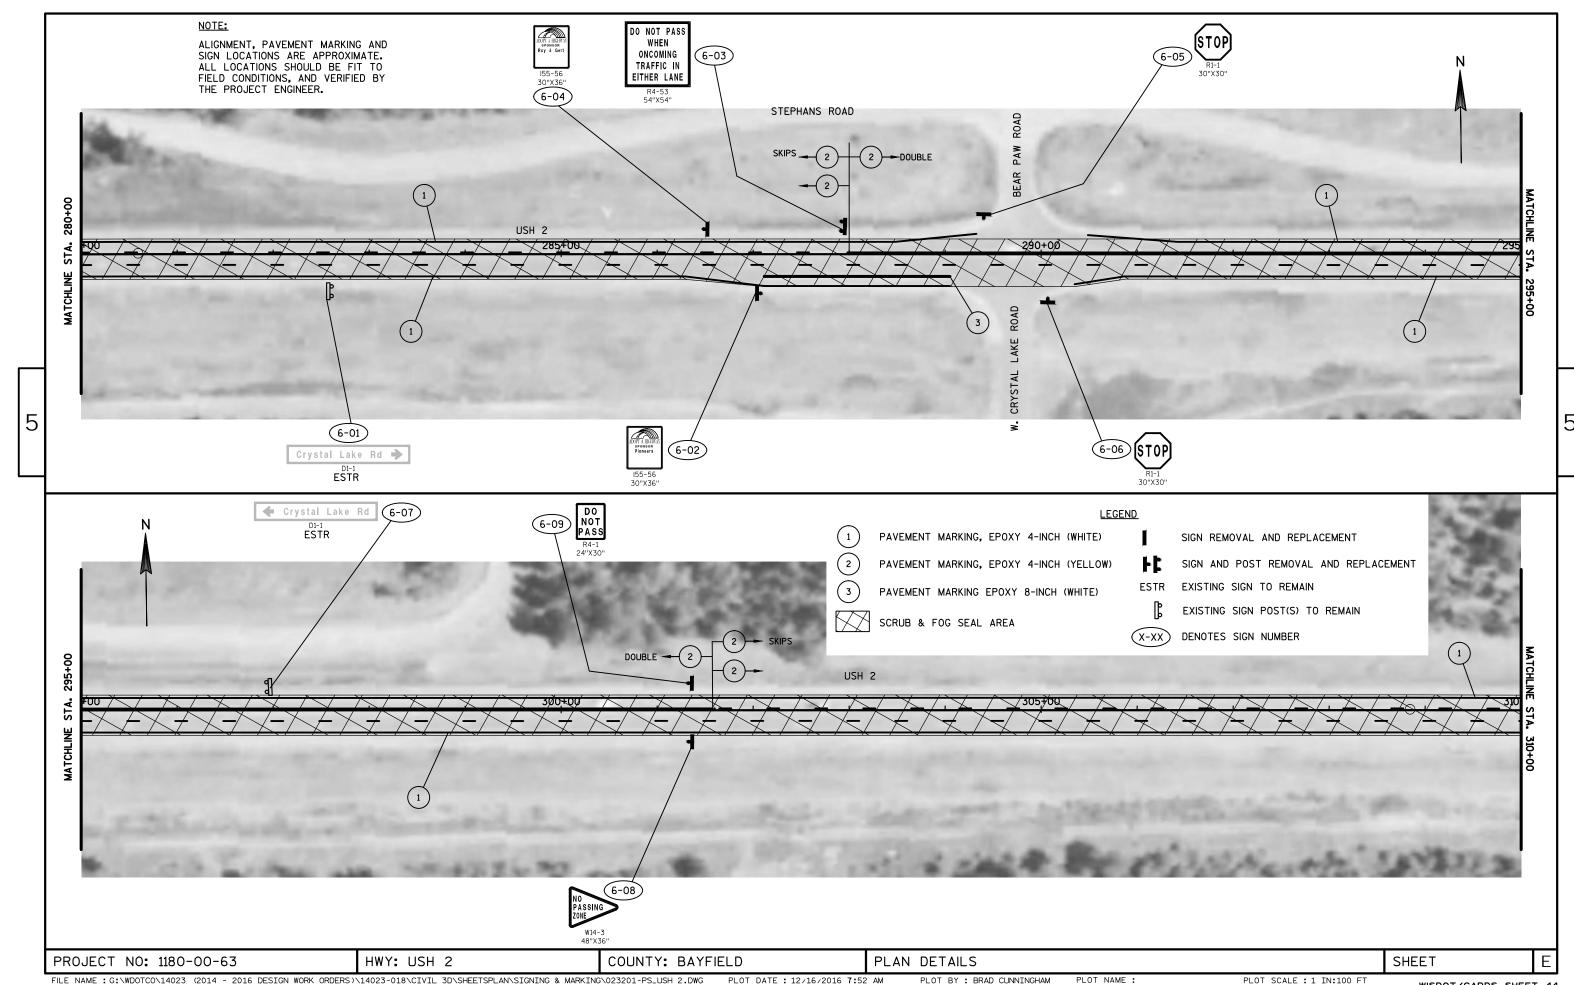

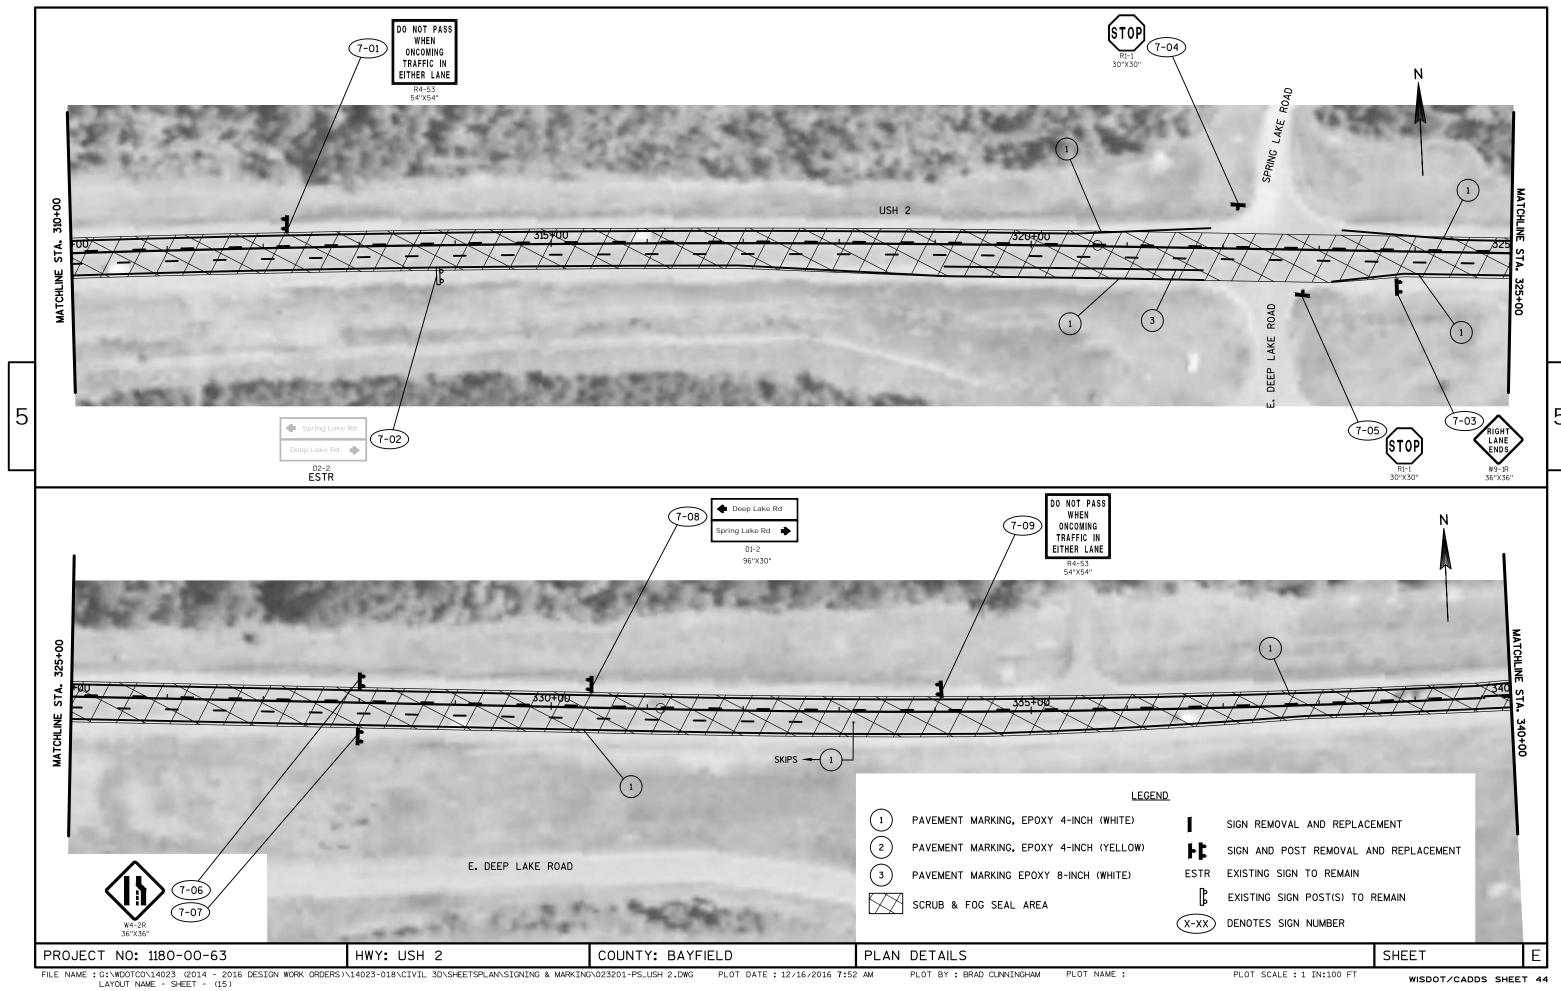

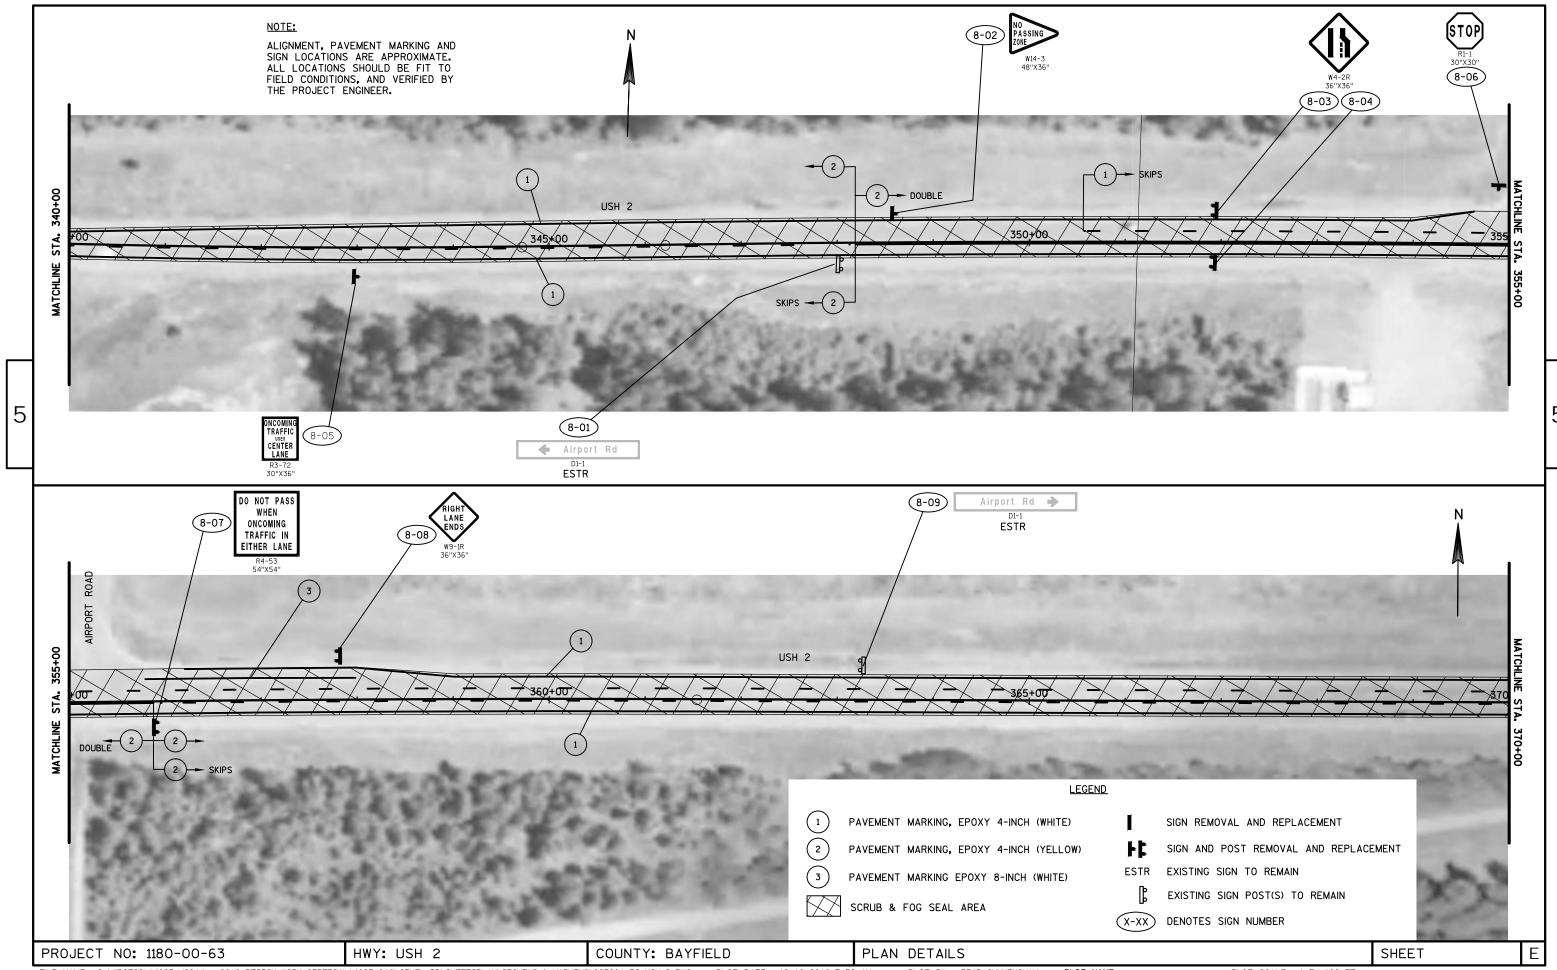


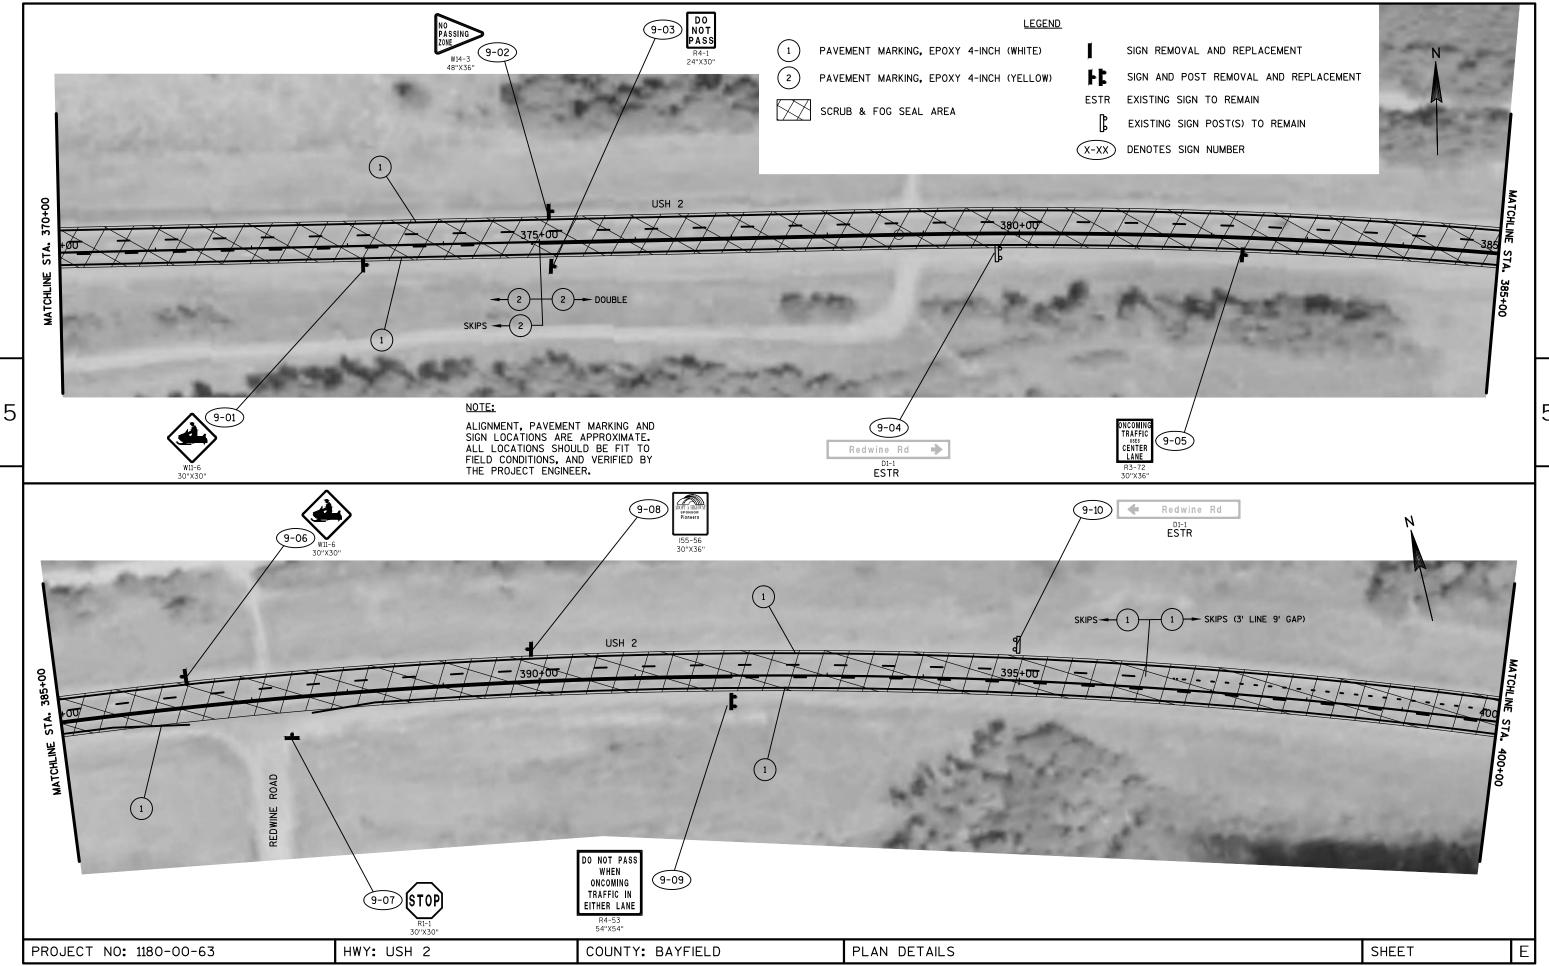

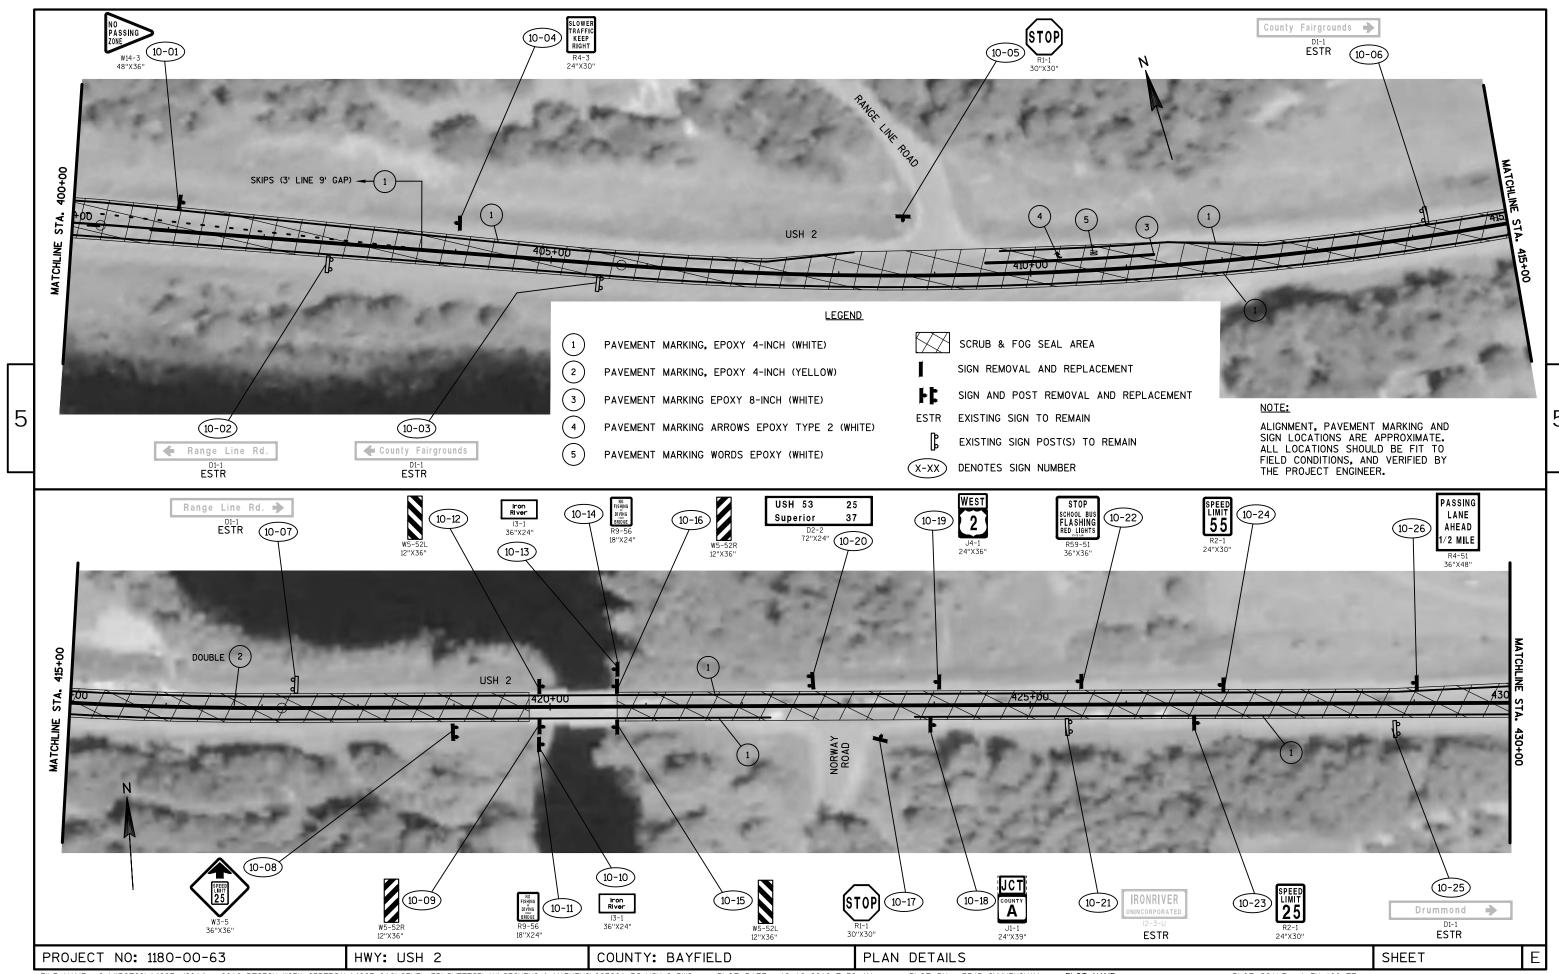






SIGN REMOVAL AND REPLACEMENT PAVEMENT MARKING, EPOXY 4-INCH (YELLOW) SIGN AND POST REMOVAL AND REPLACEMENT ESTR EXISTING SIGN TO REMAIN EXISTING SIGN POST(S) TO REMAIN (X-XX) DENOTES SIGN NUMBER PROJECT NO: 1180-00-63 SHEET HWY: USH 2 COUNTY: BAYFIELD PLAN DETAILS FILE NAME : G:\WDOTCO\14023 (2014 - 2016 DESIGN WORK ORDERS)\14023-018\CIVIL 3D\SHEETSPLAN\SIGNING & MARKING\023201-PS_USH 2.DWG PLOT DATE : 12/16/2016 7:52 AM LAYOUT NAME - SHEET - (23) PLOT BY : BRAD CUNNINGHAM PLOT SCALE : 1 IN:100 FT WISDOT/CADDS SHEET 44

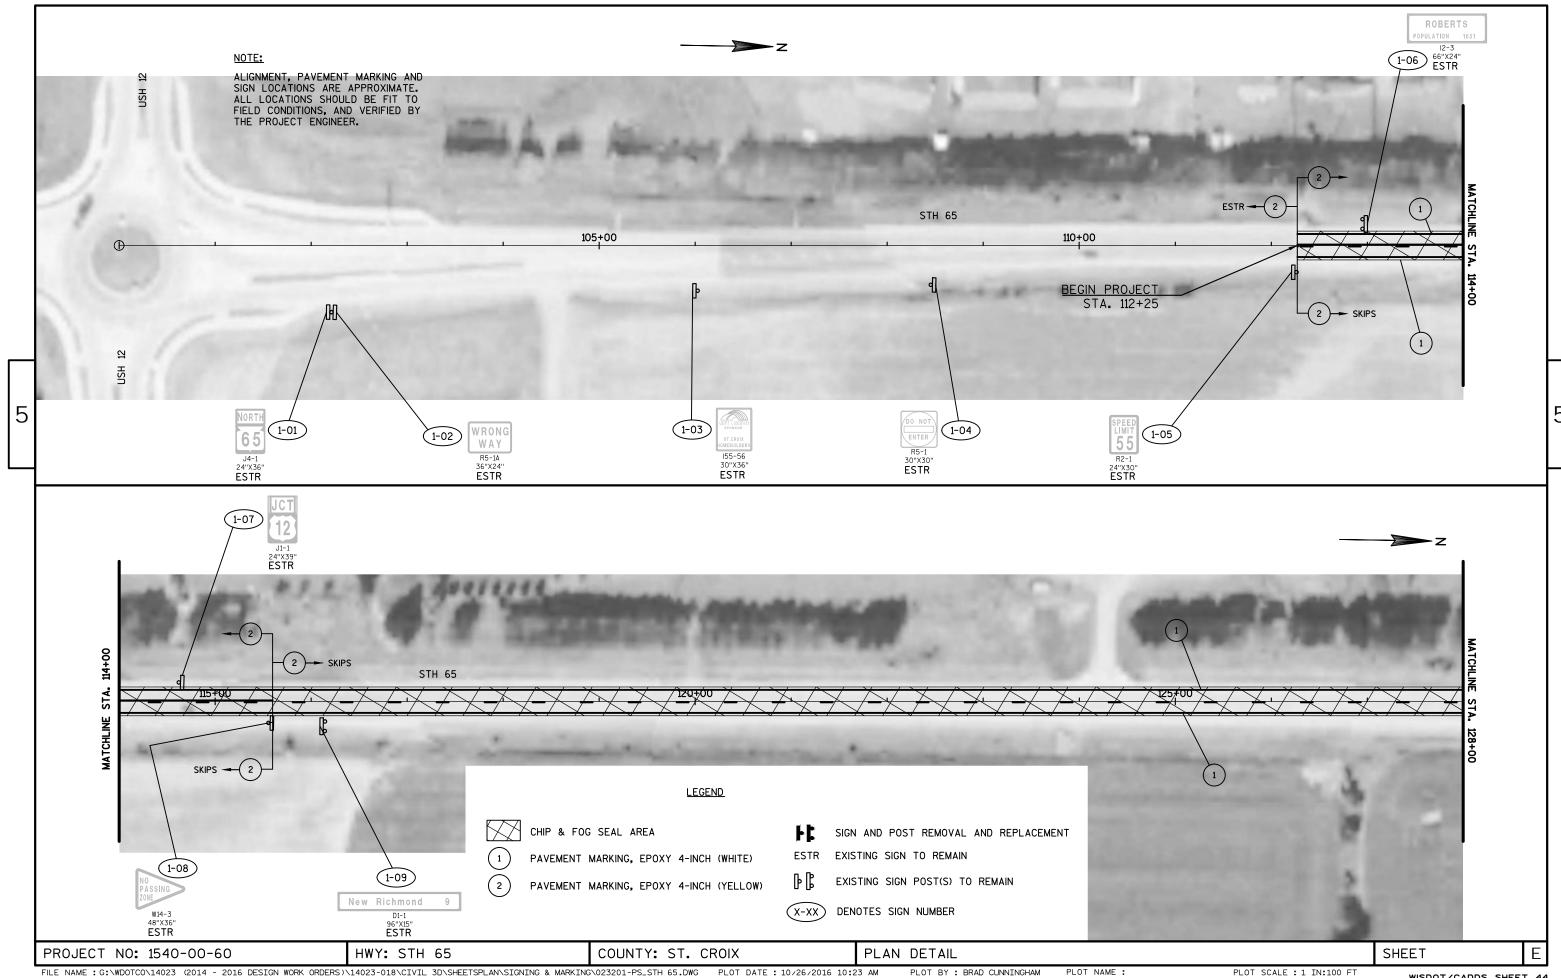





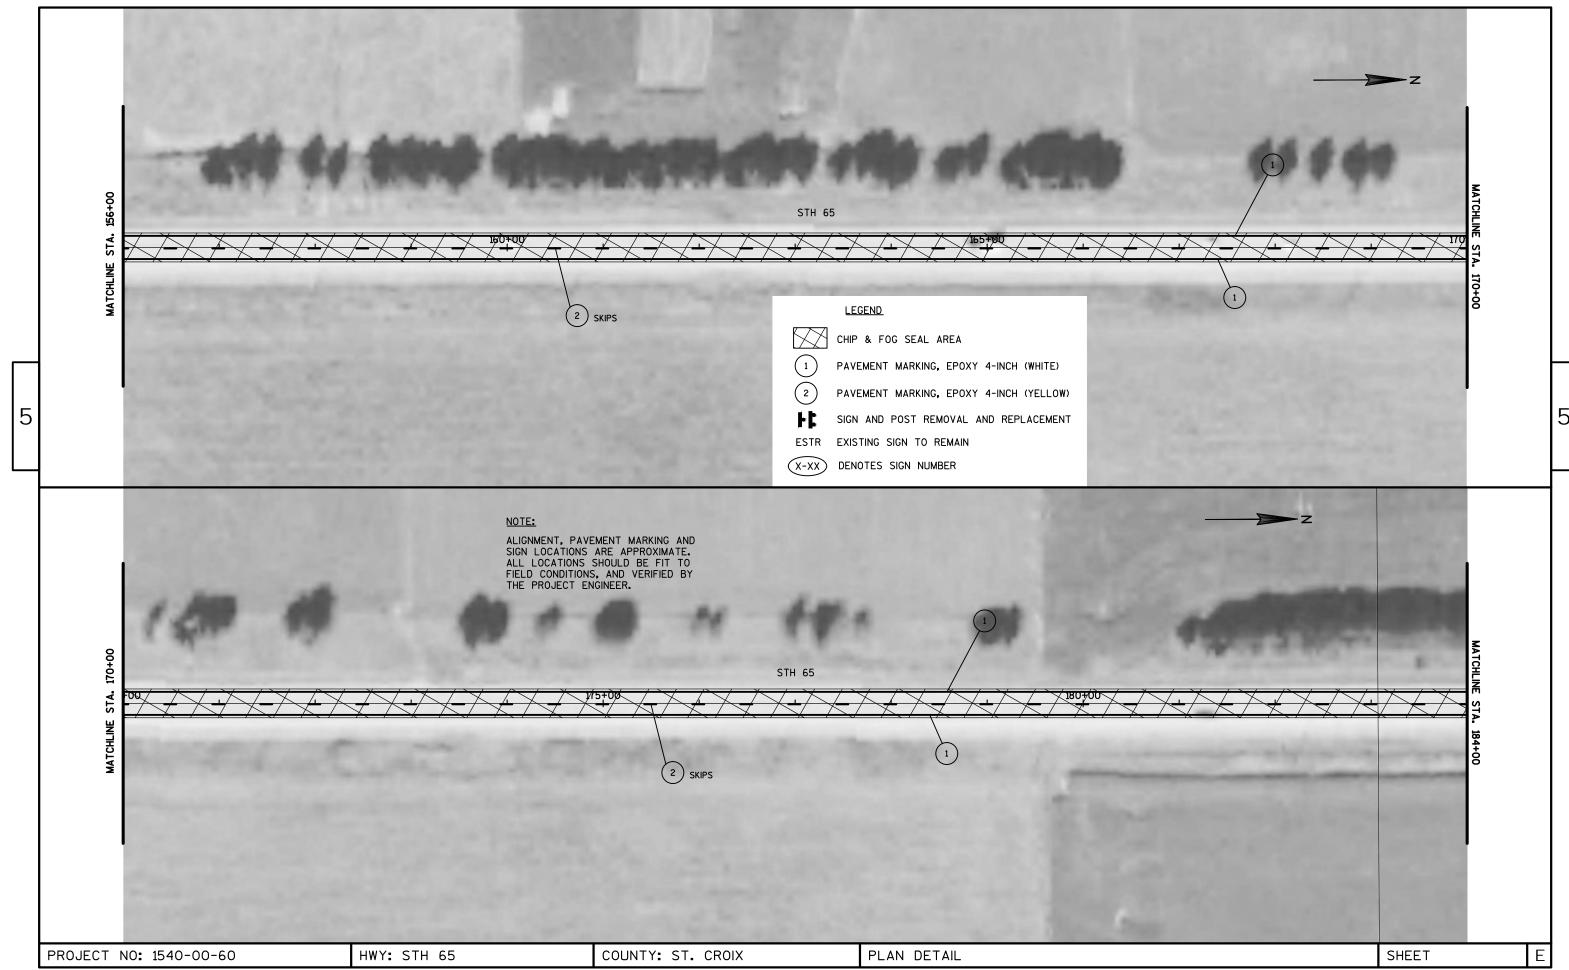


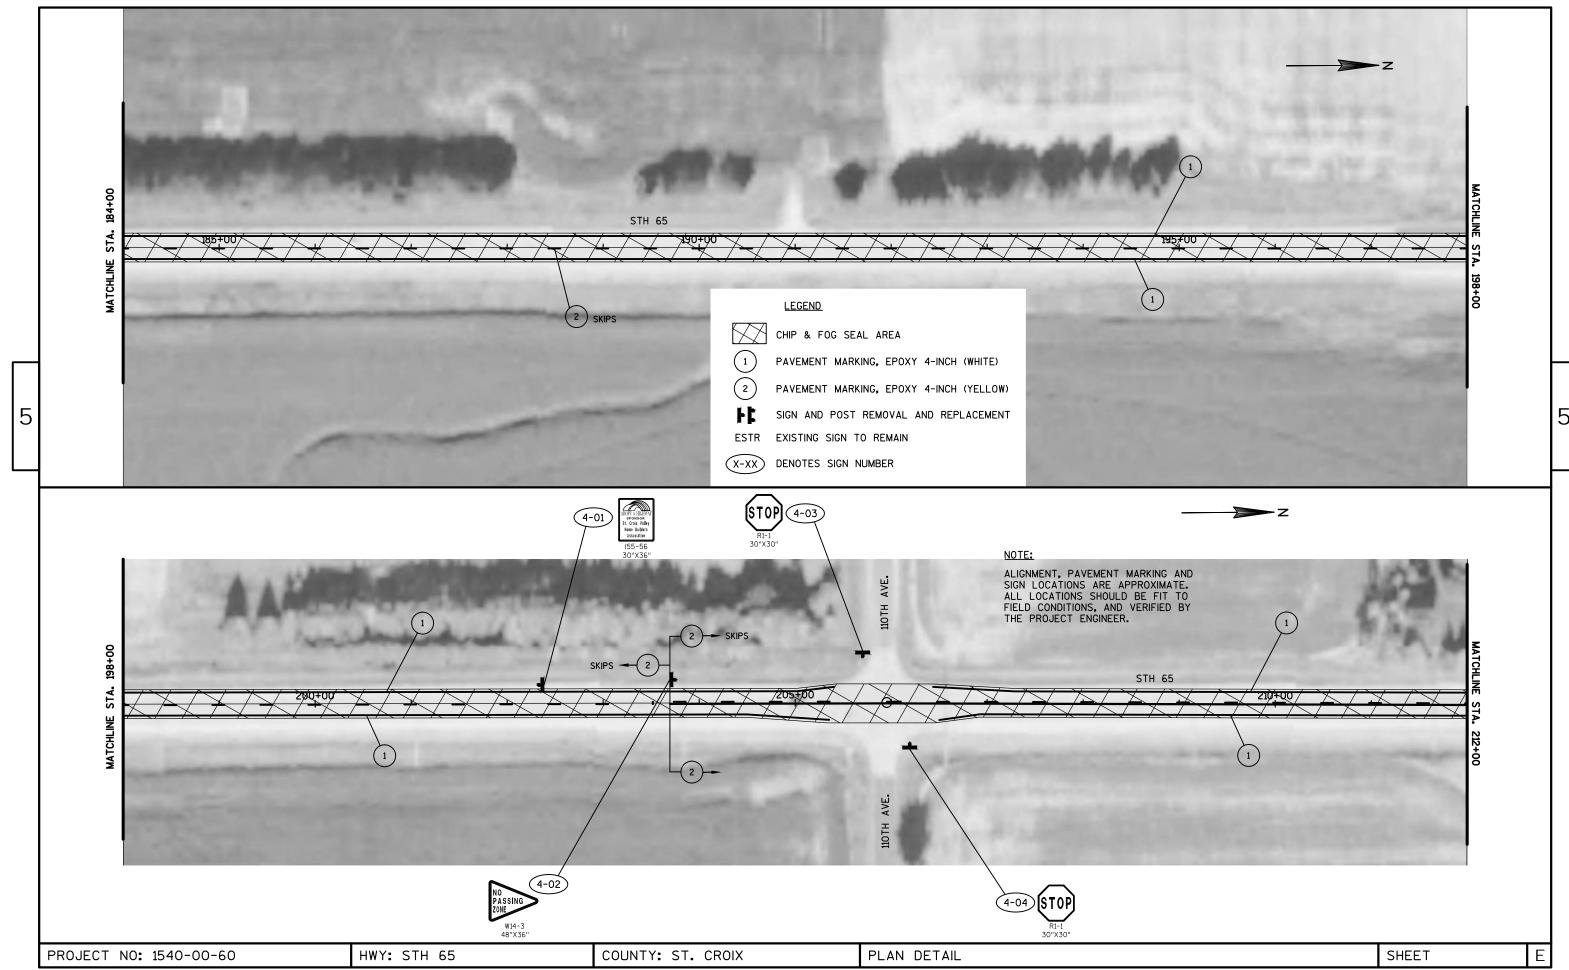

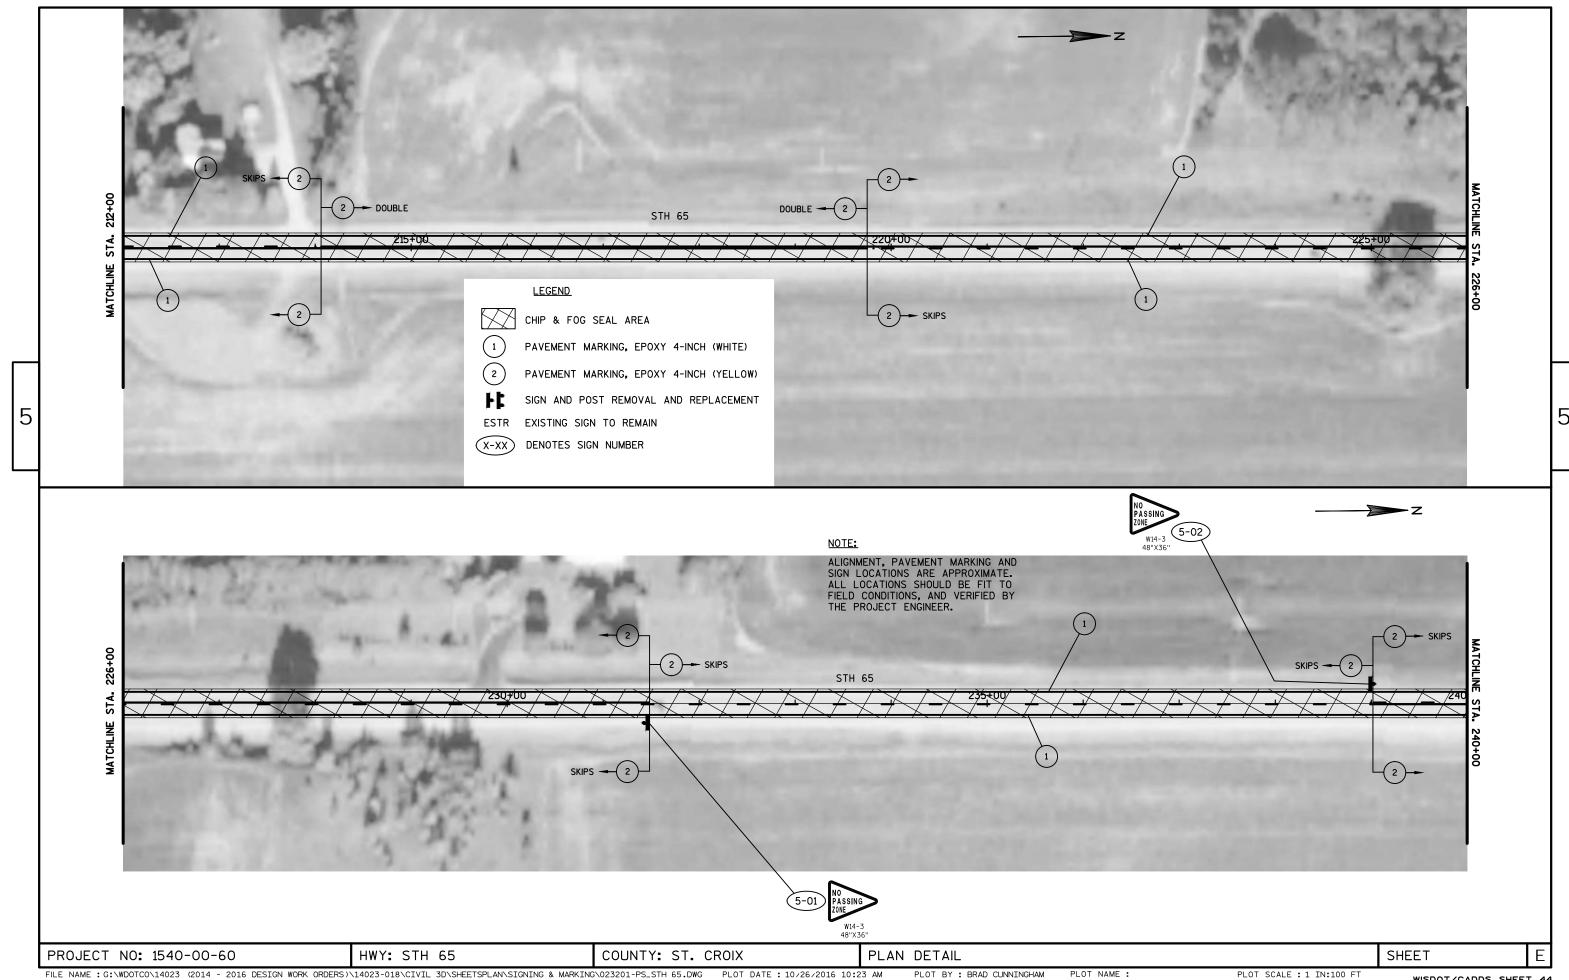


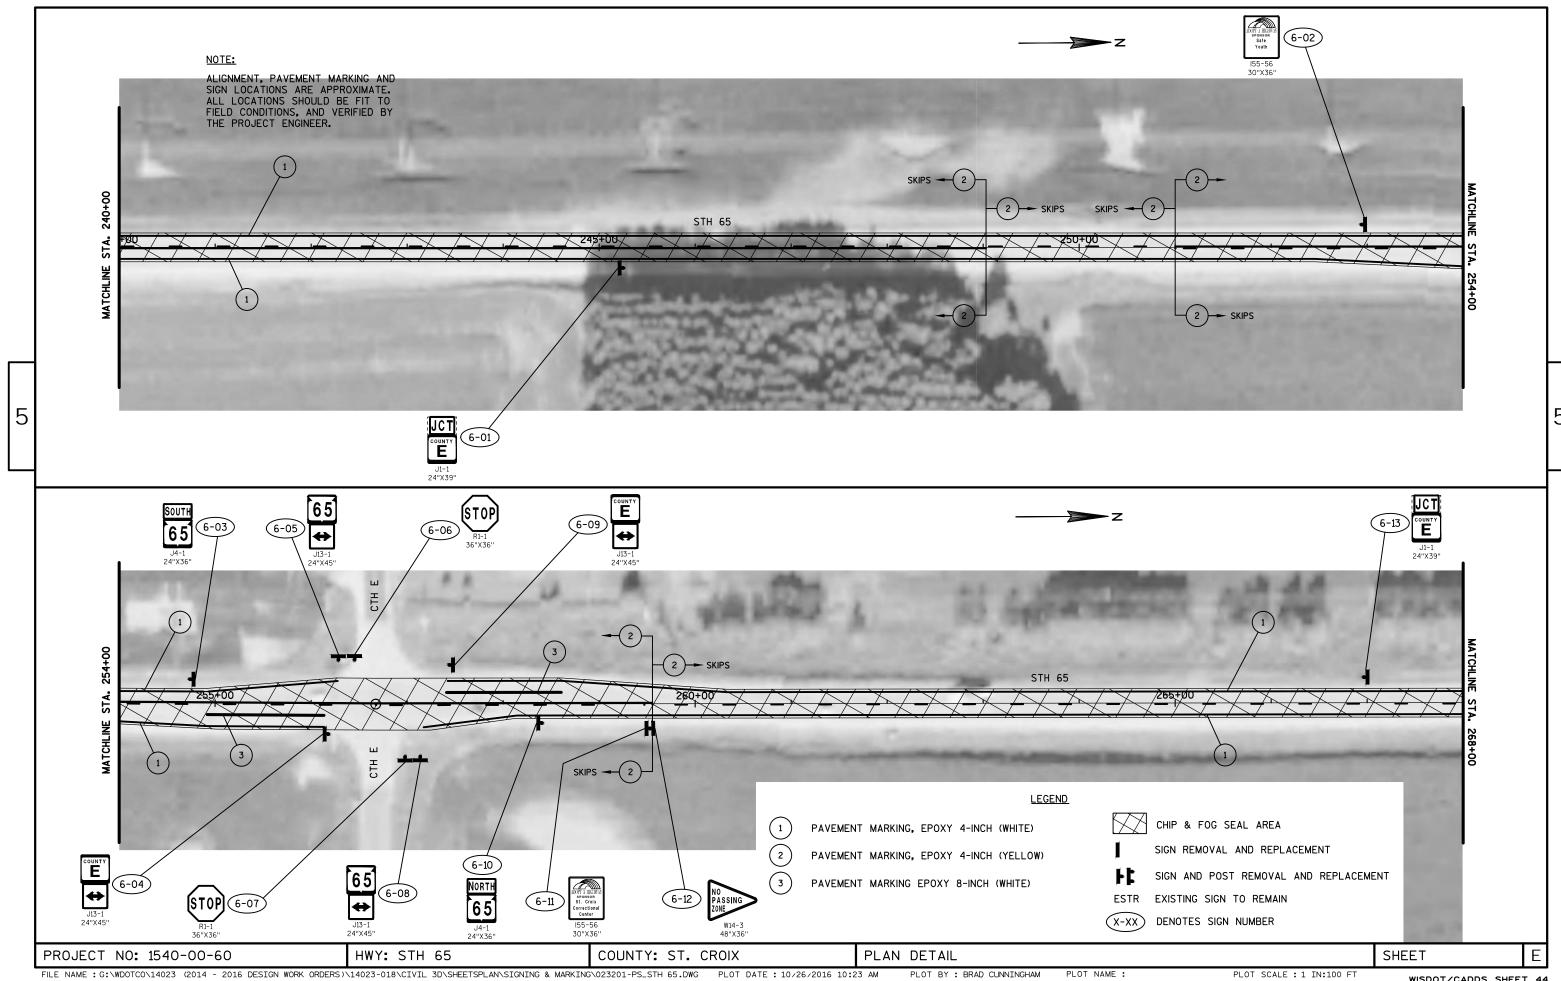


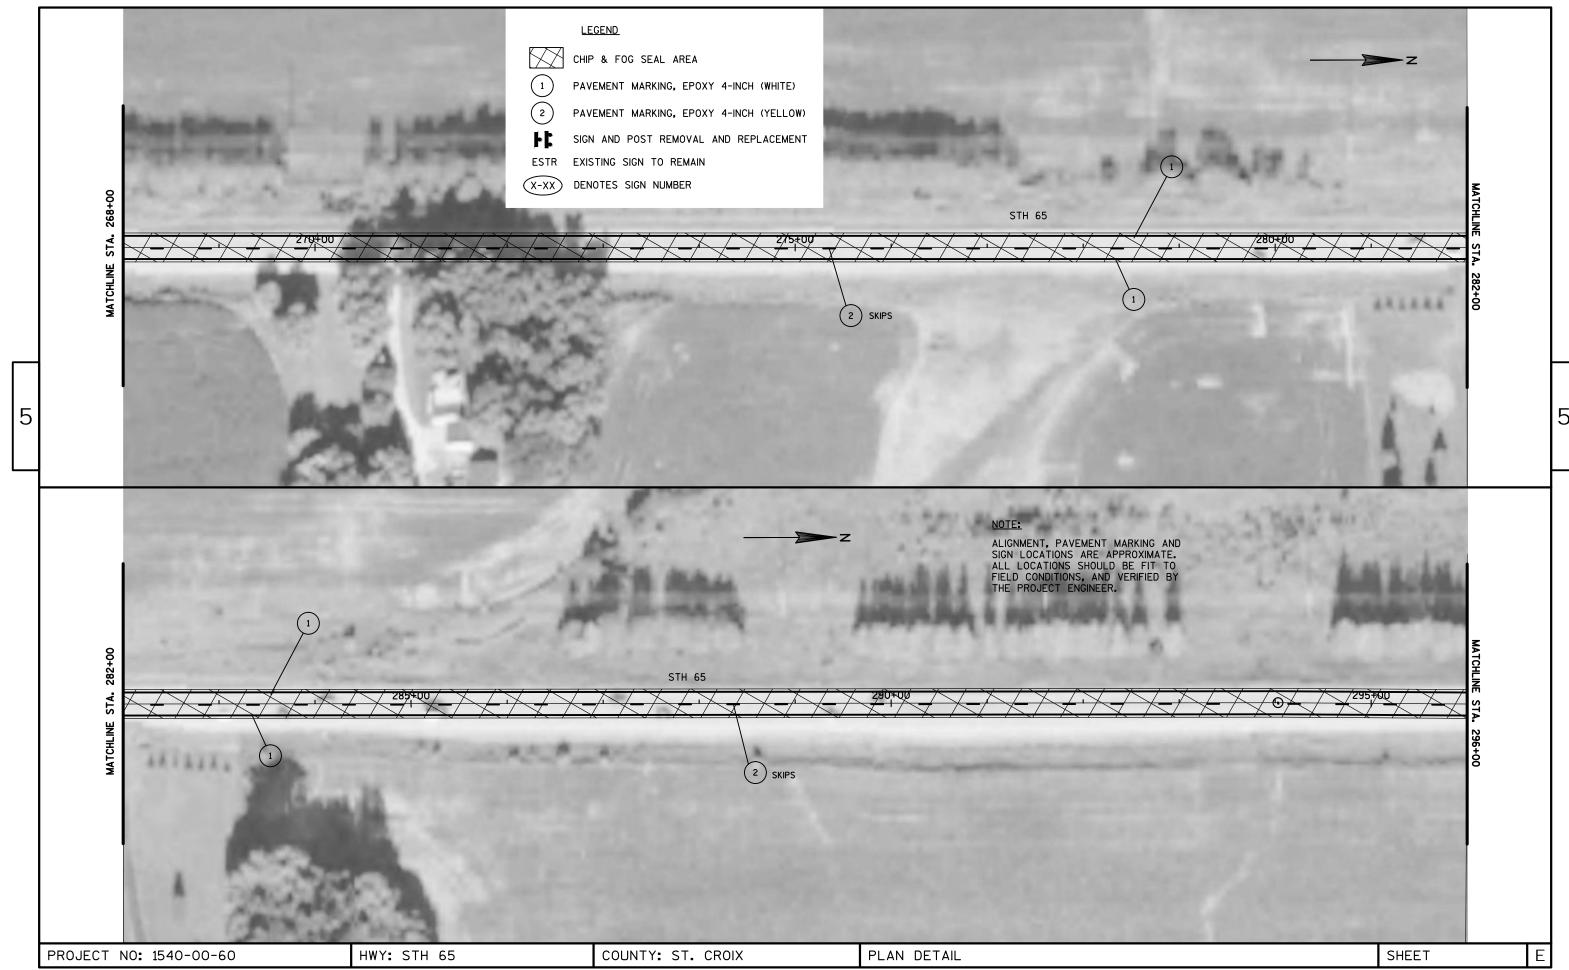


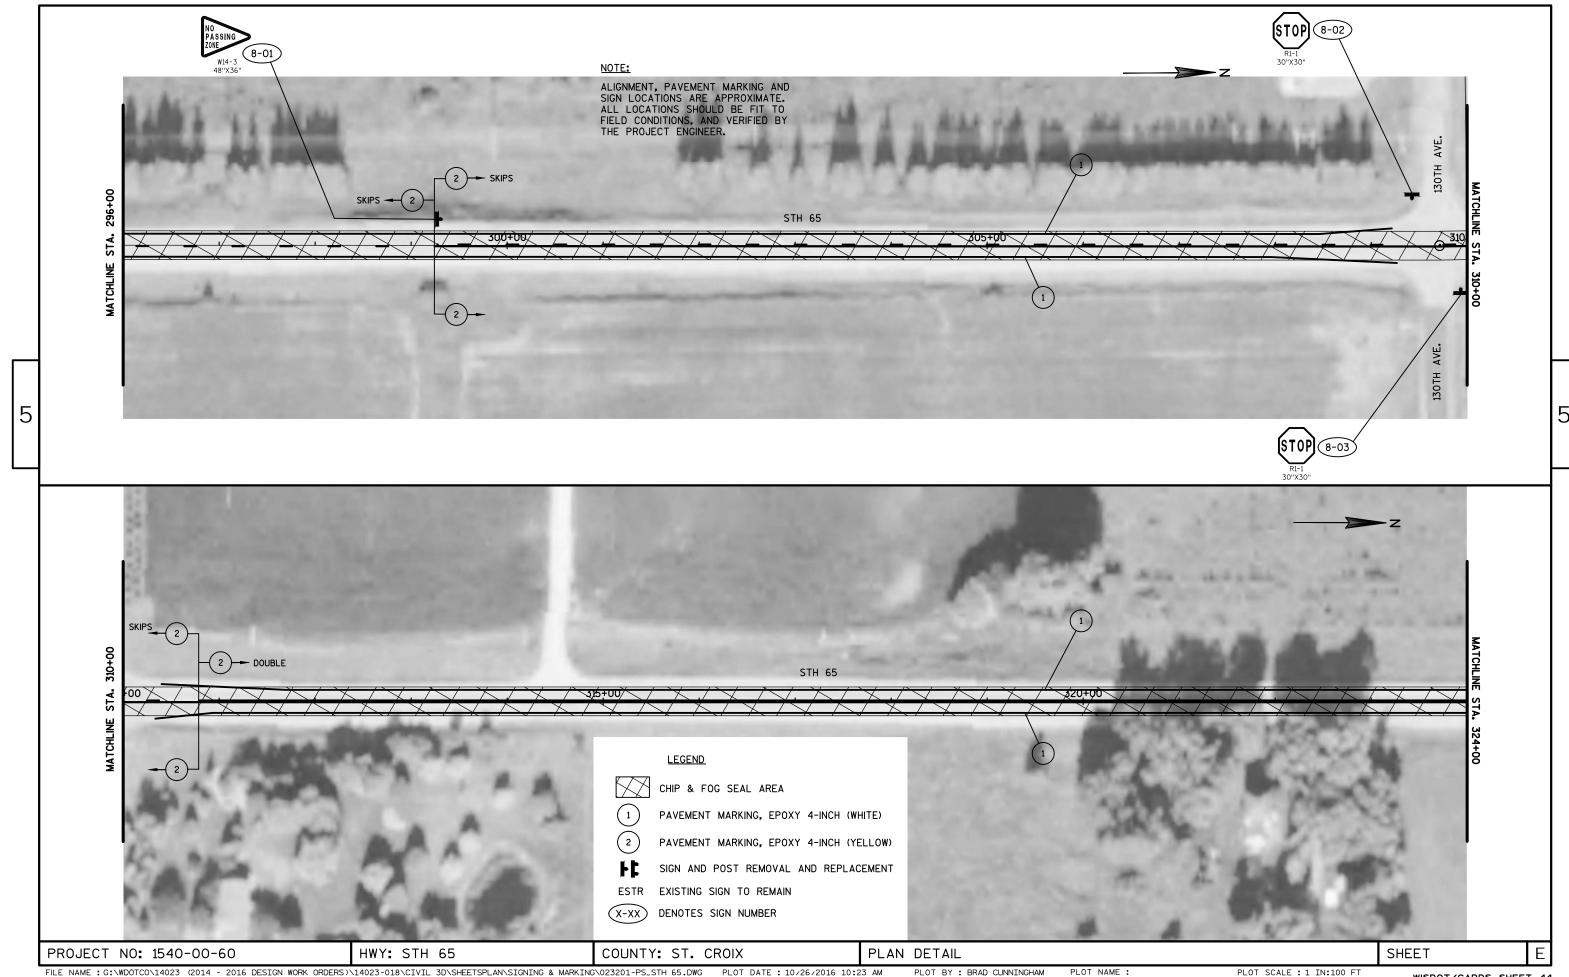





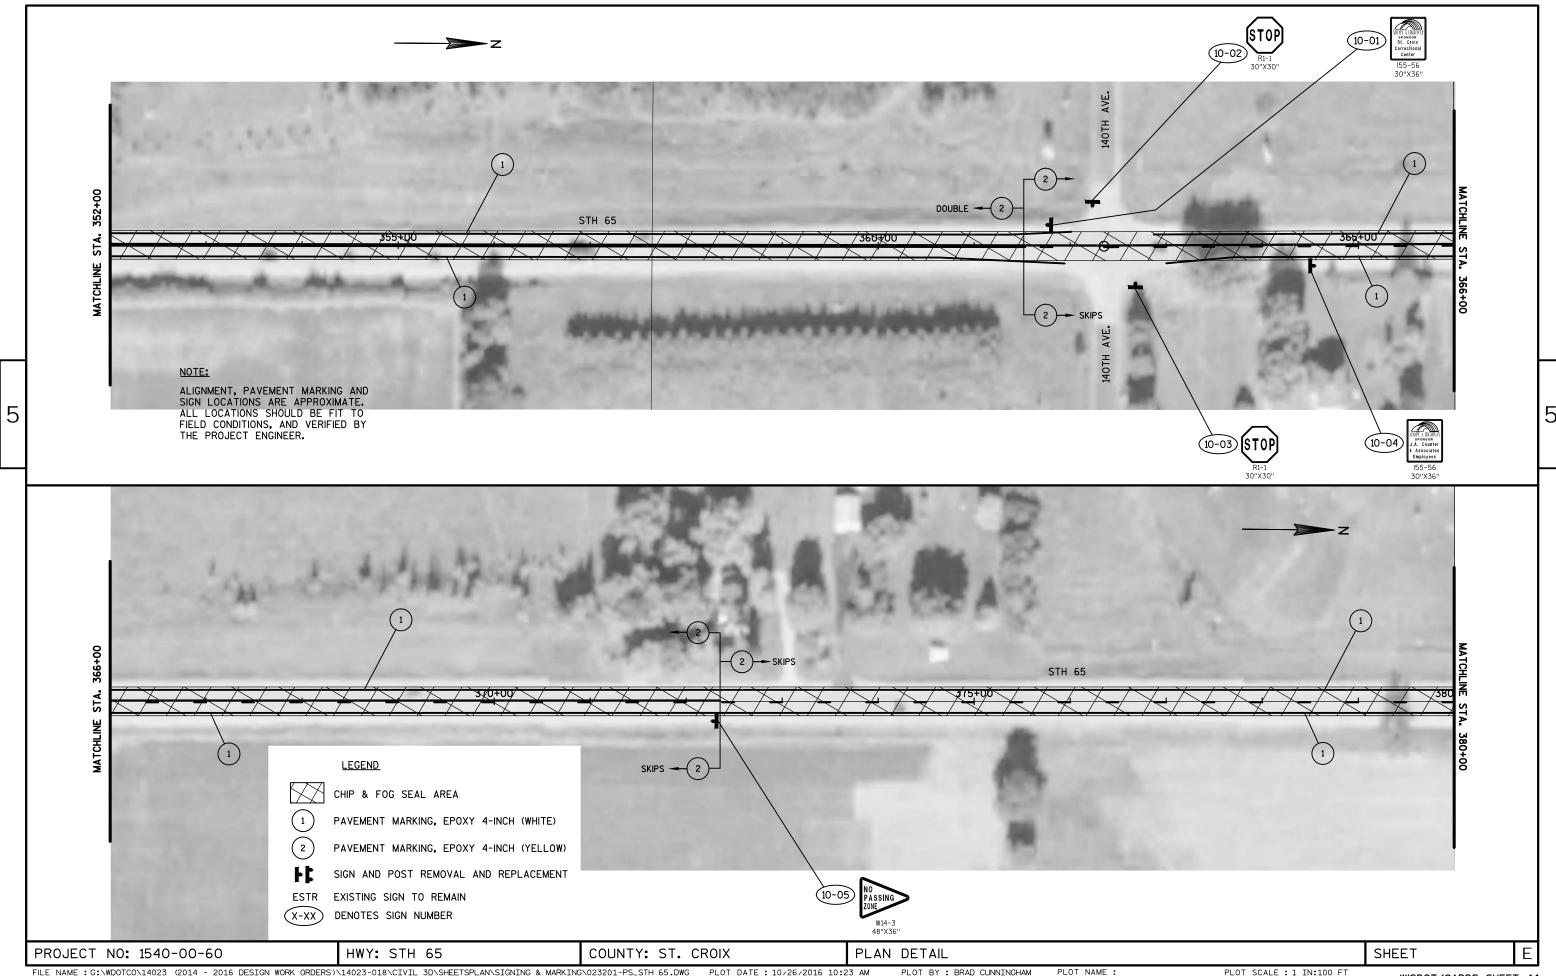


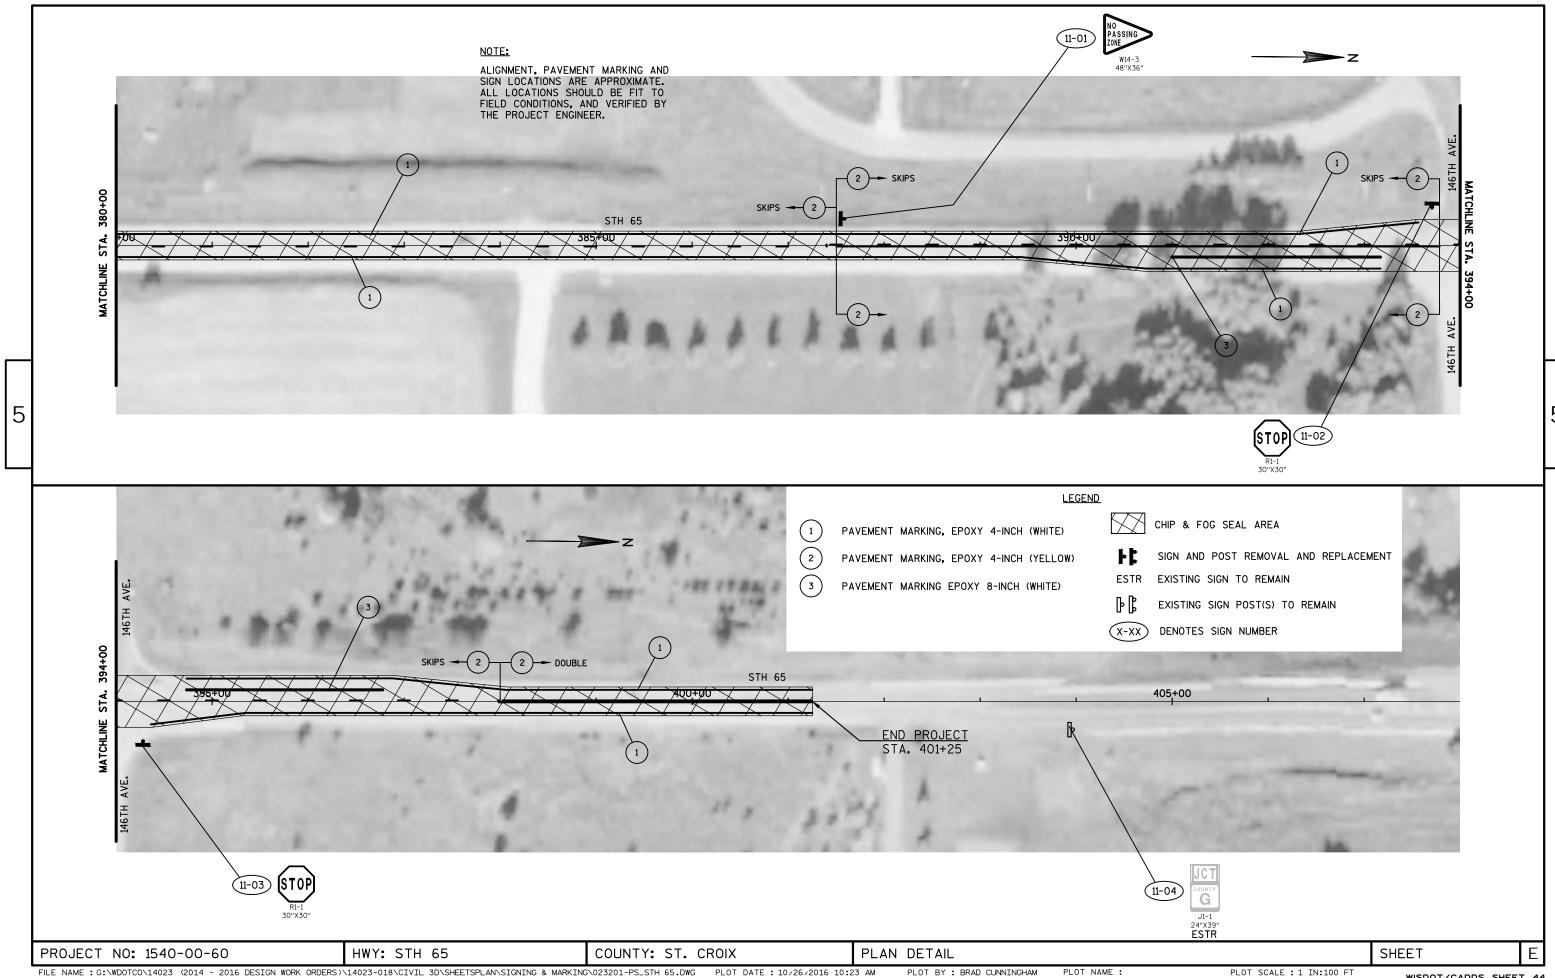


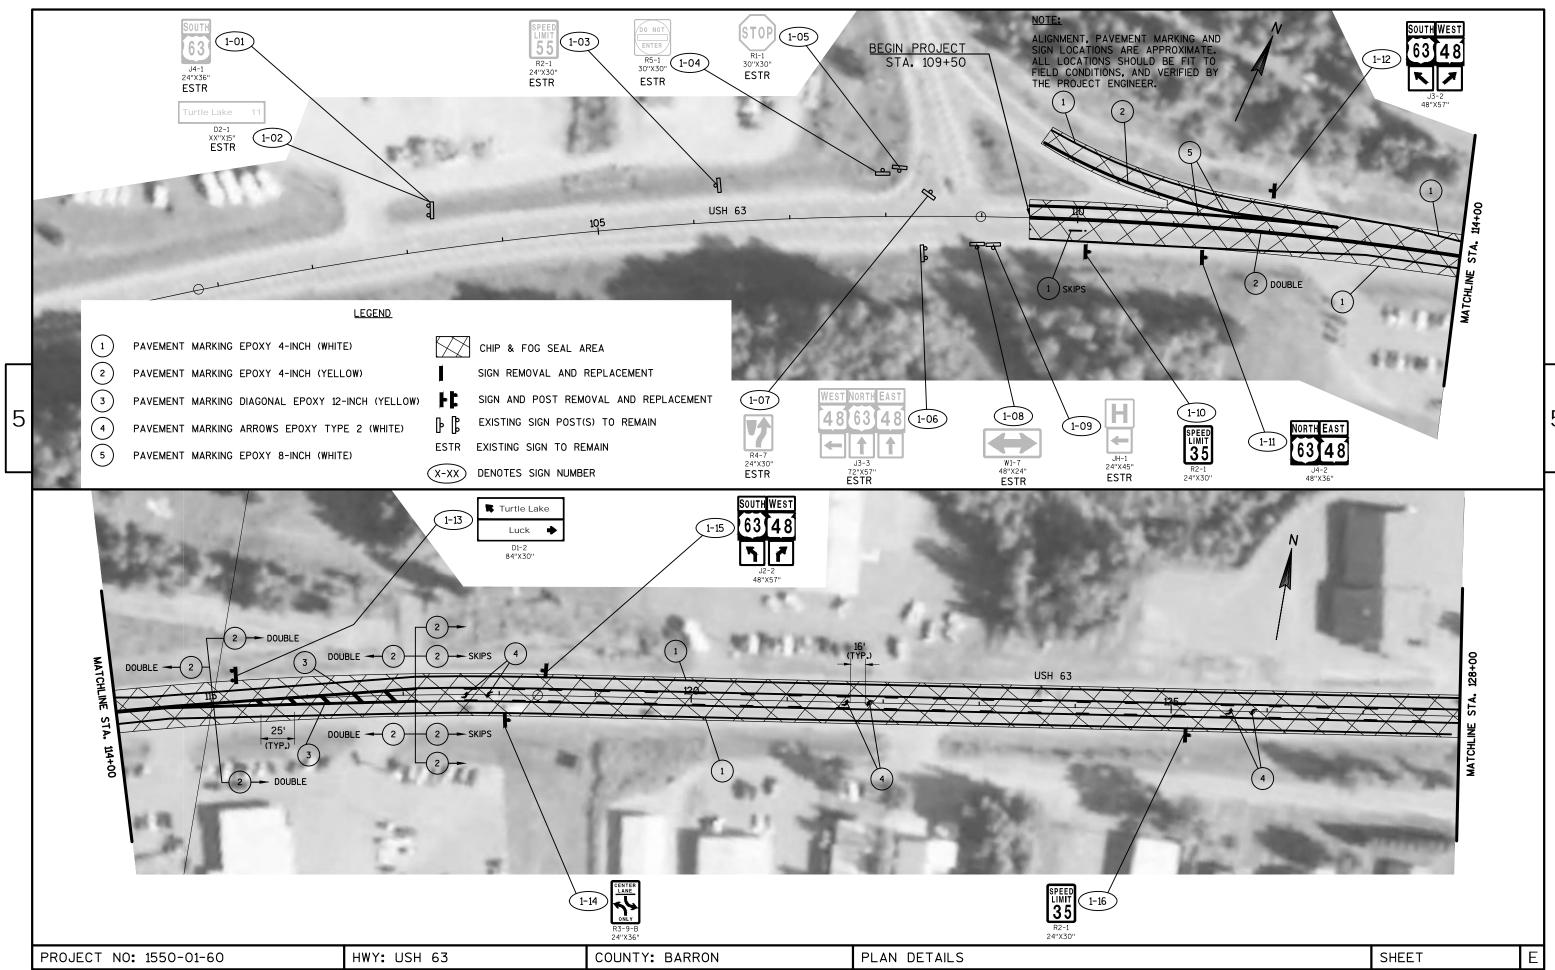

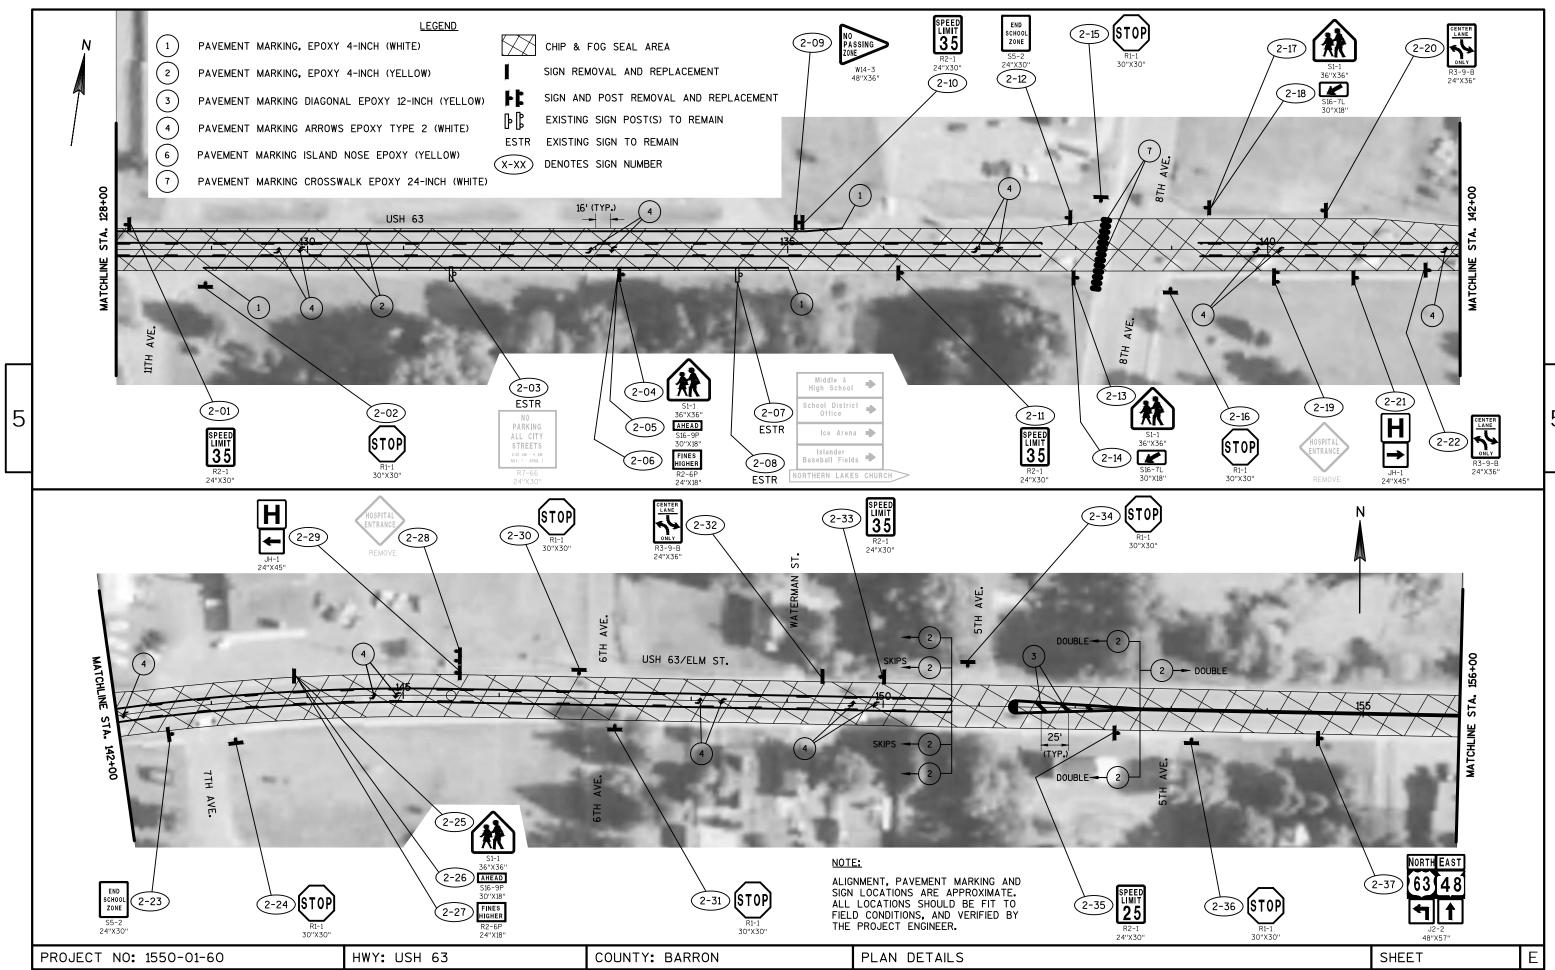


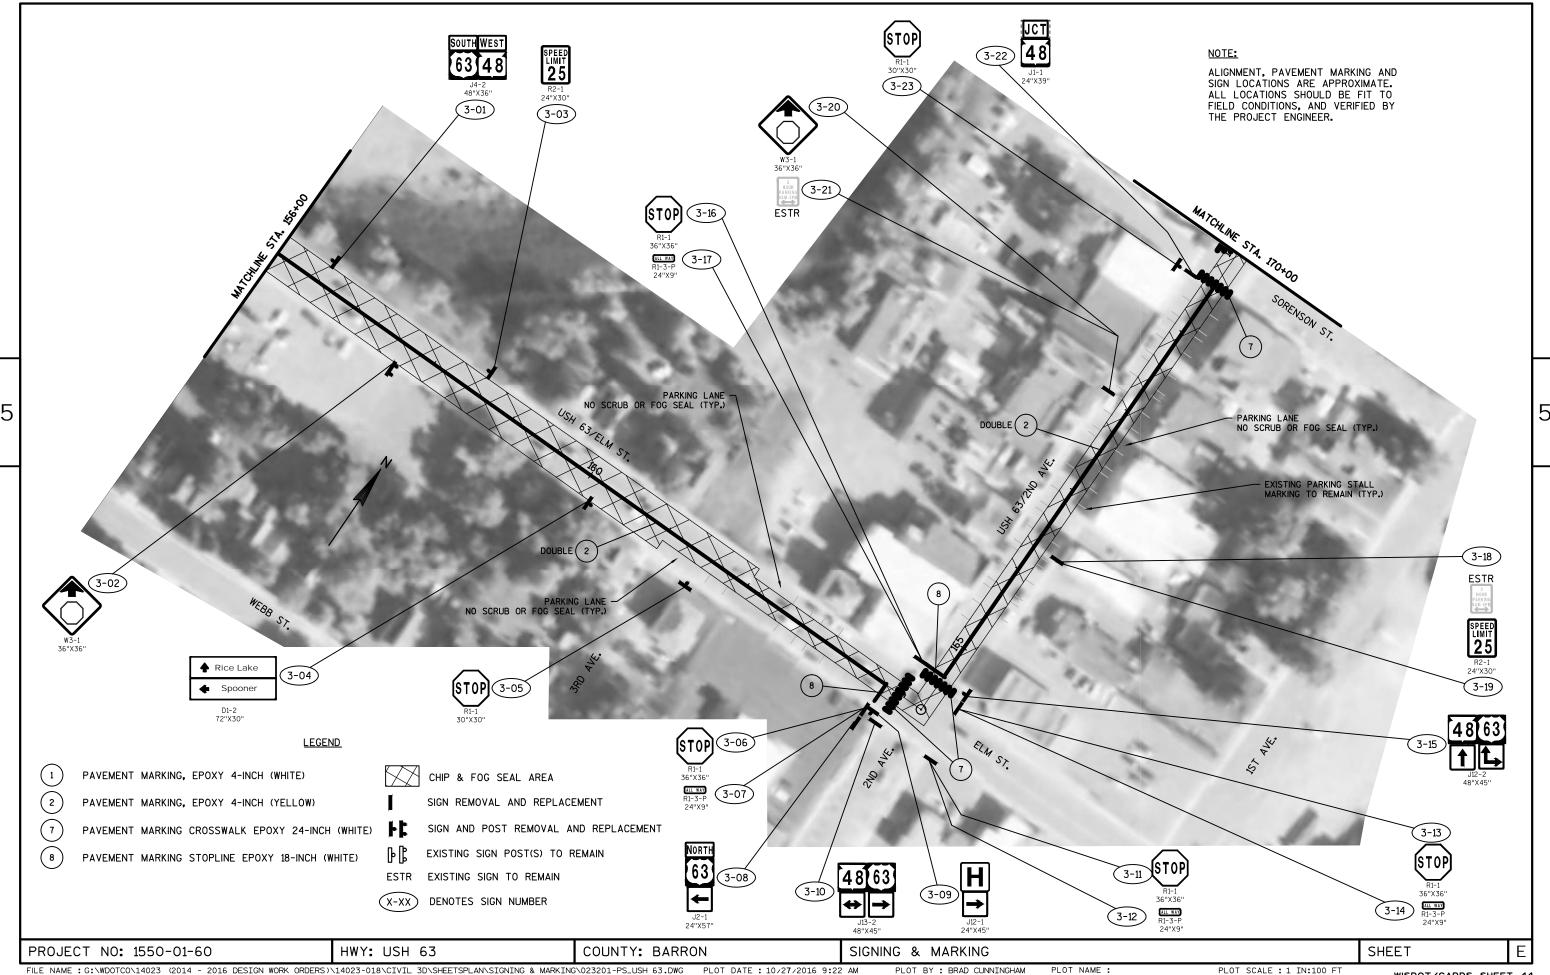


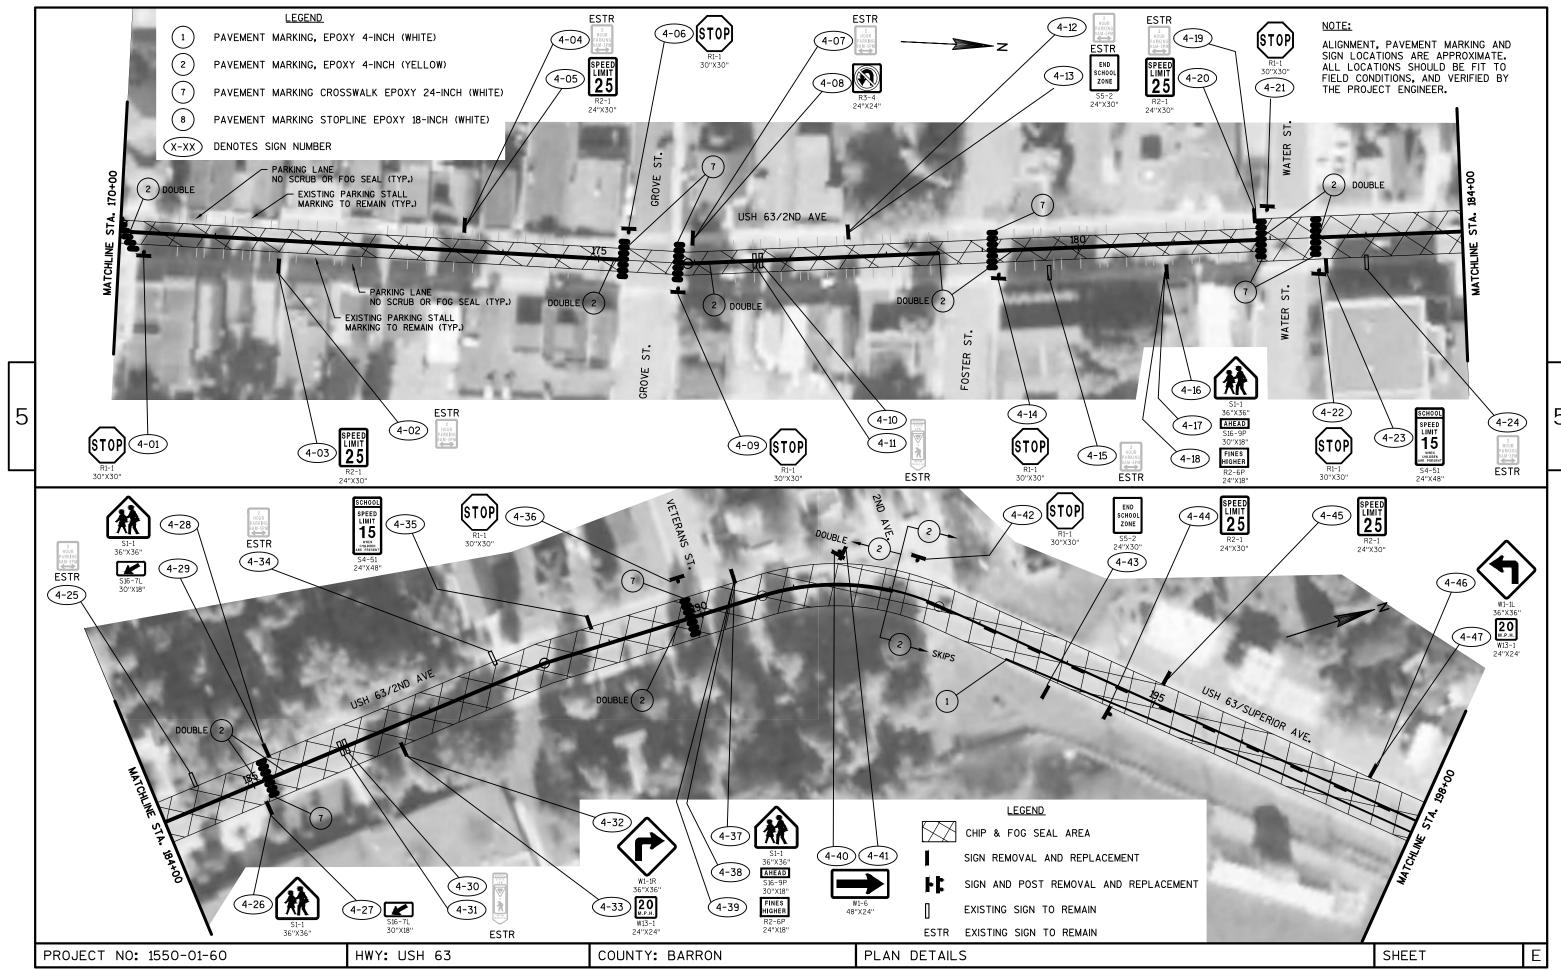


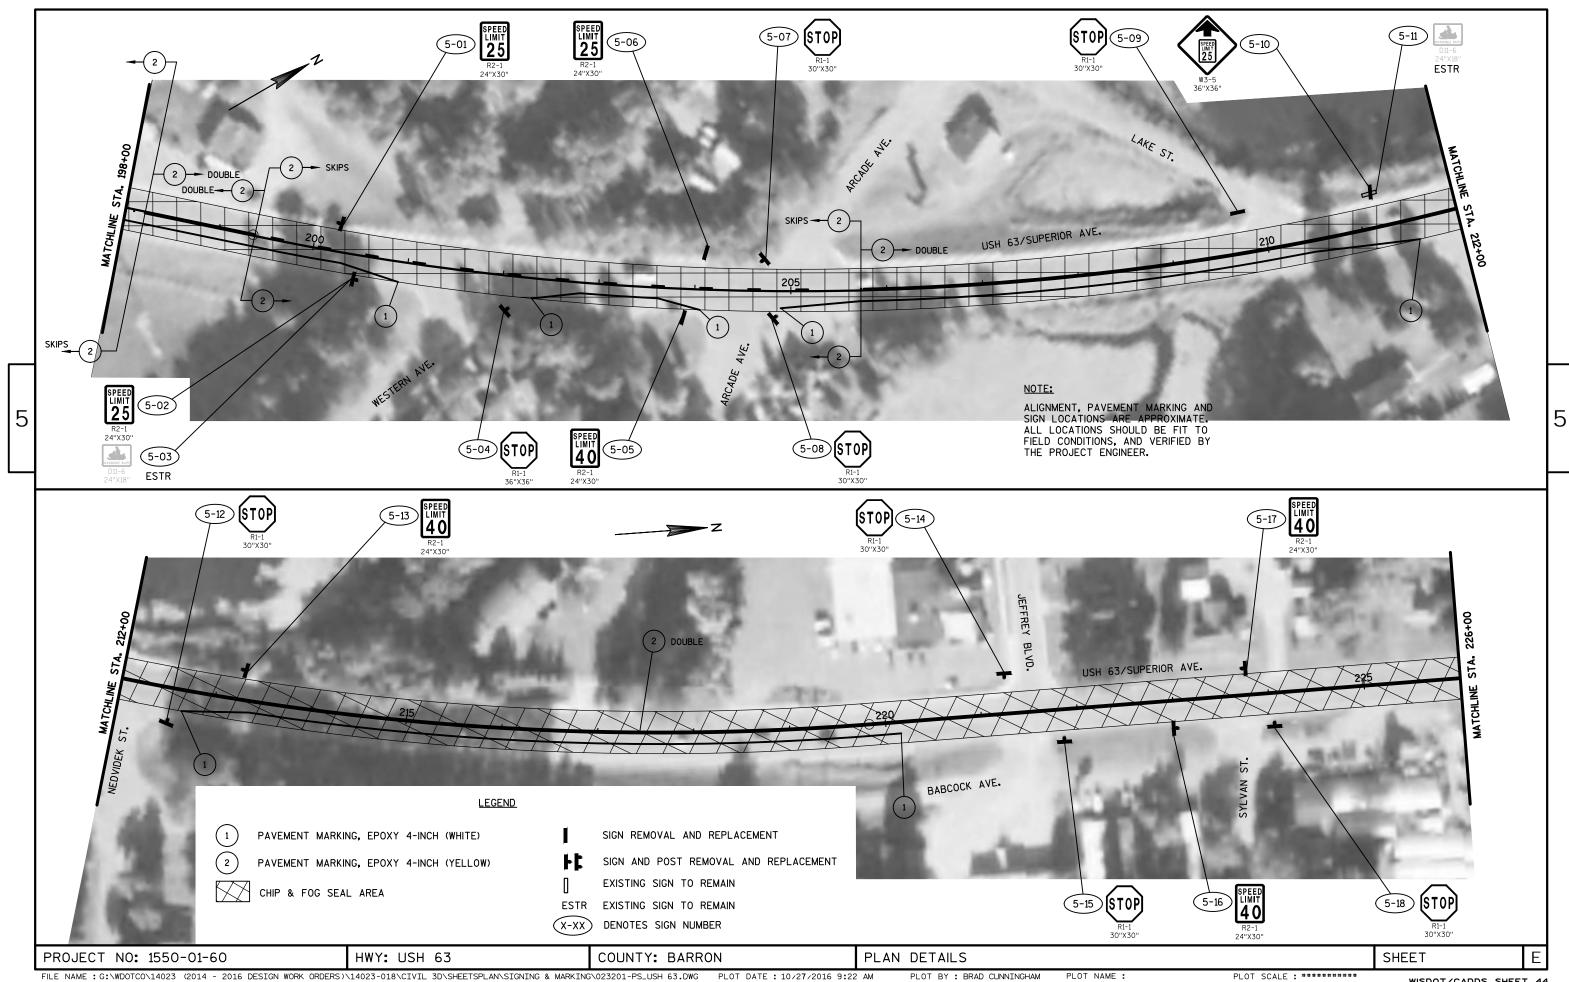





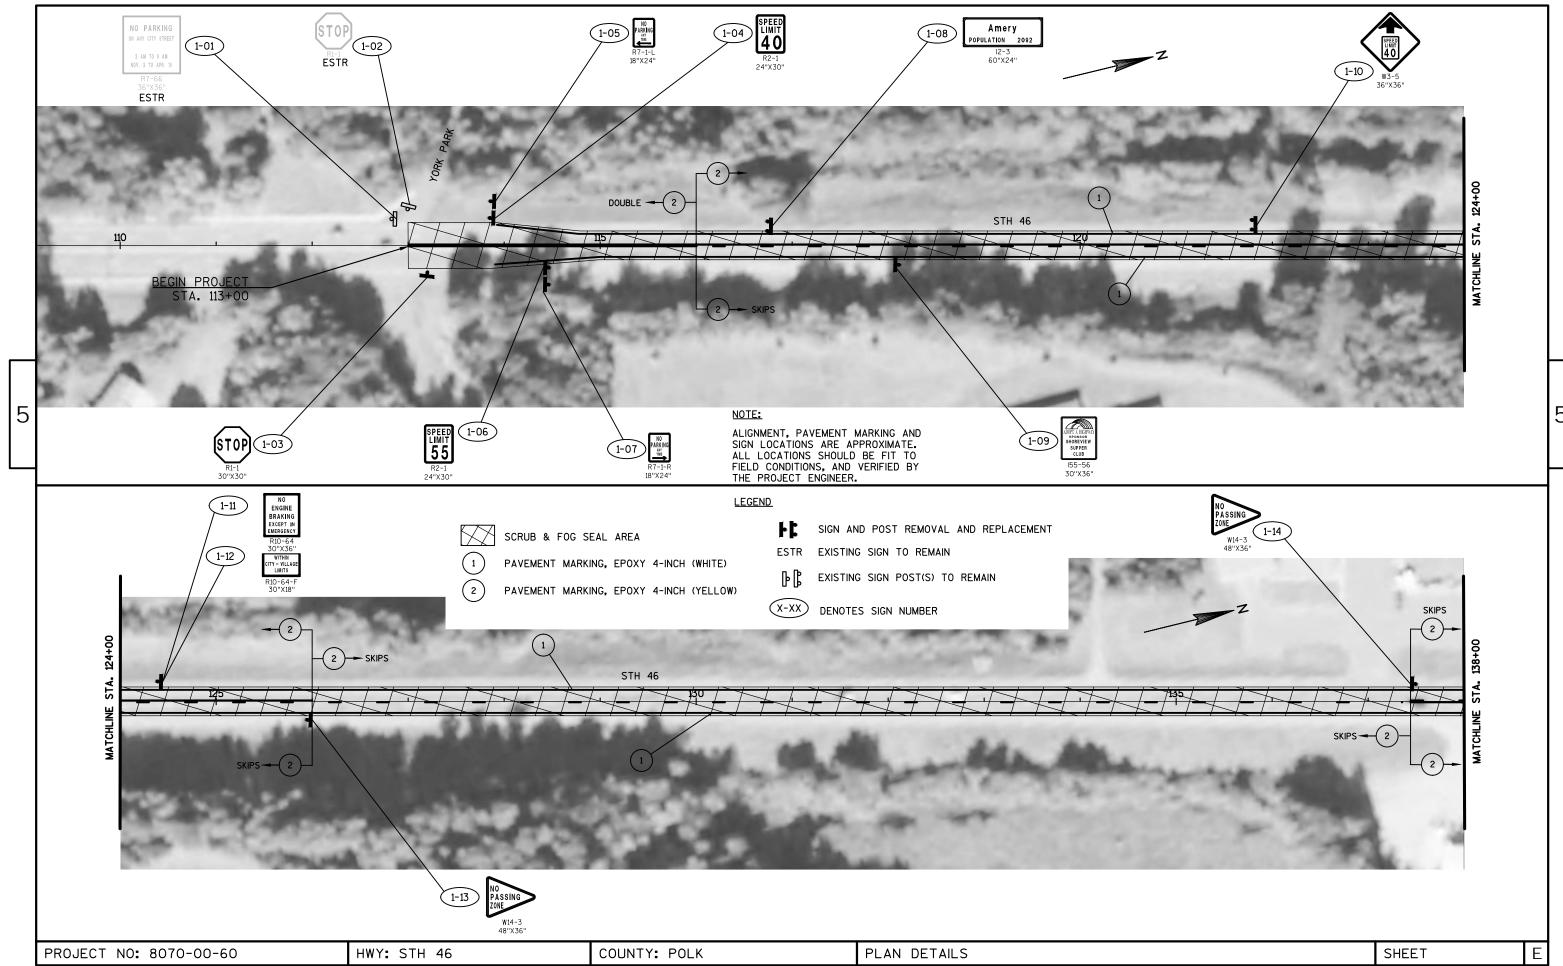


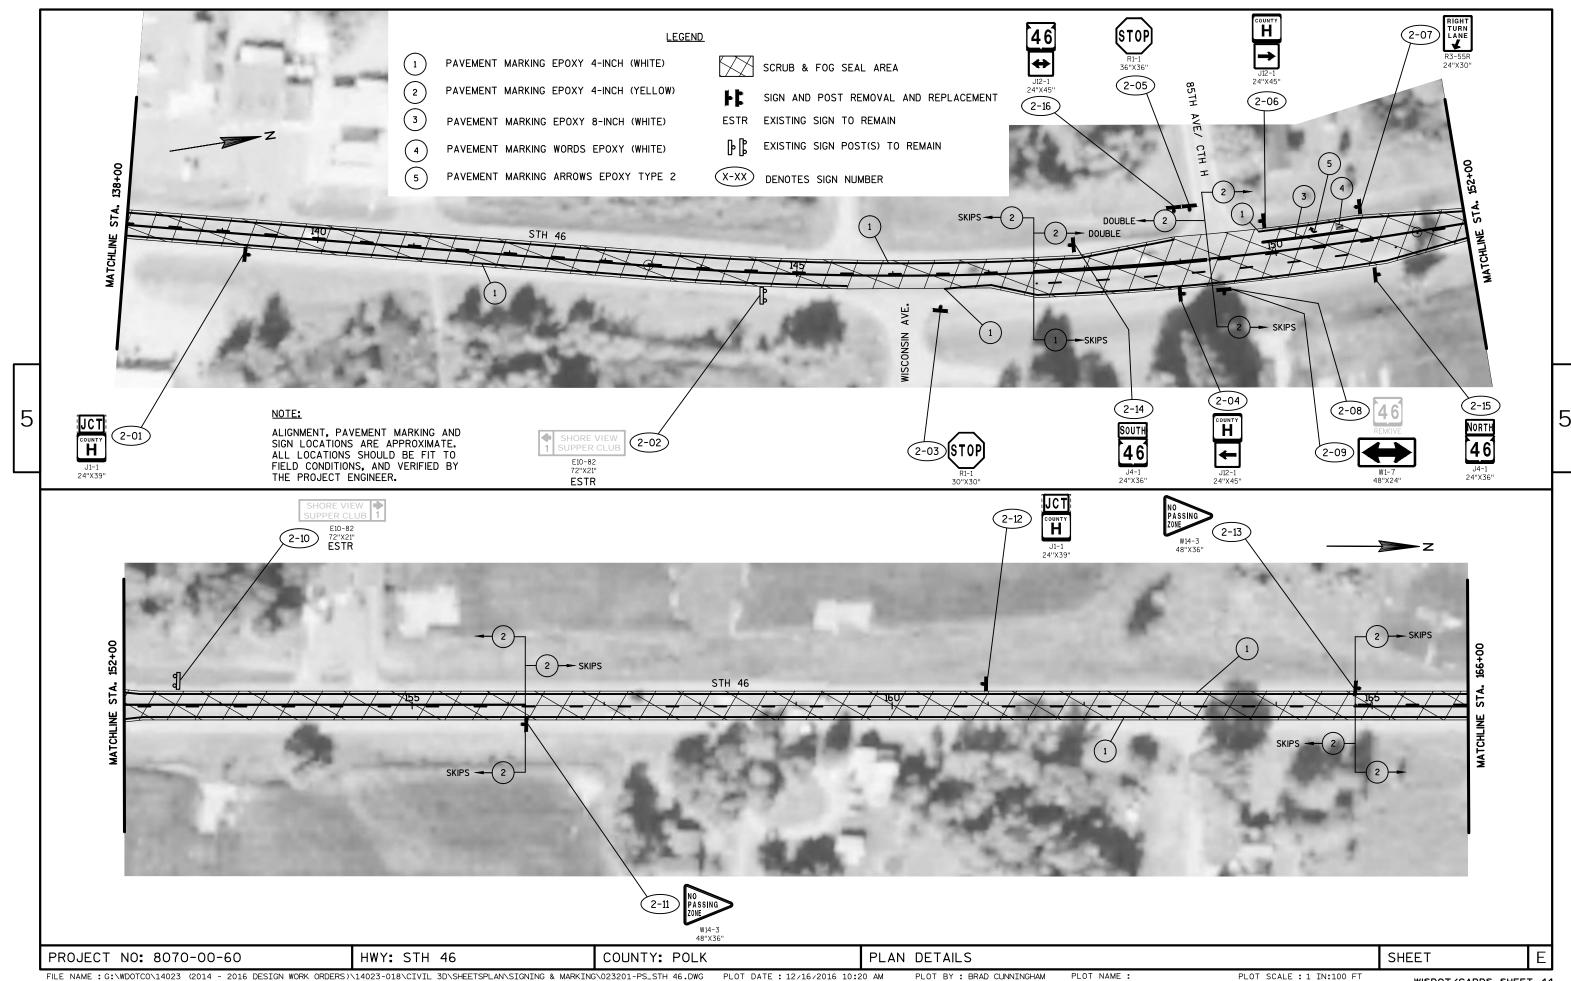


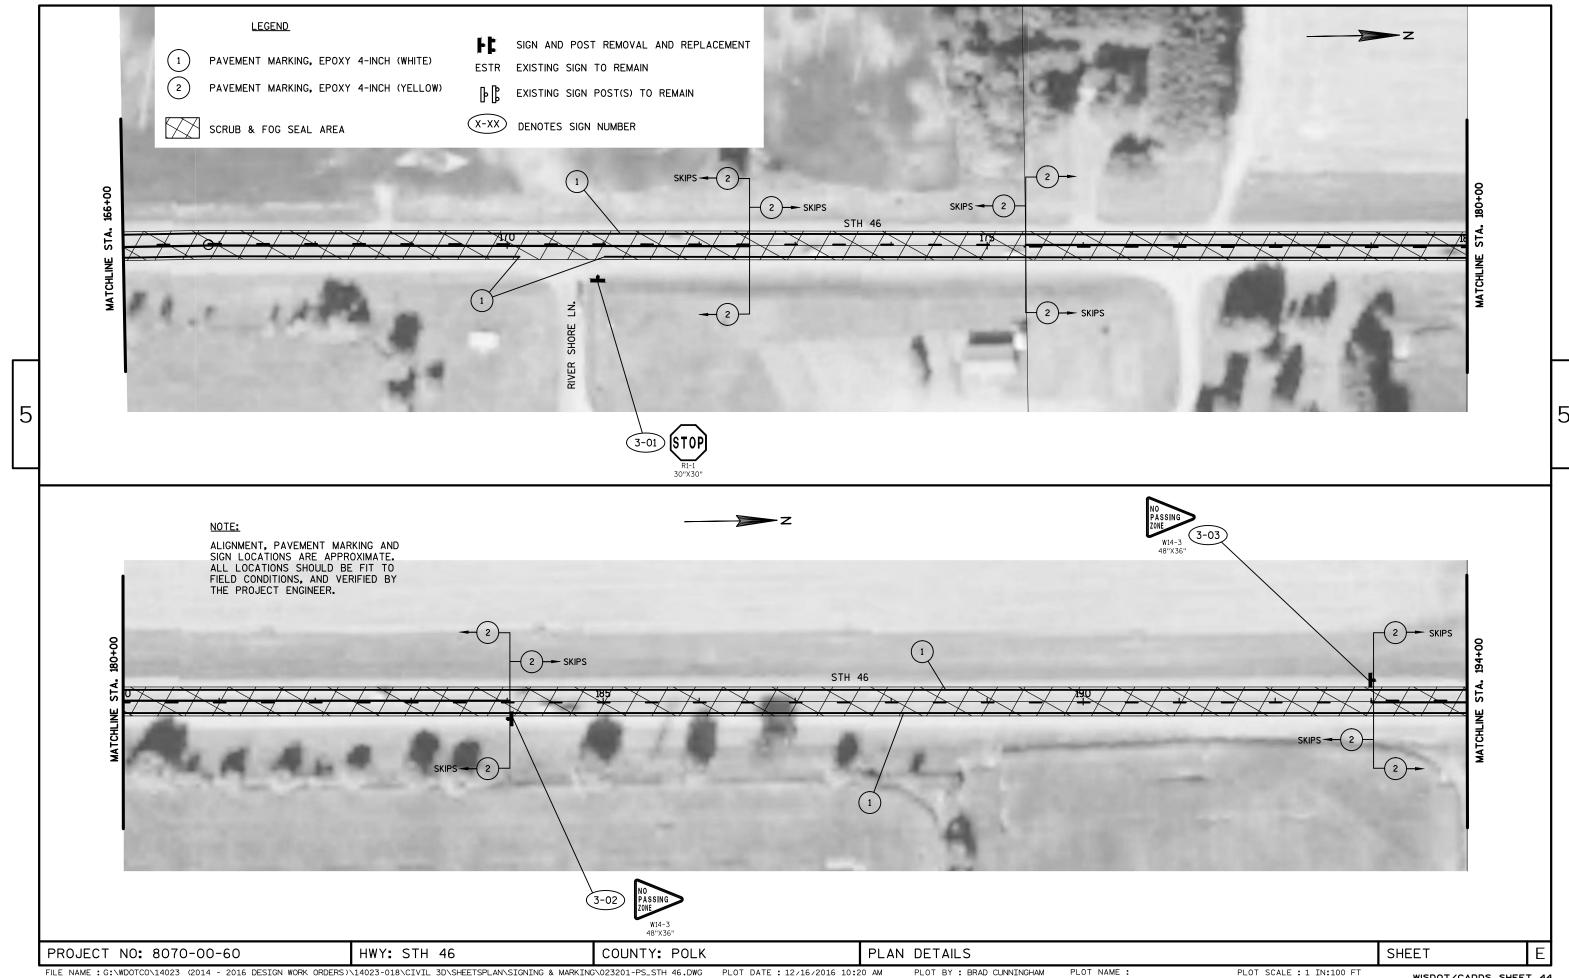


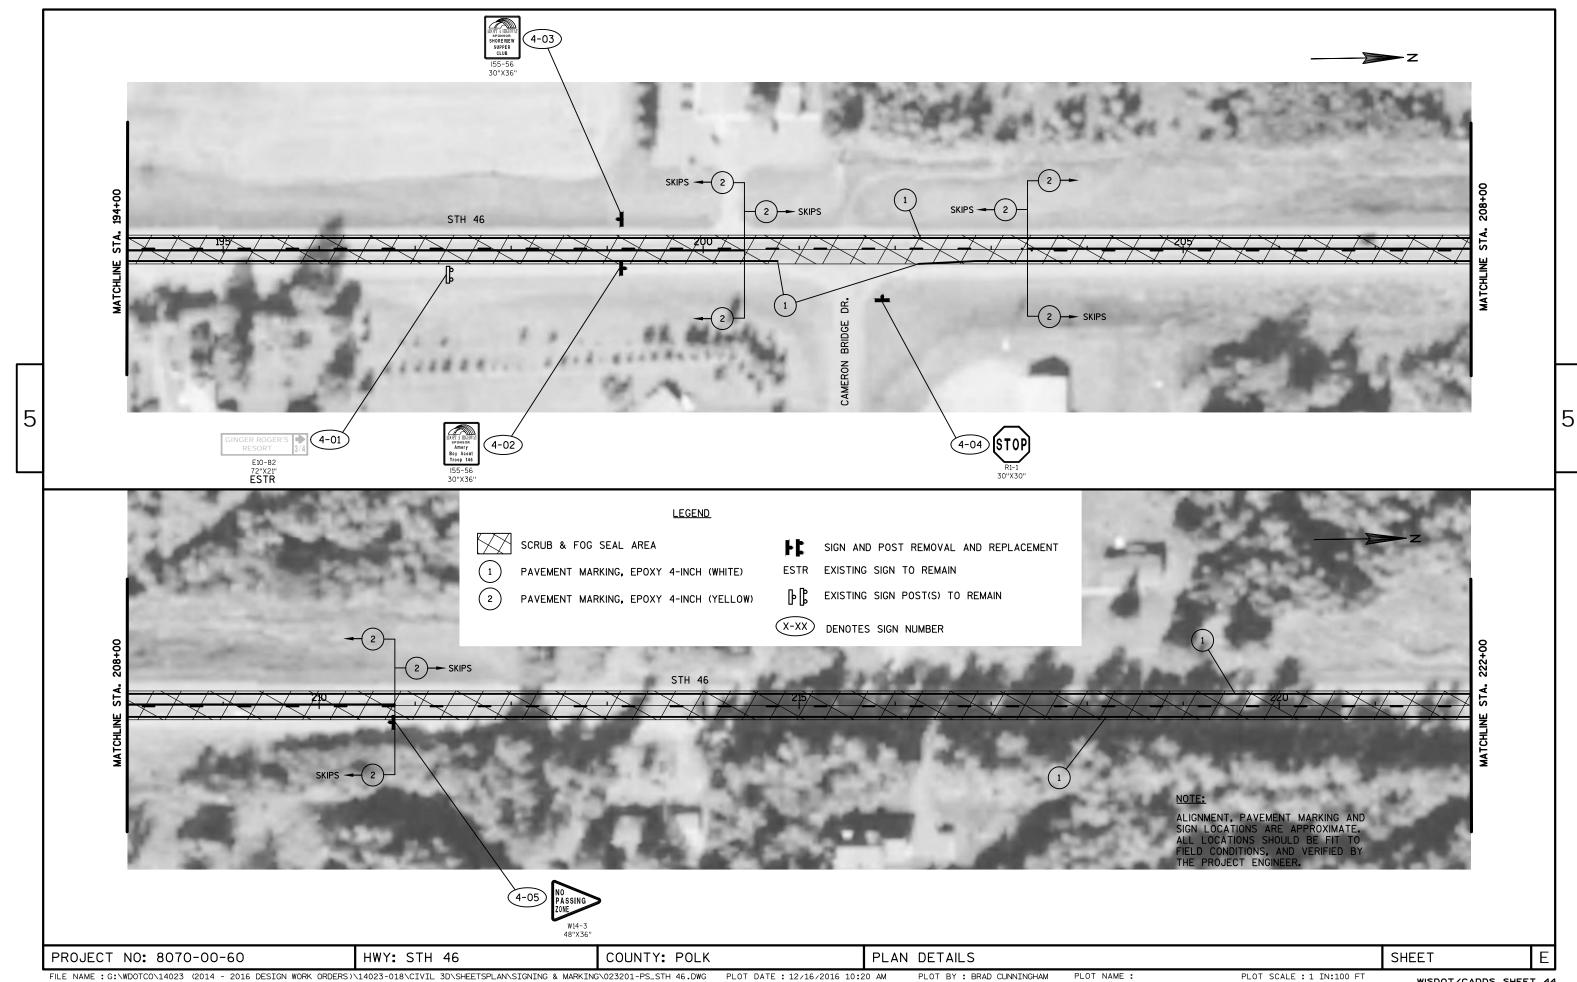


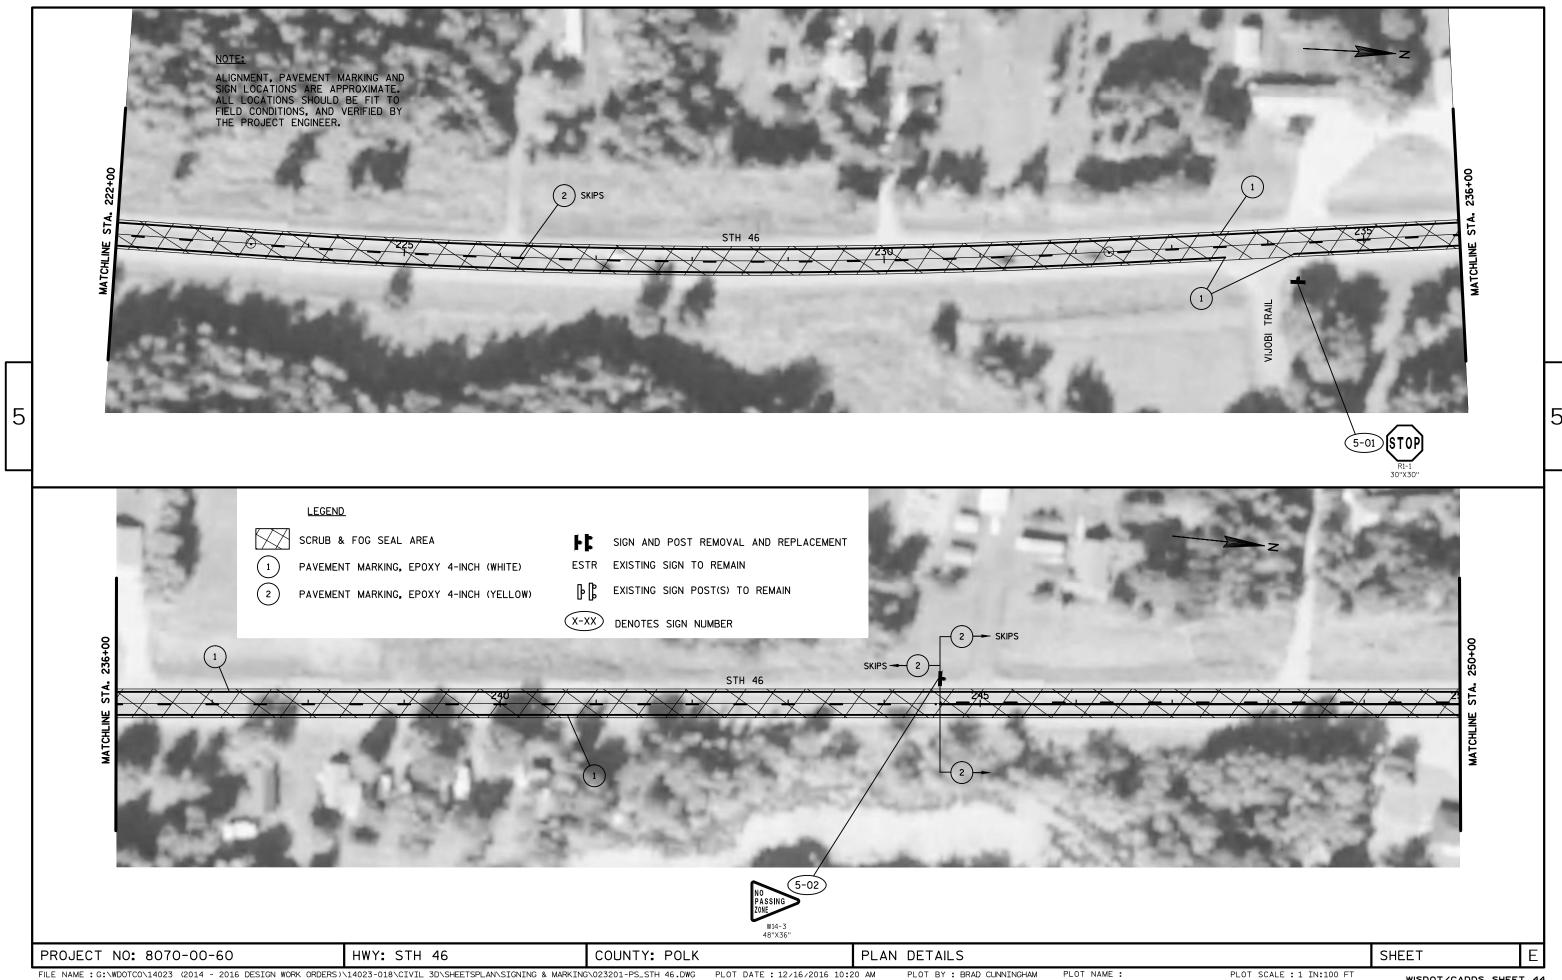


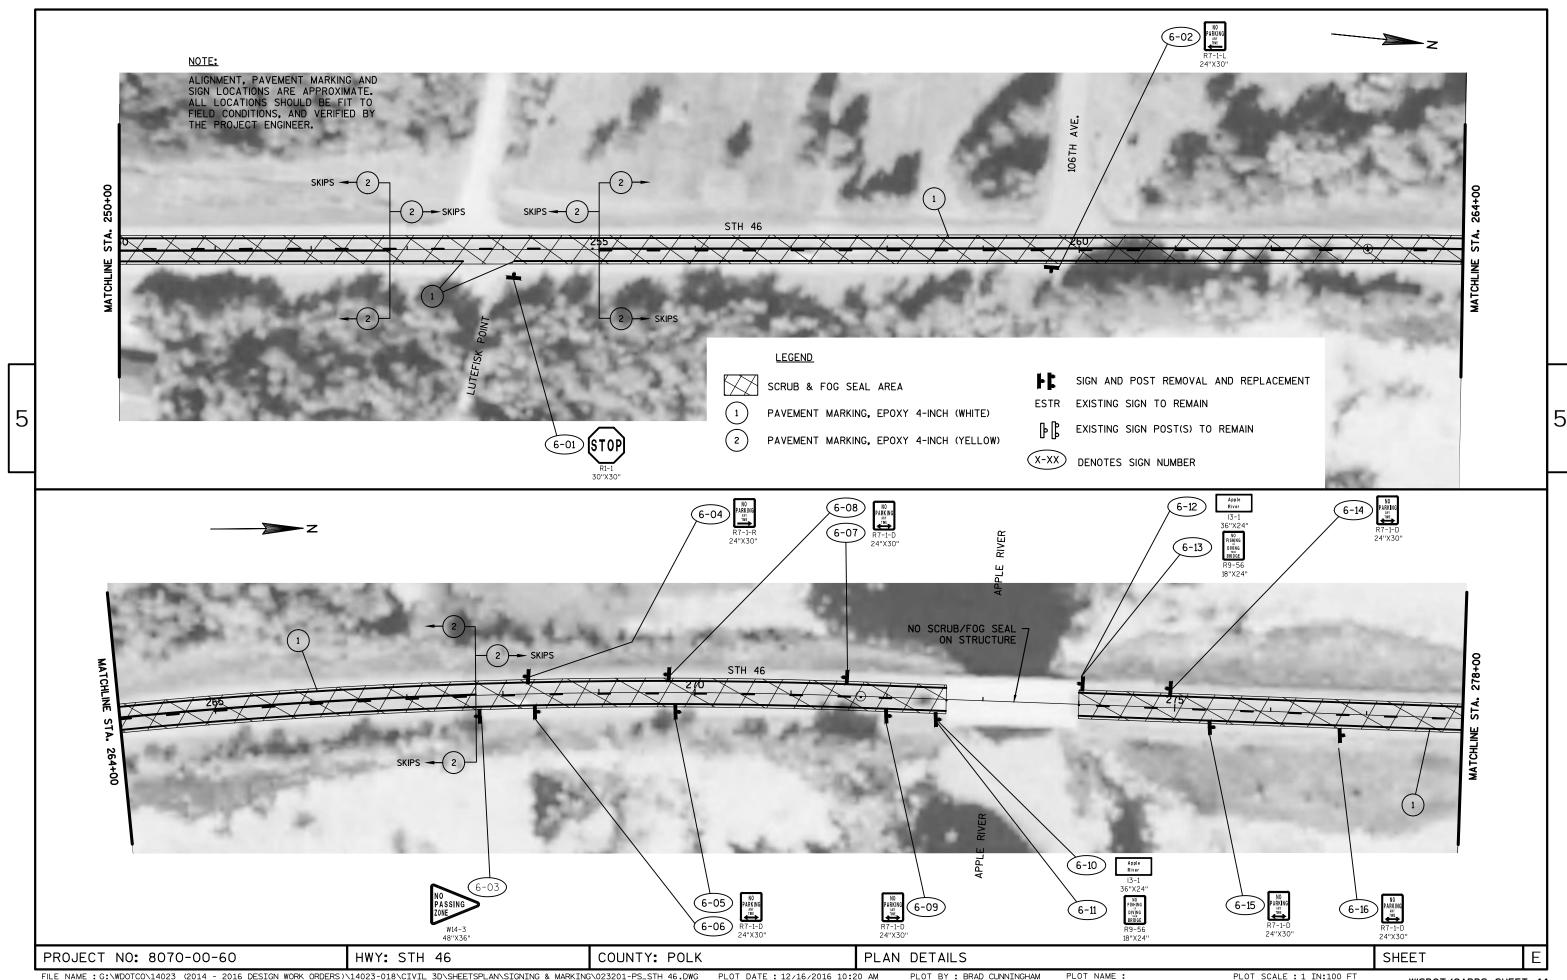


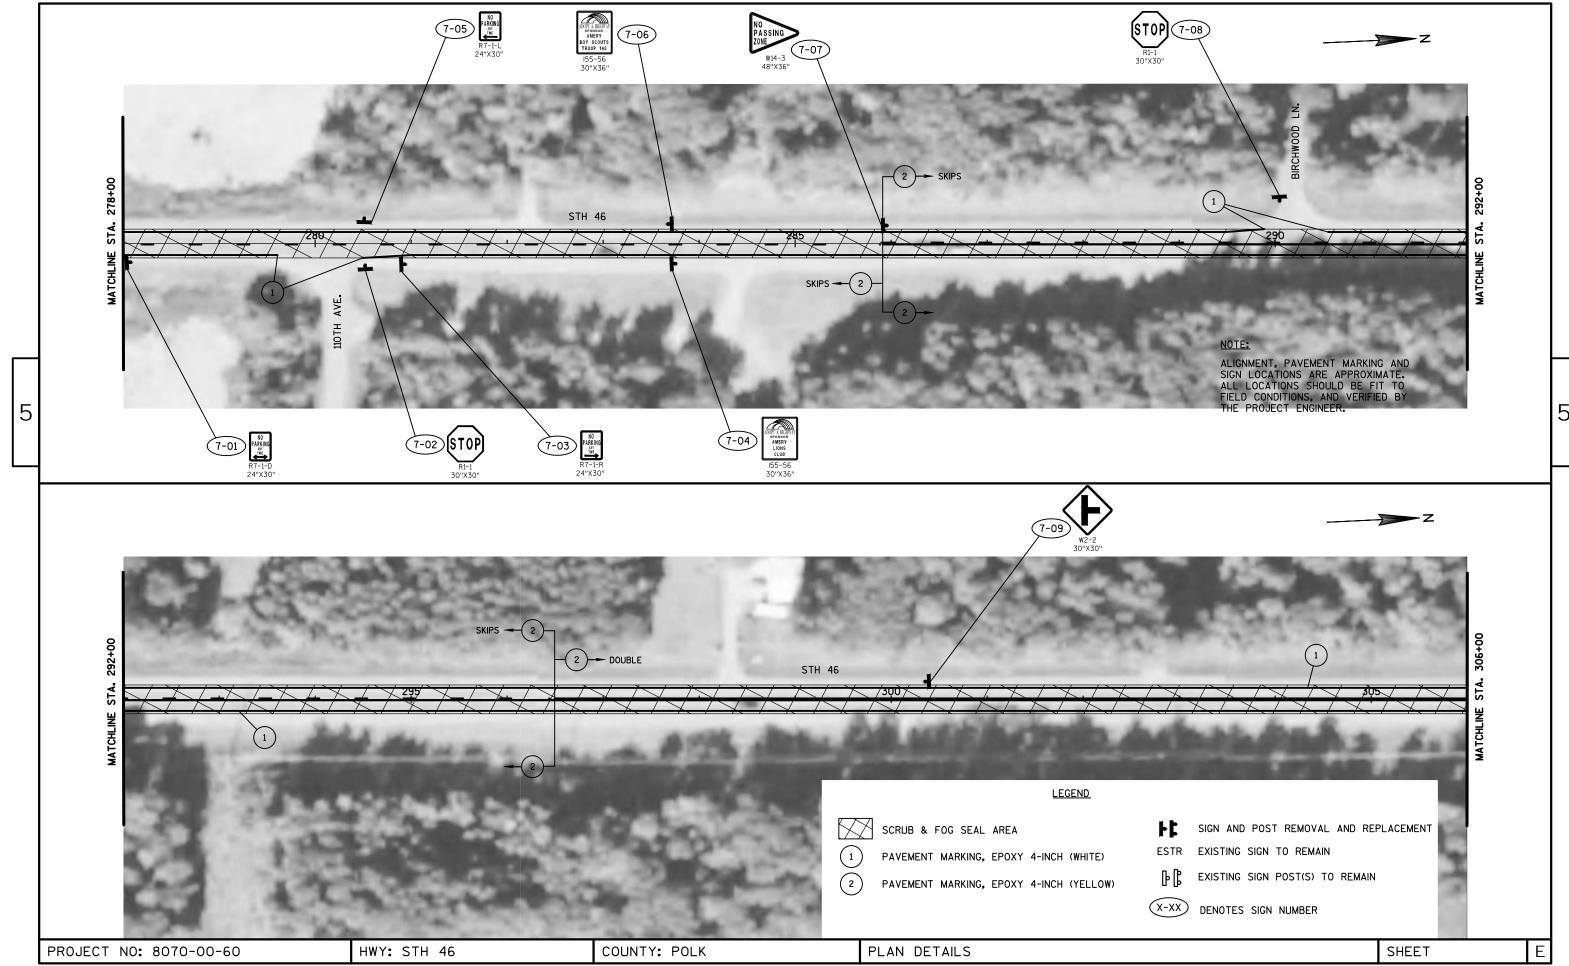


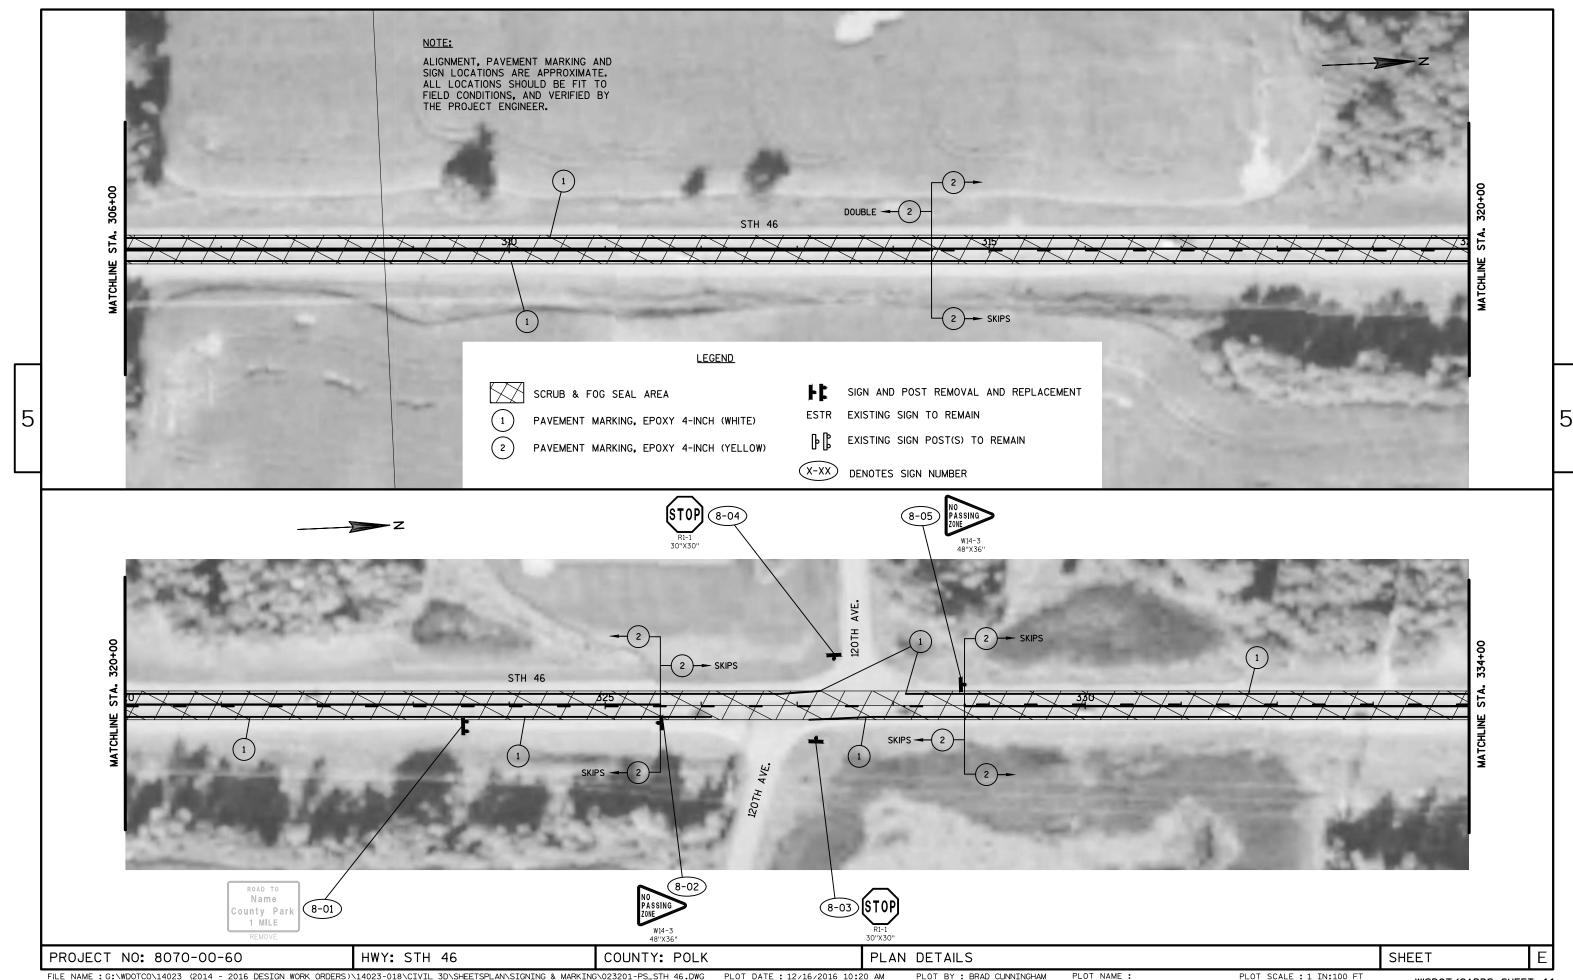


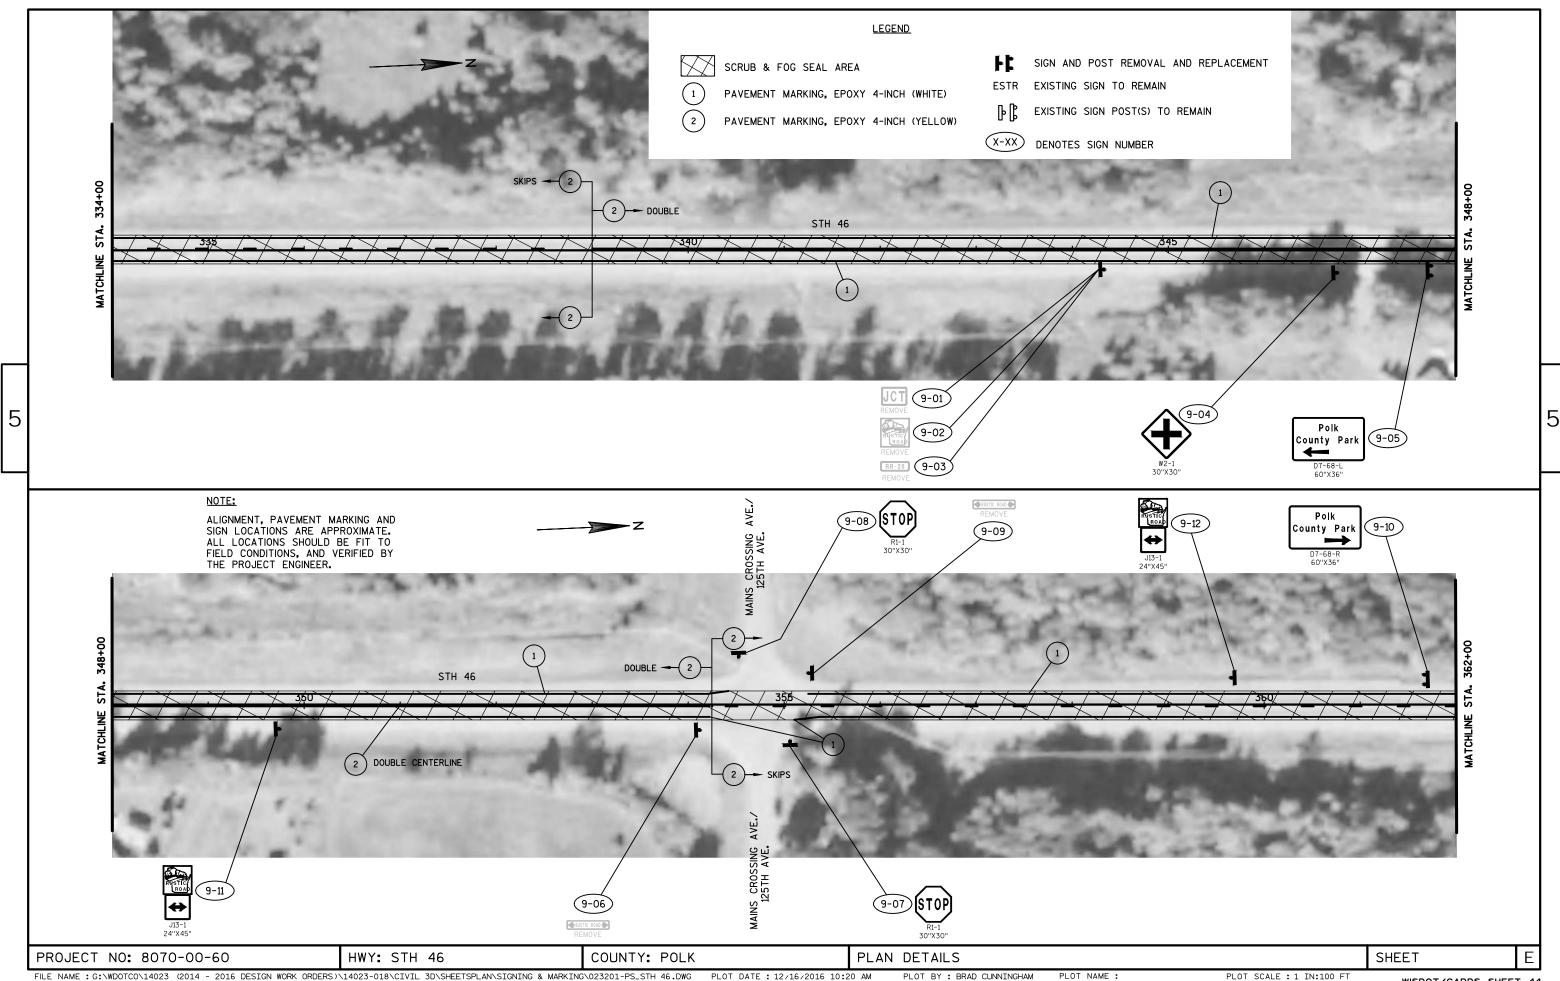


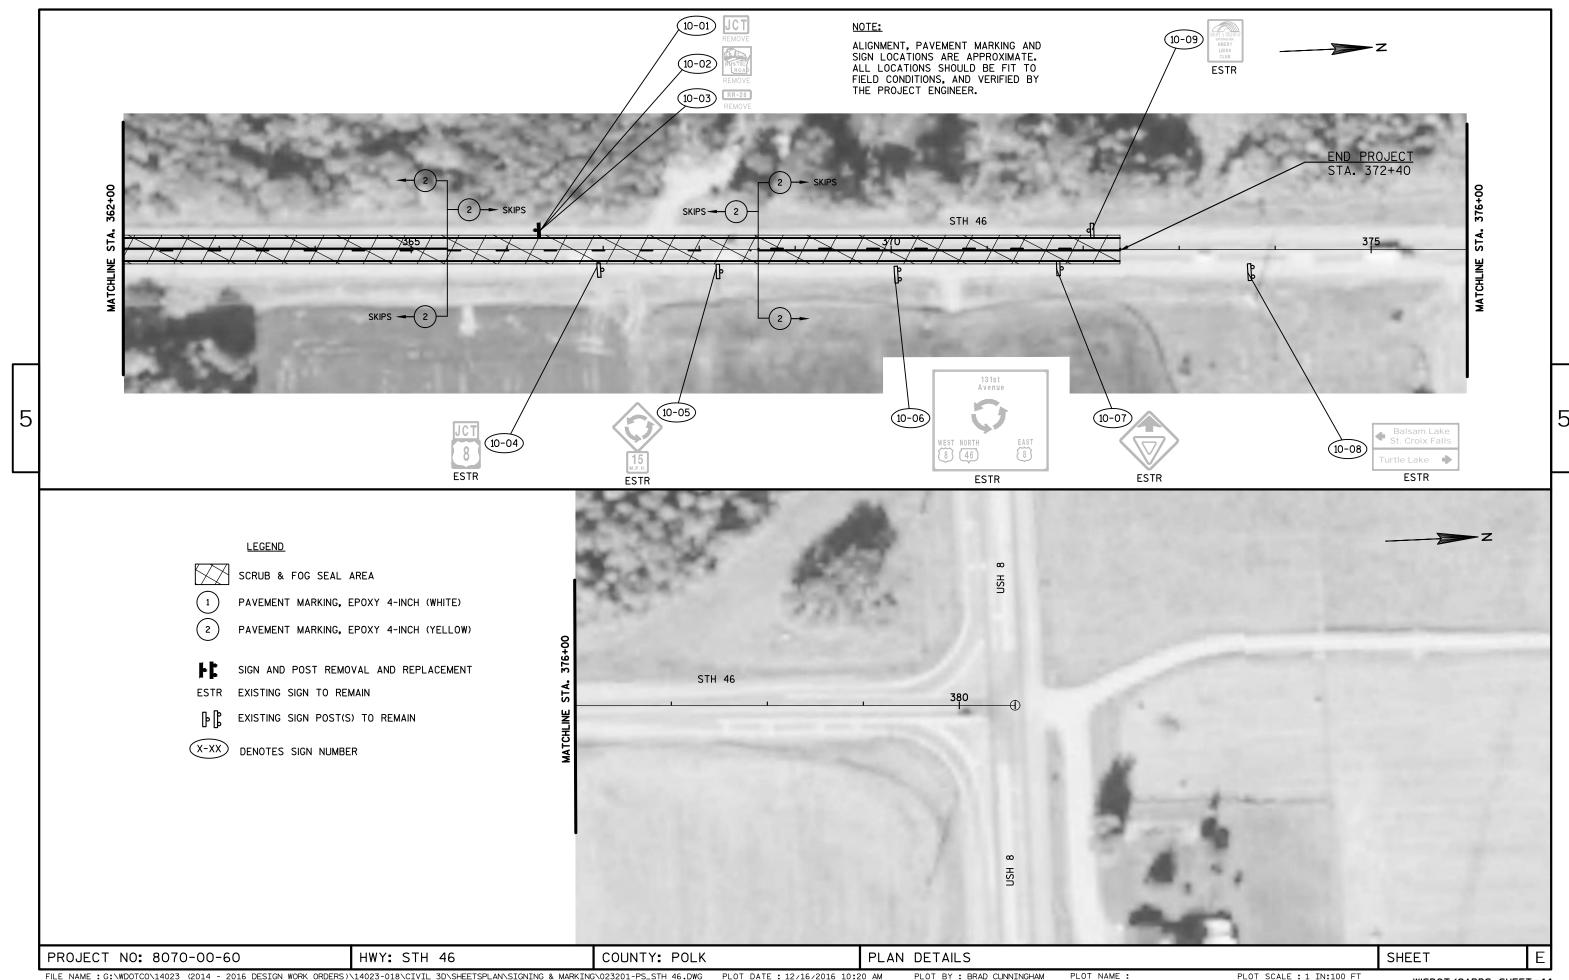


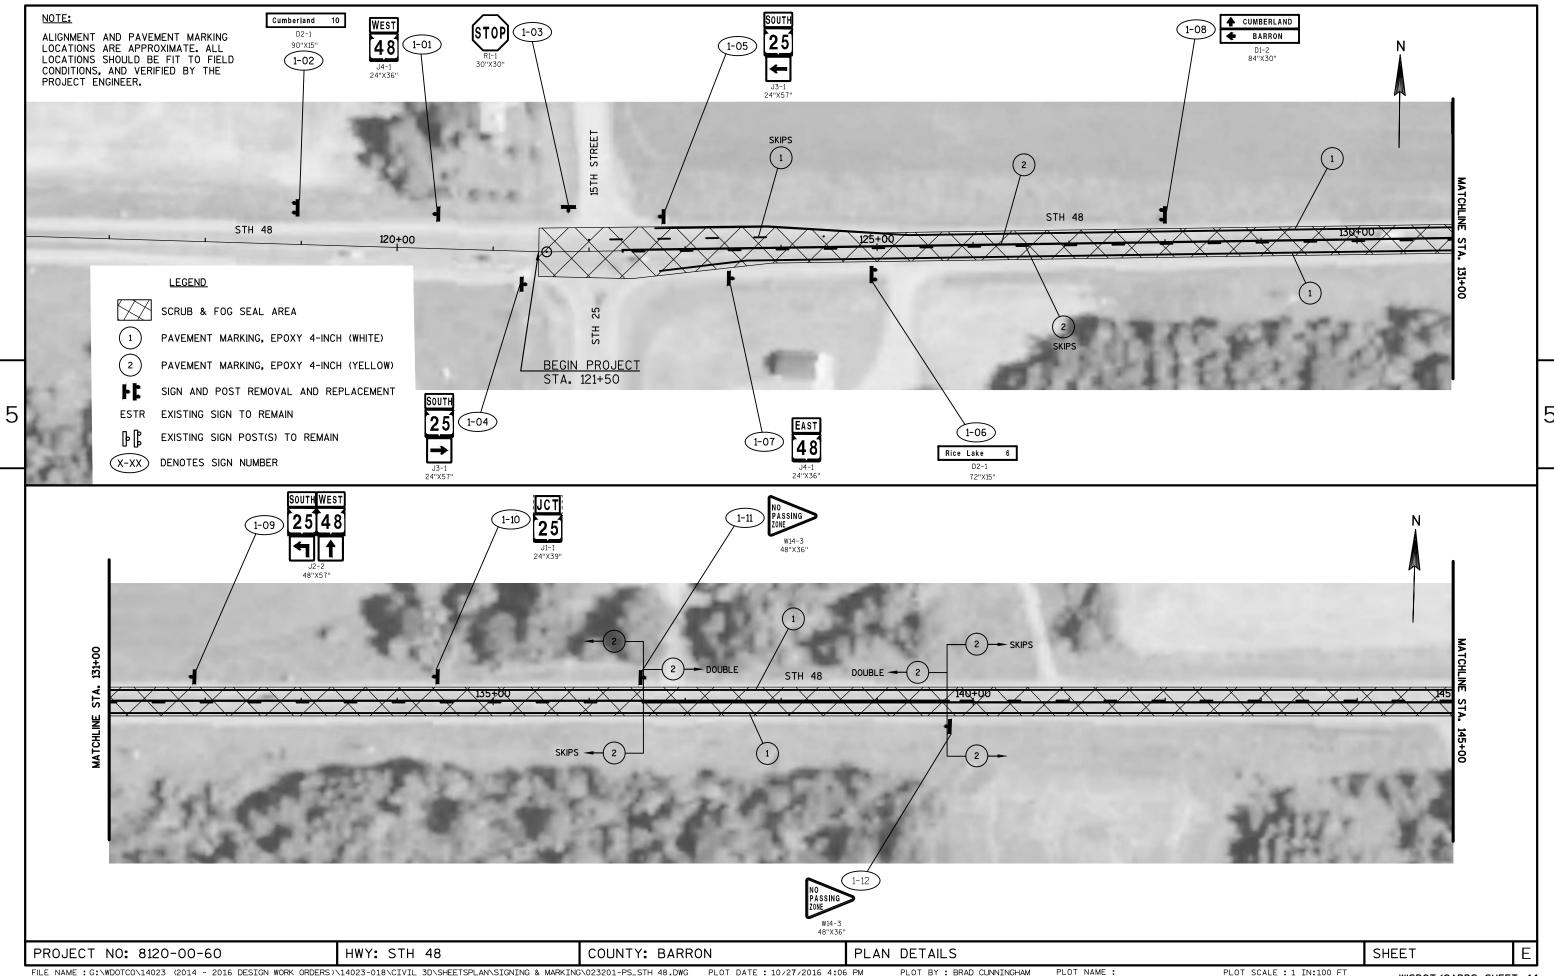

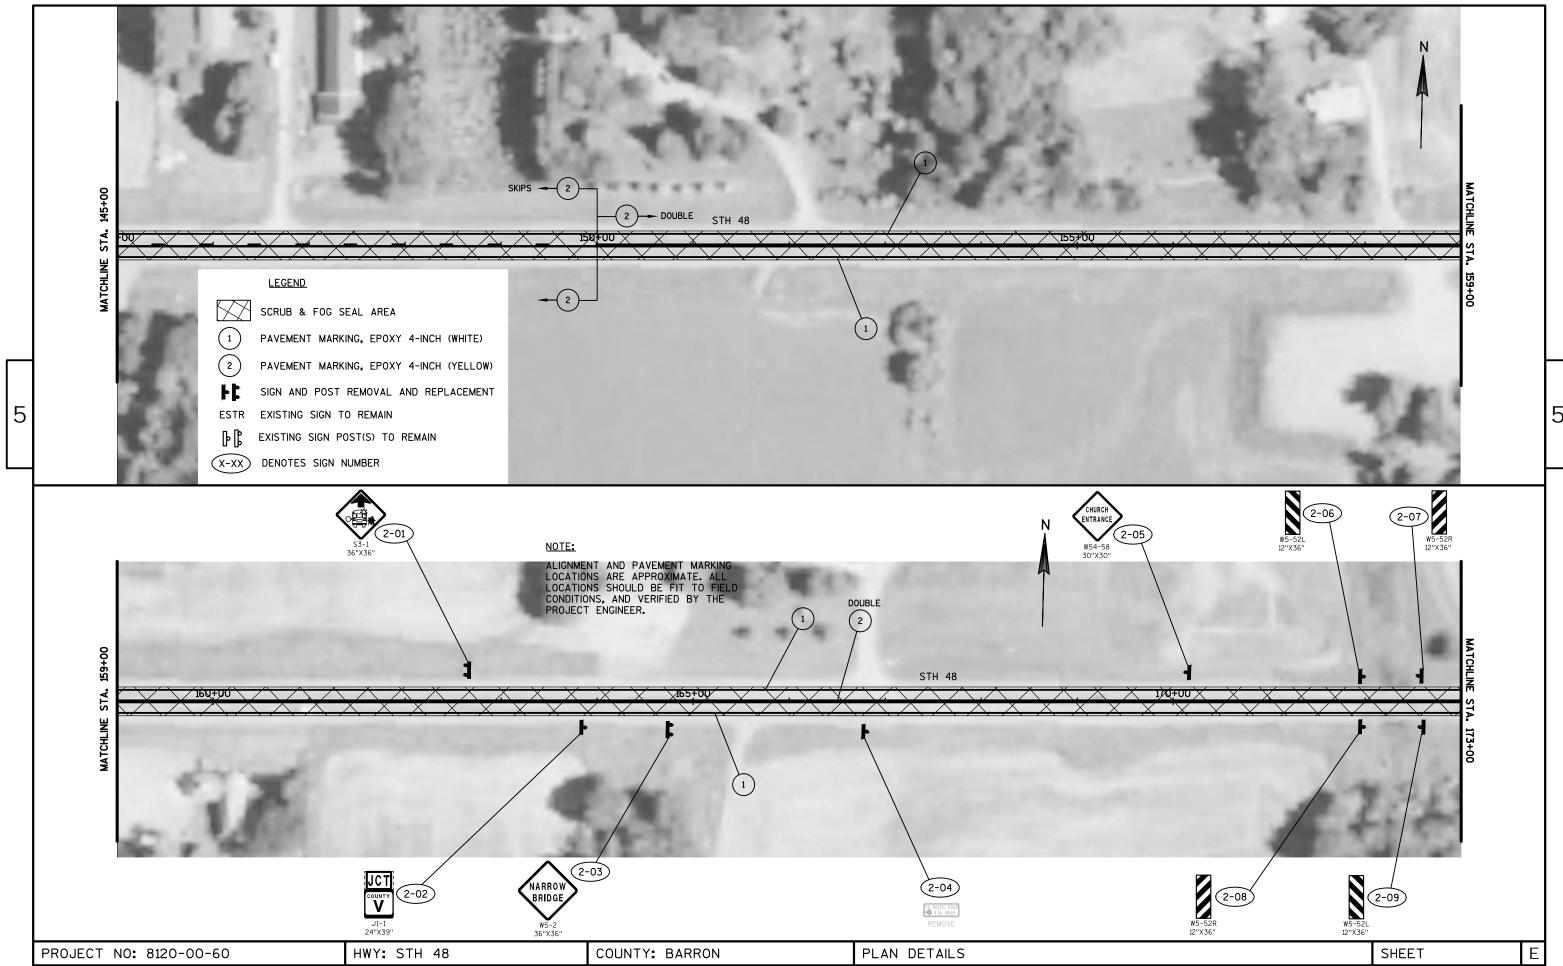


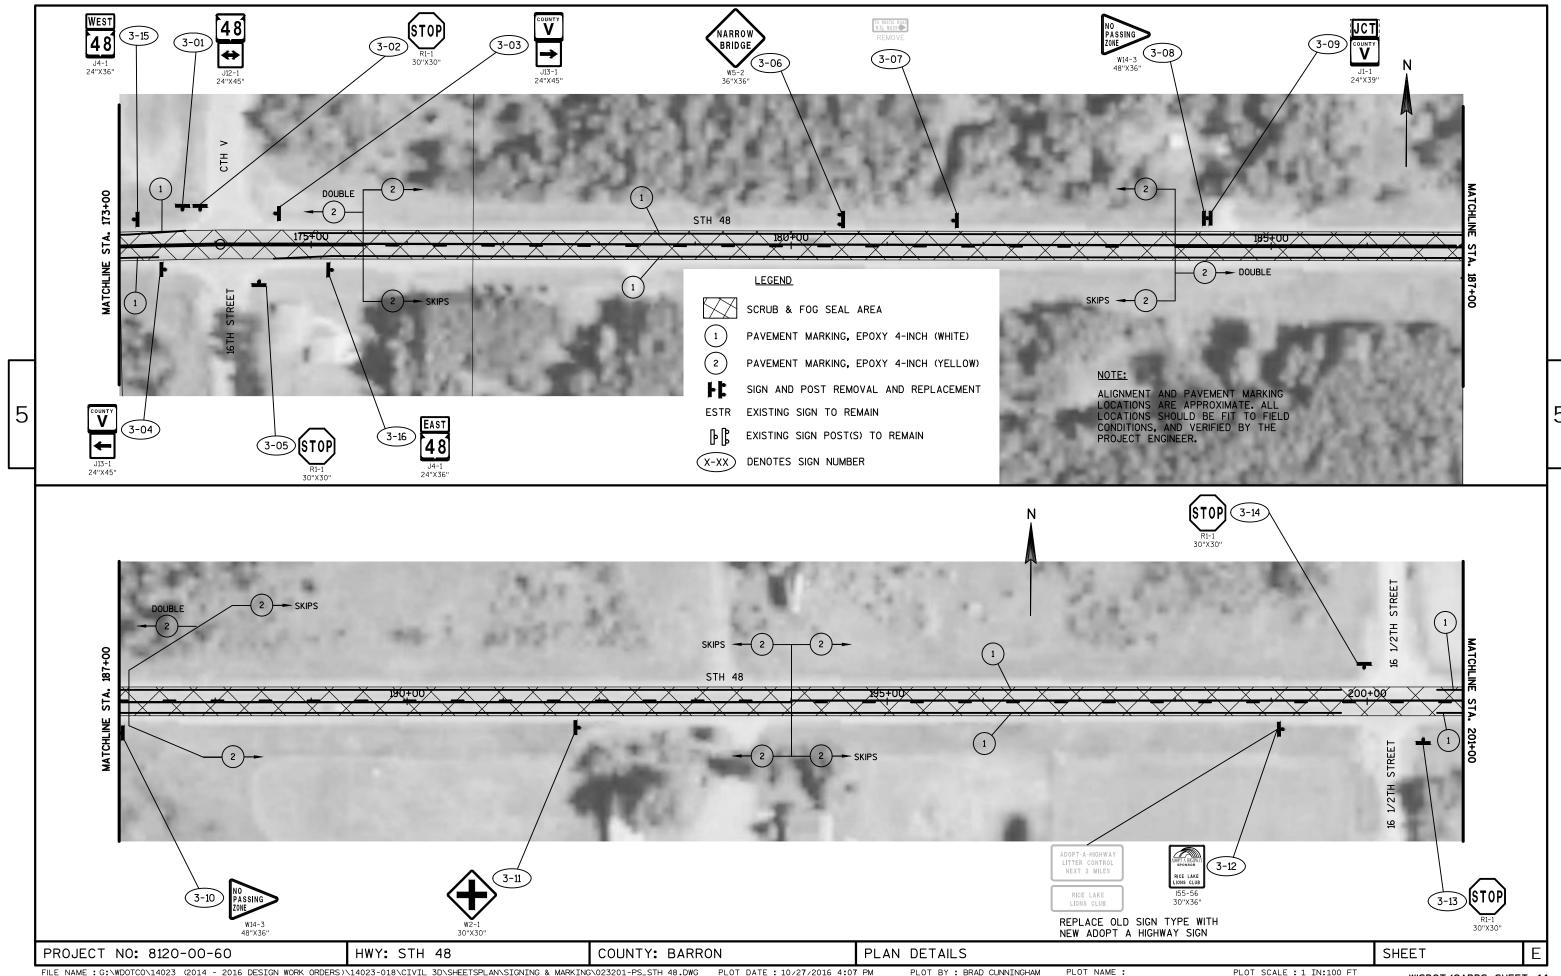


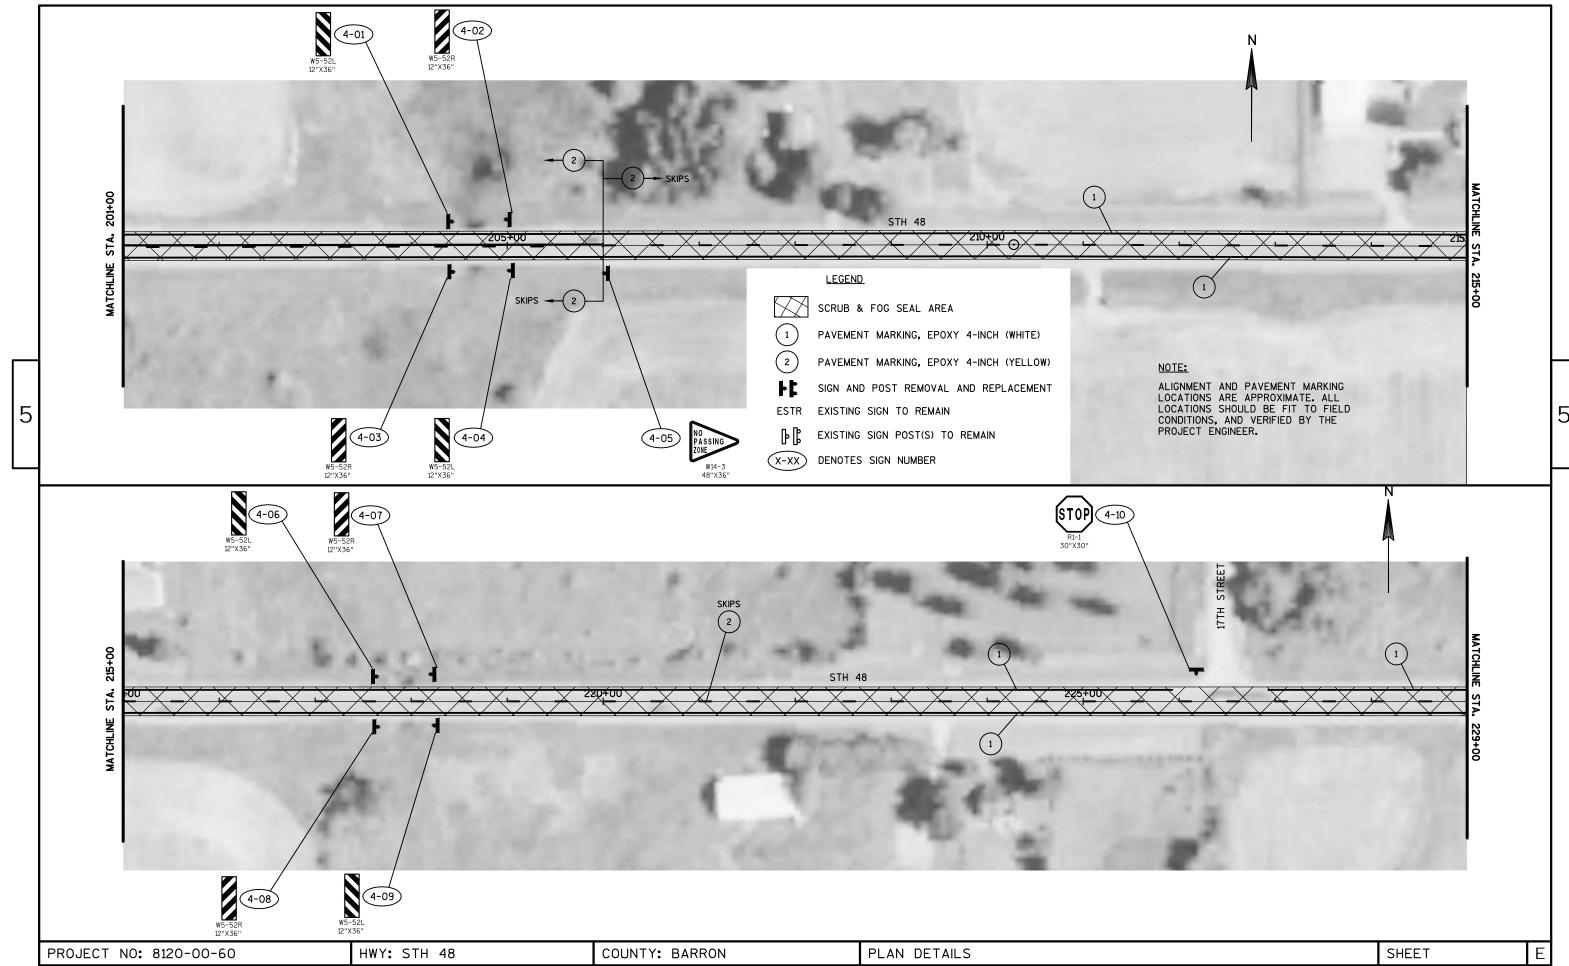

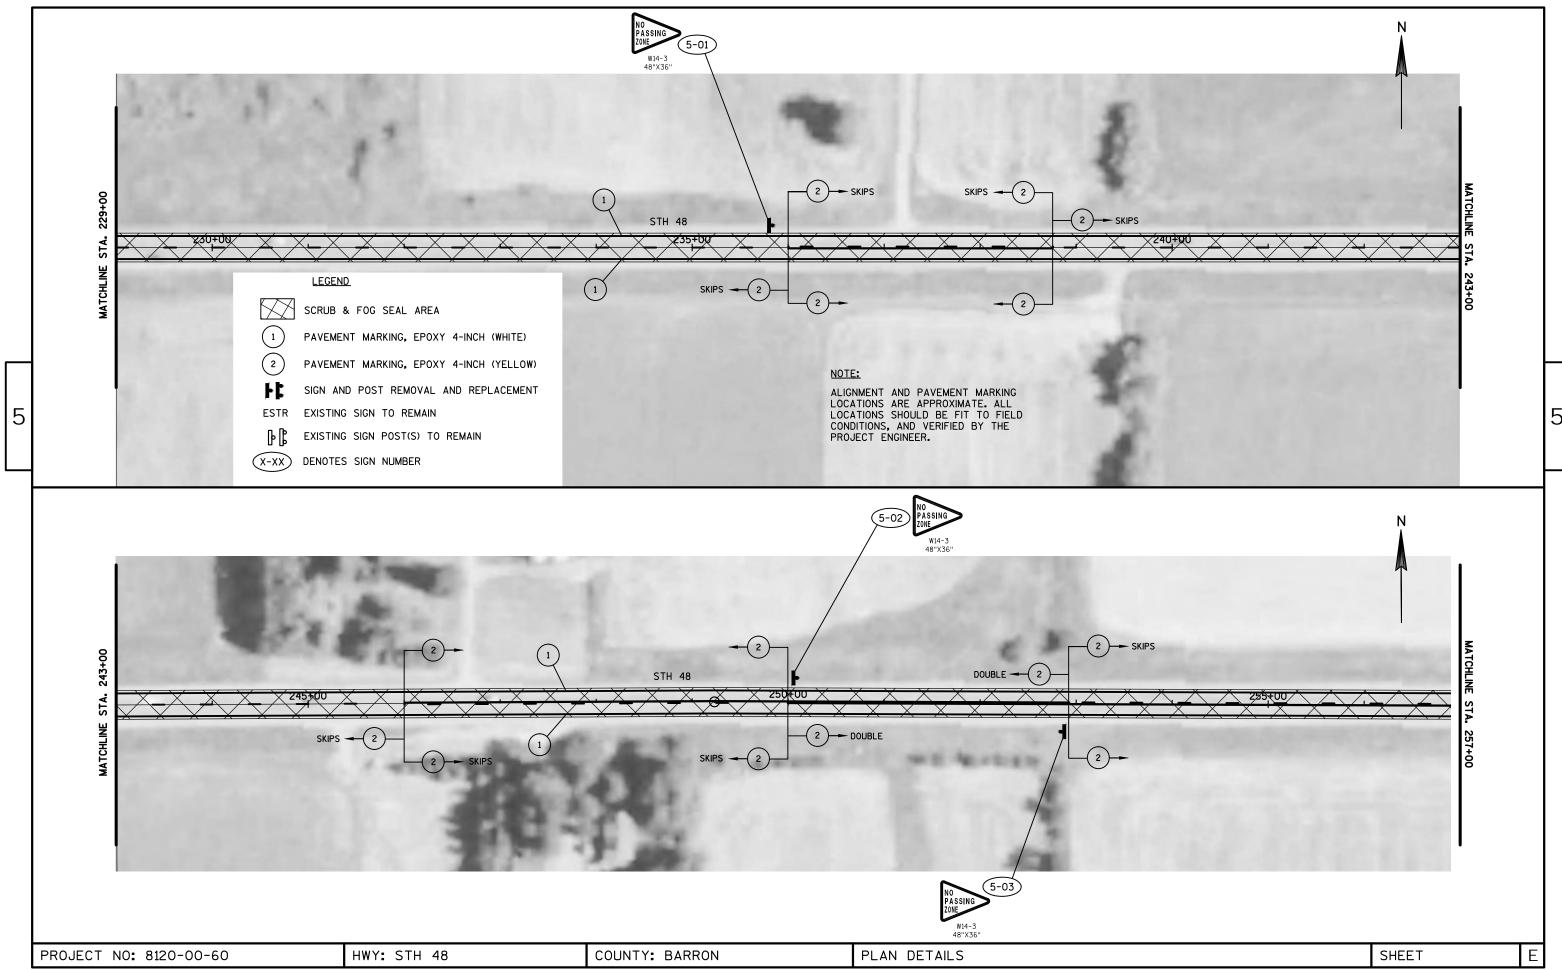




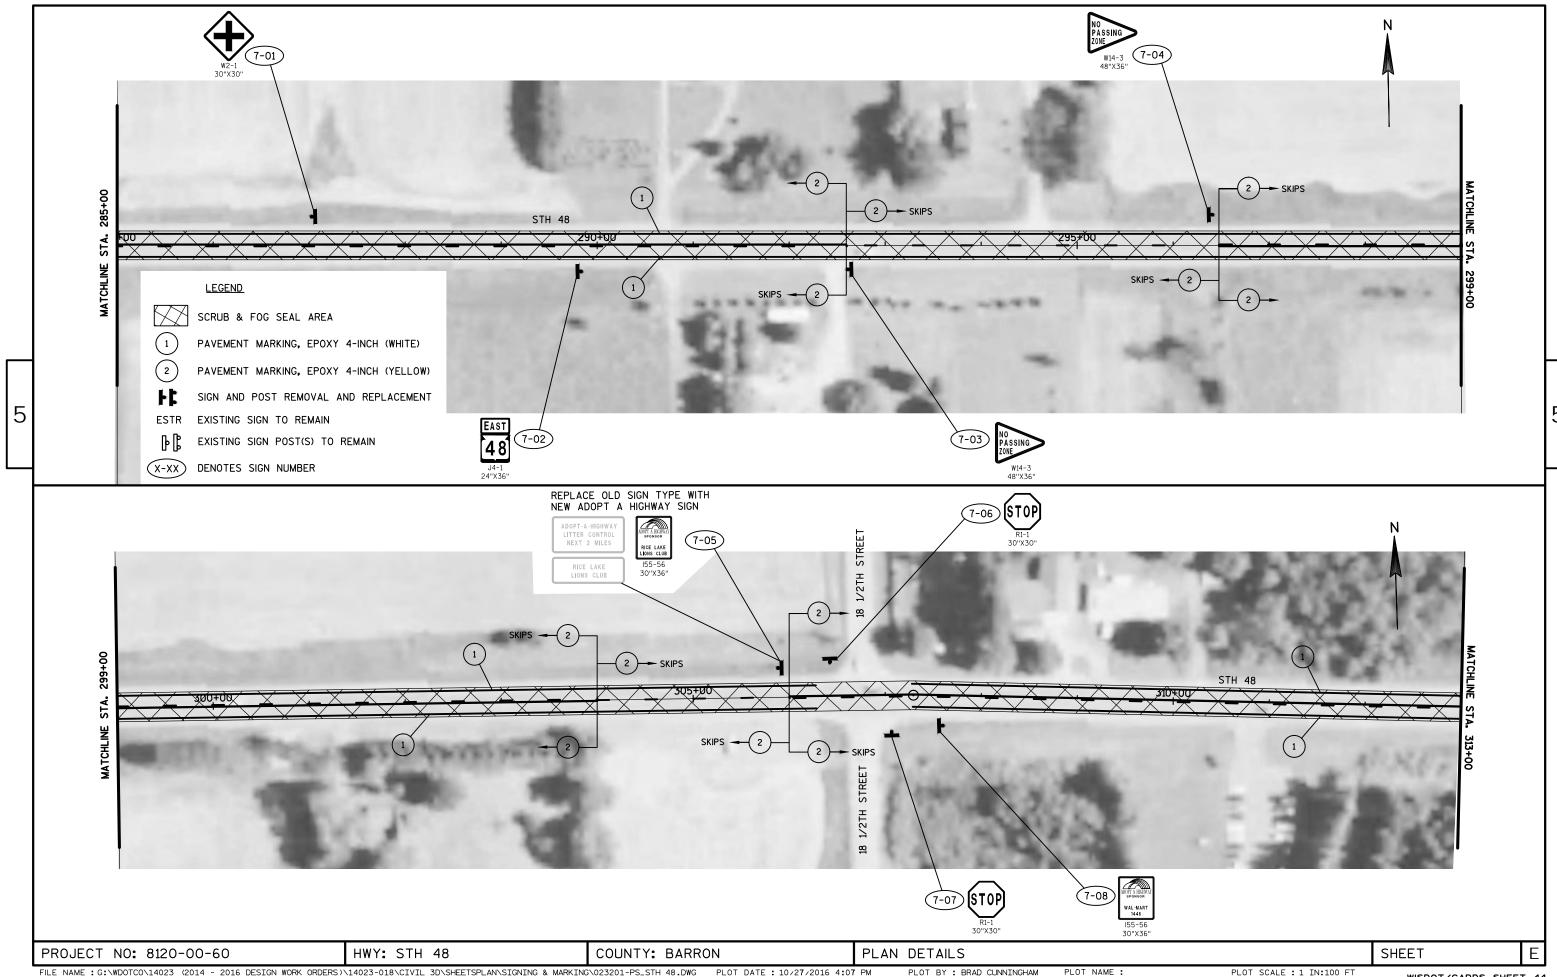

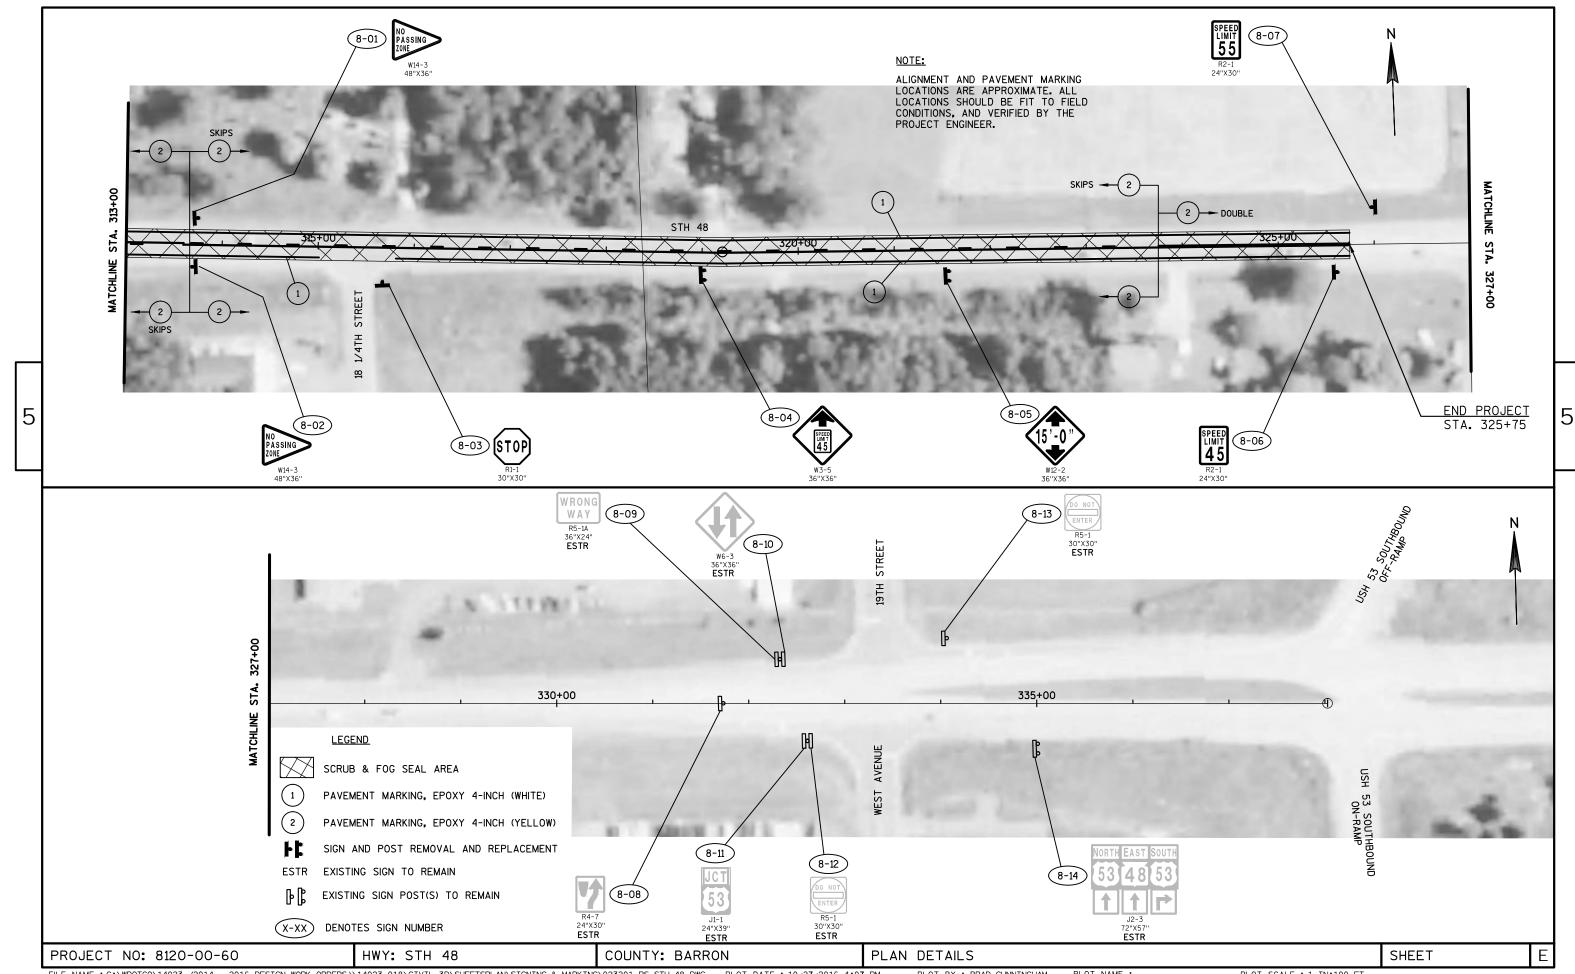





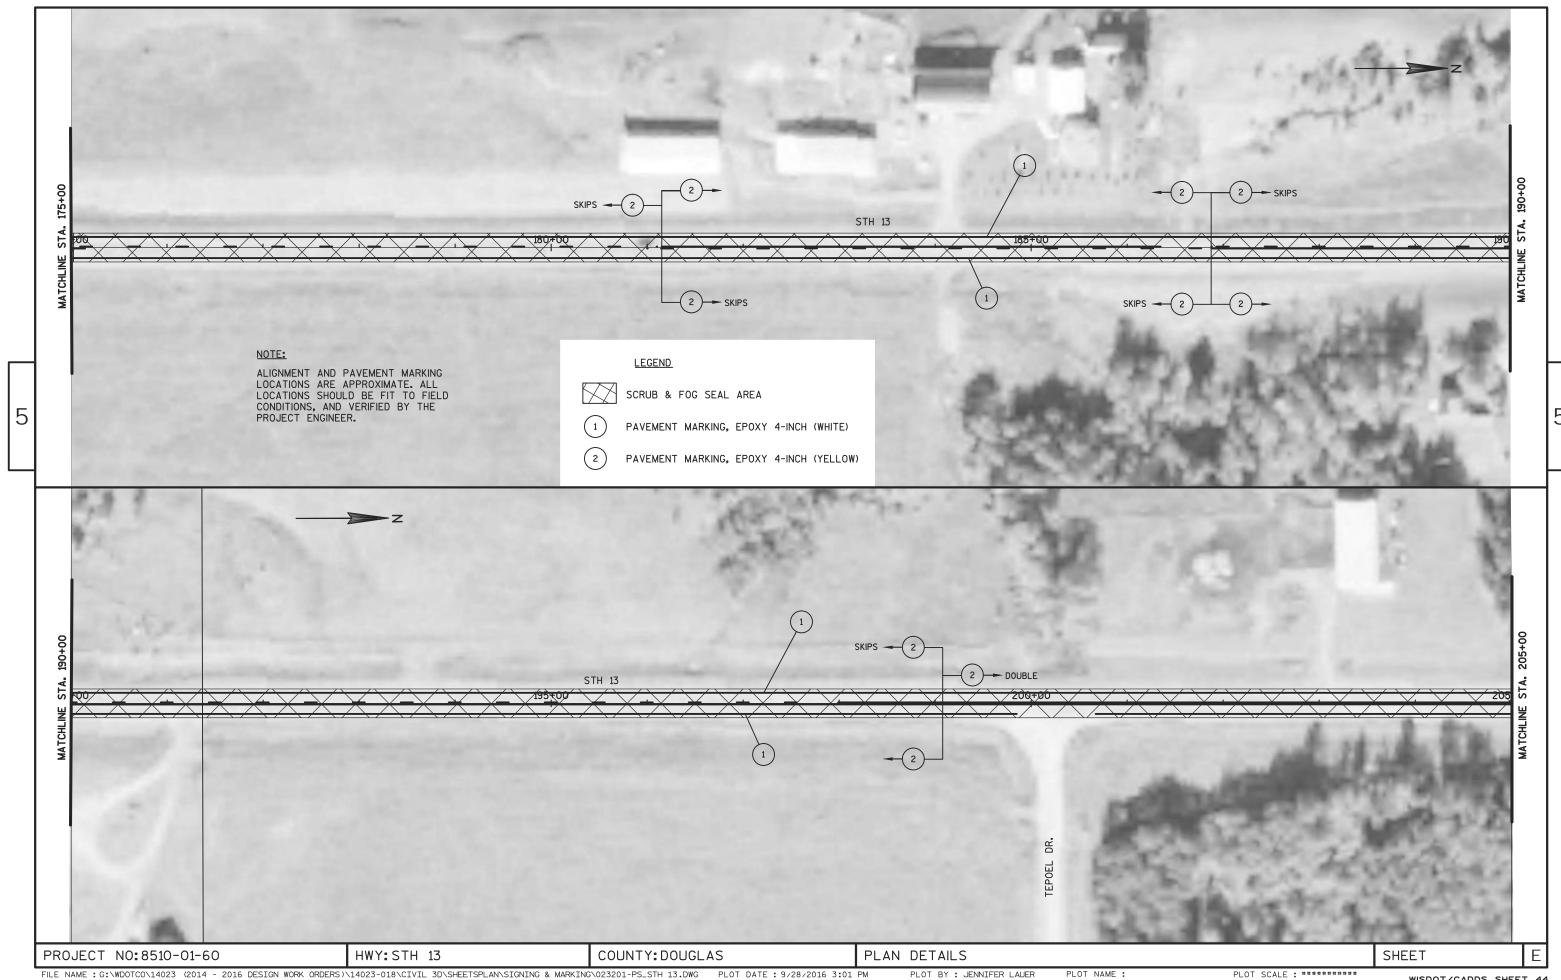












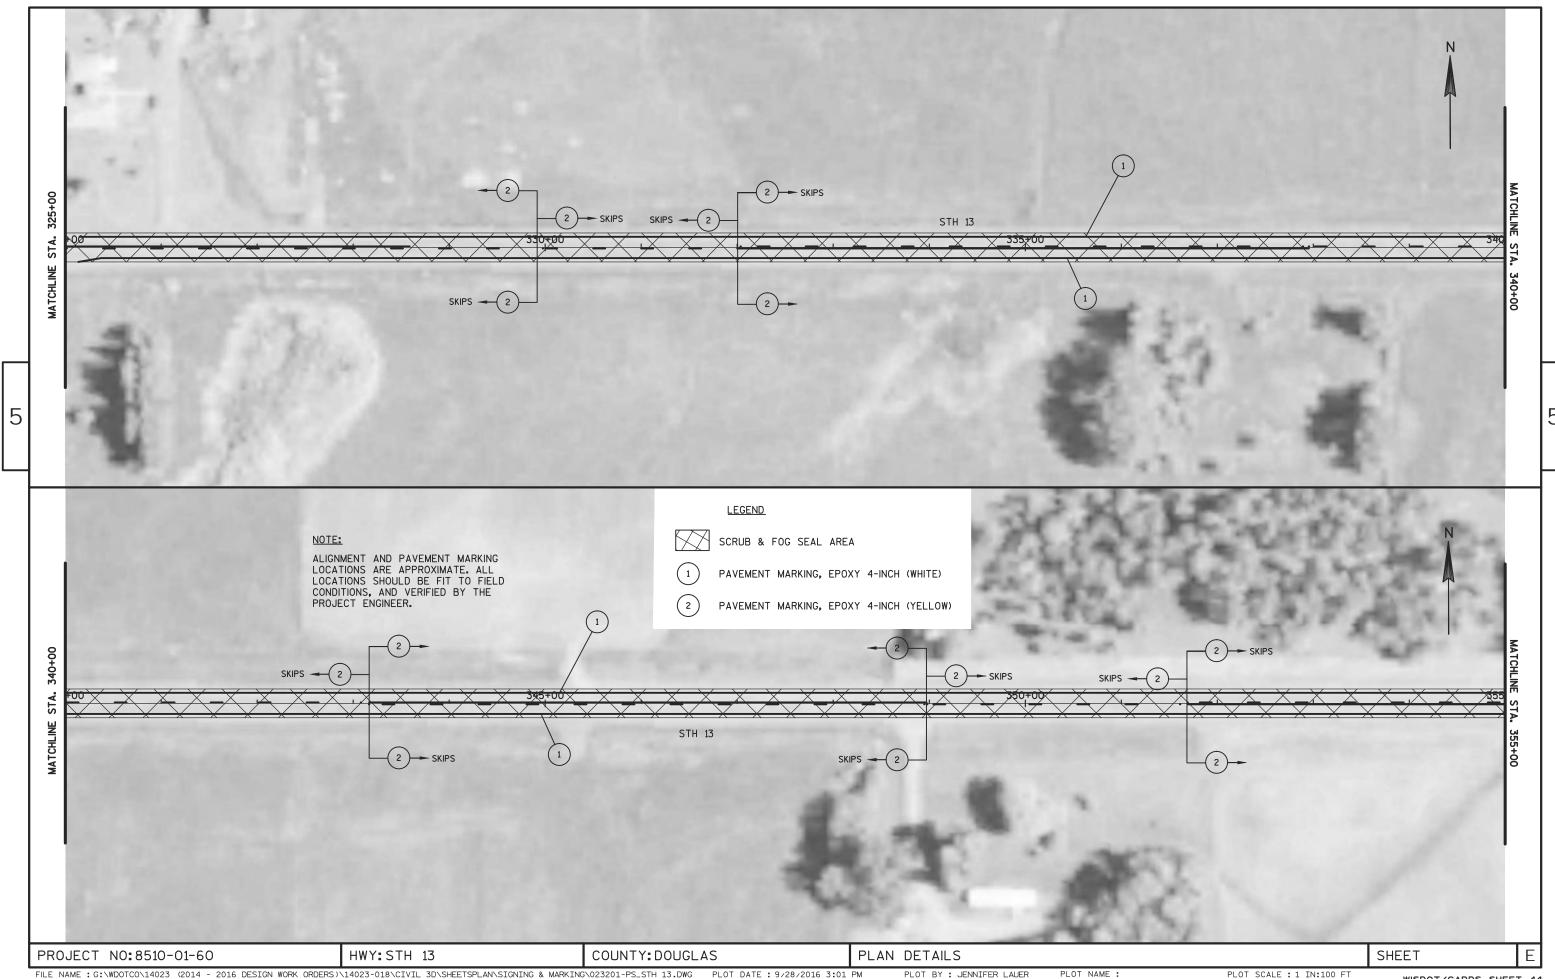





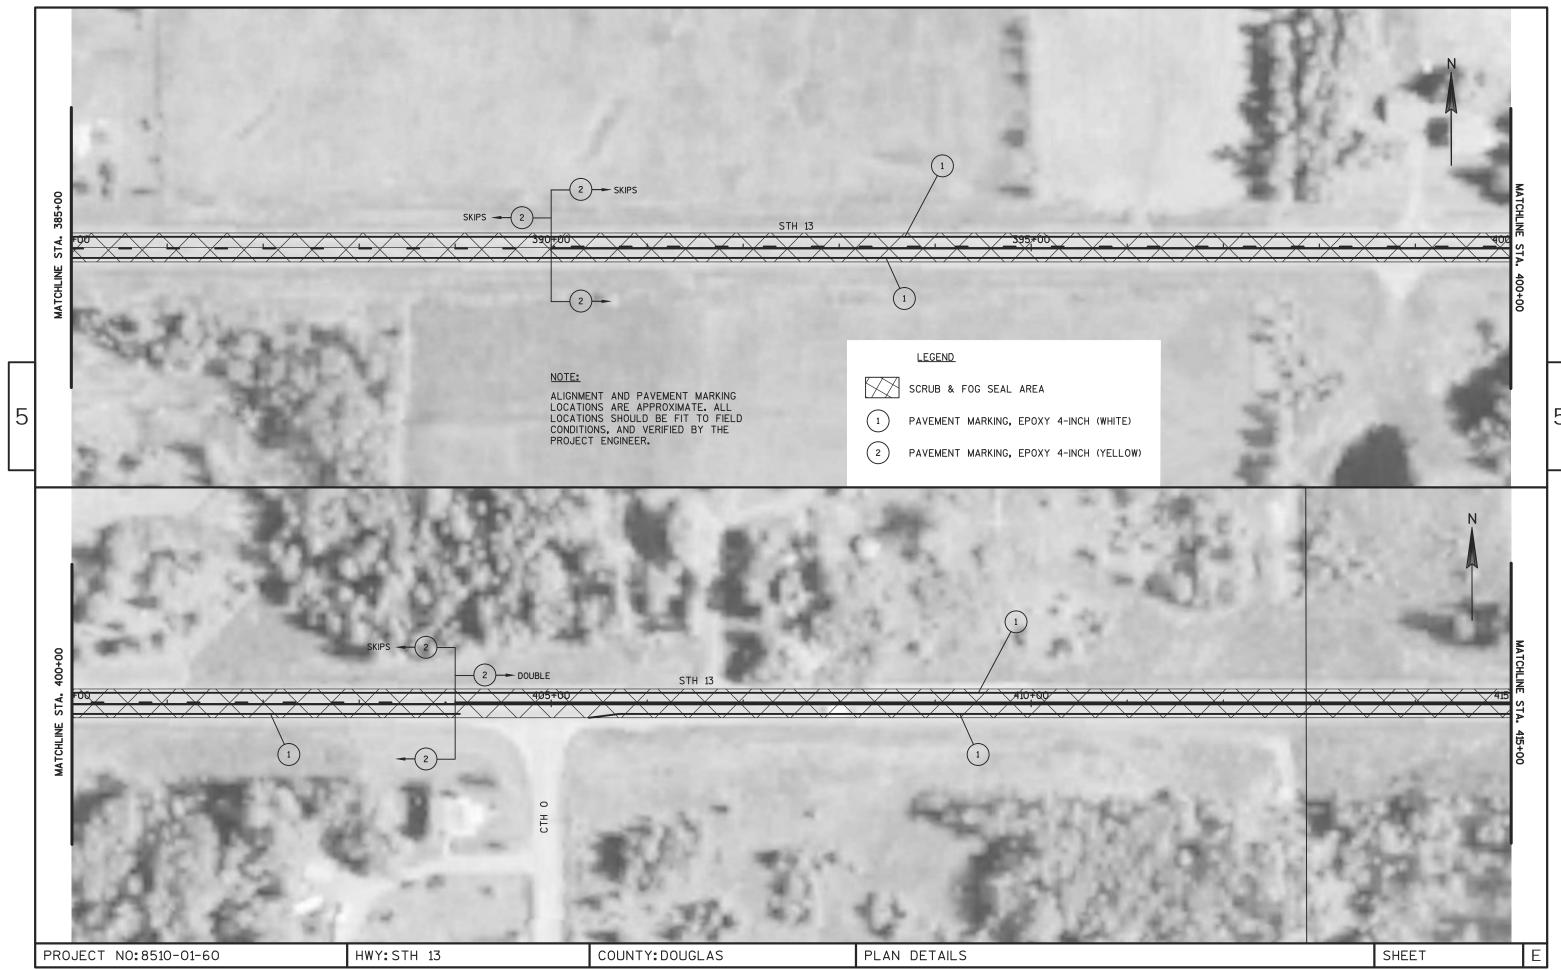

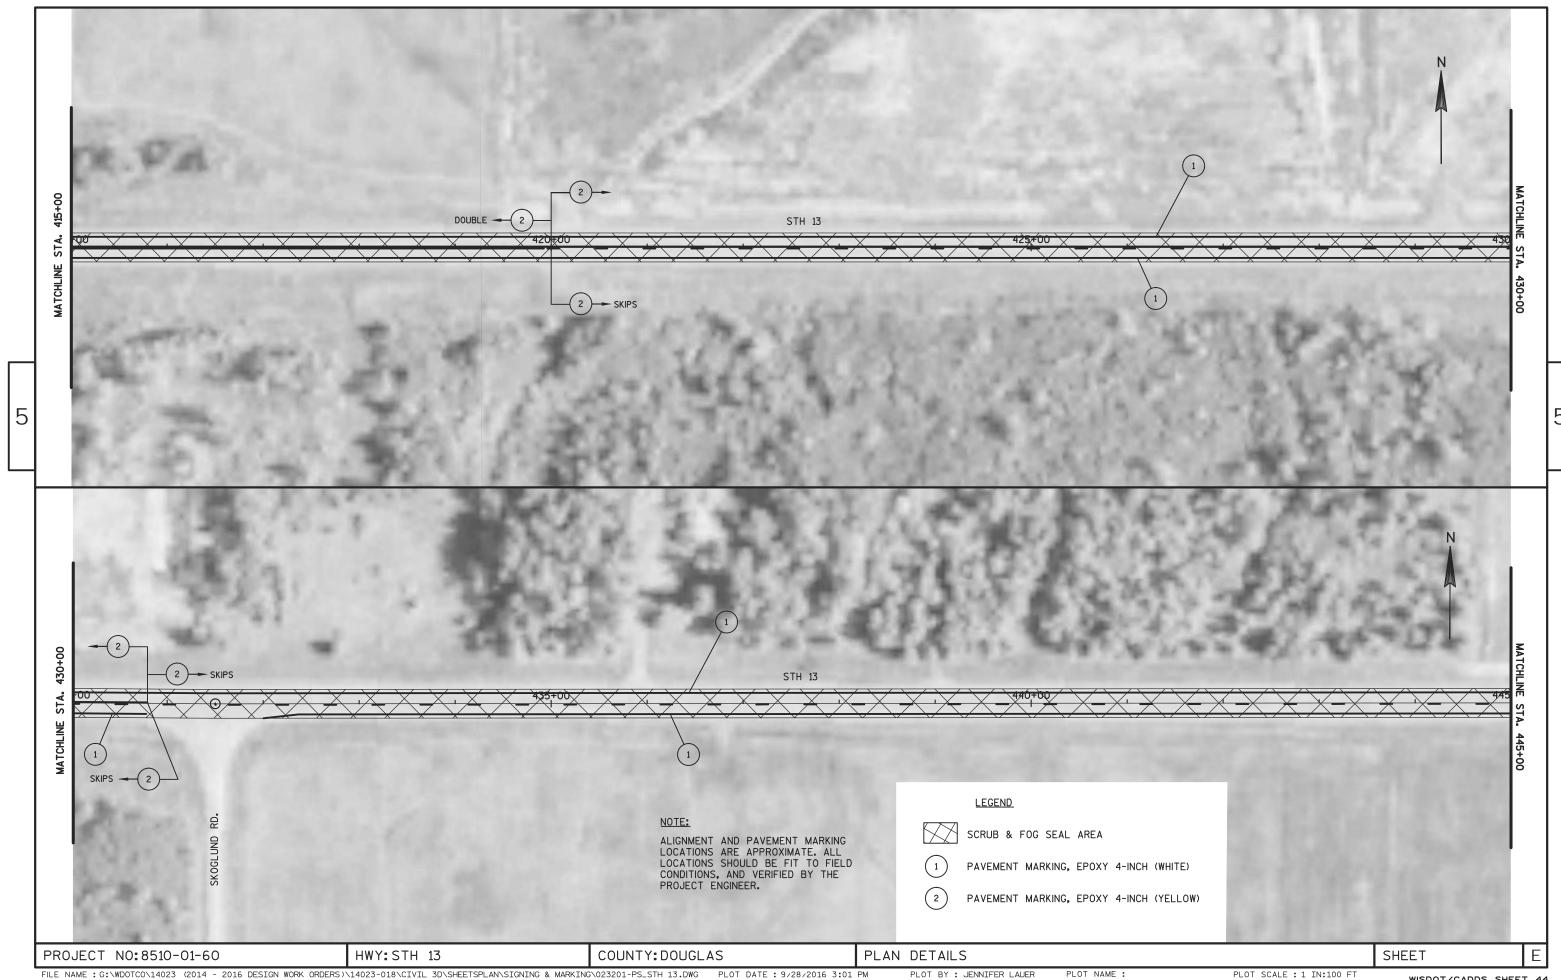




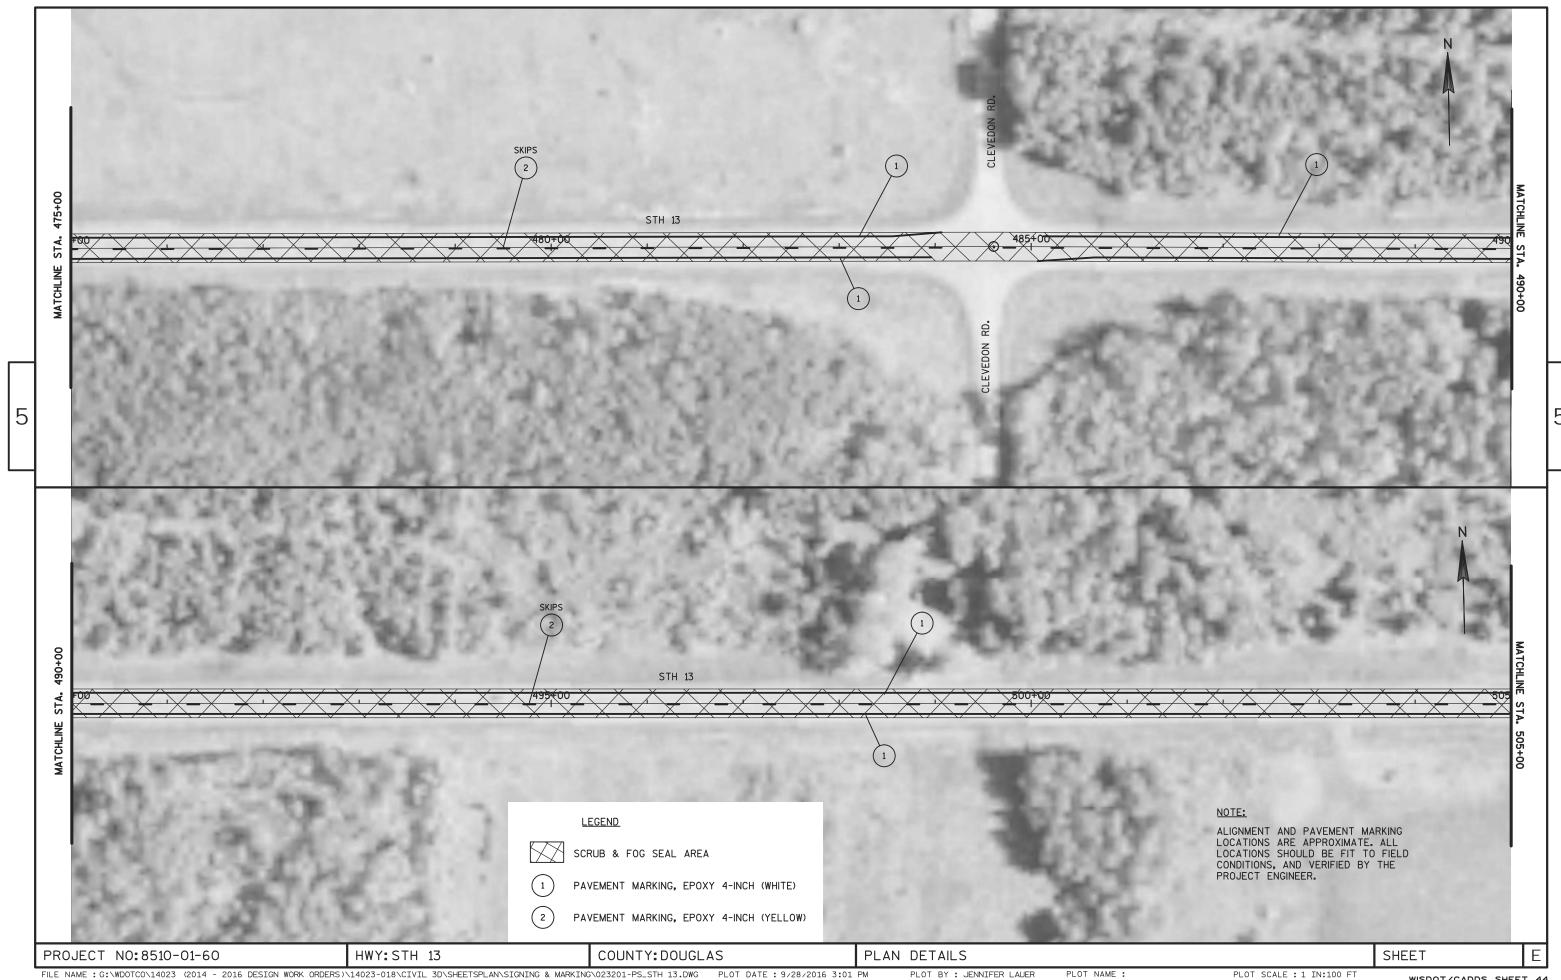


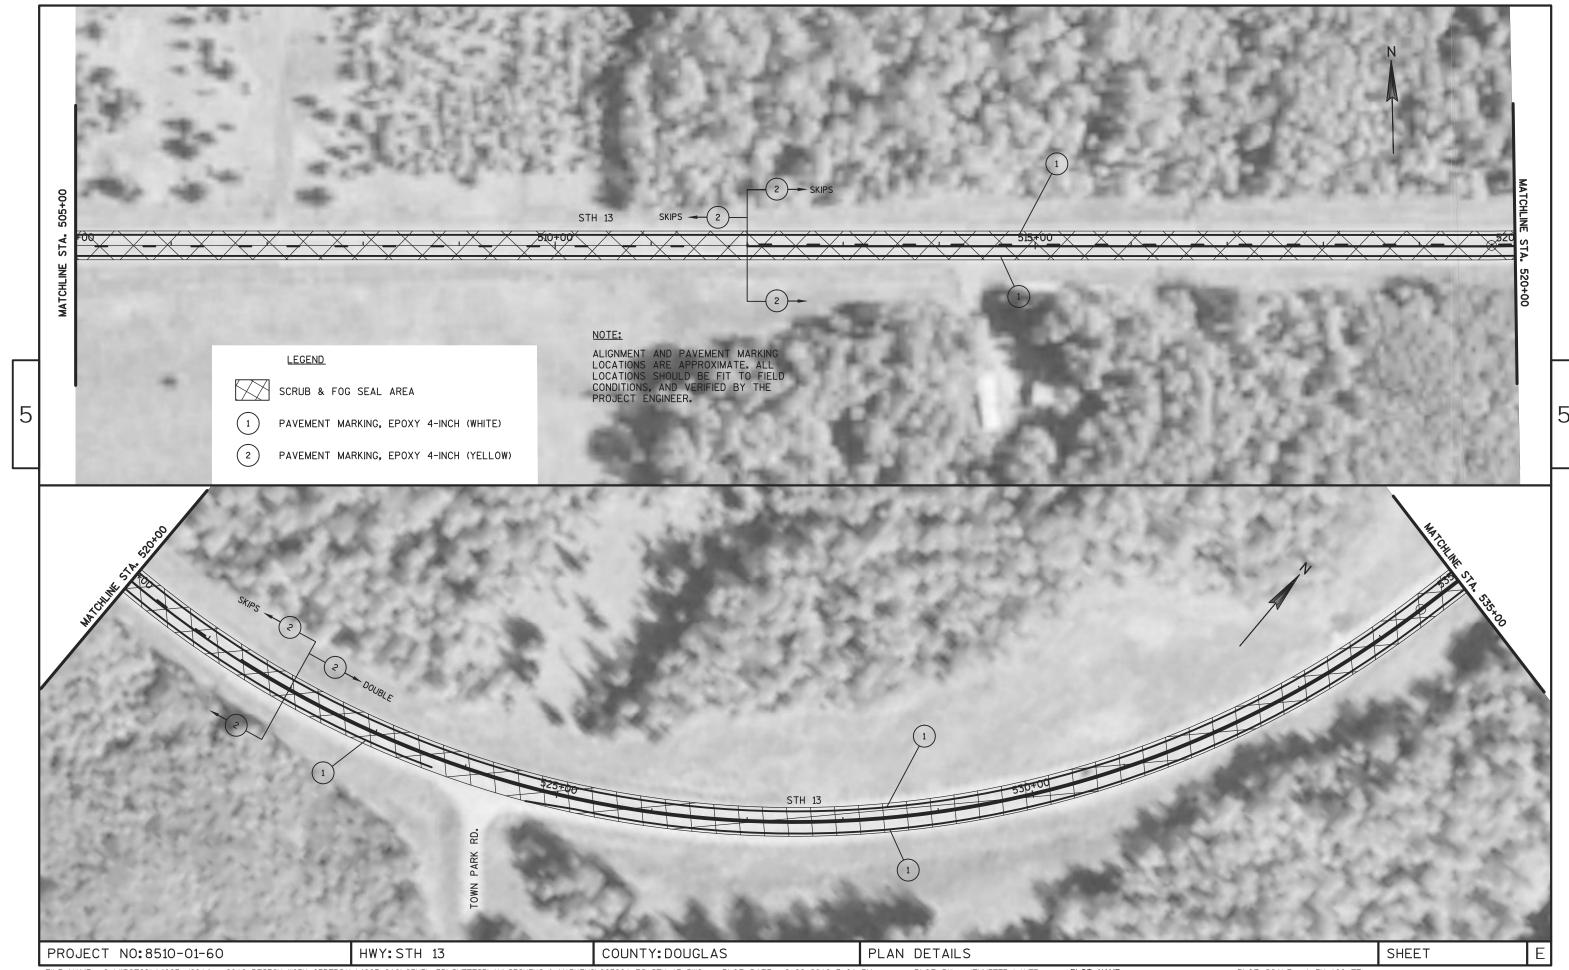




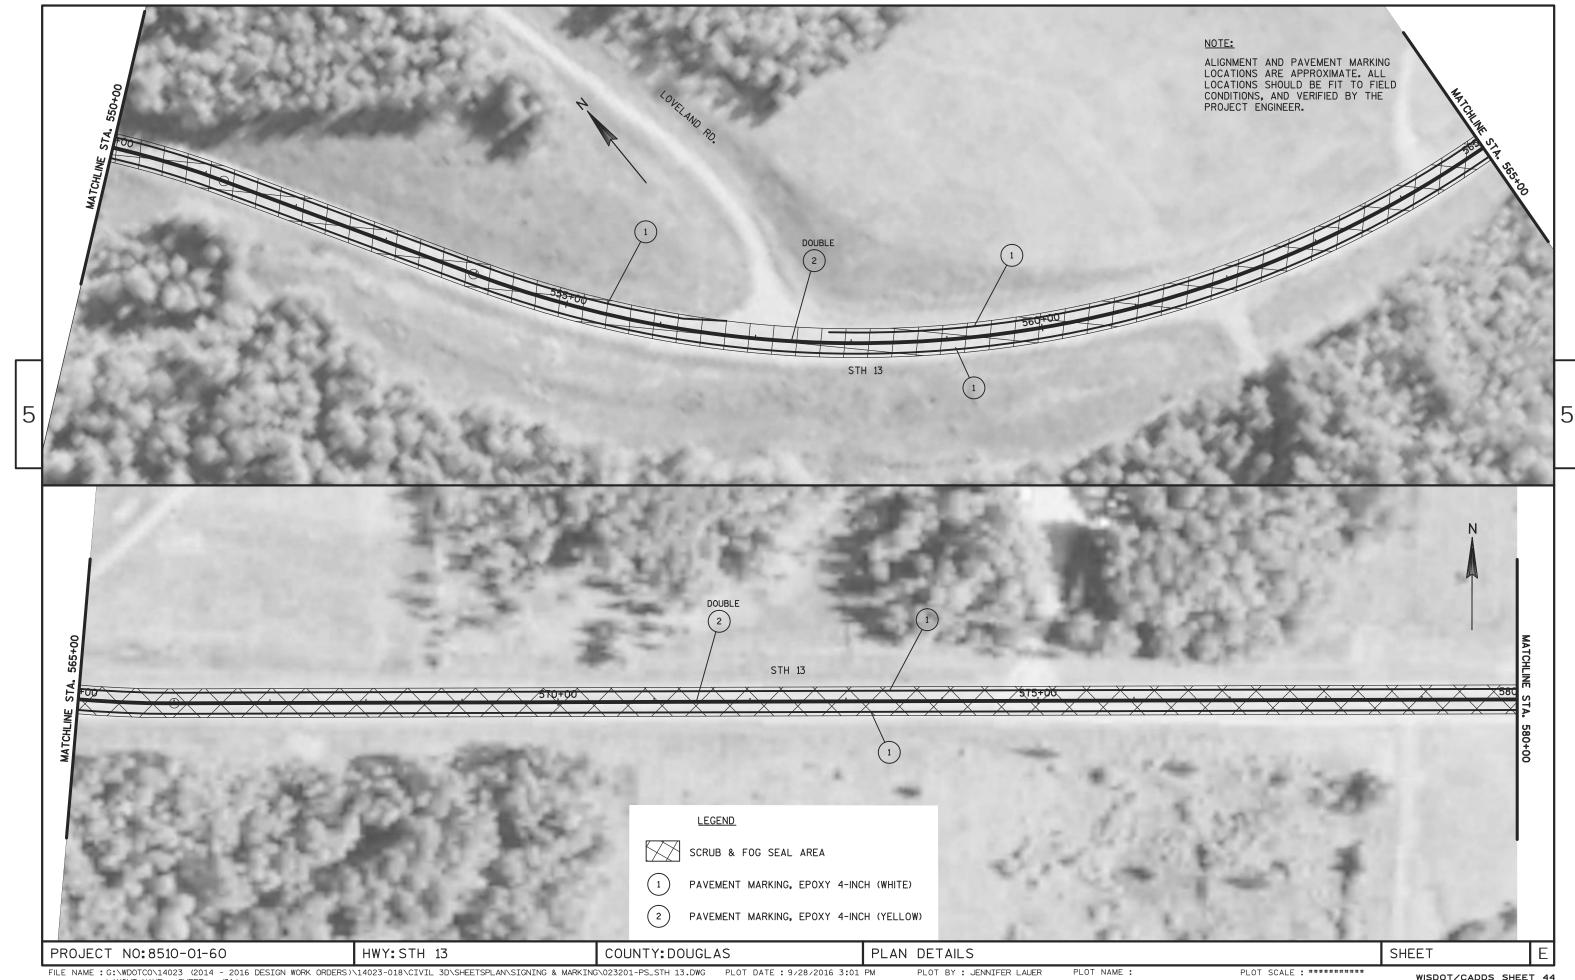



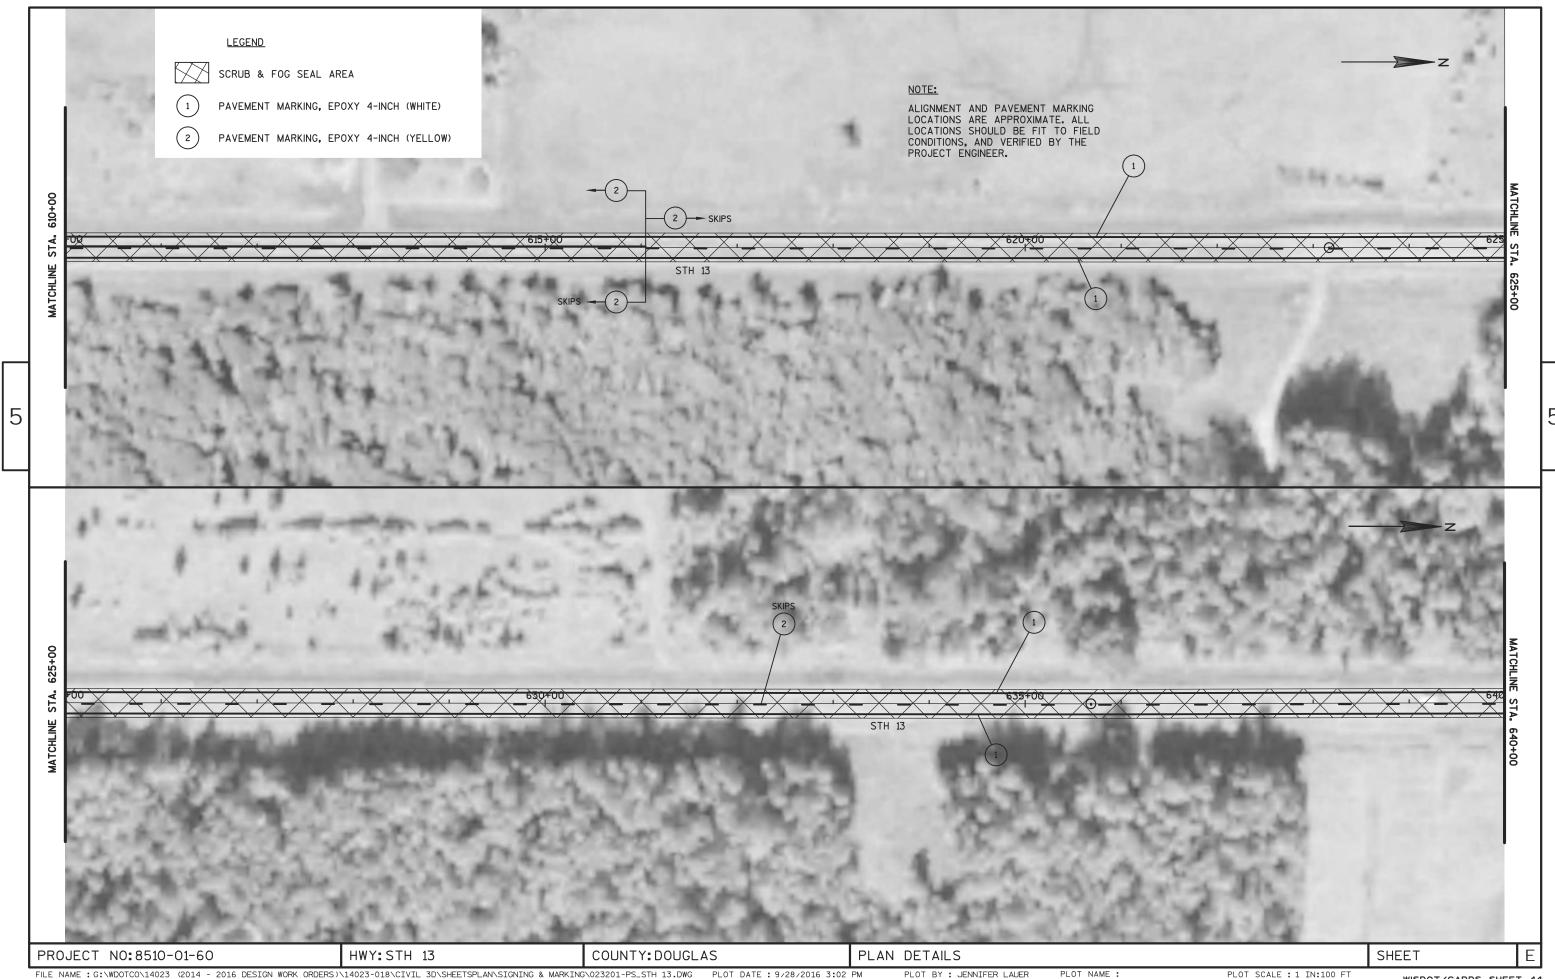

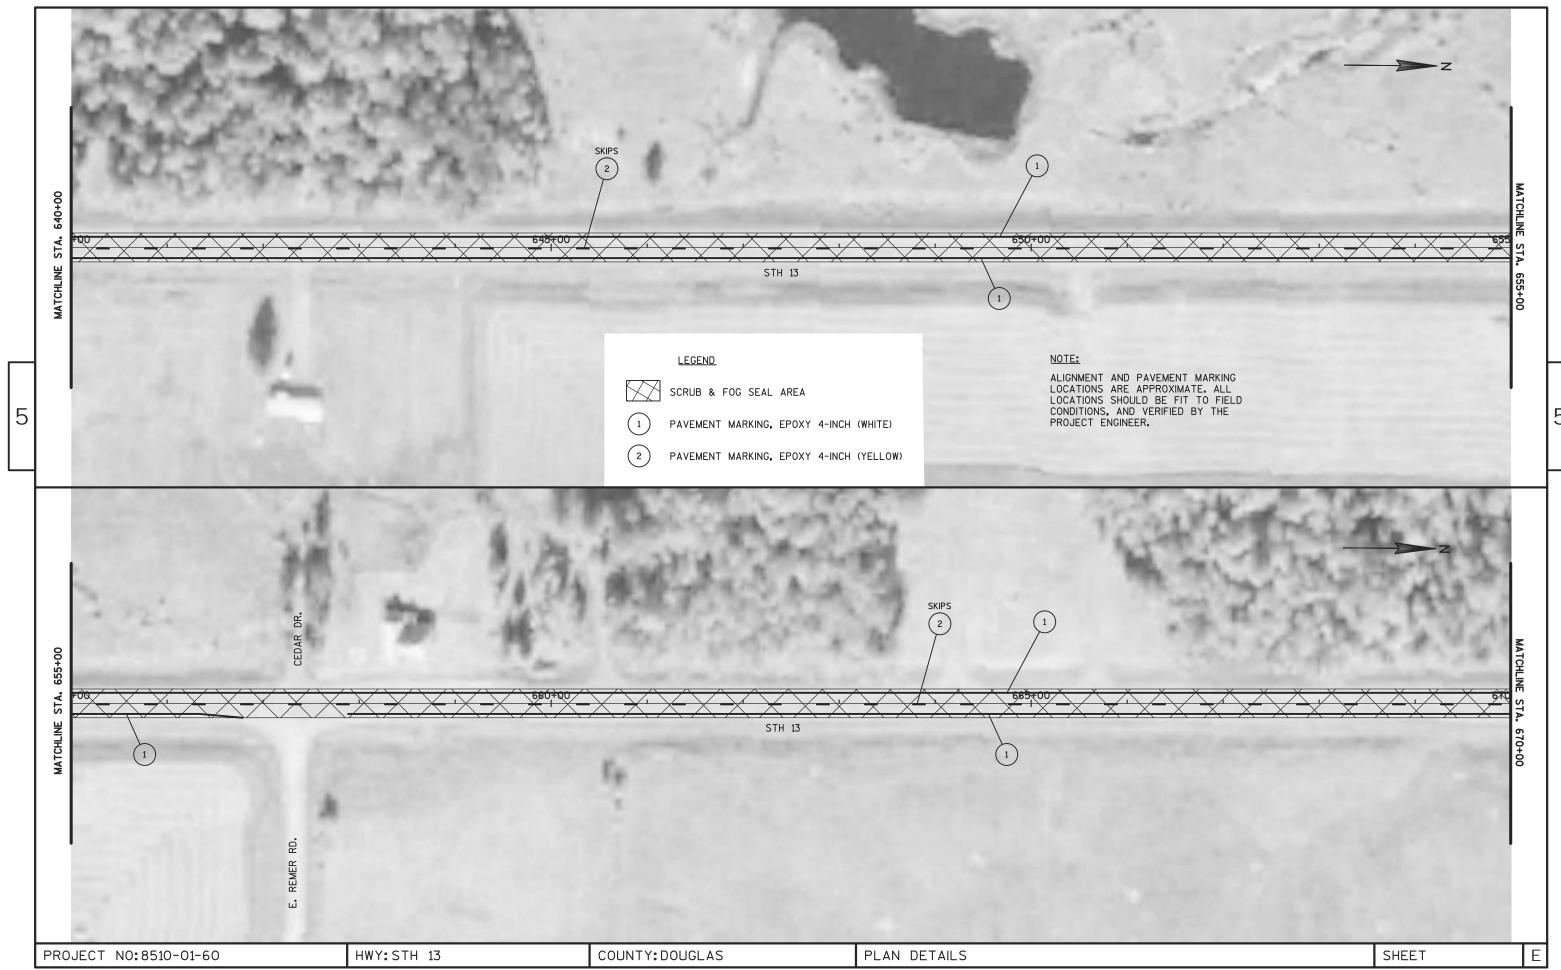












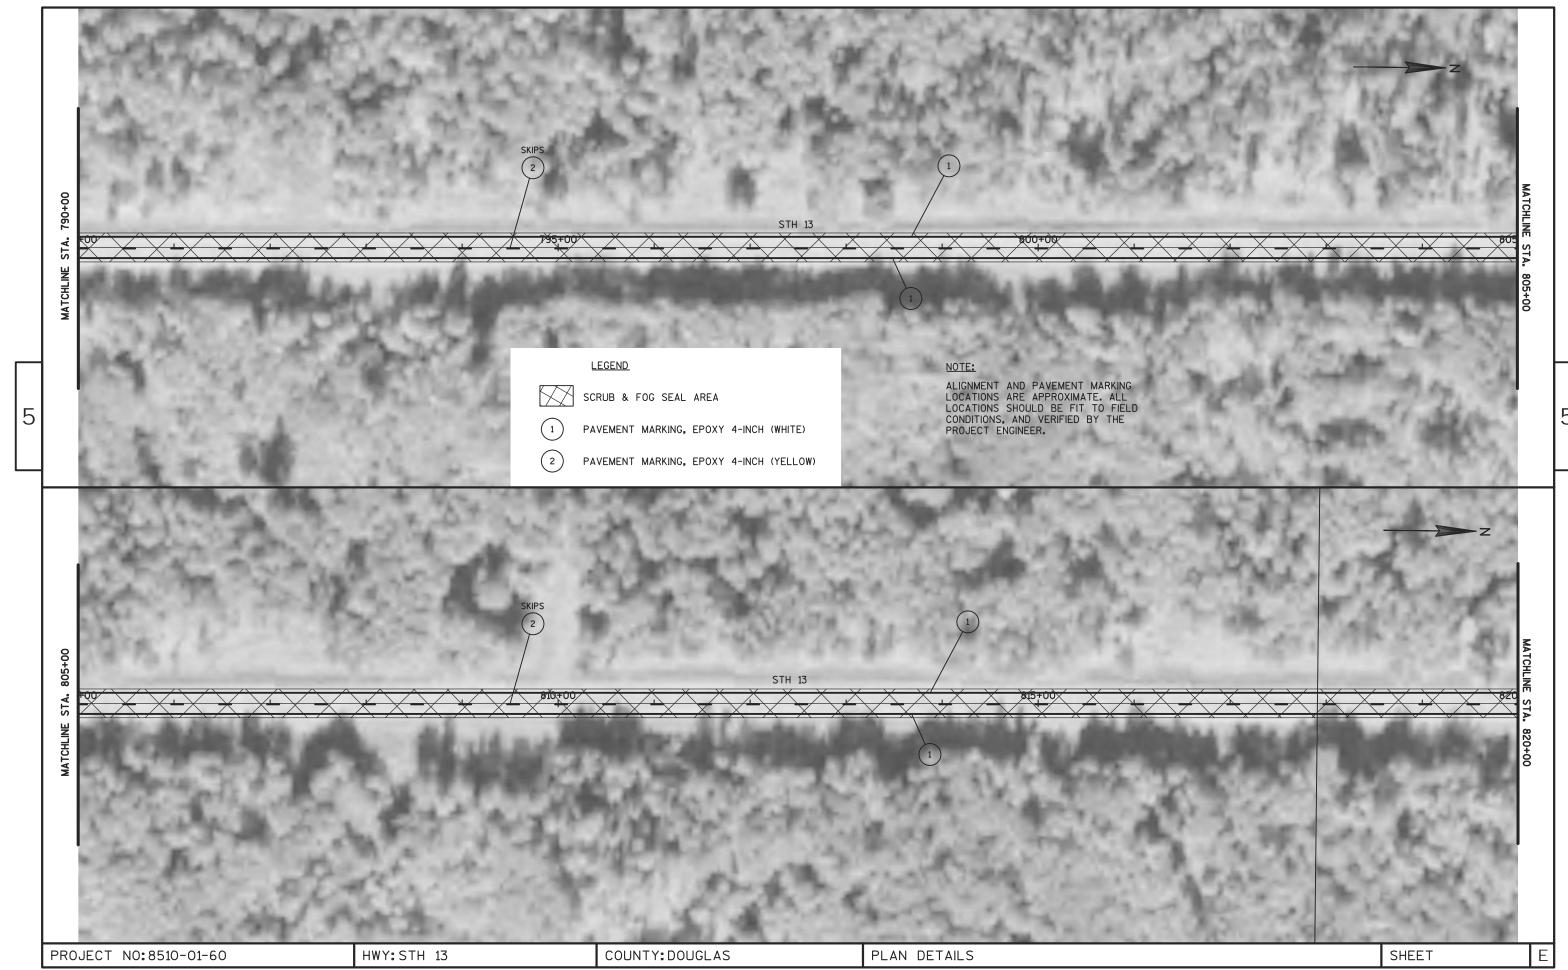

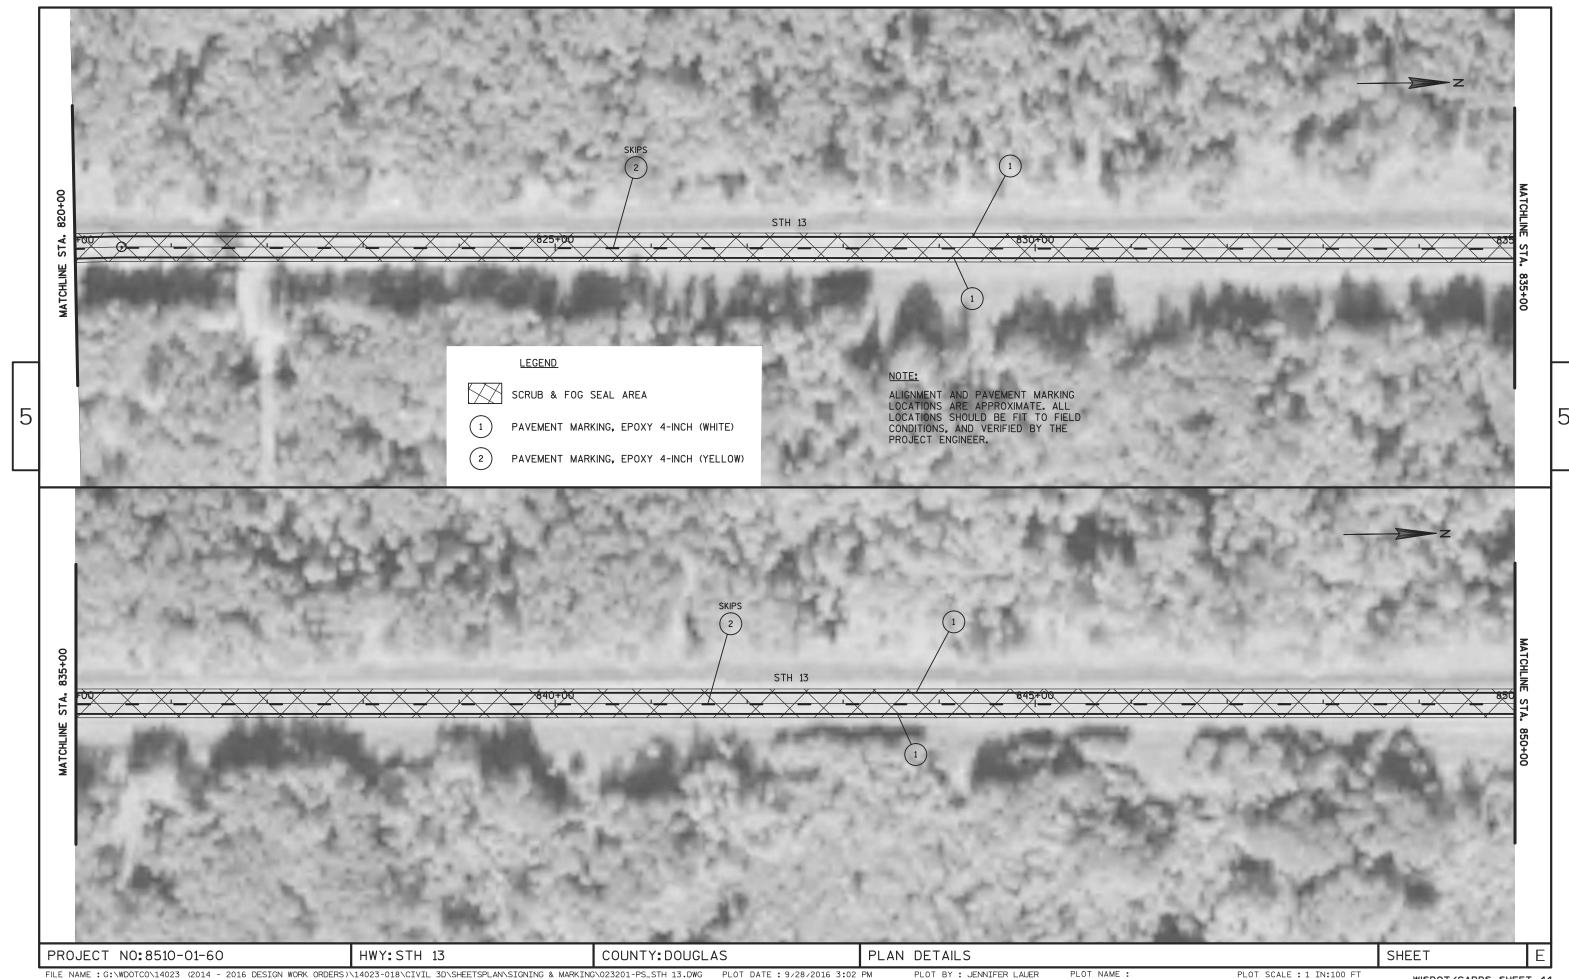



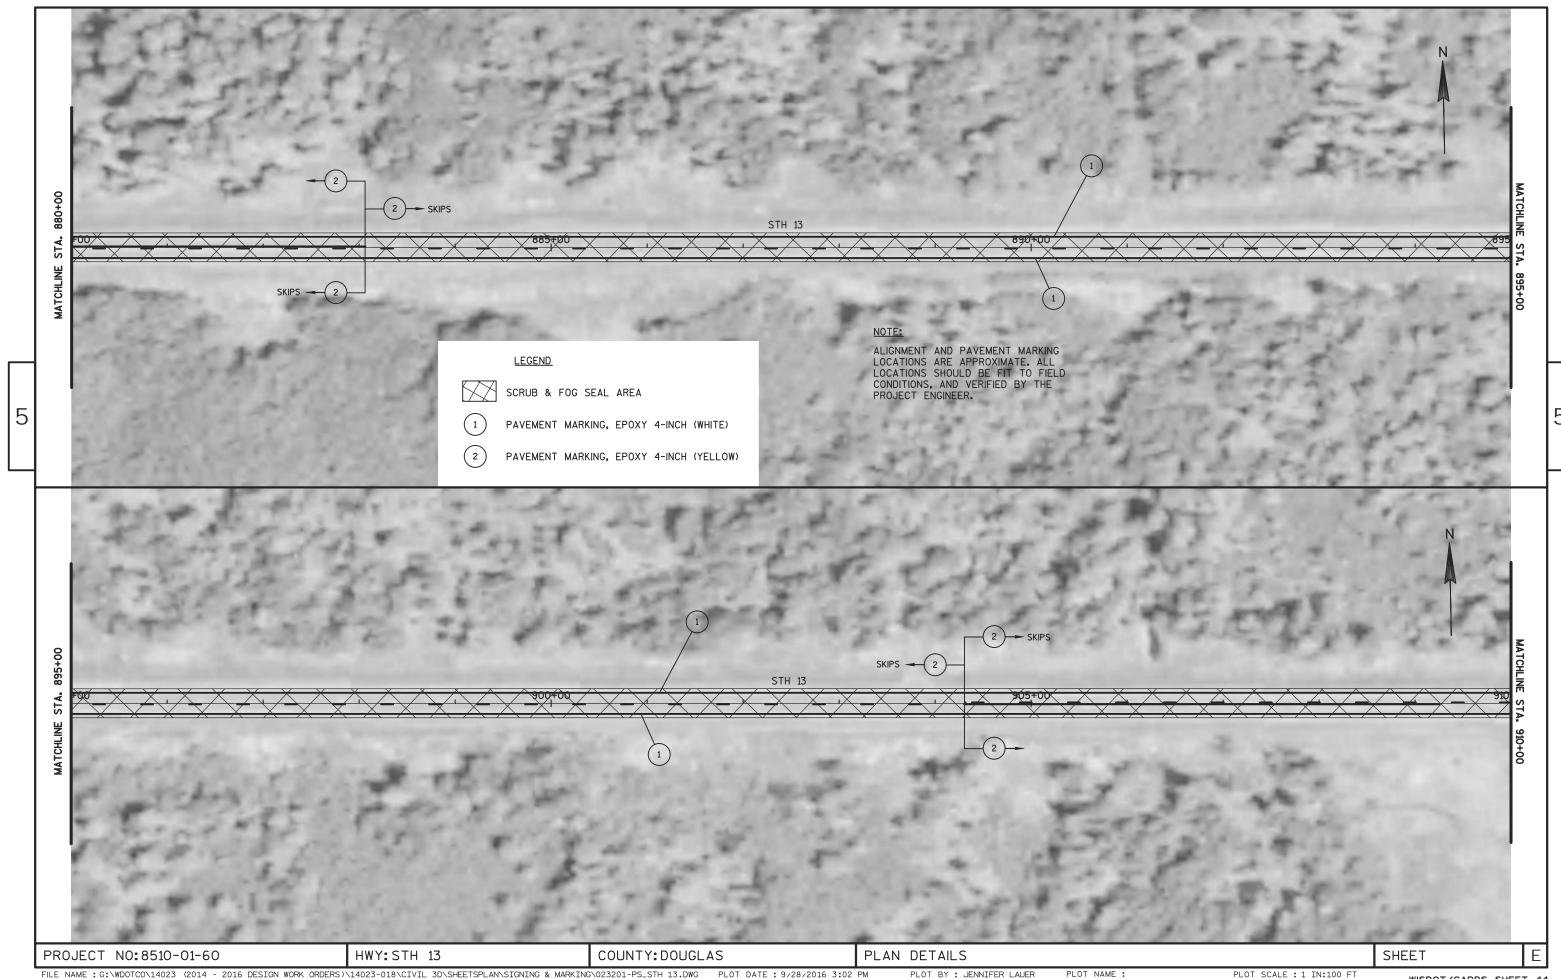



Standard Detail Drawing List

08E10-02	INLET PROTECTION TYPE A, B, C AND D
15C04-03	TRAFFIC CONTROL, ADVANCE WARNING SIGNS 45 M.P.H. OR GREATER TWO-WAY UNDIVIDED ROAD OPEN TO TRAFFIC
15C05-03	TRAFFIC CONTROL, ADVANCE WARNING SIGNS 40 M.P.H. OR LESS
15C06-08	SIGNING & MARKING FOR TWO LANE BRIDGES
15C07-13B	PAVEMENT MARKING WORDS
15C07-13C	PAVEMENT MARKING ARROWS
15C08-16A	PAVEMENT MARKING (MAINLINE)
15C08-16B	PAVEMENT MARKING (INTERSECTIONS)
15C08-16C	PAVEMENT MARKING (CLIMBING LANE & PASSING LANE)
15C08-16D	PAVEMENT MARKING (CLIMBING LANE & PASSING LANE)
15C08-16E	PAVEMENT MARKING (LEFT TURN LANE)
15C08-16F	PAVEMENT MARKING (ISLANDS)
15C12-04	TRAFFIC CONTROL FOR LANE CLOSURE (SUITABLE FOR MOVING OPERATIONS)
15C18-03	MEDIAN ISLAND MARKING
15C19-04A	MOVING PAVEMENT MARKING OPERATION TWO-LANE TWO-WAY ROADWAY
15C33-02	STOP LINE AND CROSSWALK PAVEMENT MARKING
15C34-01	STANDARD APPLICATION FOR TEMPORARY RAISED PAVEMENT MARKER, TYPE 2
15D28-03	TRAFFIC CONTROL, WORK ON SHOULDER OR PARKING LANE, UNDIVIDED ROADWAY

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INLET PROTECTION, TYPE A

GENERAL NOTES

INLET PROTECTION DEVICES SHALL BE MAINTAINED OR REPLACED AT THE DIRECTION OF THE ENGINEER.

MANUFACTURED ALTERNATIVES APPROVED AND LISTED ON THE DEPARTMENT'S EROSION CONTROL PRODUCT ACCEPTABILITY LIST MAY BE

WHEN REMOVING OR MAINTAINING INLET PROTECTION, CARE SHALL BE TAKEN SO THAT THE SEDIMENT TRAPPED ON THE GEOTEXTILE FABRIC DOES NOT FALL INTO THE INLET. ANY MATERIAL FALLING INTO THE INLET SHALL BE REMOVED IMMEDIATELY.

- 1) FINISHED SIZE, INCLUDING FLAP POCKETS WHERE REQUIRED, SHALL EXTEND A MINIMUM OF 10" AROUND THE PERIMETER TO FACILITATE MAINTENANCE OR REMOVAL.
- (2) FOR INLET PROTECTION, TYPE C (WITH CURB BOX), AN ADDITIONAL 18" OF FABRIC IS WRAPPED AROUND THE WOOD AND SECURED WITH STAPLES. THE WOOD SHALL NOT BLOCK THE ENTIRE HEIGHT OF THE CURB BOX OPENING.
- (3) FLAP POCKETS SHALL BE LARGE ENOUGH TO ACCEPT WOOD 2X4.



INLET PROTECTION, TYPE C (WITH CURB BOX)

INSTALLATION NOTES

TYPE B & C

TRIM EXCESS FABRIC IN THE FLOW LINE TO WITHIN 3" OF THE GRATE.

THE CONTRACTOR SHALL DEMONSTRATE A METHOD OF MAINTENANCE, USING A SEWN FLAP, HAND HOLDS OR OTHER METHOD TO PREVENT ACCUMULATED SEDIMENT FROM ENTERING THE INLET.

TYPE D

DO NOT INSTALL INLET PROTECTION TYPE D IN INLETS SHALLOWER THAN 30", MEASURED FROM THE BOTTOM OF THE INLET TO THE TOP OF THE GRATE.

TRIM EXCESS FABRIC IN THE FLOW LINE TO WITHIN 3" OF THE GRATE.

THE INSTALLED BAG SHALL HAVE A MINIMUM SIDE CLEARANCE, BETWEEN THE INLET WALLS AND THE BAG, MEASURED AT THE BOTTOM OF THE OVERFLOW HOLES, OF 3". WHERE NECESSARY THE CONTRACTOR SHALL CINCH THE BAG, USING PLASTIC ZIP TIES, TO ACHIEVE THE 3" CLEARANCE, THE TIES SHALL BE PLACED AT A MAXIMUM OF 4" FROM THE BOTTOM OF THE BAG.

INLET PROTECTION TYPE A, B, C, AND D

STATE OF WISCONSIN DEPARTMENT OF TRANSPORTATION

APPROVED

10/16/02

/S/ Beth Cannestra CHIEF ROADWAY DEVELOPMENT ENGINEER 6

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GENERAL NOTES

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THE EXACT NUMBER, LOCATION, AND SPACING OF ALL SIGNS AND DEVICES SHALL BE ADJUSTED TO FIT FIELD CONDITIONS.


THE SPACING BETWEEN TRAFFIC CONTROL SIGNS SHOULD BE ADJUSTED TO NOT CONFLICT WITH AND SHOULD PROVIDE A MINIMUM OF 200 FEET (500 FEET DESIRABLE) CLEARANCE TO EXISTING SIGNS THAT WILL REMAIN IN PLACE.

ALL SIGNS ARE 48"x48" UNLESS OTHERWISE NOTED.

SIGNS THAT WILL BE IN PLACE LESS THAN 7 CONTINUOUS DAYS AND NIGHTS MAY BE MOUNTED ON PORTABLE SUPPORTS.

IF A "STOP" SIGN MUST BE REMOVED FOR A WORK OPERATION, A TEMPORARY "STOP" SIGN SHALL BE PLACED PRIOR TO THE SIGN REMOVAL, OR A FLAGGER SHALL BE PROVIDED UNTIL THE SIGN IS RE-ESTABLISHED.

- * OMIT G20-1 SIGNS IF LENGTH OF WORK AREA IS 2 MILES OR LESS.
- * PLACE ADDITIONAL W20-1A "ROAD WORK AHEAD" SIGN IF WORK AREA WITHIN THE PROJECT IS SEPARATED BY MORE THAN 2 MILES FROM PREVIOUS WORK AREA.

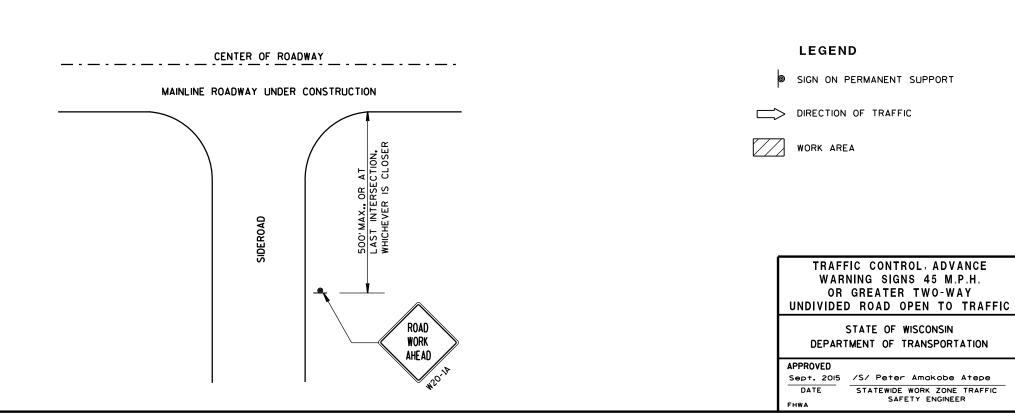

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SAFETY ENGINEER

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GENERAL NOTES

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THE EXACT NUMBER, LOCATION, AND SPACING OF ALL SIGNS AND DEVICES SHALL BE ADJUSTED TO FIT FIELD CONDITIONS.


THE SPACING BETWEEN TRAFFIC CONTROL SIGNS SHOULD BE ADJUSTED TO NOT CONFLICT WITH AND SHOULD PROVIDE A DESIRABLE MINIMUM OF 200 FEET CLEARANCE TO EXISTING SIGNS THAT WILL REMAIN IN PLACE.

ALL SIGNS ARE 48"×48" UNLESS OTHERWISE NOTED. IF NECESSARY DUE TO SPACE CONSTRAINTS, 36"×36" SIGNS MAY BE USED INSTEAD OF 48"×48" SIGNS.

SIGNS THAT WILL BE IN PLACE LESS THAN 7 CONTINUOUS DAYS AND NIGHTS MAY BE MOUNTED ON PORTABLE SUPPORTS.

IF A "STOP" SIGN MUST BE REMOVED FOR A WORK OPERATION, A TEMPORARY "STOP" SIGN SHALL BE PLACED PRIOR TO THE SIGN REMOVAL, OR A FLAGGER SHALL BE PROVIDED UNTIL THE SIGN IS RE-ESTABLISHED.


★ THE THIRD W20-1 SIGN IS REQUIRED ONLY IF THERE IS AN INTERSECTION BETWEEN THE "ROAD WORK 500 FT" SIGN AND THE WORK ZONE. ADJUST THE PLACEMENT OF THIS SIGN BASED ON INTERSECTION LOCATION AND OTHER FIELD CONDITIONS.

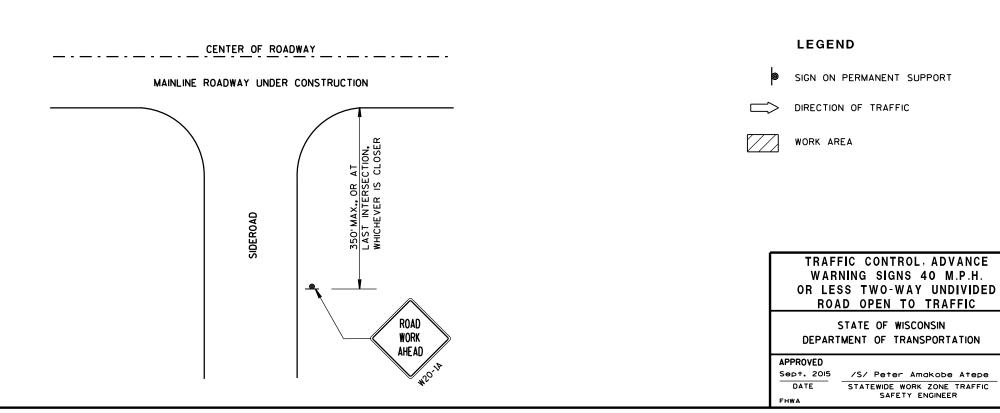



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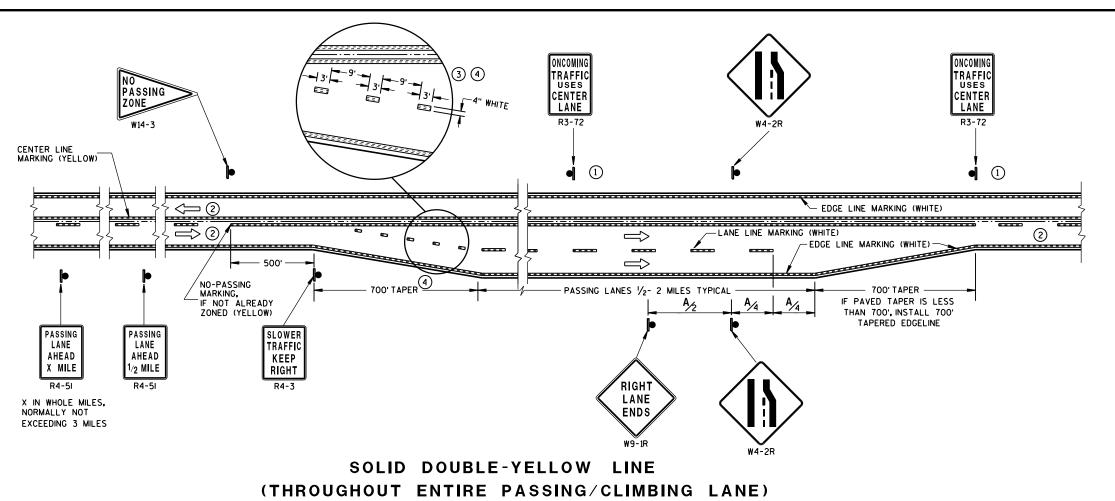






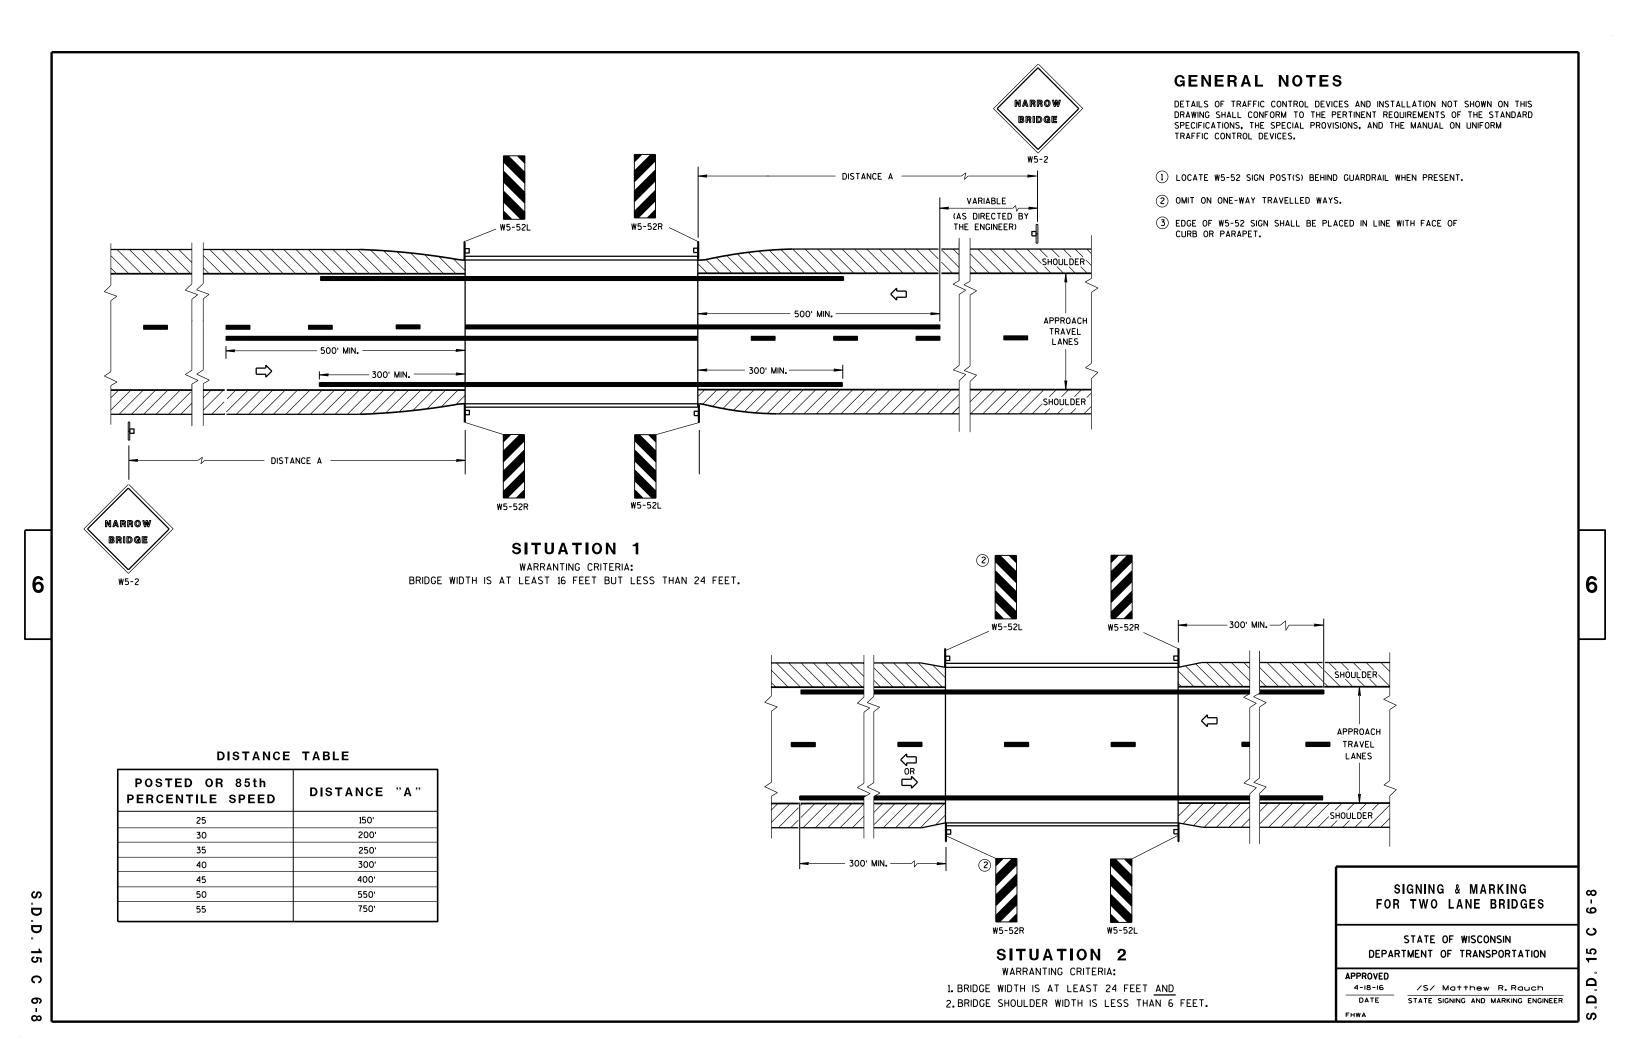

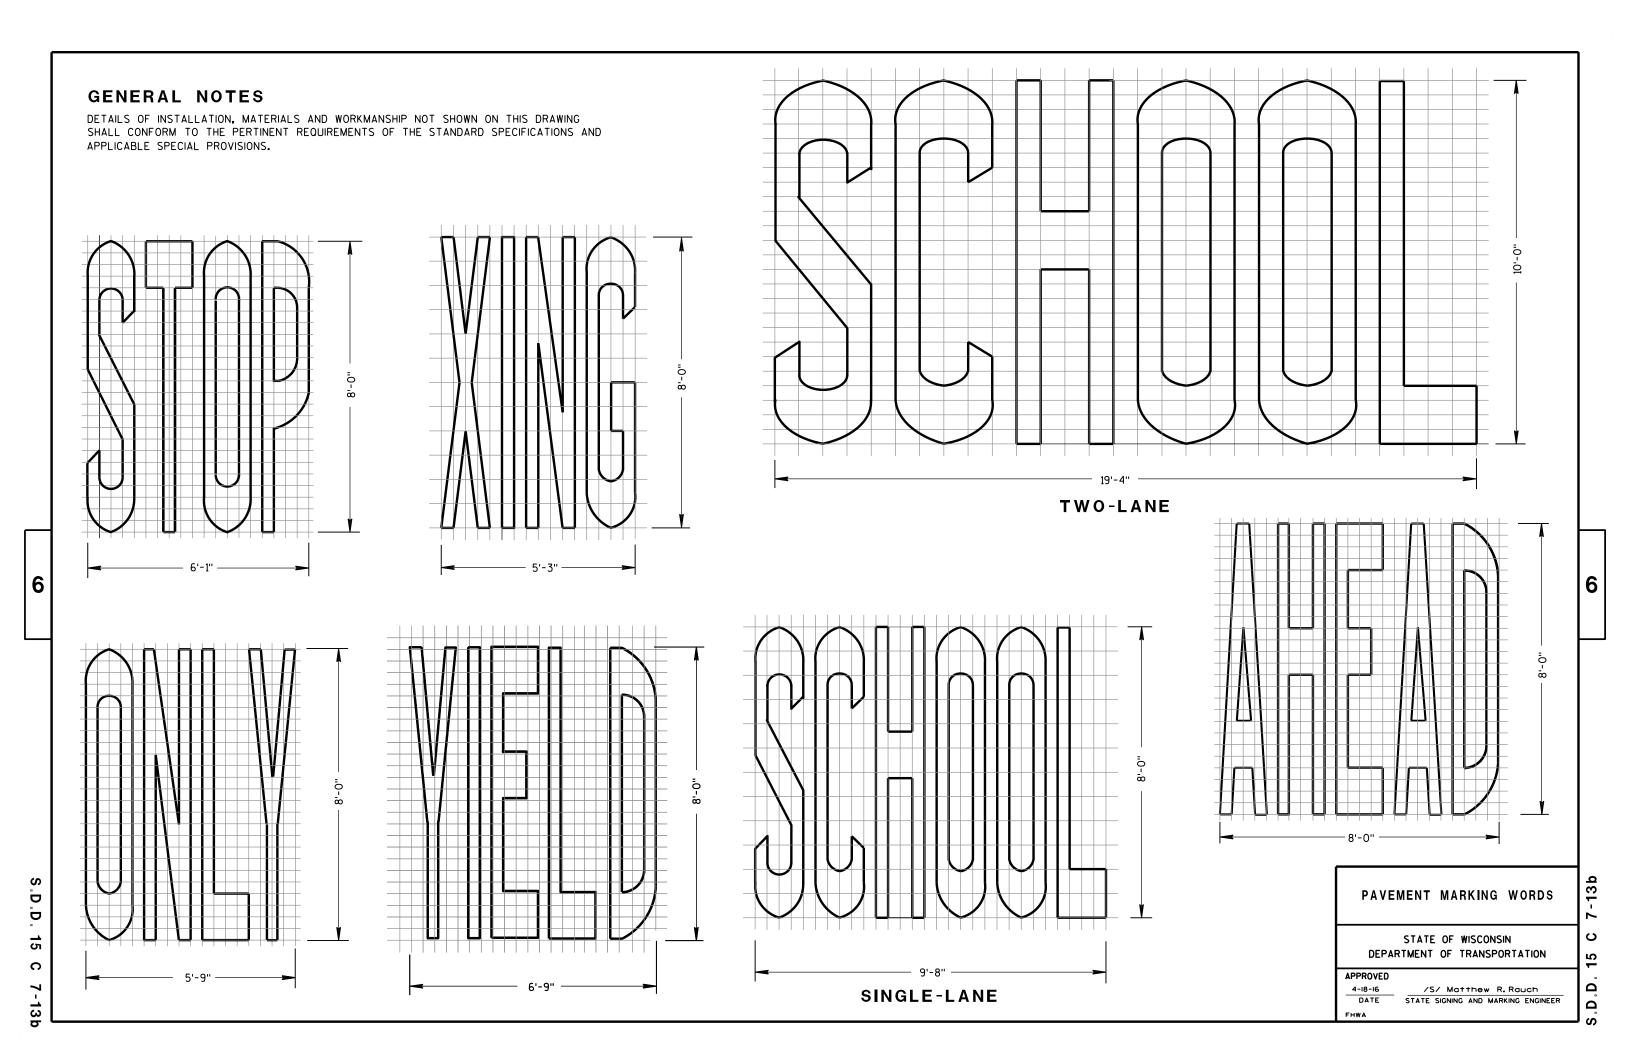

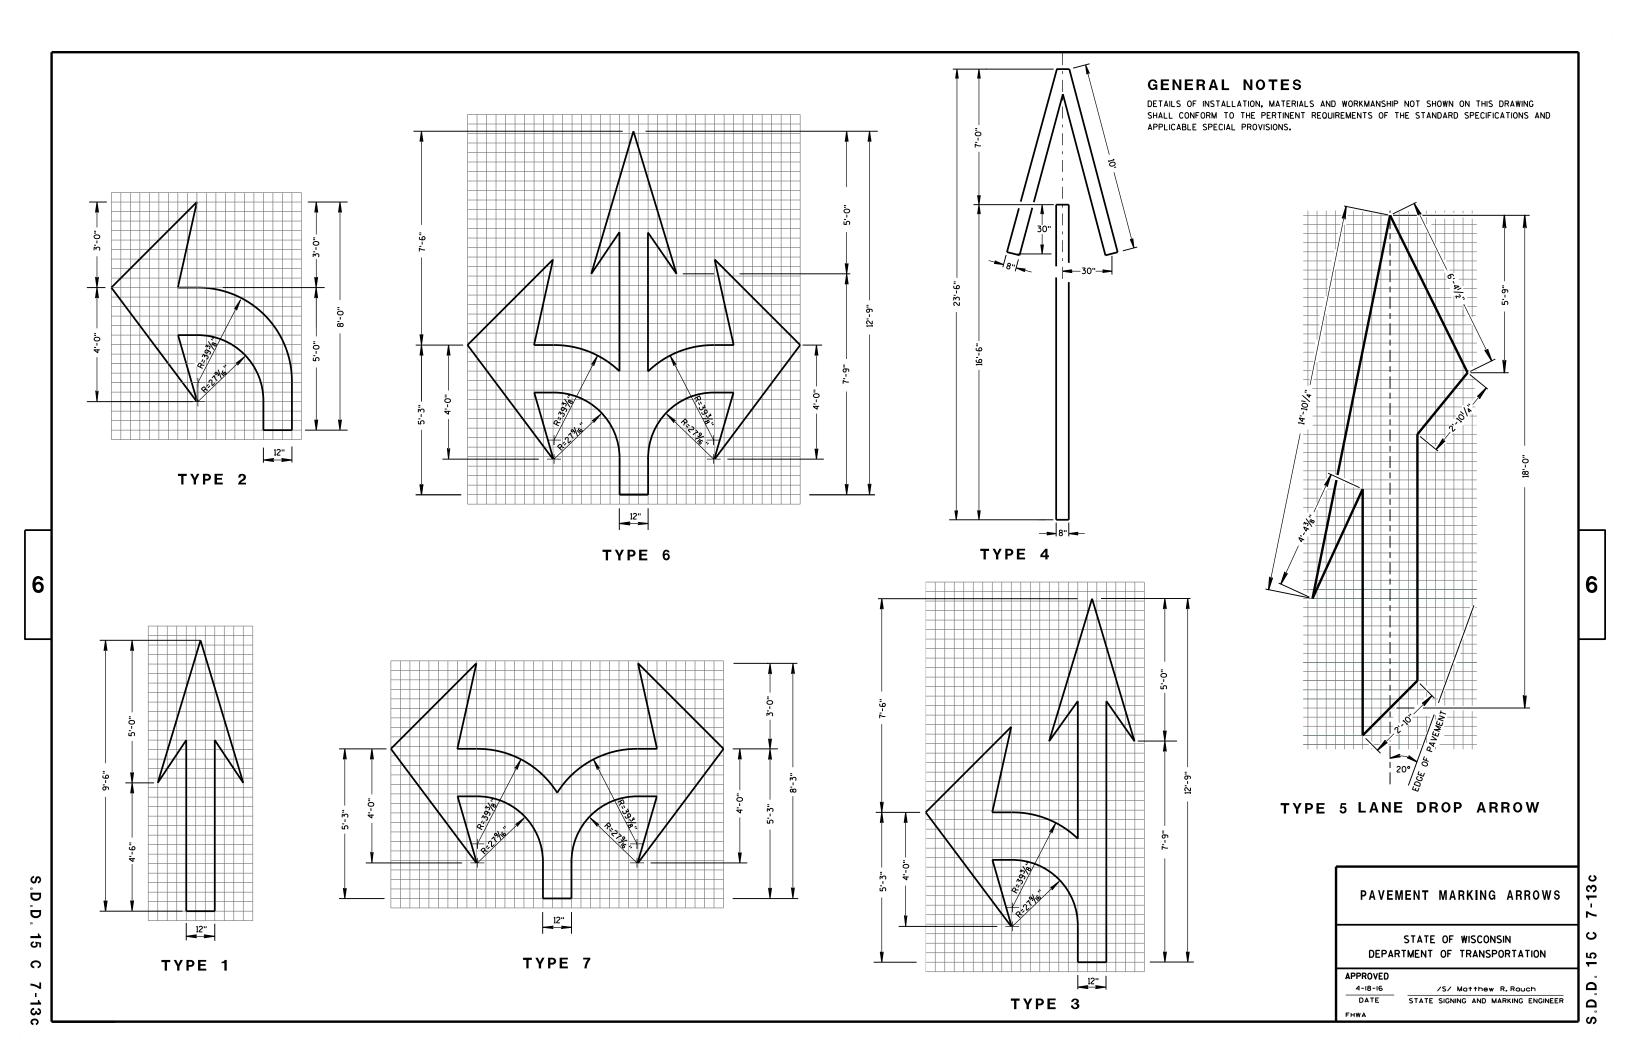


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GENERAL NOTES

- $\ensuremath{\bigcirc}$ Sign shall be repeated at 1 mile increments or at the discretion of the regional traffic engineer.
- (2) THERE MAY BE SOLID YELLOW ON THE CENTERLINE DUE TO SIGHT CONDITIONS.
- 3 THE TAPER LENGTH OF THE DOTTED LINE PAVEMENT MARKING SHALL BE 700 FEET, 3'LINE 9'GAP, EXCEPT RETRACE THE EXISTING LINE-GAP PATTERN WHERE EXISTING MARKINGS ARE IN PLACE.
- WHEN THE ENTRANCE TAPER IS LESS THAN 700 FEET OR THE SHOULDER WIDTH IN THE PASSING/CLIMBING LANE IS LESS THAN THE ADJACENT HIGHWAY, DO NOT INSTALL DOTTED LINE PAVEMENT MARKING.

ARROW SYMBOL (>>) SHOWS DIRECTION OF TRAVEL

DISTANCE TABLE

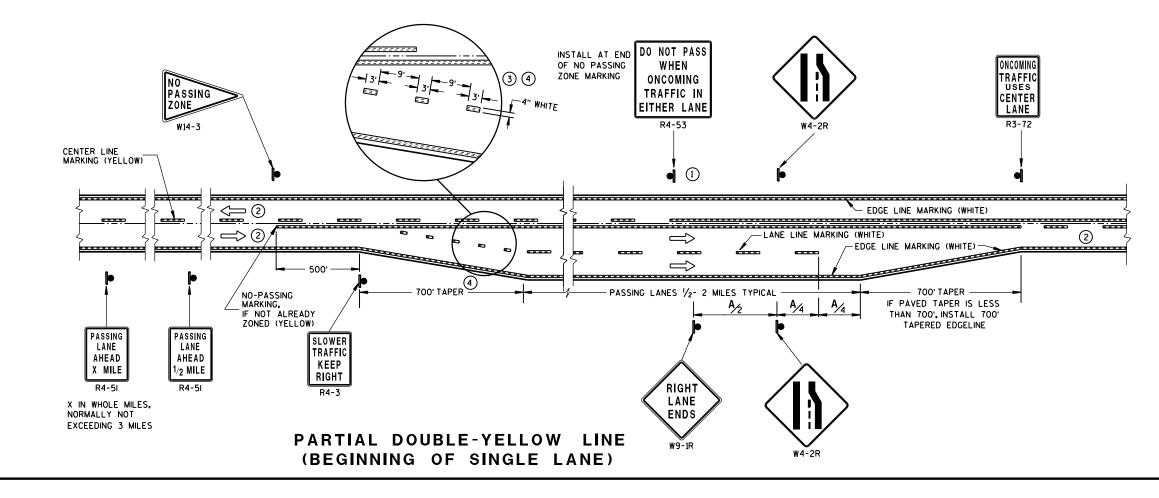POSTED OR 85th PERCENTILE SPEED	DISTANCE "A"
45	750
50	850
55	950


PAVEMENT MARKING & SIGNING
(CLIMBING LANE &
PASSING LANE)

STATE OF WISCONSIN
DEPARTMENT OF TRANSPORTATION

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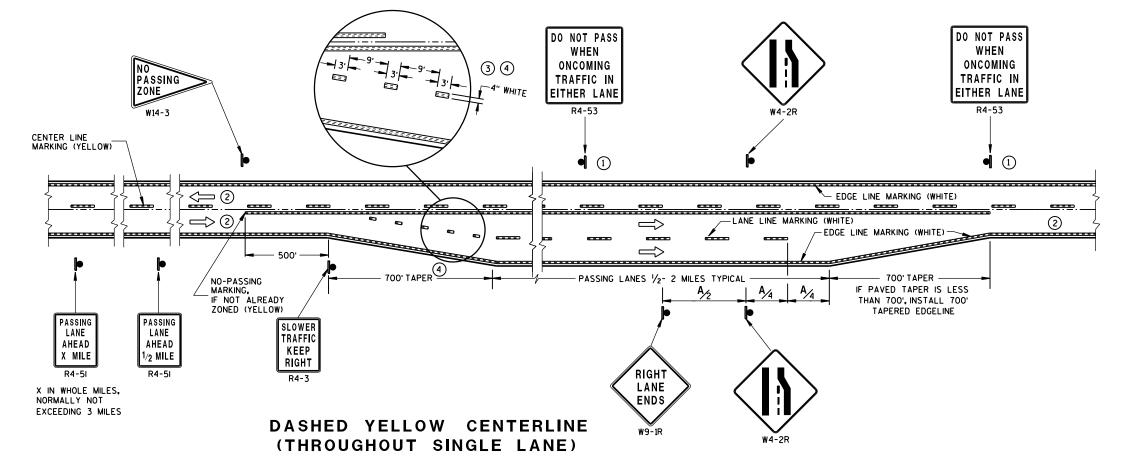
GENERAL NOTES

- \bigodot Sign shall be repeated at $\ensuremath{\mathcal{V}}_2$ mile increments or at the discretion of the regional traffic engineer.
- (2) THERE MAY BE SOLID YELLOW ON THE CENTERLINE DUE TO SIGHT CONDITIONS.
- THE TAPER LENGTH OF THE DOTTED LINE PAVEMENT MARKING SHALL BE 700 FEET, 3'LINE 9'GAP, EXCEPT RETRACE THE EXISTING LINE-GAP PATTERN WHERE EXISTING MARKINGS ARE IN PLACE.
- WHEN THE ENTRANCE TAPER IS LESS THAN 700 FEET OR THE SHOULDER WIDTH IN THE PASSING/CLIMBING LANE IS LESS THAN THE ADJACENT HIGHWAY, DO NOT INSTALL DOTTED LINE PAVEMENT MARKING.

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45	750
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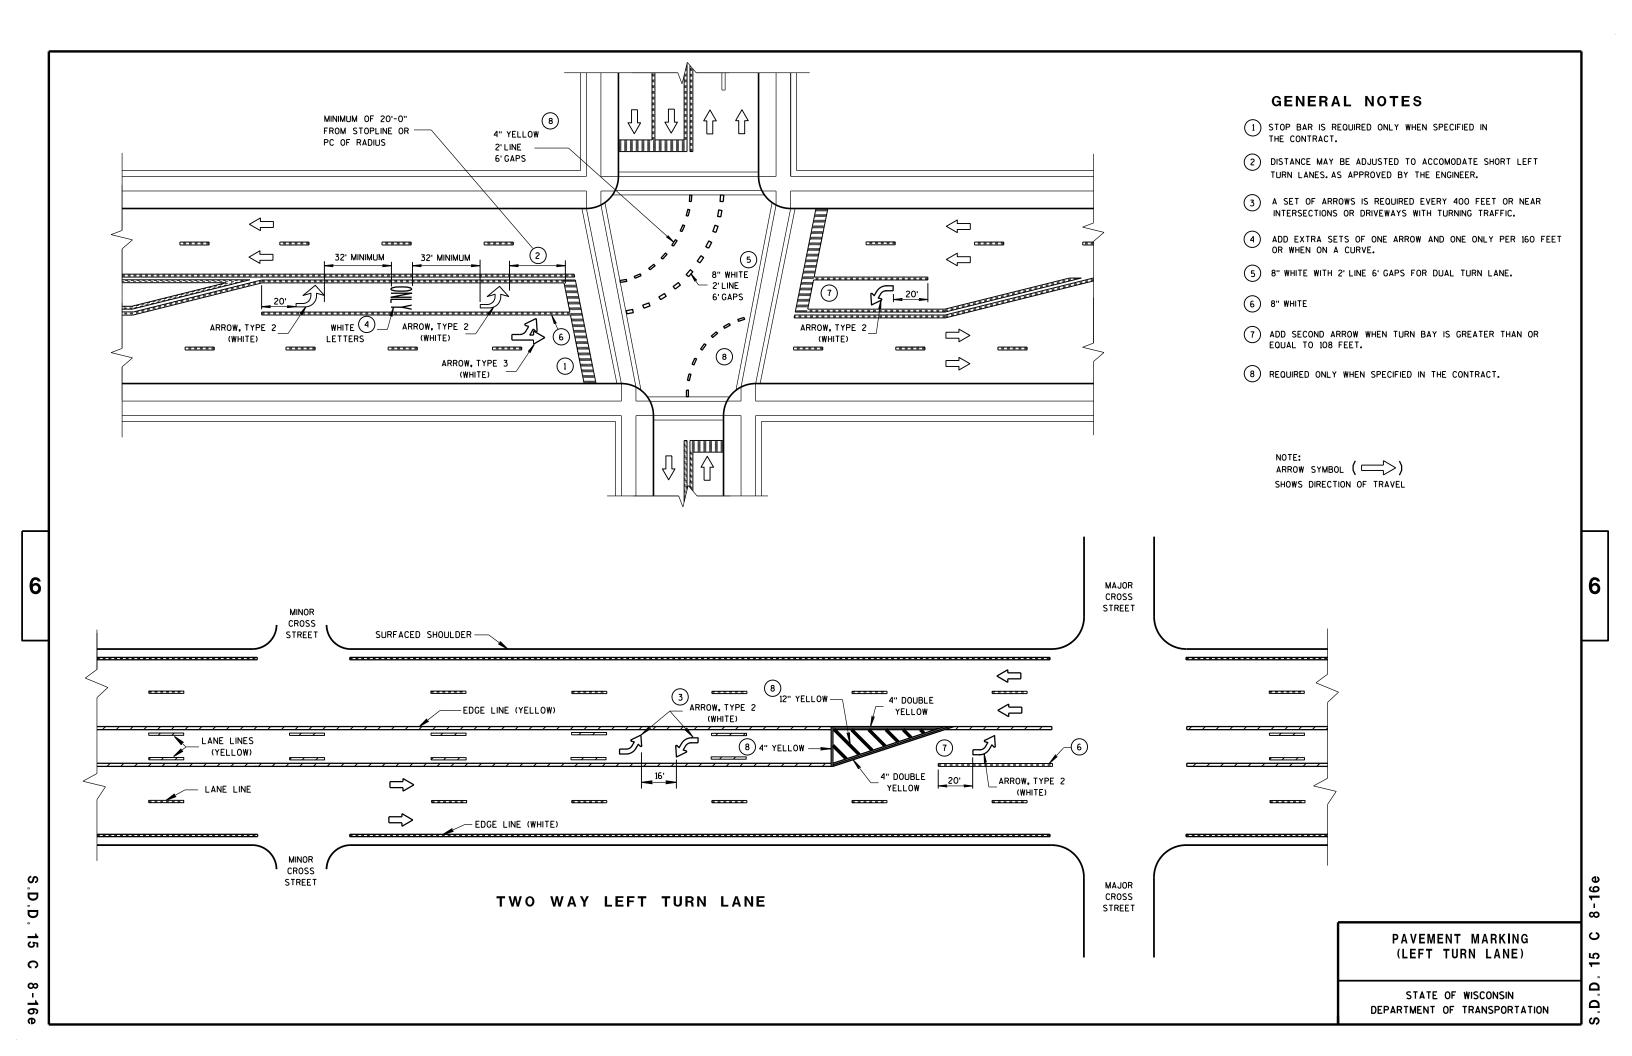


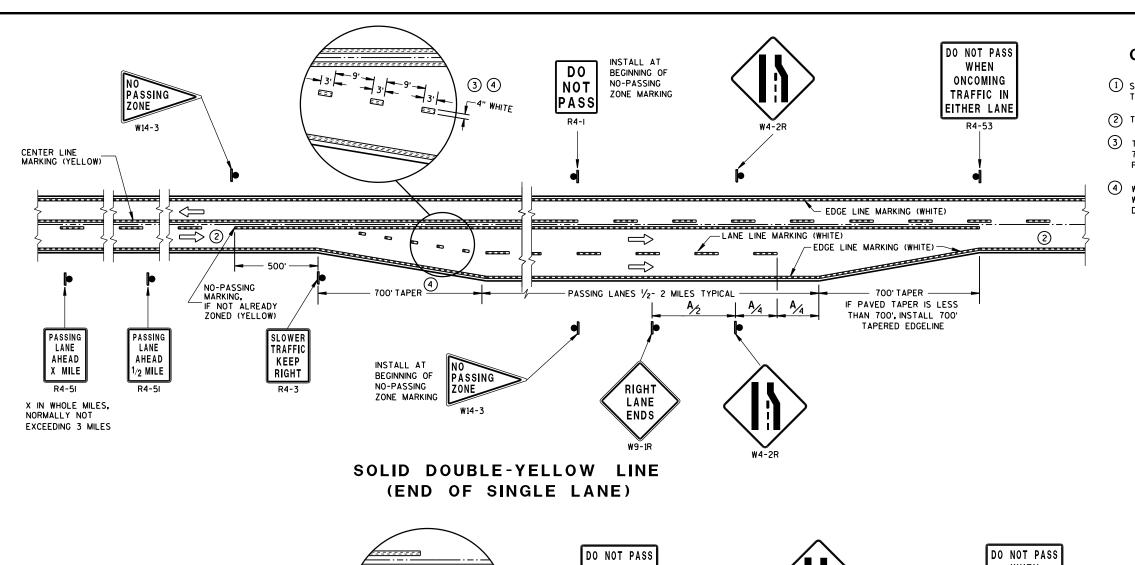
PAVEMENT MARKING & SIGNING (CLIMBING LANE & PASSING LANE)

STATE OF WISCONSIN DEPARTMENT OF TRANSPORTATION


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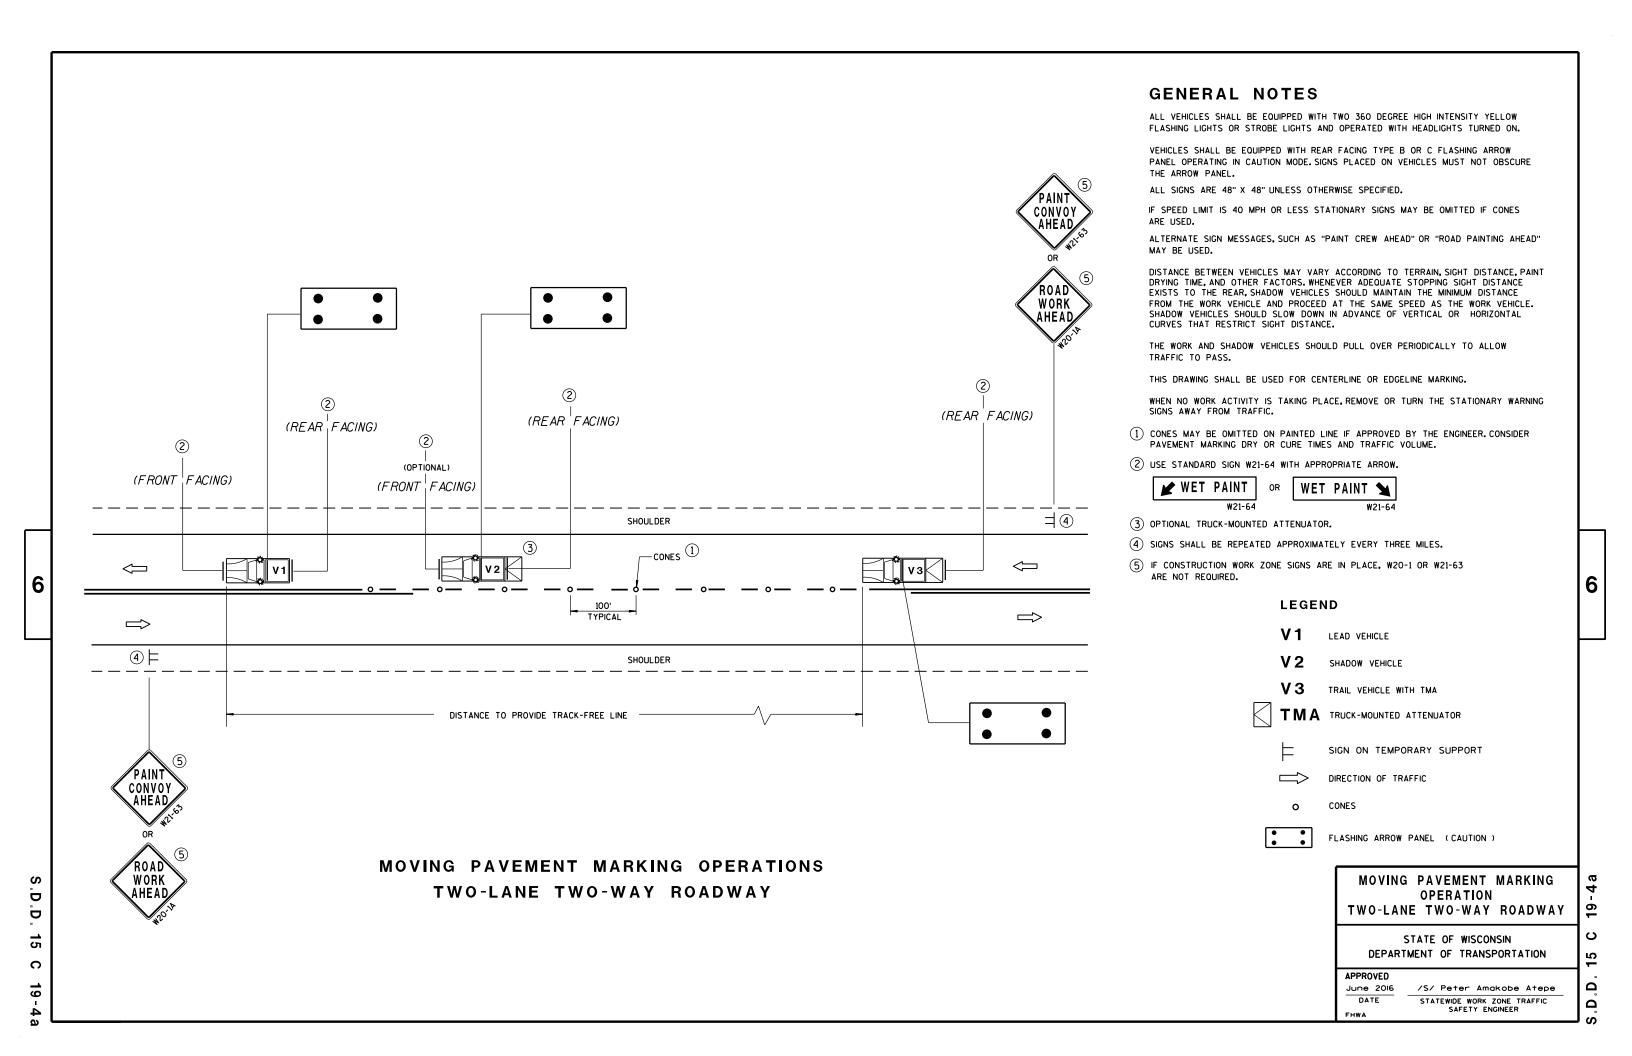
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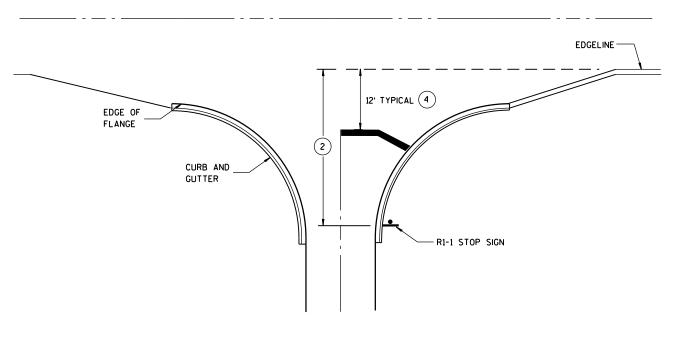






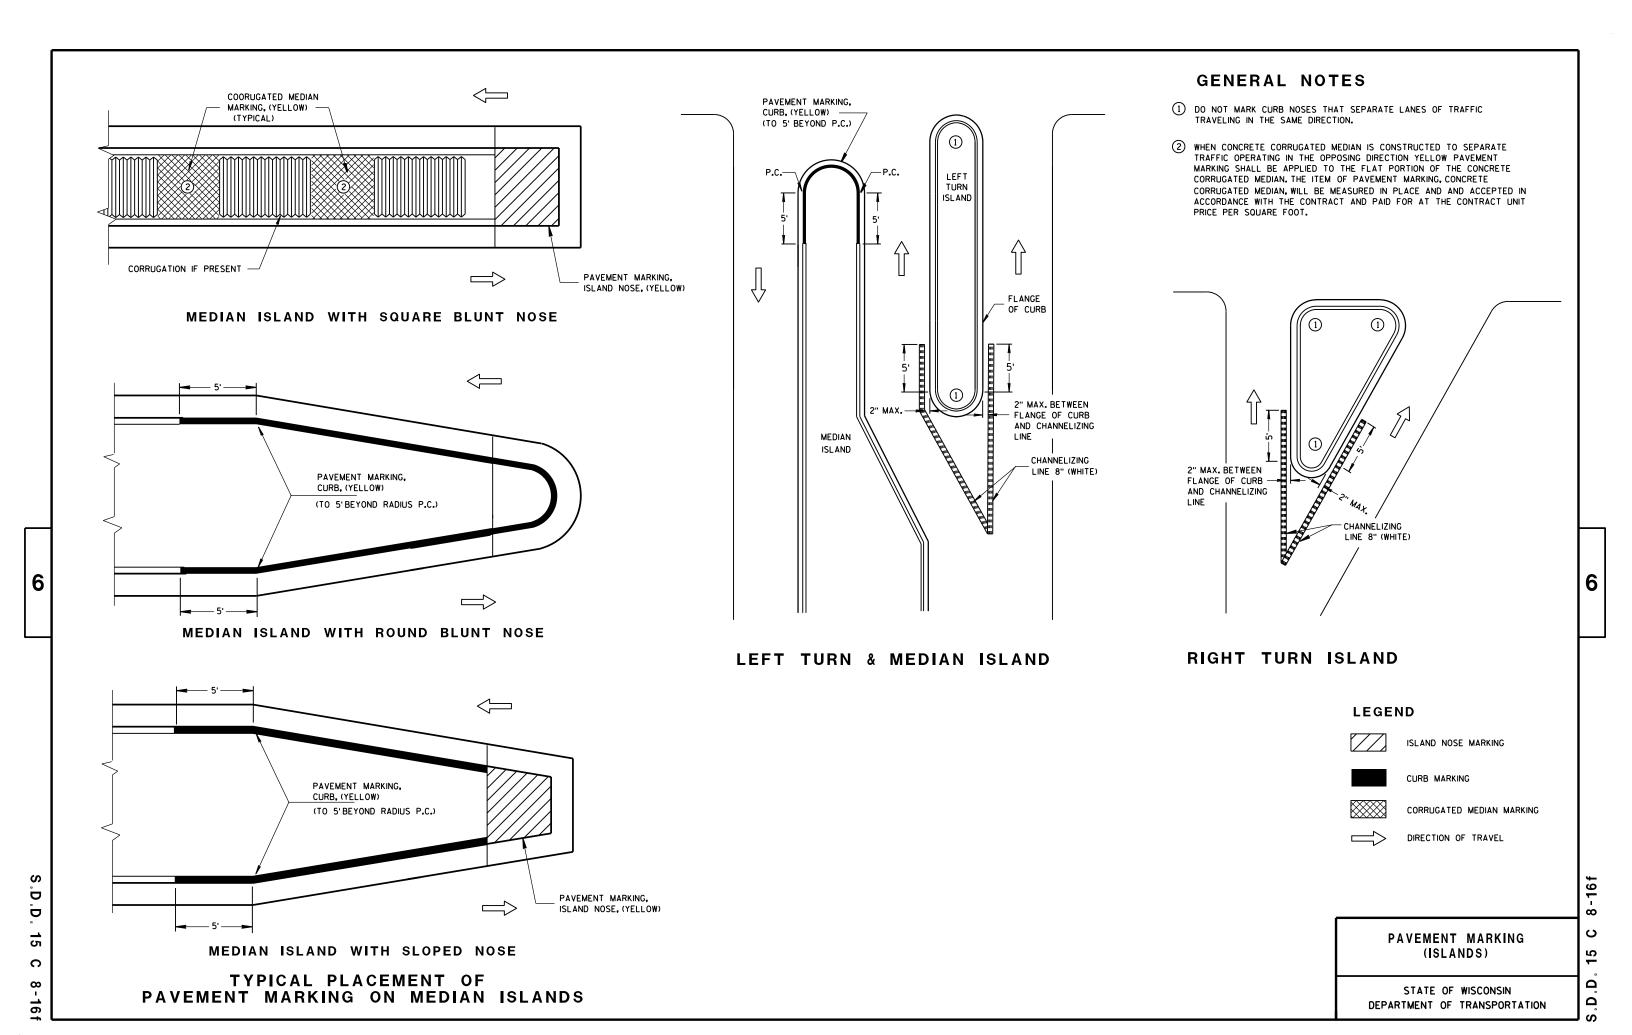



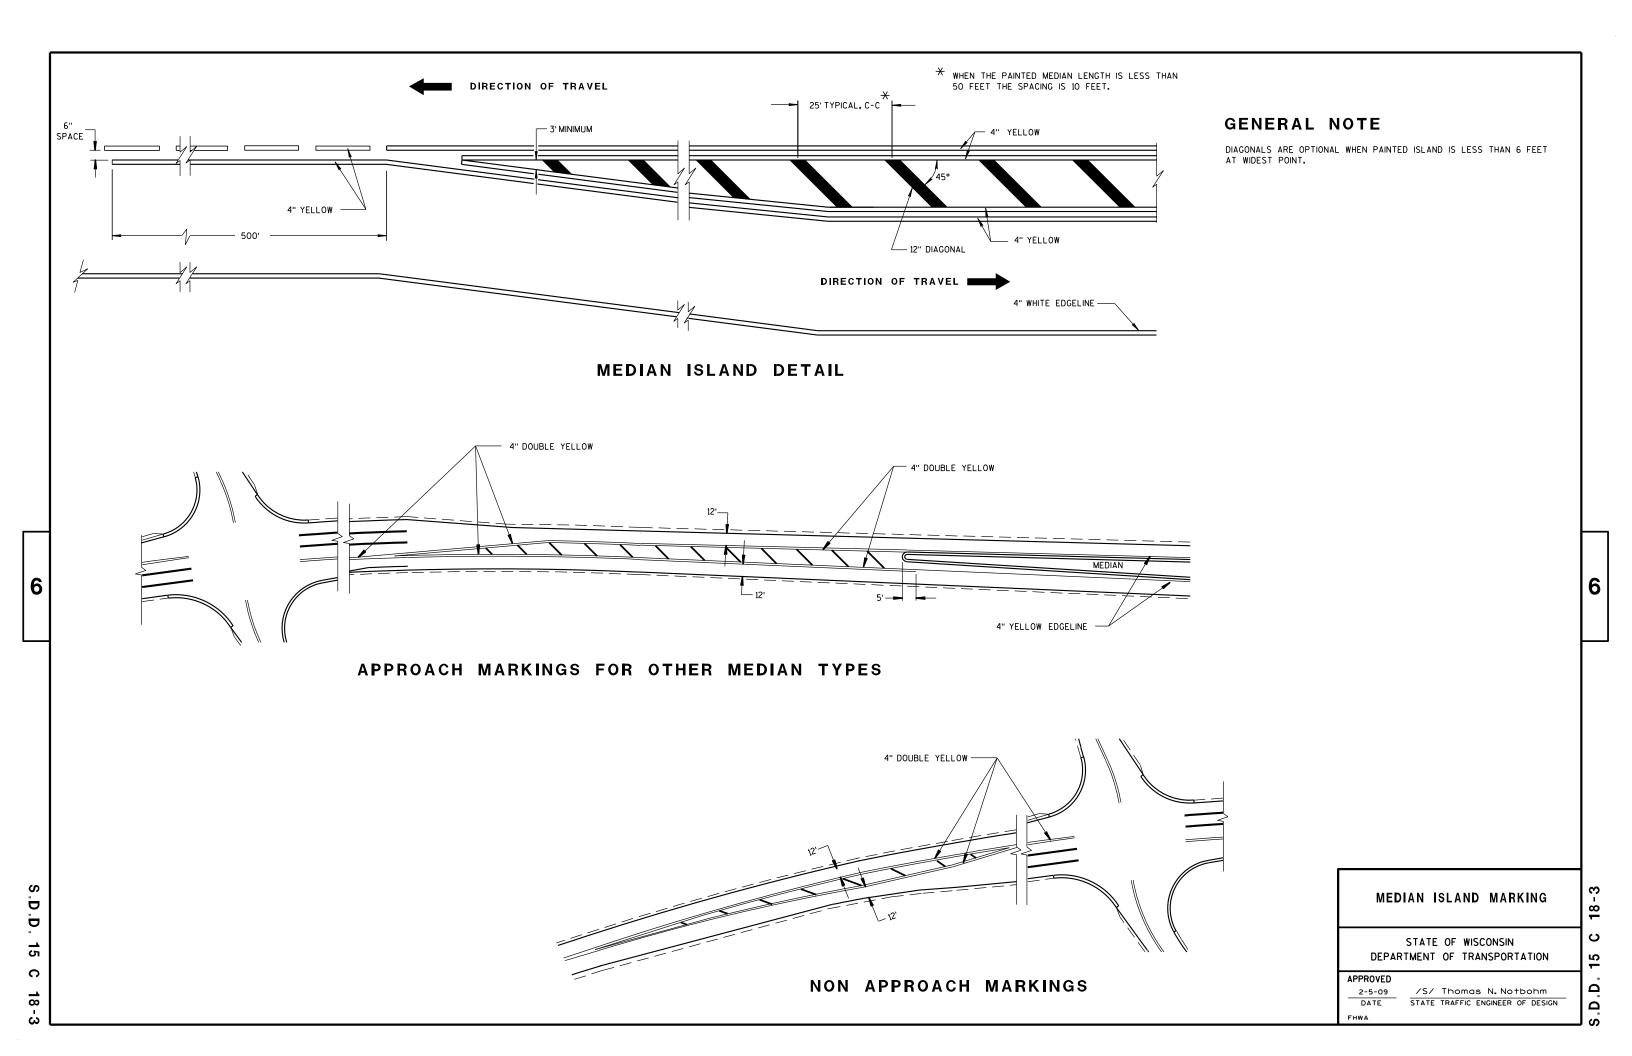

8" CHANNELIZATION WHITE


FLANGELINE (EXTENSION)

4" WHITE EDGELINE


RI-1 STOP SIGN

TYPICAL STOP LINE PAVEMENT MARKING WITH CURB AND GUTTER

TYPICAL STOP LINE PAVEMENT MARKING FOR SIDEROADS WITH RIGHT TURN LANE

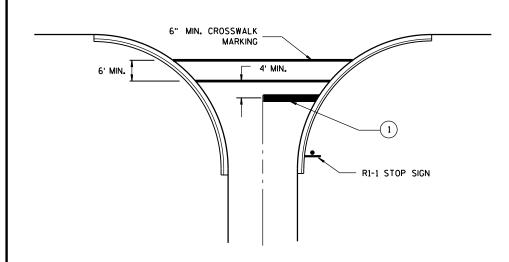

TYPICAL STOP LINE PAVEMENT MARKING FOR SIDEROADS WITH CROSSWALK MARKING

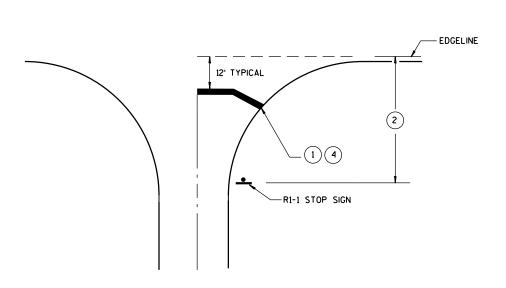

TYPICAL STOP LINE PAVEMENT MARKING WITHOUT CURB AND GUTTER

GENERAL NOTES

- 1 18-INCH STOP LINES MAY BE DELETED OR ADDED BY THE PROJECT ENGINEER BASED ON VISIBILITY AND SIGHT LINES.
- (2) IF STOP SIGN IS LESS THAN OR EQUAL TO 40 FEET FROM THE EDGELINE THAN NO STOP LINE IS REQUIRED.
- (3) IF STOP SIGN IS LESS THAN OR EQUAL TO 30 FEET FROM THE FLANGELINE EXTENSION THAN NO STOP LINE IS REQUIRED.
- MOVE CLOSER TO EDGE OF TRAVEL LANE AS NEEDED FOR VISIBILITY AND SIGHT LINES. (NO CLOSER THAN 4 FEET).

STOP LINE AND CROSSWALK PAVEMENT MARKING

STATE OF WISCONSIN
DEPARTMENT OF TRANSPORTATION

APPROVED	
4-18-2016	/S/ Matthew R. Rauch
DATE	STATE SIGNING AND MARKING ENGINEER

.D.D. 15 C 33-2


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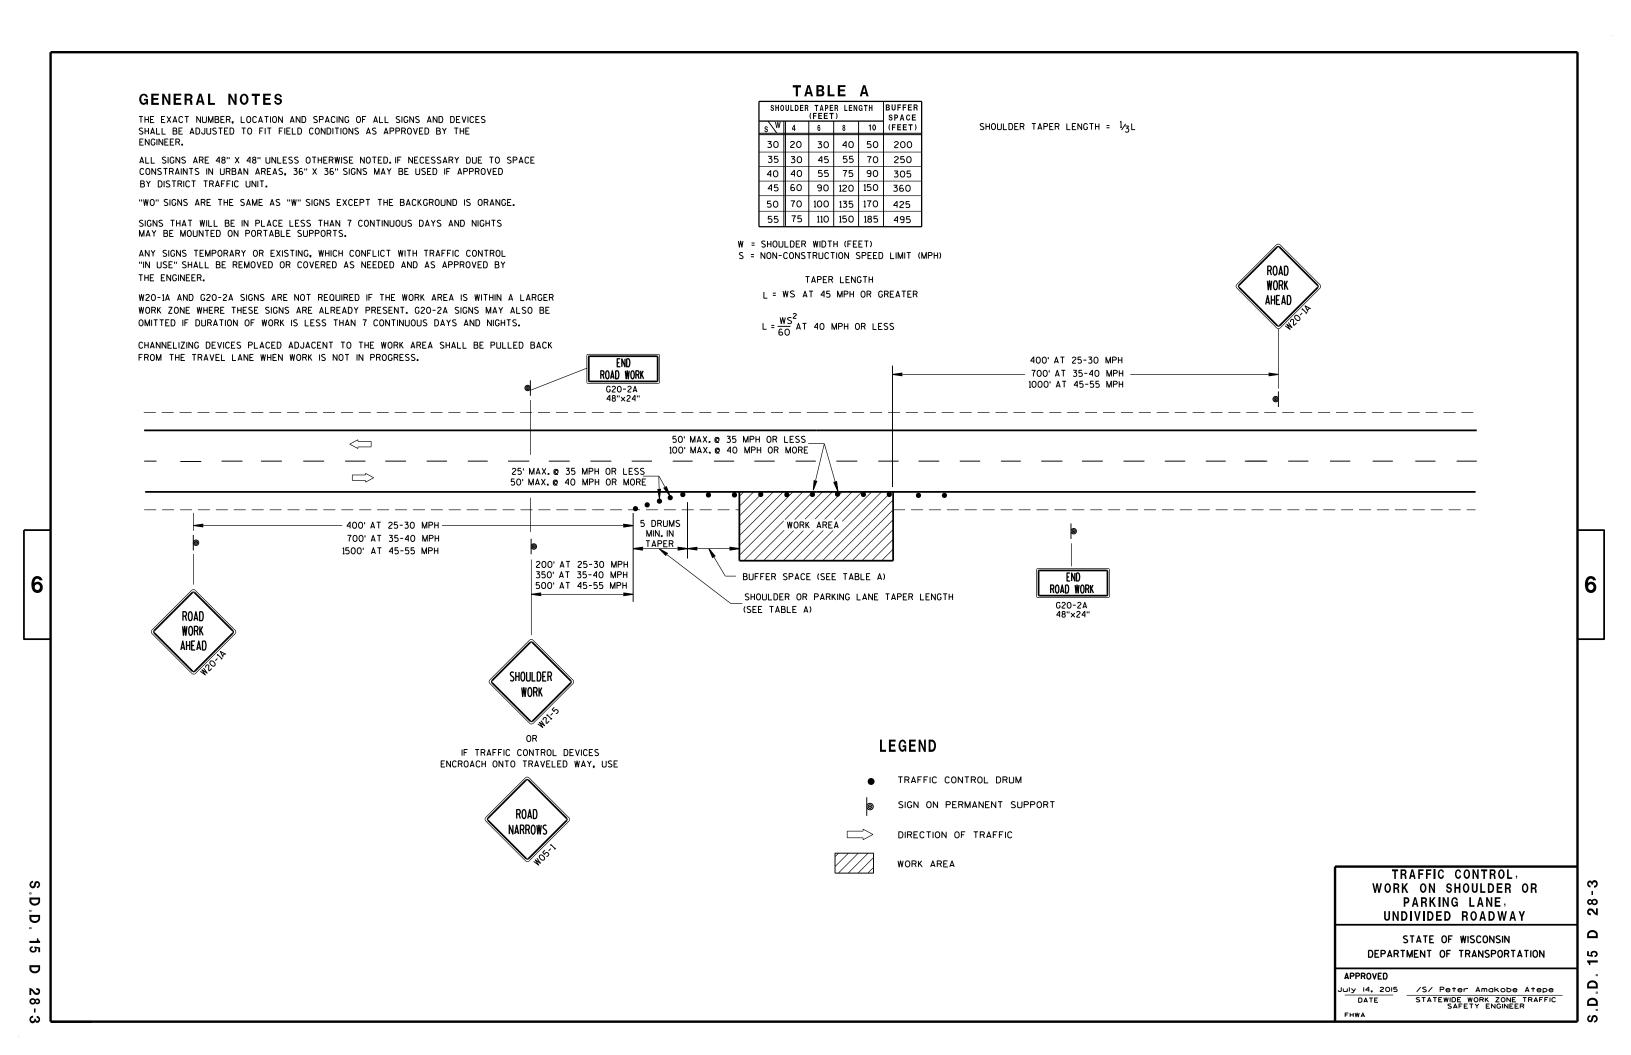
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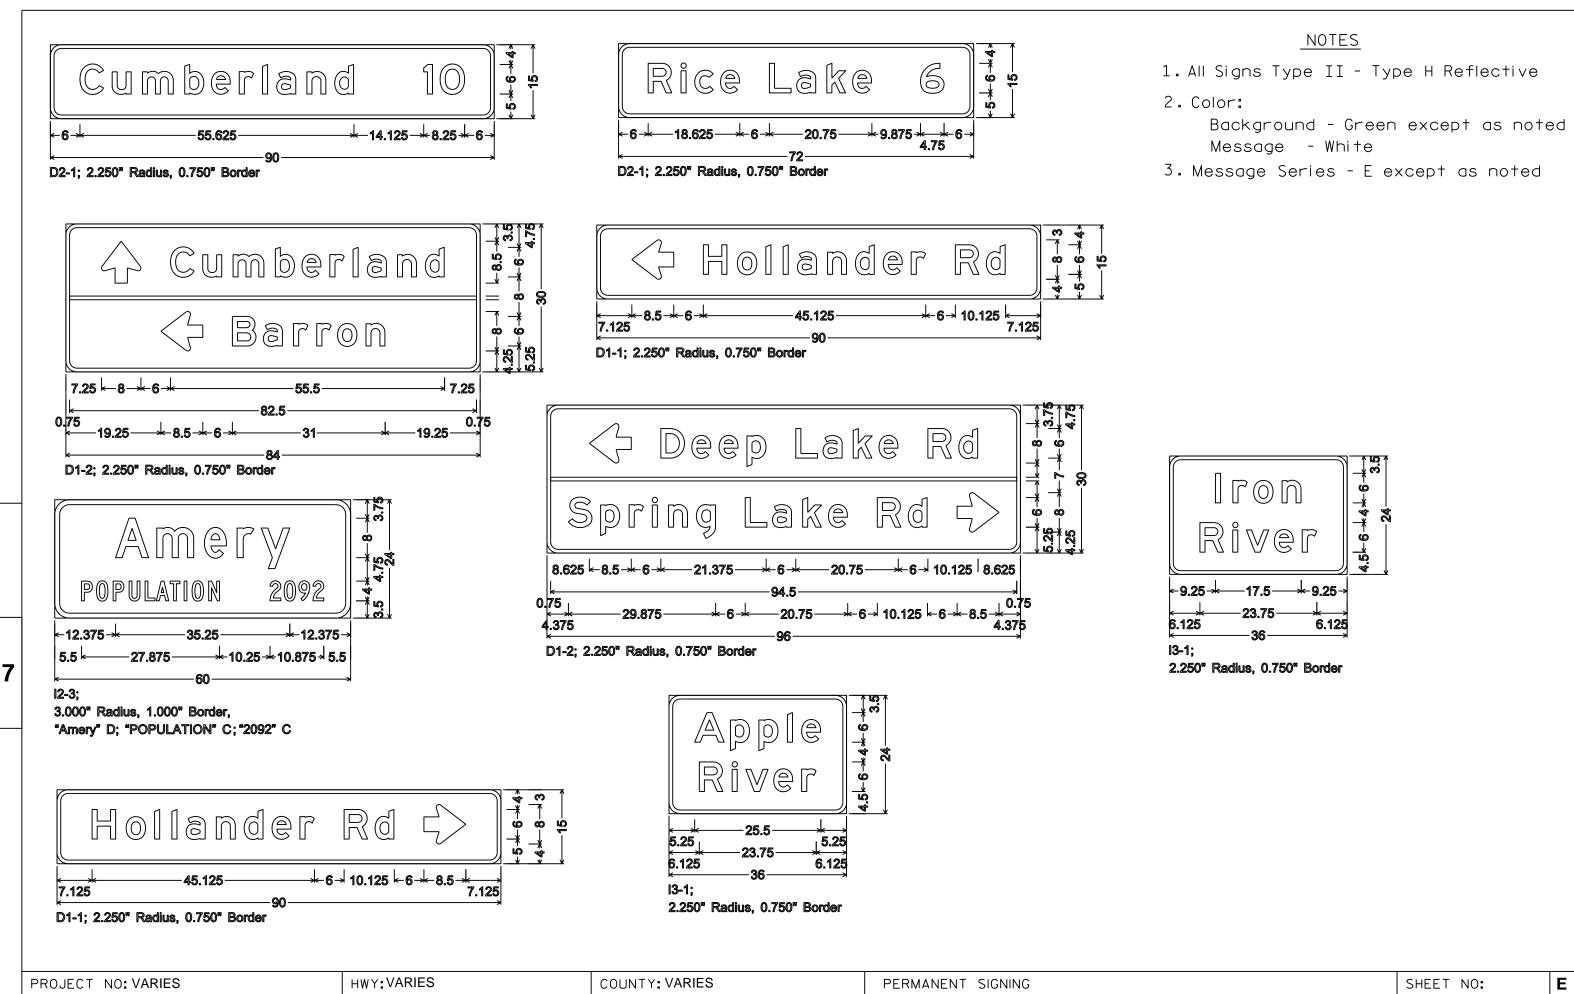
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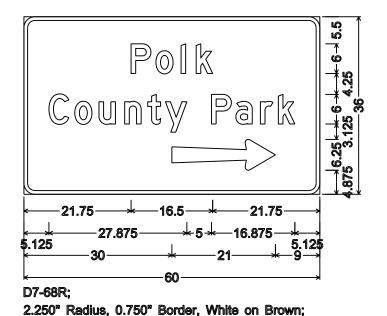





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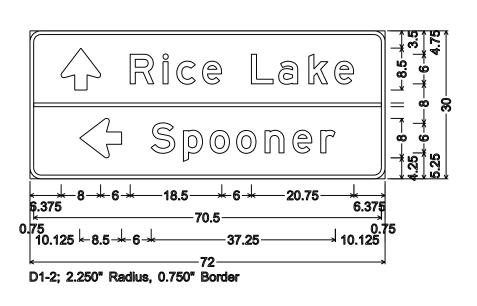
PLOT DATE . 02-NOV-2016 10:31

PLOT SCALE . 19 458419.1 000000

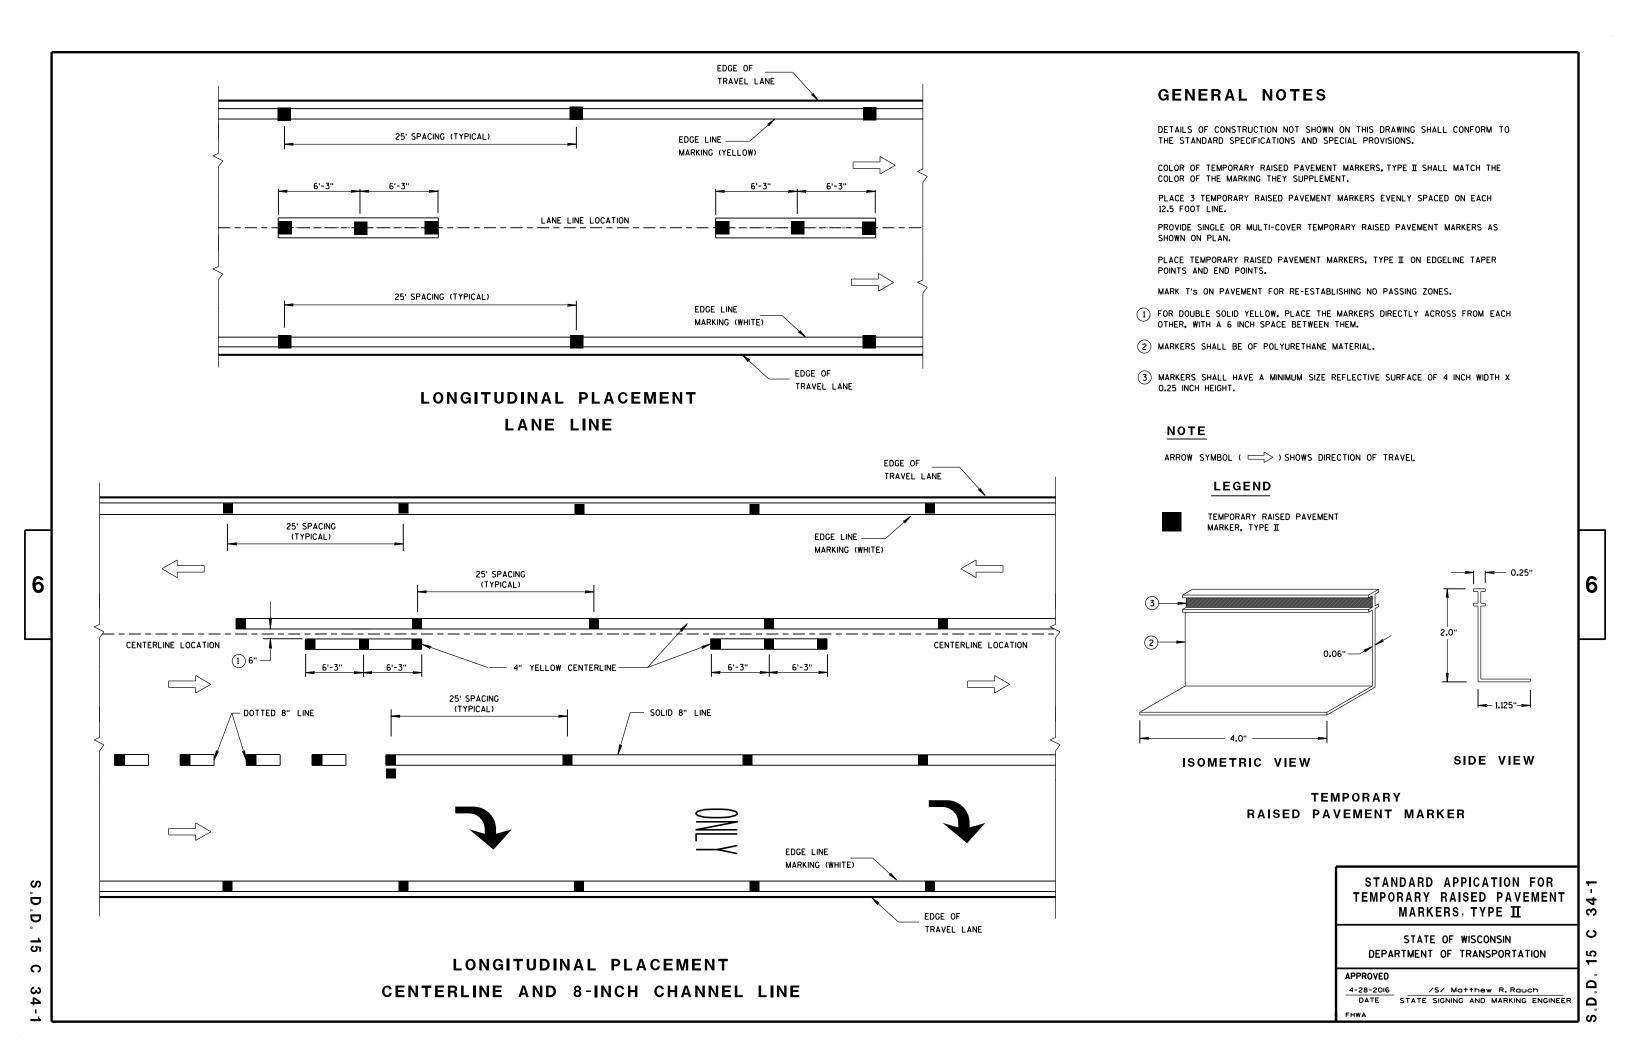


"Polk" D; "County" D; "Park" D




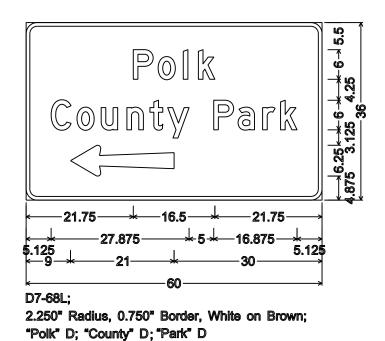

HWY: VARIES

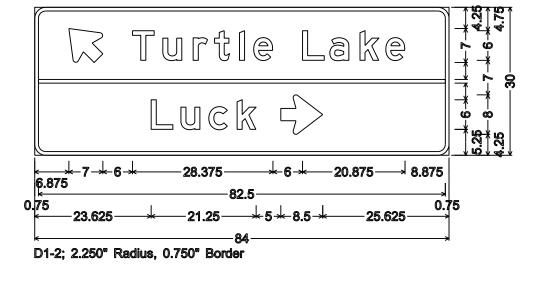

2. Color:

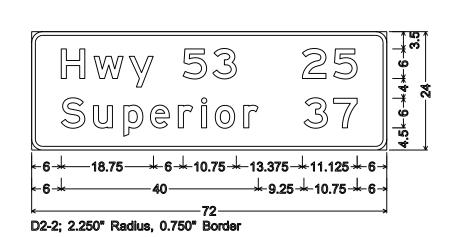

FILE NAME . C.\CAFfiles\Projects\tr d6\6473co16 DGN

PROJECT NO: VARIES

PLOT DATE . 02-NOV-2016 10.39

PLOT BY . \$\$ plotuser \$\$ PLOT NAME :

PLOT SCALE . 19 458419.1 000000

NOTES

Message - White

1. All Signs Type II - Type H Reflective

3. Message Series - E except as noted

Background - Green except as noted

PERMANENT SIGNING

1. Signs are Type II - Type H Reflective - reference WIS DOT Standard

areater than 48 inches (both vertical and horizontal) shall have one horizontal splice between the arrows and route shields. Vertical splices shall not be used on route assemblies with a horizontal dimension of 144 inches or less. The contractor shall not use more than one vertical joint per sign and the joint shall be between route shields.



PROJECT NO:

J32-1

J22-1

J23-1

J33-1

PLOT BY: mscsja

PLATE NO. __A2-15.8

DATE 2/06/14

SHEET NO:

URBAN ARFA



RURAL AREA (See Note 2)



2' Min - 4' Max (See Note 6)



5'-3"(生) D^{-1} Outside Edae of Gravel

White Edgeline Location

** The existence of curb and gutter does not in itself mandate the vertical clearance illustrated. That height is typically measured where

there is sidewalk adjacent to the roadway or parking is permitted. In the absence of sidewalk vertical clearance is measured from the top of the curb. Offset of signs is measured from the flow line.

HWY:

* 6 feet from edge of a paved shoulder or 12 feet from the edge of pavement (edge line location) or 2 feet from outside edge of gravel, whichever is greater unless directed by project engineer.

PLOT BY : mscj9h

GENERAL NOTES

- 1. Signs wider than 4 feet or 20 sq.ft or larger, shall be mounted on multiple posts. Refer to plate A4-4.
- 2. If signs are mounted on barrier wall, see A4-10 sign plate.
- 3. For expressways and freeways, mounting height is $7'-3''(\pm)$ or 6'-3" (±) depending upon existence of a sub-sign.
- 4. Minimum mounting height for J assemblies (A2-1S) is $7'-3''(\pm)$ or $6'-3''(\pm)$ per urban or rural detail respectively.
- 5. Minimum mounting height for signs mounted on traffic signal poles is $5' - 3'' (\pm)$.
- 6. Offset distance shall be consistent with existing signs or consistent throughout length of project.
- 7. The (+) tolerance for mounting height is 3 inches.
- 8. Folding signs shall be mounted at a height of 5'-3'' (\pm) or as directd by the Engineer.
- 9. The Double Arrow sign (W12-1) shall be mounted at a height of 2'-3" (\pm) . The Chevron sign (W1-8), Roundabout Chevron panel (R6-4B), Enhanced Reference Markers, Clearance Markers (W5-52), Mile Markers (D10 series), In Road Object Markers (W5-54) & End of Road Markers (W5-56) shall be mounted at a height of 4'-3'' (\pm).

POST EMBEDMENT DEPTH

Area of Sign	
Installation	D
(Sq. Ft.)	(Min)
20 or Less	4'
Greater than 20	5'

TYPICAL INSTALLATION OF PERMANENT TYPE II SIGNS ON SINGLE POSTS

WISCONSIN DEPT OF TRANSPORTATION

SHEET NO:

APPROVED

for State Traffic Engineer

DATE 7/23/15

PLATE NO. <u>A4-3.20</u>

FILE NAME : C:\CAEfiles\Projects\tr_stdplate\A43.DGN

PROJECT NO:

PLOT DATE: 23-JUL-2015 15:21

COUNTY:

PLOT NAME :

PLOT SCALE: 99.237937:1.000000



NOTES: 1. ALL MATERIAL TO BE APPROVED

BY ENGINEER PRIOR TO INSTALLATION

- 2. SEE SIGN PLATE A4-8 FOR SIGN HARDWARE REQUIREMENTS
- 3. 18 INCH X 18 INCH SQUARE BOX-OUTS MAY BE USED FOR INSTALLATIONS IN EXISTING CONCRETE OR ASPHALT LOCATIONS.



ELEVATION VIEW

DETAIL OF STEEL 2 X 2 SIGN POST IN BOX-OUT



DETAIL OF WOOD 4 X 6 SIGN POST IN BOX-OUT

HWY:



PLAN VIEW

COUNTY:

FOR NEW CONCRETE/ASPHALT INSTALLATIONS

SIGN POST BOX-OUTS A4-3B

WISCONSIN DEPT OF TRANSPORTATION

For State Traffic Engineer

DATE 1/27/14 PLATE NO. A4-3B.1

SHEET NO:

FILE NAME : C:\CAEFiles\Projects\tr_stdplate\A43B.DGN

PROJECT NO:

PLOT DATE: 27-JAN-2014 09:48

PLOT NAME :

PLOT BY: mscsja

PLOT SCALE: 13.659812:1.000000

APPROVED

GENERAL NOTES

- 1. For 3 or 4 post installations, individual post spacing shall be greater than 3'-6".
- 2. See tables below for required number of posts.
- 3. For expressways and freeways, mounting height is 7'-3'' (±) or 6'-3'' (±) depending upon existence of sub-sign.
- 4. The (±) tolerance for mounting height is 3 inches.
- 5. Minimum mounting height for J assemblies (A2-1S) is 7'-3'' (±) or 6'-3'' (±) per urban or rural detail respectively.
- 6. Offset distance shall be consistent with existing signs or consistent throughout length of project.
- 7. Folding signs shall be mounted at a height of 5'-3" (±) or as directed by the engineer.
- 8. The Double Arrow sign (W12-1) shall be mounted at a height of 2'-3" (±). The Chevron sign (W1-8). Roundabout Chevron panel (R6-4B), Clearance Markers (W5-52), Mile Markers (D10 series), In Road Object Markers (W5-54) & End of Road Markers (W5-56) shall be mounted at a height of 4"-3" (±).
- * 6 feet from edge of a paved shoulder or 12 feet from the edge of pavement (edge line location) or 2 feet from outside edge of gravel, whichever is greater unless directed by project engineer.
- ** The existence of curb and gutter does not in itself mandate the vertical clearance illustrated. That height is typically measured where there is sidewalk adjacent to the roadway or parking is permitted. In the absence of sidewalk vertical clearance is measured from the top of the curb. Offset of signs is measured from the flow line.
- *** See A4-3 sign plate for signs 4' or less in width and less than 20 S.F. in area.

URBAN AREA RURAL AREA (See Note 3) 2'Min - 4'Max (See Note 6) ₩E# FF# 6'-3"(±) 6'-3"(±) 7'-3"(±) ** Curb ****\ Flowline D **7000** White Edgeline D 11 White Edgeline, Location Outside Edae Location

2'Min - 4'Max (See Note 6) 6'-3"(±) Curb Flowline. -11

48" DIAMOND WARNING SIGN

HWY:

_ 26" 5 ' - 3 "(±) White Edgeline Location Outside Edge of Gravel 48" DIAMOND WARNING SIGN

COUNTY:

Outside Edge

of Gravel

	SIGN SHAPE OTHER THAN (TWO POSTS REQUIRED		
	L	E	
* * *	Greater than 48" Less than 60"	12"	
	60" to 120"	L/5	l

SIGN SHAPE OTHER THAN (THREE POSTS REQUIR	
L	E
Greater than 120" less than 168"	12"

SIGN SHAPE OTHER THAN (FOUR POSTS REQUIRE	
L	E
168" and greater	12"

POST EMBEDMENT DEPTH

of Gravel

Area of Sign	
Installation	D
(Sq. Ft.)	(Min)
20 or Less	4'
Greater than 20	5'

TYPICAL INSTALLATION OF TYPE II SIGNS ON MULTIPLE POSTS

Matther

SHEET NO:

FILE NAME : C:\CAEfiles\Projects\tr_stdplate\A44.DGN

PROJECT NO:

PLOT DATE: 23-JUL-2015 15:23

PLOT SCALE: 107.021305:1.000000

WISDOT/CADDS SHEET 42

PLOT NAME :

PLOT BY: mscj9h

WISCONSIN DEPT OF TRANSPORTATION APPROVED

For State Traffic Engineer

PLATE NO. 44-4.14 DATE 7/23/15



Two different fastening systems are shown for illustration purposes. On any individual sign, either one or the other system shall be used. Actual number of fasteners per sign varies with the sign area, but normally there are two. For a single post installation, all signs greater than 9 sq. ft. require the use of 3 fasteners.

ATTACHMENT OF SIGNS
TO POSTS

WISCONSIN DEPT OF TRANSPORTATION

APPROVED

Nather R Raw
For State Traffic Engineer

DATE <u>8/11/16</u>

PLATE NO. <u>44-8.8</u>

PROJECT NO:

FILE NAME : C:\CAFfiles\Projects\tr stdplote\A48 DCN

PLOT DATE . 11-416-2016 11:35

PINT RY * \$\$ nintuser \$\$

SHEET NO:

| | |




PROJECT NO: HWY: COUNTY: SHEET NO: FILE NAME : C:\CAEFiles\Projects\tr_stdplate\A49.DGN PLOT DATE: 05-FEB-2015 17:09 PLOT BY: mscsja PLOT NAME : PLOT SCALE: 13.659812:1.000000

DATE 2/05/15

PLATE NO. <u>A4-9.9</u>

For State Traffic Engineer



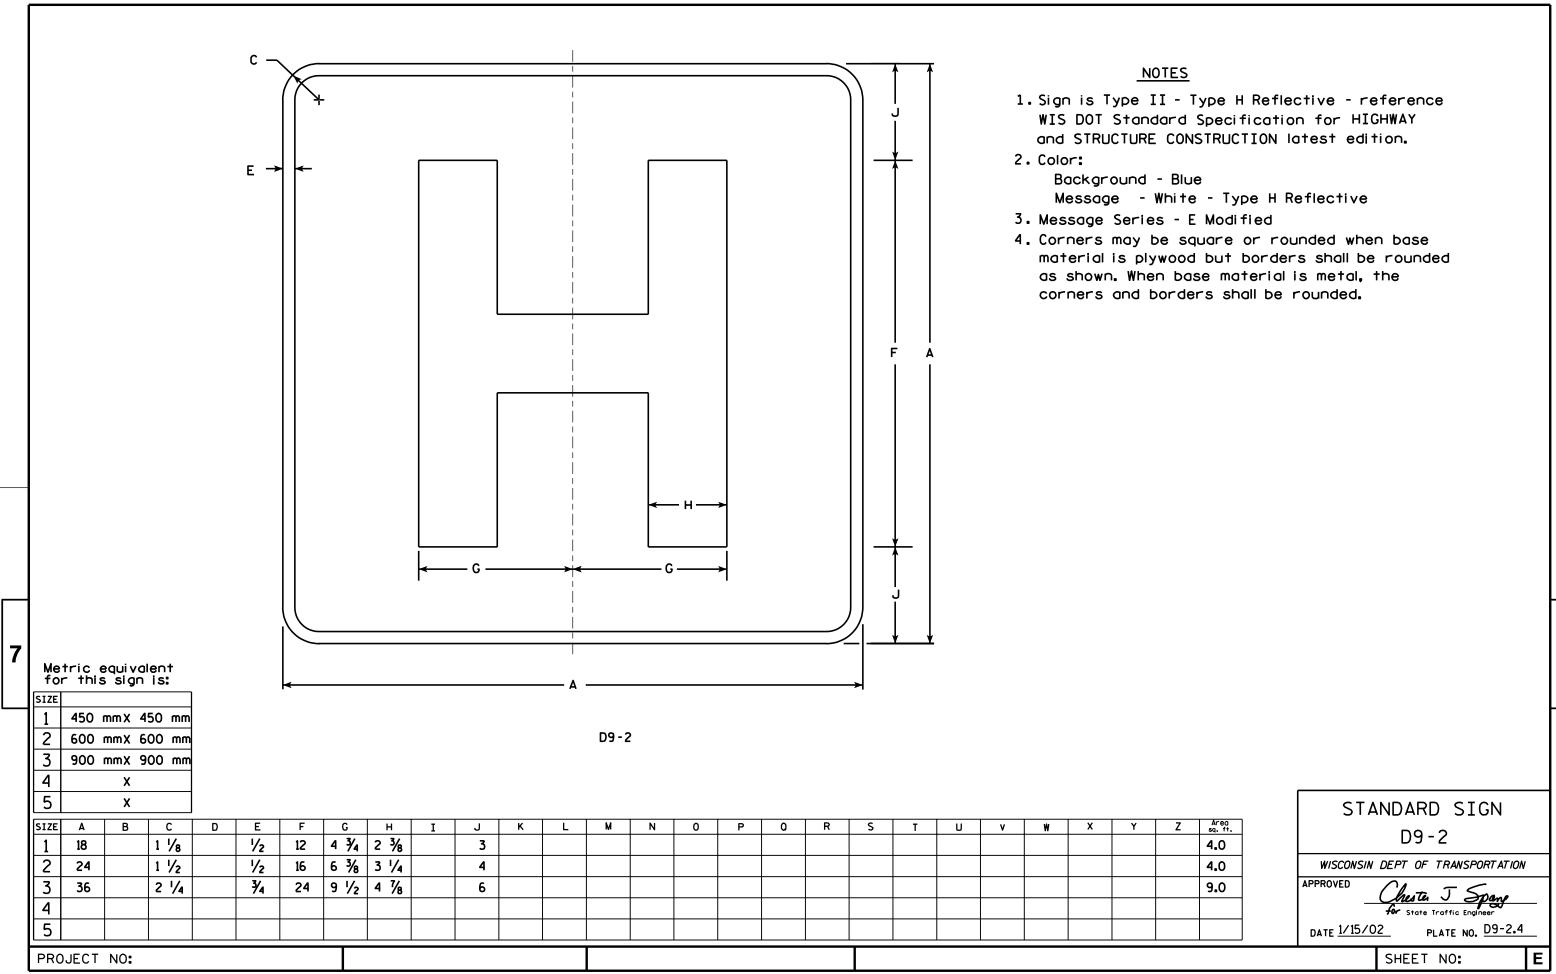

1. Sign is Ty

 Sign is Type II - Type H Reflective - reference WIS DOT Standard Specification for HIGHWAY and STRUCTURE CONSTRUCTION latest edition.

2. Color:

Background - White Message - (See Note 5)

NOTES

- 3. Message Series (See Note 6)
- 4. Corners may be square or rounded when base material is plywood but borders shall be rounded as shown. When base material is metal, the corners and borders shall be rounded.
- 5. Border Blue

Line 1 - Red

Line 2 - Black

Line 3-5 - Blue

6. Line 1 - Dutch 8011L

Line 2 - Series E


Line 3-5 - Series C

7. Contractor shall provide and install a new post bracket in accordance with the I55-56B sign detail.



HWY:

Background Colors of Symbol*

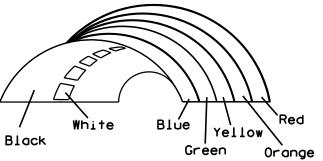

*1/4" Black Border between each color of rainbow and border of rainbow

SIZE	Α	В	С	D	Е	F	G	Н	I	J	K	L	М	N	0	Р	0	R	S	Т	U	٧	W	X	Y	Z	Area sq. ft.
1																											
2	30	36	1 1/2	1/2	5/8	3	2	3 1/2	2 1/8	1	8	2 1/8	11 1/4	11 1/8	9 3/8	1 1/4		3/4	12 %	7 1/2							7.5
3																											
4																											
5																											

COUNTY:

STANDARD SIGN I55-56

WISCONSIN DEPT OF TRANSPORTATION

APPROVED

Ap

SHEET NO:

SHEET NO:

FILE NAME : C:\Users\PROJECTS\tr_stdplate\I5556.DGN

PROJECT NO:


PLOT DATE: 27-APR-2011 10:05

PLOT BY: mscj9h


PLOT NAME :


PLOT SCALE: 7.945391:1.000000

ISOMETRIC VIEW

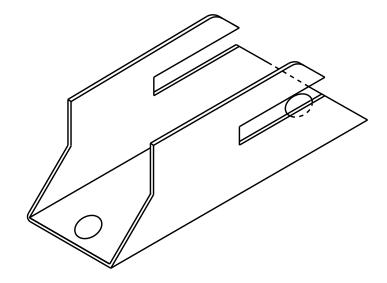


TOP VIEW

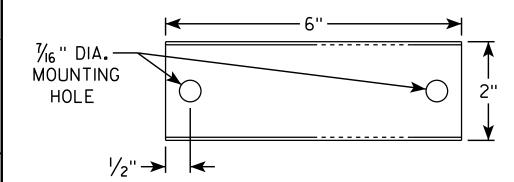

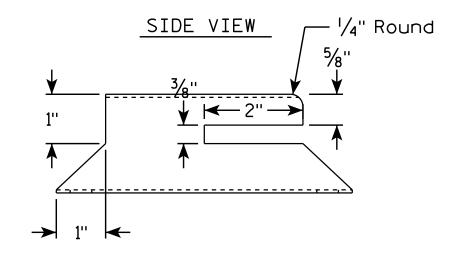

HWY:


END VIEW

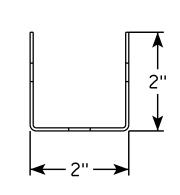

COUNTY:

NOTES

- Must be capable of permanent attachment to a wood or steel channel sign post utilizing the fastening hardware specified on the A4-8 sign plate.
- 2. Shall be entirely primed and painted with two coats of a black powder coated enamel paint.
- 3. Shall be made with 12 gauge steel, and incorporate no welds, no hinged components, no threaded lock-type components, and no parts which are loose or can be separated from the main body.
- 4. Shall have rounded edges with at least $\frac{1}{8}$ " radii.
- 5. Shall not have unrounded and uncoated metaledges which can contact the back surface of the roll-up sign.
- 6. Top of bracket shall be mounted 2' below the bottom of the 155-56 sign.
- 7. Cost of bracket and fastening hardware shall be incidental to the 155-56 sign.

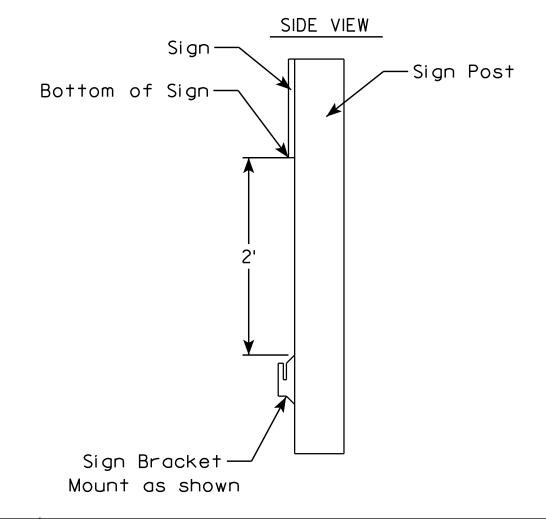

SHEET NO:

PROJECT NO:

PLOT BY : mscj9h


DATE 4/26/16

PLATE NO.155-56B.2

ROLLUP SIGN BRACKET

155-56B

WISCONSIN DEPT OF TRANSPORTATION

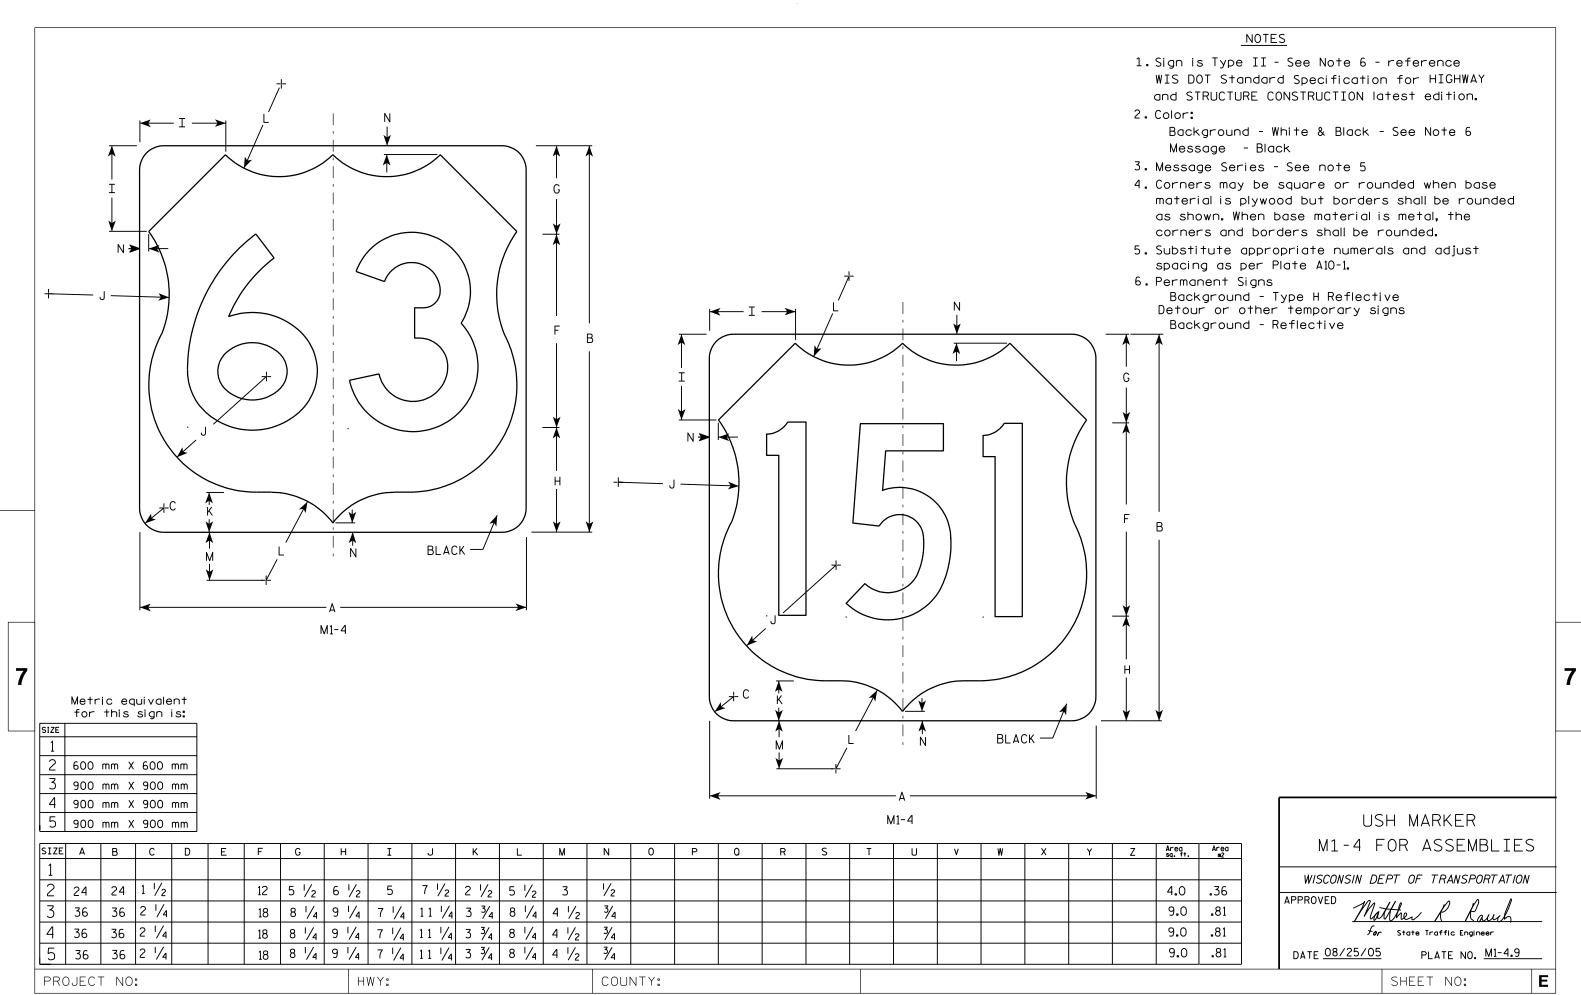


FILE NAME : C:\Users\Projects\tr_stdplate\M14.DGN


- 1. Sign is Type II see Note 7 reference WIS DOT Standard Specification for HIGHWAY and STRUCTURE CONSTRUCTION latest edition.
- 2. Color:


Background - White & Black - See Note 7 Message - Black

- 3. Message Series see Note 5
- 4. Corners may be square or rounded when base material is plywood but borders shall be rounded as shown. When base material is metal, the corners and borders shall be rounded.
- 5. Message Series E for 1 letter. Message Series D for 2 letters unless message is too big then Series C. Message Series C for 3 letters unless message is too big then Series B.
- 6. Substitute appropriate letters & optically center to achieve proper balance.
- 7. Permanent Signs

Background - Type H Reflective Detour or temporary Signs Background - Reflective

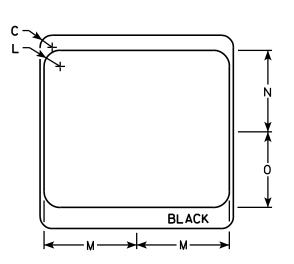

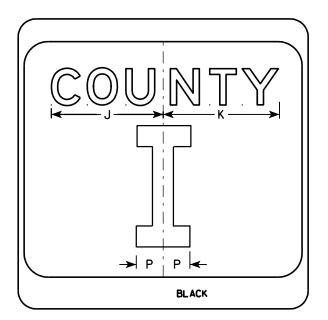

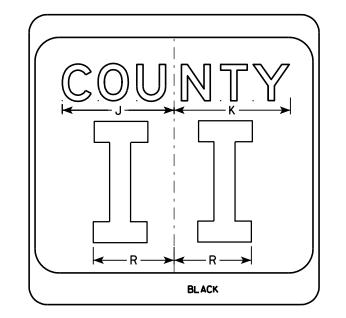

SIZE	Α	В	С	D	E	F	G	Н	I	J	K	L	M	N	0	Р	0	R	S	T	U	٧	W	X	Y	Z	Area sq. ft.
1																											
2	24		1 1/2			10	3	5 1/8	4 1/8	9 1/4	9 %	2	11 1/2	10 1/8	9 %	2 1/4		6 %									4.0
3	36		2 1/4			16	4	7 5/8	5 %	12 1/4	12 1/8	3	17 1/8	15 1/4	14	3 3/8		10									9.0
4	36		2 1/4			16	4	7 %	5 %	12 1/4	12 1/8	3	17 1/8	15 1/4	14	3 %		10									9.0
5	36		2 1/4			16	4	7 %	5 %	12 1/4	12 1/8	3	17 1/8	15 1/4	14	3 3/8		10									9.0
																			_								

COUNTY:

CTH MARKER M1-5A FOR ASSEMBLIES

WISCONSIN DEPT OF TRANSPORTATION

APPROVED

FerState Traffic Engineer PLATE NO. M1-5A.8 DATE 9/27/11

SHEET NO:

FILE NAME : C:\Users\PROJECTS\tr_stdplate\M15A.DGN

PROJECT NO:

BLACK

HWY:

M1-5A

PLOT DATE: 29-SEP-2011 11:25

PLOT NAME :

PLOT BY: mscsja

PLOT SCALE: 5.959043:1.000000

- 1. Sign is Type II See Note 6 reference WIS DOT Standard Specification for HIGHWAY and STRUCTURE CONSTRUCTION latest edition.
- 2. Color:

Background - White & Black - See Note 6 Message - Black

- 3. Message Series See note 5
- 4. Corners may be square or rounded when base material is plywood but borders shall be rounded as shown. When base material is metal, the corners and borders shall be rounded.
- 5. Substitute appropriate Series numerals and adjust spacing as per plate A10-1.
- 6. Permanent Signs Background - Type H Reflective Detour or temporary Signs Background - Reflective

	BLACK BLACK
Metric equivalent for this sign is:	>

HWY:

SIZE 600 mm X 600 mm 900 mm X 900 mm 900 mm X 900 mm 900 mm X 900 mm

PROJECT NO:

SIZE	Α	В	С	D	E	F	G	Н	I	J	К	L	М	N	0	Р	Q	R	S	T	U	٧	W	Х	Y	Z	Area sq. ft.	Area m2
1																												ļ
2	24		1 1/2			12	5 1/2	6 1/2	10 1/4	2 1/2	8 %	11 ½	1	1 %	11 1/4	21 1/8											4.0	. 36
3	36		2 1/4			18	8 3/4	9 1/4	15 3/8	5	12 5/8	17 1/8	1 1/2	2 1/8	16 1/8	33											9.0	.81
4	36		2 1/4			18	8 3/4	9 1/4	15 3/8	5	12 5/8	17 1/8	1 1/2	2 1/8	16 1/8	33											9.0	.81
5	36		2 1/4			18	8 3/4	9 1/4	15 3/8	5	12 5/8	17 1/8	1 1/2	2 1/8	16 1/8	33											9.0	. 81

COUNTY:

STATE ROUTE MARKER M1-6 FOR ASSEMBLIES

WISCONSIN DEPT OF TRANSPORTATION

APPROVED

DATE 3/20/02 PLATE NO. M1-6.9

SHEET NO:

FILE NAME : C:\Users\Projects\tr_stdplate\M16.DGN

PLOT DATE: 13-OCT-2005 14:55

PLOT BY : DITJPH

PLOT NAME :

PLOT SCALE : 6.715871:1.000000

- 1. Sign is Type II Type H
- 2. Color:

Background - See note 5 Message - See note 5

- 3. Message Series C
- 4. Corners may be square or rounded when base material is plywood but borders shall be rounded as shown. When base material is metal, the corners and borders shall be rounded.
- 5. M2-1 Background White

Message - Black

MB2-1 Background - Blue

Message - White

MK2-1 Background - Green

Message - White

MM2-1 Background - White

Message - Green

MN2-1 Background - Brown


Message - White

MP2-1 Background - White

Message - Blue

MR2-1 Background - Brown

Message - Yellow

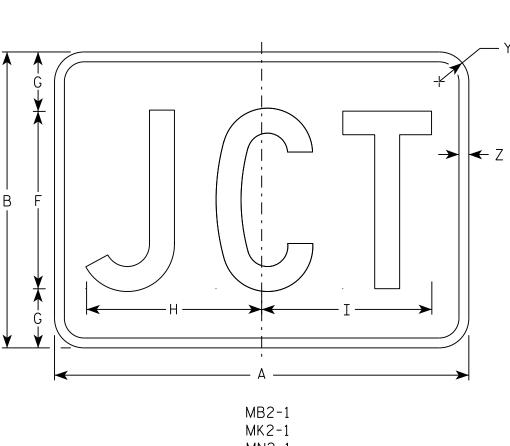

MN2-1

MR2-1

SIZE	Α	В	С	D	E	F	G	Н	I	J	K	L	М	N	0	Р	0	R	S	T	J	V	W	Х	Υ	Z	Area sq. ft.
1																											
2	21	15	1 1/8	3/8	3/8	9	3	8 1/8	8 %																1 1/2	1/2	2.20
3	30	21	1 1/8	3/8	3/8	13	4	12 1/8	12 3/8																1 1/2	1/2	4.40
4	30	21	1 1/8	3/8	3/8	13	4	12 1/8	12 3/8																1 1/2	1/2	4.40
5	30	21	1 1/8	3/8	3/8	13	4	12 1/8	12 3/8																1 1/2	1/2	4.40

COUNTY:

В

STANDARD SIGN

M2 - 1

WISCONSIN DEPT OF TRANSPORTATION

APPROVED

Matthew & Rauch f_{or} State Traffic Engineer

DATE 10/15/15

PLATE NO. M2-1.12 Ε

SHEET NO:

FILE NAME · C·\CAFfiles\Projects\tr stdplote\M21 DGN

PROJECT NO:

M2-1

HWY:

MM2-1

MP2-1

PLOT DATE . 01-DEC-2015 17:54

PLOT BY . \$\$ Diotuser \$\$ PLOT NAME :

PLOT SCALE • 4 864603•1 000000







MP3-1









HWY:



NOTES

- 1. All Signs Type II Type H
- 2. Color:

Background - See note 5 Message - See note 5

- 3. Message Series C
- 4. Corners may be square or rounded when base material is plywood but borders shall be rounded as shown. When base material is metal, the corners and borders shall be rounded.

5. M3-1 thru M3-4 Background - White Message - Black

MB3-1 thru MB3-4 Background - Blue

Message - White

MK3-1 thru MK3-4 Background - Green

Message - White

MM3-1 thru MM3-4 Background - White

Message - Green

MN3-1 thru MN3-4 Background - Brown

Message - White

MP3-1 thru MP3-4 Background - White

Message - Blue

6. Note the first letter of each direction is larger than the remainder of the message.

SIZE	Α	В	С	D	E	F	G	Н	I	J	К	L	М	N	0	Р	0	R	S	Т	U	V	W	Х	Y	Z	Area sq. ft.
1																											
2	24	12	1 1/8	3/8	3/8	6	7	2 1/4	2 3/4	10 1/4	7 1/8	8 3/8	10 1/4	9 3/4	8 3/4			1 1/2									2.00
3	36	18	1 1/8	3/8	1/2	9	10	3 3/4	4 1/4	14 3/8	12	12 1/8	14	14 1/8	13			1 1/2									4.5
4	36	18	1 1/8	3/8	1/2	9	10	3 3/4	4 1/4	14 3/8	12	12 1/8	14	14 1/8	13			1 1/2									4.5
5	36	18	1 1/8	3/8	1/2	9	10	3 3/4	4 1/4	14 3/8	12	12 1/8	14	14 1/8	13			1 1/2									4.5

COUNTY:

STANDARD SIGNS M3-1 thur M3-4 **SERIES**

WISCONSIN DEPT OF TRANSPORTATION

APPROVED

DATE 10/15/15 PLATE NO. M3-1.14

Ε

SHEET NO:


FILE NAME · C·\CAFfiles\Projects\tr stdnlote\M31 DCN

PROJECT NO:

PLOT DATE . 01-DEC-2015 17:54

PLOT RY . \$\$ plotuser \$\$ PLOT NAME :

PLOT SCALE . 11 675051.1 000000

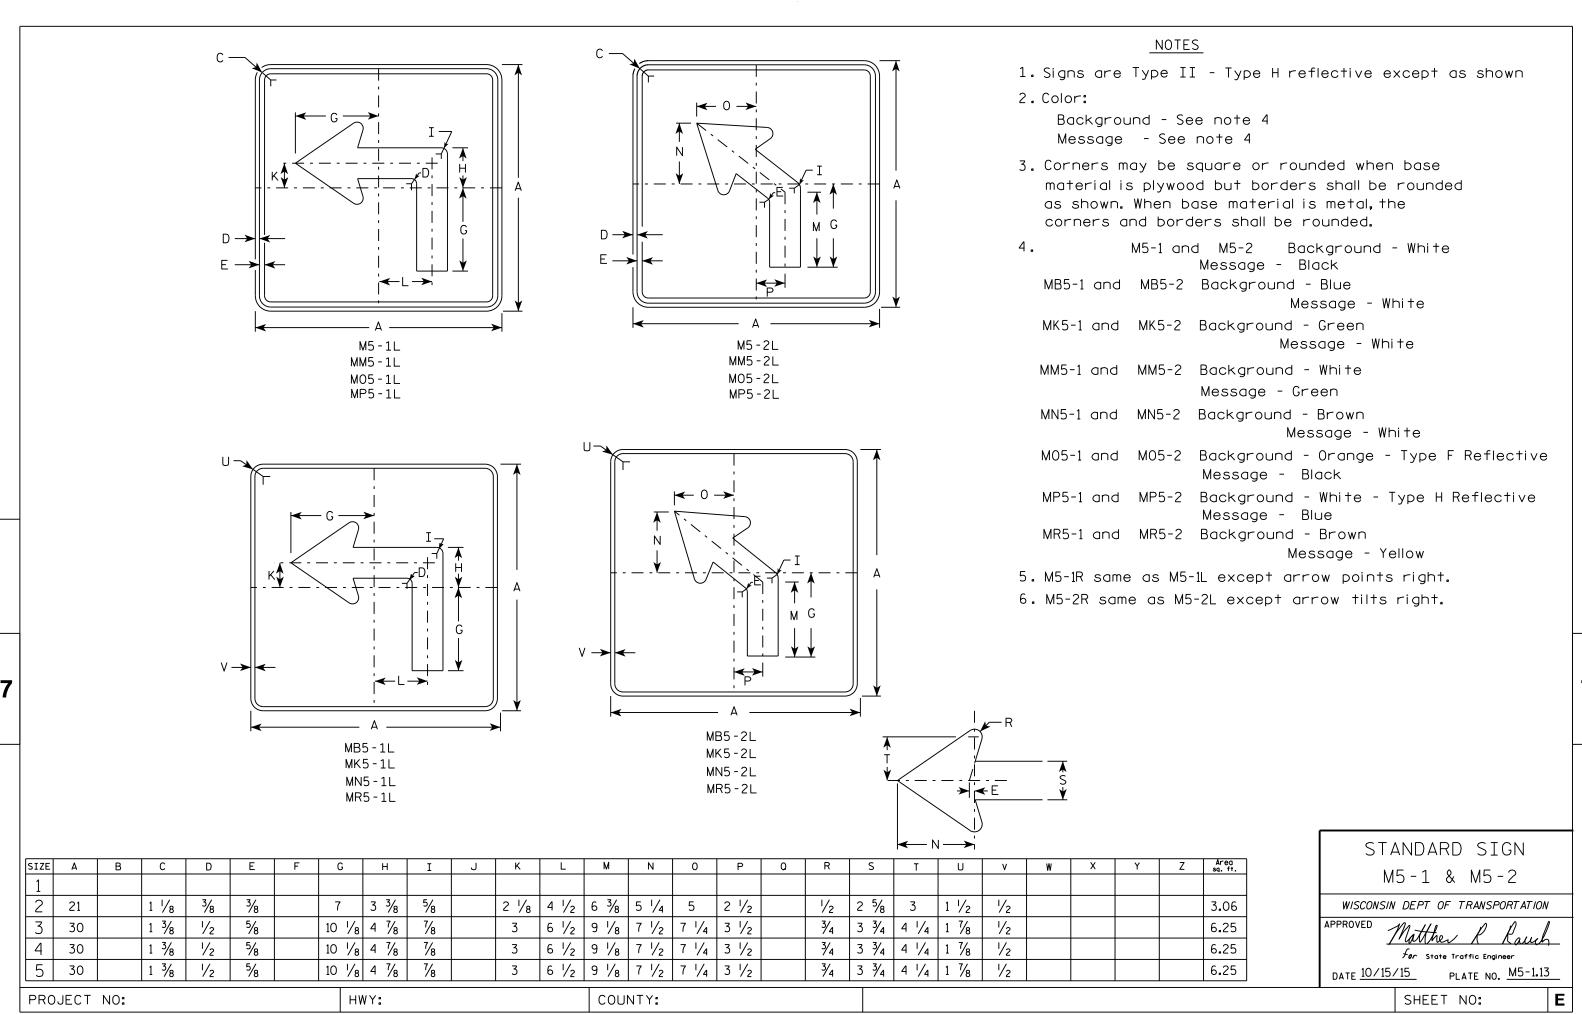

FILE NAME . C.\CAFfiles\Projects\tr stdolote\M51 DCN

PLOT DATE . 01-DEC-2015 18:07

PINT RY . \$\$ DIOTUSET \$\$ PINT NAMF :

PLOT SCALE . 11 675051.1 000000







MR6-1

HWY:



NOTES

- 1. Signs are Type II Type H except as Shown
- 2. Color:

Background - See note 4 Message - See note 4

- 3. Corners may be square or rounded when base material is plywood but borders shall be rounded as shown. When base material is metal, the corners and borders shall be rounded.
- 4. M6-1 and M6-2 Background White

Message - Black

MB6-1 and MB6-2 Background - Blue

Message - White

MK6-1 and MK6-2 Background - Green

Message - White

MM6-1 and MM6-2 Background - White

Message - Green

MN6-1 and MN6-2 Background - Brown

Message - White

M06-1 and M06-2 Background - Orange - Type F Reflective

Message - Black

MP6-1 and MP6-2 Background - White

Message - Blue

MR6-1 and MR6-2 Background - Brown

Message - Yellow



SIZE	: Α	В	С	D	E	F	G	Н	I	J	K	L	М	N	0	Р	٥	R	S	T	U	٧	W	Х	Y	Z	Area sq. ft.
1																											
2	21		1 1/8	3/8	3%		7 1/2	7 1/8	5 %	5	4 1/4	5 1/4	3	2 %	1/2						1 1/2	1/2					3.06
3	30		1 3/8	1/2	5%		10 3/4	10 1/4	8	7 1/4	6	7 1/2	4 1/4	3 3/4	3/4						1 1/8	1/2					6.25
4	30		1 3/8	1/2	5/8		10 3/4	10 1/4	8	7 1/4	6	7 1/2	4 1/4	3 3/4	3/4						1 1/8	1/2					6.25
5	30		1 3/8	1/2	5/8		10 3/4	10 1/4	8	7 1/4	6	7 1/2	4 1/4	3 3/4	3/4						1 1/8	1/2					6.25

COUNTY:

STANDARD SIGN M6-1 & M6-2 SERIES

WISCONSIN DEPT OF TRANSPORTATION

APPROVED

Matthew & Rawl For State Traffic Engineer

Ε

DATE 10/15/15 PLATE NO. M6-1.15

SHEET NO:


FILE NAME · C·\CAFfiles\Projects\tr stdplote\M61 DCN


PROJECT NO:


PLOT DATE . 01-DEC-2015 17:57

PIOT RY . \$\$ plotuser \$\$ PIOT NAMF :


PLOT SCALE . 11 675051.1 000000

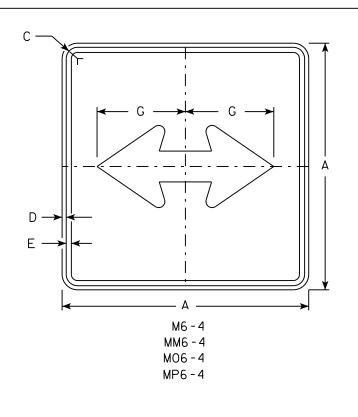

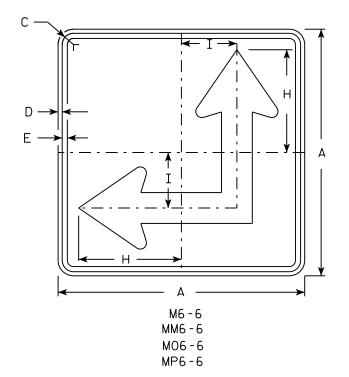

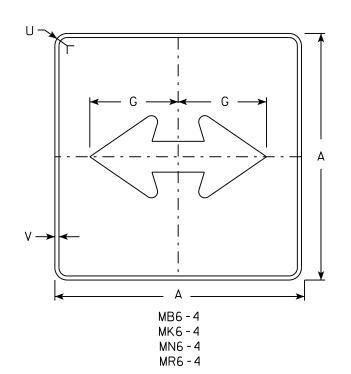

HWY:

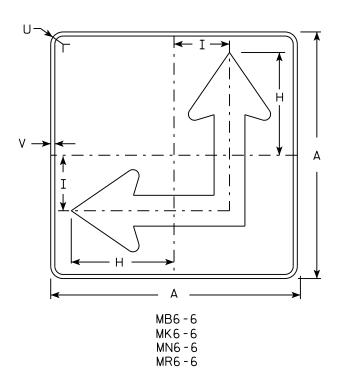

NOTES

- 1. Signs are Type II Type H except as Shown
- 2. Color:

Background - See Note 4 Message - See Note 4

- 3. Corners may be square or rounded when base material is plywood but borders shall be rounded as shown. When base material is metal, the corners and borders shall be rounded.
- 4. M6-4 and M6-6 Background White Message - Black

MB6-4 and MB6-6 Background - Blue

Message - White

MK6-4 and MK6-6 Background - Green

Message - White

and MM6-6 Background - White MM6-4

Message - Green

MN6-4 and MN6-6 Background - Brown

Message - White

M06-4 and M06-6 Background - Orange - Type F Reflective

Message - Black


MP6-4 and MP6-6 Background - White

Message - Blue

MR6-4 and MR6-6 Background - Brown

Message - Yellow

5. M6-6R same as M6-6L except arrow points ahead and right.

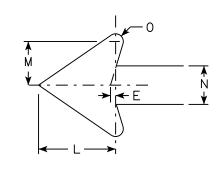

SIZE	Α	В	С	D	E	F	G	Н	I	J	K	L	М	N	0	Р	a	R	S	T	U	٧	W	X	Y	Z	Area sq. ft.
1																											
2	21		1 1/8	3/8	3/8		7 1/2	8 3/4	4 1/4			5 1/4	3	2 5/8	1/2						1 1/2	1/2					3.06
3	30		1 3/8	1/2	5/8		10 3/4	12 1/2	6 3/4			7 1/2	4 1/4	3 3/4	3/4						1 1/8	1/2					6.25
4	30		1 3/8	1/2	5/8		10 3/4	12 1/2	6 3/4			7 1/2	4 1/4	3 3/4	3/4						1 1/8	1/2					6.25
5	30		1 3/8	1/2	5/8		10 3/4	12 ½	6 3/4			7 1/2	4 1/4	3 3/4	3/4						1 1/8	1/2					6.25

COUNTY:

STANDARD SIGN M6-4 & M6-6 SERIES

WISCONSIN DEPT OF TRANSPORTATION

SHEET NO:

APPROVED

DATE 10/15/15

PLATE NO. M6-4.10 Ε

PLOT DATE . 01-DEC-2015 17.58

PLOT RY . \$\$ plotuser \$\$ PLOT NAME :

PLOT SCALE . 11 675051.1 000000

PROJECT NO:

NOTES 1. Sign is Type II - Type H Reflective - reference WIS DOT Standard Specification for HIGHWAY and STRUCTURE CONSTRUCTION latest edition. 2. Color: Background - Red Message - White 3. Message Series - C R1-1 SIZE A STANDARD SIGN 30 5/8 10 12 1/2 45° 12 3/4 5.18 2S 30 5/8 12 1/2 45° 12 3/4 10 5.18 R1-1 2M 36 3/4 12 15 45° 15 % 7.46 3/4 15 3/8 12 45° 36 15 7.46 WISCONSIN DEPT OF TRANSPORTATION 45° 20 1/2 48 16 20 13.25 APPROVED Matthew & Kauch 5 48 16 20 45° 20 1/2 13.25 3/8 7 3/4 45° 7 3/4 1.86 18 6 For State Traffic Engineer 12 1/4 4 45° 5 1/8 0.78 DATE <u>11/12/15</u> PLATE NO. _____R1-1.13 COUNTY: SHEET NO: PROJECT NO: HWY: PLOT SCALE • 4 378143•1 000000

FILE NAME · C·\CAFfiles\Projects\tr stdplote\R11 DGN


PLOT DATE . 01-DEC-2015 18:07

PINT RY . \$\$ plotuser \$\$ PINT NAMF :

- 1. Sign is Type II Type H Reflective
- 2. Color:

Background - Red Message - White

- 3. Message Series C
- 4. For 30"x30" R1-1 use 18"x6" R1-3P sign For 36"x36" R1-1 use 24"x9" R1-3P sign For 48"x48" R1-1 use 30"x12" R1-3P sign

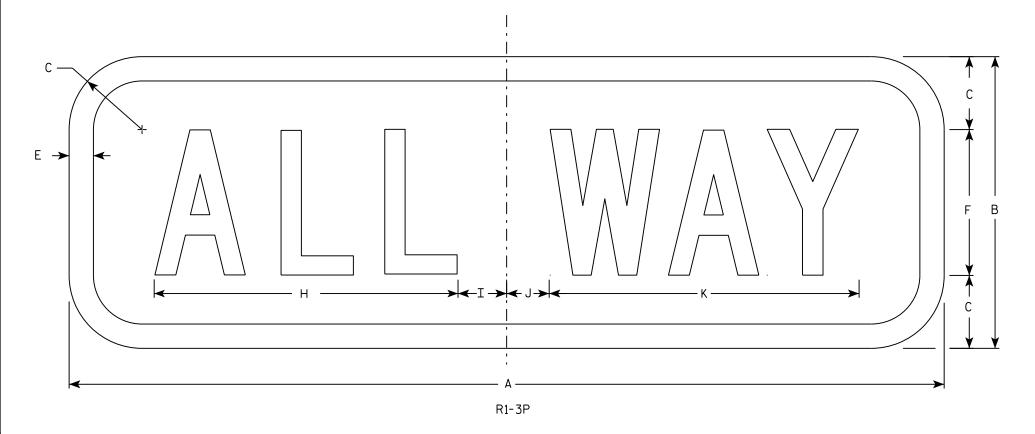

SIZE	Α	В	С	D	E	F	G	Н	I	J	К	L	М	N	0	Р	0	R	S	Т	U	V	W	Х	Y	Z	Area sq. ft.
1	18	6	1 1/2		1/2	3		6 1/4	1 1/4	7/8	6 3/8																0.75
25	18	6	1 1/2		1/2	3		6 1/4	1 1/4	7/8	6 3/8																1.5
2M	24	9	1 1/2		1/2	5		9 1/4	1 1/4	3/4	9 3/4																1.5
3	24	9	1 1/2		1/2	5		9 1/4	1 1/4	3/4	9 3/4																1.5
4	30	12	2 1/4		5/8	6		11	2 1/4	1 1/2	11 3/4																2.5
5	30	12	2 1/4		5/8	6		11	2 1/4	1 1/2	11 3/4					·											2.5

COUNTY:

STANDARD SIGN R1-3P

WISCONSIN DEPT OF TRANSPORTATION

APPROVED

DATE 11/29/16


PLATE NO. R1-3P.3

SHEET NO:

HWY:

PROJECT NO:

 $f_{\it or}$ State Traffic Engineer

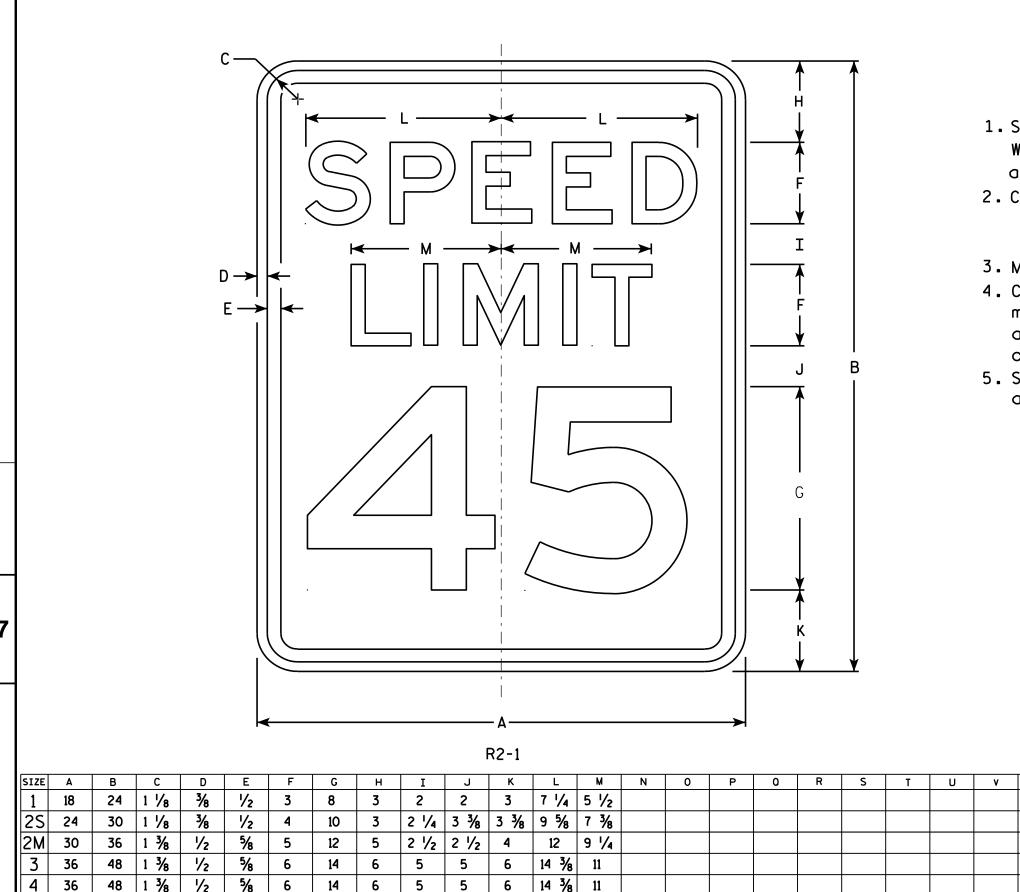

4 1/2 6 3/4 6 3/4 19 1/4 14 5/8

COUNTY:

20

HWY:

6

NOTES

- 1. Sign is Type II Type H Reflective reference WIS DOT Standard Specification for HIGHWAY and STRUCTURE CONSTRUCTION latest edition.
- 2. Color:

Background - White Message - Black

- 3. Message Series E
- 4. Corners may be square or rounded when base material is plywood but borders shall be rounded as shown. When base material is metal. the corners and borders shall be rounded.
- 5. Substitute appropriate numerals and optically adjust spacing to achieve proper balance.

3.0

5.0

7.5

12.0

12.0

20.0

STANDARD SIGN R2-1

WISCONSIN DEPT OF TRANSPORTATION APPROVED

Matther R Raus For State Traffic Engineer PLATE NO. R2-1.13

DATE <u>5/26/1</u>0

SHEET NO:

2 1/4

60

5

48

PROJECT NO:


PLOT NAME :

- 1. Sign is Type II Type H Reflective reference WIS DOT Standard Specification for HIGHWAY and STRUCTURE CONSTRUCTION latest edition.
- 2. Color:

Background - White Message - Black

- 3. Message Series E
- 4. Corners may be square or rounded when base material is plywood but borders shall be rounded as shown. When base material is metal, the corners and borders shall be rounded.

Ε G Ε R3-9B

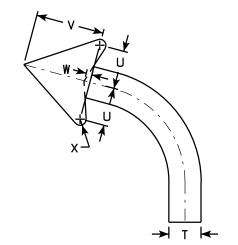

ARROW DETAIL

SIZE	Α	В	С	D	E	F	G	Н	I	J	К	L	М	N	0	Р	0	R	S	T	U	٧	W	X	Y	Z	Area sq. ft.
1																											
2S	24	36	3/8	1/2	2 1/2	3	1 1/2	16		1 1/2	8 1/2	5 3/4	8	2 1/2		6	2	5 1/8	1 1/2		2 3/8	4 3/8	3/8				6.0
2M	24	36	3/8	1/2	2 1/2	3	1 1/2	16		1 1/2	8 1/2	5 3/4	8	2 1/2		6	2	5 1/8	1 1/2		2 3/8	4 3/8	3/8				6.0
3	36	48	5/8	7 /8	3 1/2	5	1 1/2	20		2 1/4	14 1/8	9 1/2	12	3		4	3	9 %	2		3 1/2	6 1/8	1/2				12.0
4																											
5																											

STANDARD SIGN R3-9B

WISCONSIN DEPT OF TRANSPORTATION

APPROVED

DATE 3/24/2011 PLATE NO. R3-9B.5

for State Traffic Engineer

SHEET NO:

COUNTY:

PLOT DATE: 24-MAR-2011 11:24 PLOT BY: mscsja PLOT NAME :

PLOT SCALE: 5.959043:1.000000

PROJECT NO:

HWY:


R3-20R

HWY:

- 1. Sign is Type II Type H Reflective reference WIS DOT Standard Specification for HIGHWAY and STRUCTURE CONSTRUCTION latest edition.
- 2. Color:

Background - White Message - Black

- 3. Message Series E
- 4. Corners may be square or rounded when base material is plywood but borders shall be rounded as shown. When base material is metal, the corners and borders shall be rounded.

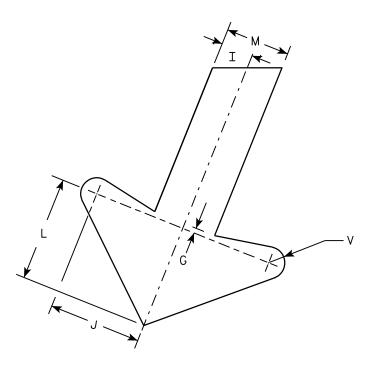

ARROW	DETAIL

SIZE	Α	В	С	D	E	F	G	Н	I	J	К	L	М	N	0	Р	Q	R	S	Т	U	٧	W	Х	Y	Z	Area sq. ft.
1																											
25	24	36	1 1/8	3/8	1/2	4	1/4	2 1/2	1	2 1/8	2 %	3 1/4	2	1 1/2	8 1/2	8 1/4		8 1/8	7	8	22°	1/2	9 1/2				6.0
2M	24	36	1 1/8	3/8	1/2	4	1/4	2 1/2	1	2 1/8	2 %	3 1/4	2	1 1/2	8 1/2	8 1/4		8 1/8	7 %	8	22°	1/2	9 1/2				6.0
3	36	54	1 3/4	1/2	5/8	6	3/8	3 3/4	1 1/2	4 1/4	4	4 1/8	3	2 1/4	12 3/4	12 1/2		12 1/4	11 1/2	12	22°	3/4	13 1/4				13.5
4																											
5																											

COUNTY:

STANDARD SIGN R3-20R

WISCONSIN DEPT OF TRANSPORTATION

APPROVED Matthew R Rauch
Forstate Traffic Engineer

SHEET NO:

DATE 10/18/10

PLATE NO. <u>R3-20R.</u>6

М

Ν

PLOT DATE: 15-OCT-2010 14:59 PLOT BY: do+sja


PLOT NAME :

PLOT SCALE : 5.959043:1.000000

WISDOT/CADDS SHEET 42

FILE NAME : C:\Users\PROJECTS\tr_stdplate\R320R.DGN

PROJECT NO:

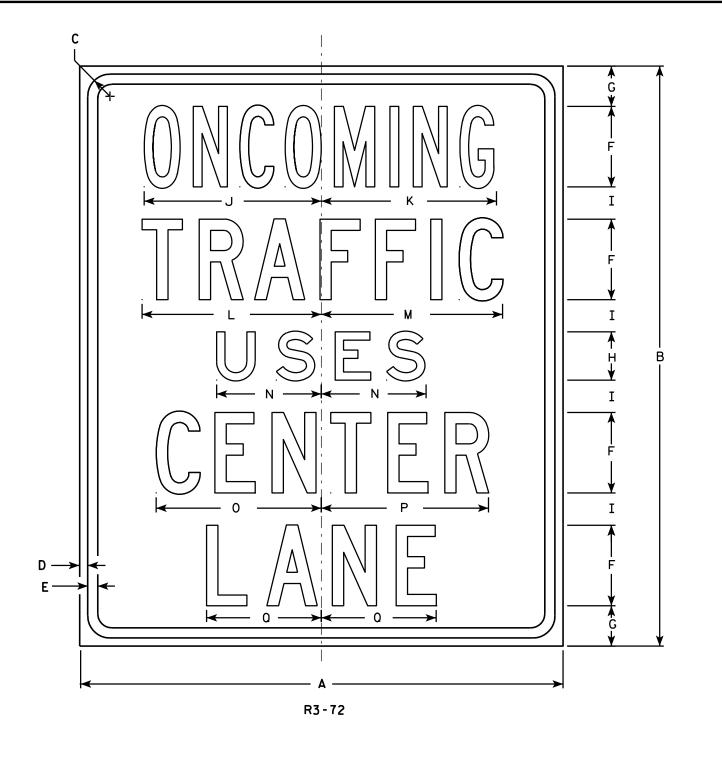

- 1. Sign is Type II Type H Reflective reference WIS DOT Standard Specification for HIGHWAY and STRUCTURE CONSTRUCTION latest edition.
- 2. Color:

Background - White Message - Black

- 3. Message Series Line 1 is Series B, Lines 2, 4 and 5 are Series C, and Line 3 is Series E.
- 4. Corners may be square or rounded when base material is plywood but borders shall be rounded as shown. When base material is metal, the corners and borders shall be rounded.

SIZE	Α	В	С	D	Ε	F	G	Н	I	7	K	L	M	N	0	Ρ	0	R	S	T	J	٧	W	X	Y	Z	Area sq. ft.
1	30	36	1 3/8	1/2	5/8	5	2 1/2	3	2	11	10 %	11 1/8	11 1/4	6 1/2	10 1/4	10 3/8	7 1/8										7.50
2S	30	36	1 3/8	1/2	5/8	5	2 1/2	3	2	11	10 %	11 1/8	11 1/4	6 1/2	10 1/4	10 3/8	7 1/8										7.50
2M	30	36	1 3/8	1/2	5/8	5	2 1/2	3	2	11	10 1/8	11 1/8	11 1/4	6 1/2	10 1/4	10 3/8	7 1/8										7.50
3																											
4																											
5																											

COUNTY:

STANDARD SIGN R3-72

WISCONSIN DEPT OF TRANSPORTATION

APPROVED

₹ar State Traffic Engineer

DATE 3/25/2011 PLATE NO. R3-72.5

SHEET NO:

FILE NAME : C:\Users\PROJECTS\tr_stdplate\R372.DGN

HWY:

PROJECT NO:

PLOT DATE: 25-MAR-2011 13:16

PLOT NAME :

PLOT BY: mscsja

PLOT SCALE: 5.959043:1.000000

R4-1

NOTES

- 1. Sign is Type II Type H Reflective reference WIS DOT Standard Specification for HIGHWAY and STRUCTURE CONSTRUCTION latest edition.
- 2. Color:

Background - White Message - Black

- 3. Message Series D
- 4. Corners may be square or rounded when base material is plywood but borders shall be rounded as shown. When base material is metal, the corners and borders shall be rounded.

SIZE	Α	В	С	۵	Е	F	G	Н	I	J	K	L	M	N	0	Р	0	R	S	T	U	٧	W	X	Y	Z	Area sq. ft.
1	18	24	1 1/8	3/8	1/2	4	3 1/2	2 1/2	3 1/8	3 1/4	4 3/4	4 1/8	6 1/4	6 1/2													3.0
2S	24	30	1 1/8	3/8	1/2	6	3 1/2	2 1/2	4 3/4	5	7 1/8	7 3/8	9 3/8	9 3/4													5.0
2M	24	30	1 1/8	3/8	1/2	6	3 1/2	2 1/2	4 3/4	5	7 1/8	7 3/8	9 3/8	9 3/4													5.0
3																											
4	36	48	1 %	5/8	3/4	8	7	5	6 1/4	6 %	9 1/2	9 3/4	12 1/2	13													12.0
5	48	60	2 1/4	3/4	1	10	8	7	7 3/4	8 3/8	11 1/8	12 1/4	15 %	16 1/4													20.0

COUNTY:

STANDARD SIGN R4-1

WISCONSIN DEPT OF TRANSPORTATION

APPROVED

For State Traffic Engineer

/25/2011 PLATE NO. R4-1.7

DATE 3/25/2011

SHEET NO:

PLOT DATE: 25-MAR-2011 13:24 PLOT

PLOT BY: mscsja

PLOT NAME :


PLOT SCALE: 4.965868:1.000000

WISDOT/CADDS SHEET 42

FILE NAME : C:\Users\PROJECTS\tr_stdplate\R41.DGN

PROJECT NO:

HWY:

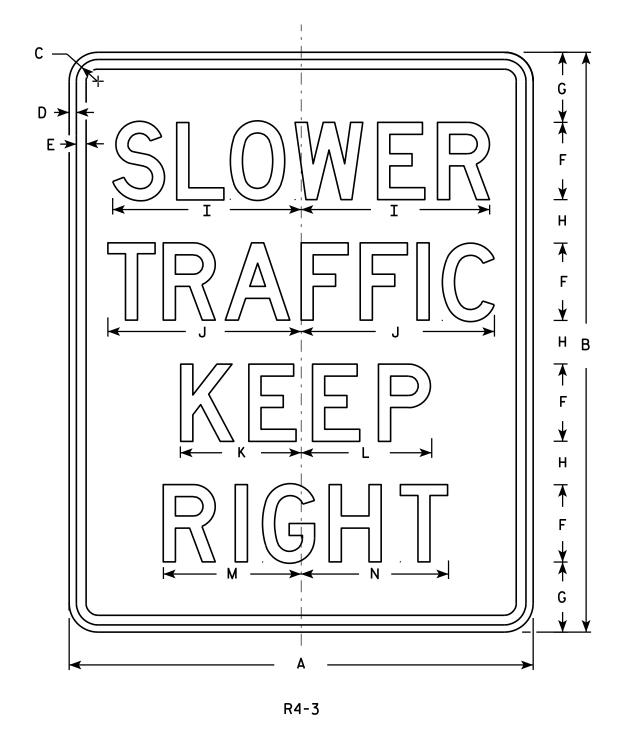

- 1. Sign is Type II Type H Reflective reference WIS DOT Standard Specification for HIGHWAY and STRUCTURE CONSTRUCTION latest edition.
- 2. Color:

Background - White Message - Black

- 3. Message Series D
- 4. Corners may be square or rounded when base material is plywood but borders shall be rounded as shown. When base material is metal, the corners and borders shall be rounded.

SIZE A В С G 2S 24 3/8 10 6 1/4 6 3/4 7 1/8 7 5/8 30 | 1 1/8 1/2 | 3 % | 2 1/4 | 9 ¾ | 5.0 3 % 2 1/4 9 3/4 10 6 1/4 6 3/4 7 1/8 7 5/8 1/2 5.0 24 30 | 1 1/8 48 1 1 1 1 1 1 1 1 1 1 1 1 1 5/8 3/4 15 9 3/8 14 % 10 10 3/4 11 3/8 12.0 36 10 3/4 11 3/8 3/4 15 9 % 10 36 1 % 12.0 48 5 7 1/4 4 1/2 19 1/2 20 12 1/2 13 1/2 14 1/4 15 1/4 48 60 2 1/4 20.0

STANDARD SIGN R4-3

WISCONSIN DEPT OF TRANSPORTATION

APPROVED

For State Traffic Engineer

DATE 3/25/2011 PLATE NO. R4-3.8

SHEET NO:

PROJECT NO:

R4-51

HWY:

NOTES

- 1. Sign is Type II Type H Reflective reference WIS DOT Standard Specification for HIGHWAY and STRUCTURE CONSTRUCTION latest edition.
- 2. Color:

Background - White Message - Black

- 3. Message Series C
- 4. Corners may be square or rounded when base material is plywood but borders shall be rounded as shown. When base material is metal, the corners and borders shall be rounded.

SIZE	Α	В	C	D	E	F	G	Н	I	J	K	L	M	N	0	Р	0	R	S	T	U	V	W	×	Y	Z	Areo sq. ft.
1																											
25	36	48	1 3/8	1/2	5/8	6	9	4 1/2	3 1/2	4	5	13 %	14 1/2	8	11 3/8	10 3/4	4	1/2	14 1/8								12.0
2M	36	48	1 3/8	1/2	5/8	6	9	4 1/2	3 1/2	4	5	13 %	14 1/2	8	11 3/8	10 ¾	4	1/2	14 1/8								12.0
3																											
4																											
5																											

COUNTY:

STANDARD SIGN R4-51

WISCONSIN DEPT OF TRANSPORTATION

PPROVED

Matthew R

Fac. State Traffic Engineer

DATE 3/29/2011 PLATE NO. R4-51.4

SHEET NO:

FILE NAME : C:\Users\PROJECTS\tr_stdplate\R451.DGN

PROJECT NO:

PLOT DATE: 29-MAR-2011 10:36

PLOT NAME :

PLOT BY: mscsja

PLOT SCALE: 8.938567:1.000000

1. Sign is Type II - Type H Reflective - reference WIS DOT Standard Specification for HIGHWAY and STRUCTURE CONSTRUCTION latest edition.

2. Color:

Background - White Message - Black

- 3. Message Series C
- 4. Corners may be square or rounded when base material is plywood but borders shall be rounded as shown. When base material is metal, the corners and borders shall be rounded.

C —	1
PASSING LANGE LANGE	★K ★ F ★ J ★ F ★ I ★ G → H ★ ★ F ★ I ★ F ★ H ★
R4-51A	

SIZE	Α	В	С	D	Ε	F	G	Н	I	J	K	L	М	N	0	Р	0	R	S	T	J	٧	W	X	Y	Z	Area sq. ft.
1																											
2S	36	48	1 3/8	1/2	5/8	6	9 1/4	4 1/2	3 1/2	4	5	13 5/8	14 1/2	8	11 3/8	10 ¾	4	5 ½	13 3/8	3 1/4							12.0
2M	36	48	1 3/8	1/2	5/8	6	9 1/4	4 1/2	3 1/2	4	5	13 %	14 1/2	8	11 3/8	10 ¾	4	5 ½	13 %	3 1/4							12.0
3																											
4																											
5																											

COUNTY:

STANDARD SIGN R4-51A

WISCONSIN DEPT OF TRANSPORTATION

APPROVED

For State Traffic Engineer
DATE 3/29/2011 PLATE NO. R4-51A.2

SHEET NO:

FILE NAME : C:\Users\PROJECTS\tr_stdplate\R451A.DGN

PROJECT NO:

HWY:

PLOT DATE: 29-MAR-2011 10:43

PLOT BY: mscsja

PLOT NAME :

PLOT SCALE: 8.938567:1.000000




- 1. Sign is Type II Type H Reflective reference WIS DOT Standard Specification for HIGHWAY and STRUCTURE CONSTRUCTION latest edition.
- 2. Color:

Background - White Message - Red

- 3. Message Series See Note 5
- 4. Corners may be square or rounded when base material is plywood but borders shall be rounded as shown. When base material is metal, the corners and borders shall be rounded.
- 5. Lines 1, 3 and 4 are series C, line 2 is series B.
- 6. R7-1D (double arrow)

R7-1L (left arrow)

R7-1R (right arrow)

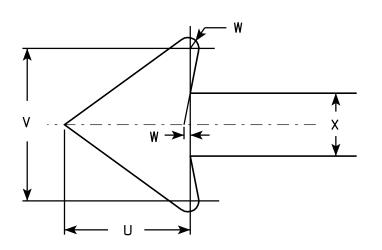

R7-1

SIZE	Α	В	С	D	E	F	G	Н	I	J	K	L	M	N	0	Р	0	R	S	Т	U	٧	W	X	Y	Z	Area sq. ft.
1	12	18	1 1/8	3/8	3/8	3	1 %	2	%	5/8	1 1/2	2 1/2	2	2	4 %	4 1/8	2 1/4	2 1/8	2 1/2	3 %	1 1/2	1 3/4	1/8	3/4			1.5
2S	18	24	1 1/8	3/8	1/2	4	2 1/2	2 1/2	1 1/4	1	2	3 1/4	2 3/4	2 %	7 1/8	7	2 3/4	2 %	3 1/8	5 %	2 1/4	2 5/8	1/4	1 1/8			3.0
2M	24	30	1 1/8	3/8	1/2	5	3	3	2	1 1/4	2 1/2	4	3 1/4	3 3/8	9 1/4	9 1/4	3 1/4	3 1/4	3 3/4	7 3/4	3	3 1/2	1/4	1 1/2			5.0
3	24	30	1 1/8	3/8	1/2	5	3	3	2	1 1/4	2 1/2	4	3 1/4	3 3/8	9 1/4	9 1/4	3 1/4	3 1/4	3 3/4	7 3/4	3	3 1/2	1/4	1 1/2			5.0
4																											
5																											

COUNTY:

STANDARD SIGN R7-1

WISCONSIN DEPT OF TRANSPORTATION

APPROVED

ROVED

Matthew Rauch

For State Traffic Engineer

DATE 3/31/2011

1 PLATE NO. R7-1.9
SHEET NO:

FILE NAME : C:\Users\PROJECTS\tr_stdplate\R71.DGN

HWY:

PROJECT NO:

PLOT DATE: 31-MAR-2011 09:20

PLOT BY: mscsja

PLOT NAME :

PLOT SCALE: 3.476110:1.000000



- 1. Sign is Type II Type H Reflective reference WIS DOT Standard Specification for HIGHWAY and STRUCTURE CONSTRUCTION latest edition.
- 2. Color:

Background - White Message - Black

- 3. Message Series See Note 5
- 4. Corners may be square or rounded when base material is plywood but borders shall be rounded as shown. When base material is metal, the corners and borders shall be rounded.
- 5. Line 1 is Series E. Lines 2, 3, 4, 5 and 6 are Series C.

SIZE Α N 0 2S 2M 1 1/8 3/8 1/2 1 1/2 3 1/8 6 3/8 5 1/4 2 1/8 5 3/4 18 24 3 2 3.0 24 1 1/8 5 1/4 2 1/8 5 3/4 18 3/8 1/2 1 1/2 3 1/8 6 3/8 3.0 3 2 3 4 5

COUNTY:

STANDARD SIGN R9-56

WISCONSIN DEPT OF TRANSPORTATION

APPROVED

DATE 4/4/2011

PLATE NO. R9-56.5

SHEET NO:

FILE NAME : C:\Users\PROJECTS\tr_stdplate\R956.DGN

HWY:


PROJECT NO:

PLOT DATE: 04-APR-2011 10:37

PLOT BY: mscsja

PLOT NAME :

PLOT SCALE: 3.476110:1.000000

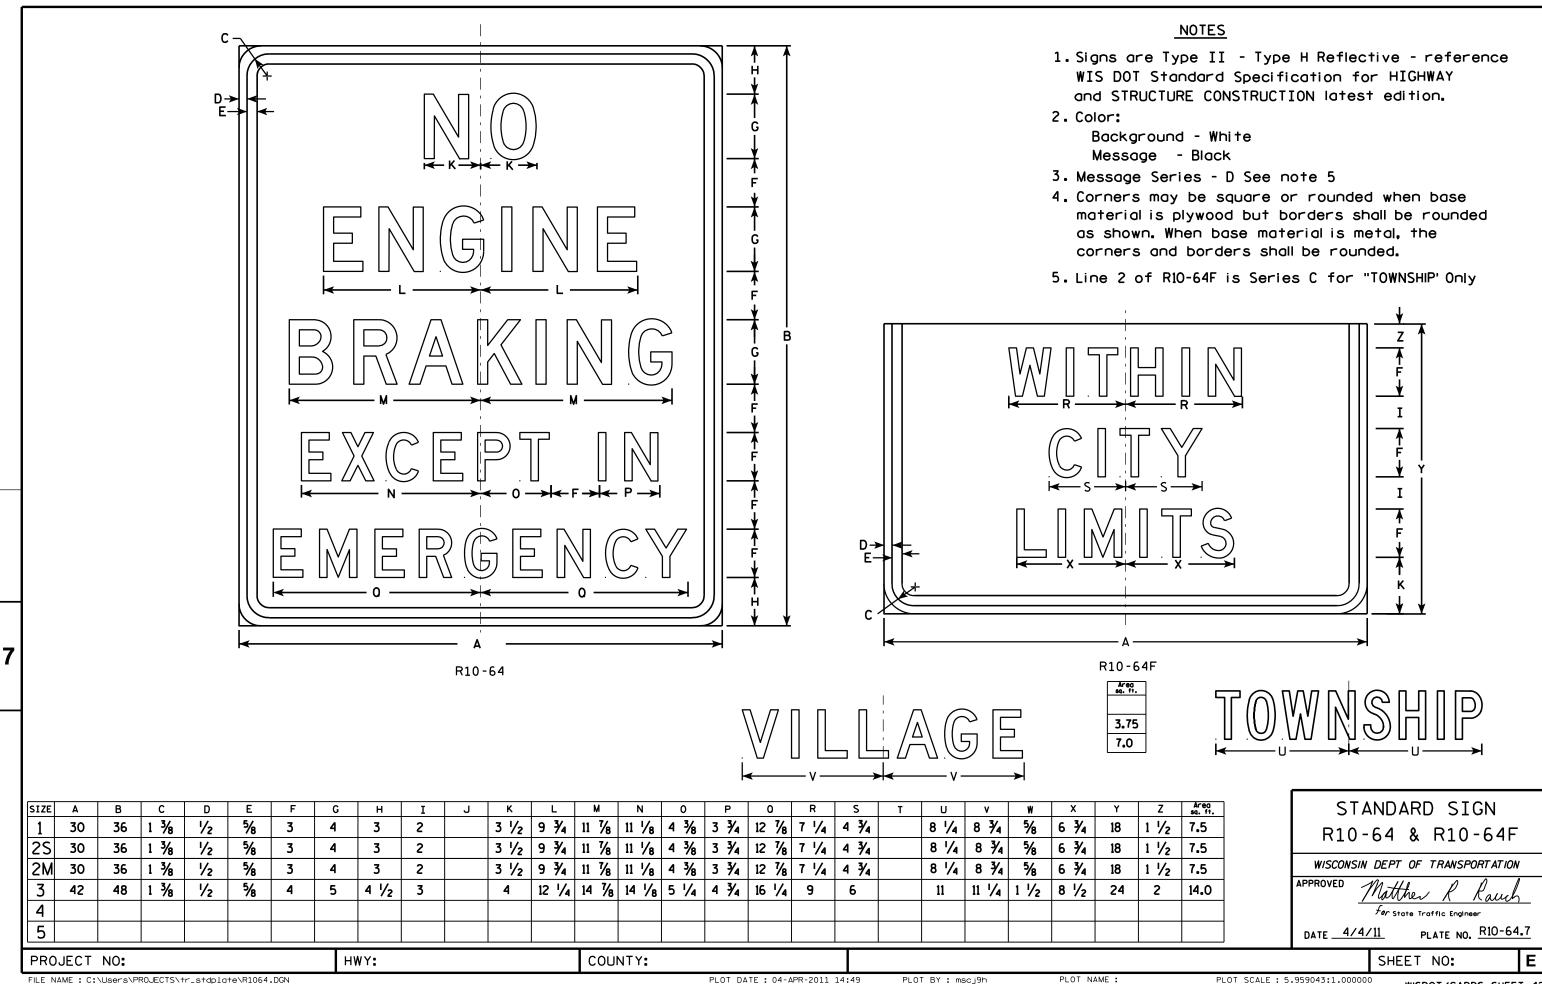


FILE NAME : C:\Users\PROJECTS\tr_stdplate\R1064.DGN

PLOT DATE: 04-APR-2011 14:49

PLOT NAME :

PLOT SCALE: 5.959043:1.000000

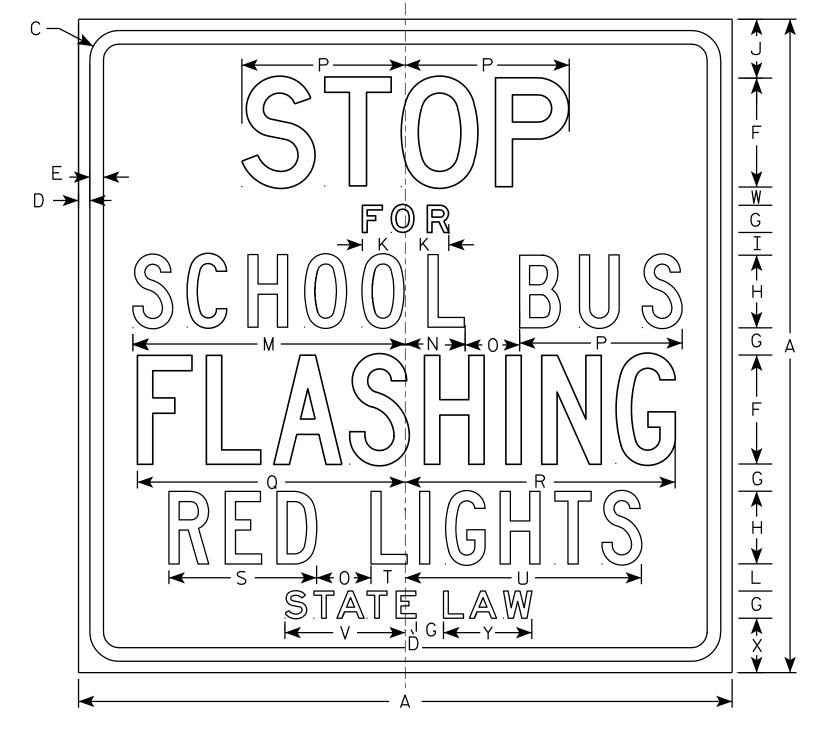

- 1. Sign is Type II Type H Reflective reference WIS DOT Standard Specification for HIGHWAY and STRUCTURE CONSTRUCTION latest edition.
- 2. Color:

Background - White Message - Black

- 3. Message Series See note 5
- 4. Corners may be square or rounded when base material is plywood but borders shall be rounded as shown. When base material is metal, the corners and borders shall be rounded.
- 5. Line 1 is Series D
 Lines 2 & 6 are Series E
 Line 3,4 & 5 are Series C

R59-51

SIZE	Α	В	C	D	E	F	G	Н	I	J	K	L	М	N	0	Р	0	R	S	T	U	V	W	X	Y	Z'	Area sq. ft.
1																											
25	36		1 %	5/8	3/4	6	1 1/2	4	1 1/4	3 1/4	2 3/8	1 1/2	15	3 1/4	3	9	14 3/4	14 %	8 1/8	1 %	13	6 %	1	3	4 %		9.0
2M	36		1 %	5/8	3/4	6	1 1/2	4	1 1/4	3 1/4	2 3/8	1 1/2	15	3 1/4	3	9	14 3/4	14 %	8 1/8	1 %	13	6 %	1	3	4 1/8		9.0
3	48		2 1/4	3/4	1	8	2	6	1 1/4	4 3/4	3 1/4	1 1/2	20 1/4	5	3 %	12	19 1/2	20	11 5/8	3 3/4	19	9 1/2	1	3 1/2	6 3/4		16.0
4	48		2 1/4	3/4	1	8	2	6	1 1/4	4 3/4	3 1/4	1 1/2	20 1/4	5	3 %	12	19 1/2	20	11 5/8	3 3/4	19	9 1/2	1	3 1/2	6 3/4		16.0
5																											
		•		•	•				-					•	-		•	•	_	•	•	•					

COUNTY:

STANDARD SIGN R59-51

WISCONSIN DEPT OF TRANSPORTATION

APPROVED

Matther R Rauch

For State Traffic Engineer

DATE 3/30/11 PLATE NO. R59-51.10

SHEET NO:

FILE NAME : C:\Users\PROJECTS\tr_stdplate\R5951.DGN

HWY:

PROJECT NO:


30-MAR-2011 09:59

PLOT DATE: 30-MAR-2011 09:59

PLOT NAME :

PLOT BY: mscj9h

PLOT SCALE: 5.287650:1.000000

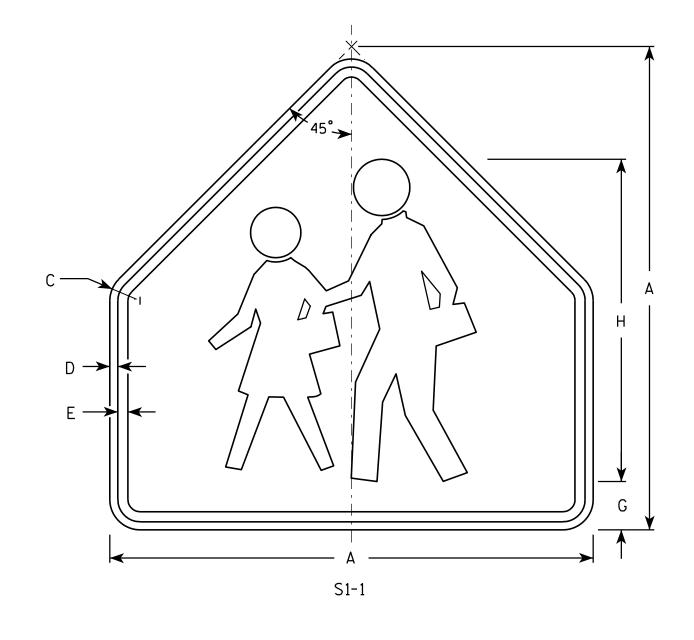

- 1. Sign is Type II Type F Reflective reference WIS DOT Standard Specification for HIGHWAY and STRUCTURE CONSTRUCTION latest edition.
- 2. Color:

Background - Yellow-Green Message - Black

3. Corners may be square or rounded when base material is plywood but borders shall be rounded as shown. When base material is metal, the corners and borders shall be rounded.

SIZE	Α	В	С	D	E	F	G	Н	I	J	К	L	М	N	0	Р	0	R	S	Т	U	٧	W	X	Y	Z	Areg sq. ft.
1	30		1 3/8	1/2	5/8		3	20																			4.69
2	36		1 %	5/8	3/4		3 1/2	24																			6.75
3	36		1 %	5/8	3/4		3 1/2	24																			6.75
4	48		2 1/4	₹4	1		4 3/4	32																			12
5																											

COUNTY:

STANDARD SIGN S1-1

WISCONSIN DEPT OF TRANSPORTATION

APPROVED

Ter State Traffic Engineer

DATE 6/30/05 PLATE NO. S1-1.8

SHEET NO:

FILE NAME : C:\Users\PROJECTS\tr_stdplate\S11.DGN

PROJECT NO:

HWY:

PLOT DATE: 26-MAY-2010 16:12

PLOT BY : ditjph

PLOT NAME :

PLOT SCALE : 5.959043:1.000000

959043:1.000000 WISDOT/CADDS SHEET 42


00 S3-1

NOTES

- 1. All Signs Type II Type F Reflective reference WIS DOT Standard Specification for HIGHWAY and STRUCTURE CONSTRUCTION latest edition.
- 2. Color:

Background - YELLOW-GREEN Message - BLACK except as noted Circles except PEDS- RED BACKGROUND

3. Corners may be square or rounded when base material is plywood but borders shall be rounded as shown. When base material is metal, the corners and borders shall be rounded.

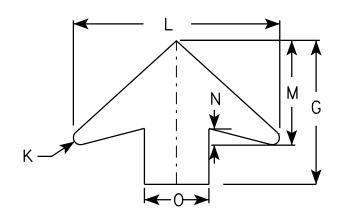

RROW	DFTAII

SIZE	Α	В	С	D	E	F	G	Н	I	J	K	L	М	N	0	Р	0	R	S	Т	U	٧	W	X	Y	Z	Area sq. ft.
1	30		1 3/8	1/2	5/8	6 1/4	11 1/4	12 1/2	5 1/4	5 ½	1/2	16	8	1 1/4	5	1 1/2		6 %	5 %	10 %							6.25
2	36		1 %	5/8	₹4	7 1/2	13 1/2	15 1/8	6 1/4	6 1/2	5/8	19 1/4	9 3/4	1 %	6	1 1/8		7 1/8	6 3/8	12 3/8							9.0
3	48		2 1/4	3/4	1	10	17 1/8	20 1/8	8 %	8 3/4	7 ⁄8	25 %	13	2	8	2 1/2		10 1/2	8 1/2	16 1/2							16.0
4	48		2 1/4	₹4	1	10	17 1/8	20 1/8	8 %	8 ¾	1 / ₈	25 %	13	2	8	2 1/2		10 1/2	8 1/2	16 1/2							16.0
5																											

STANDARD SIGN S3-1

WISCONSIN DEPT OF TRANSPORTATION

APPROVED

for State Traffic Engineer DATE <u>6/8/10</u>

SHEET NO:

FILE NAME : C:\Users\PROJECTS\tr_stdplate\S31.DGN

PROJECT NO:

PLATE NO. <u>\$3-1.6</u>

- 1. Sign is Type II reference WIS DOT Standard Specification for HIGHWAY and STRUCTURE CONSTRUCTION latest edition. (See note 5).
- 2. Color:

Background - See note 5 Message - Black

- 3. Message Series See note 6
- 4. Corners may be square or rounded when base material is plywood but borders shall be rounded as shown. When base material is metal, the corners and borders shall be rounded.
- 5. Top panel (SCHOOL) background Yellow Green -Type F Reflective. Lower panel background - White -Type H Reflective.
- 6. From top to bottom: Lines 1, 5, 6 & 7 are series D Lines 2,3 & 4 are series E
- 7. Line 4 substitute appropriate numerals and adjust spacing to achieve proper balance.

Metric equivalent for this sign is:

SIZE					
1					
2	600	mm	X	1200	mm
3	900	mm	X	1800	mm
4					
5					

PROJECT NO:

SIZE Α С D Ε 2 1 3/8 1 1/4 | 3 3/4 | 9 1/8 | 10 1/4 | 9 5/8 | 7 1/8 | 7 5/8 | 3 1/2 | 3 3/8 | 6 5/8 | 6 3/8 | 9 1/4 | 9 3/8 24 1/2 5/8 8.00 0.72 48 3 36 2 1/4 ₹4 5 1/2 15 1/4 14 1/2 11 1/4 | 11 1/2 | 5 1/2 | 5 3/4 14 1/8 18.00 1.62 72 15 4 5

COUNTY:

STANDARD SIGN S4-51

WISCONSIN DEPT OF TRANSPORTATION

Matthew R Racel DATE 4/26/10 PLATE NO. 54-51.9

SHEET NO:

FILE NAME : C:\Users\PROJECTS\tr_stdplate\S451.DGN


HWY:

PLOT DATE: 26-APR-2010 12:50

PLOT NAME :

PLOT BY : ditjph

PLOT SCALE: 7.945391:1.000000

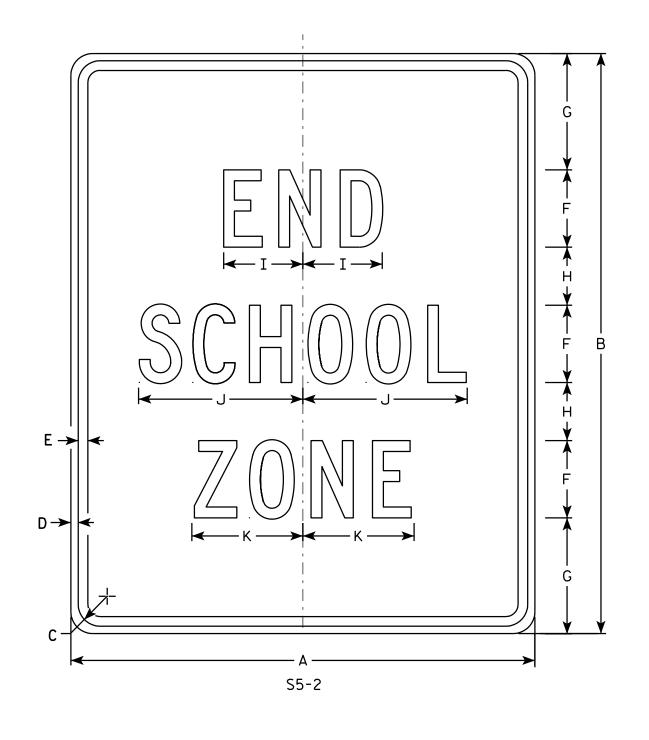

- 1. Sign is Type II Type H Reflective reference WIS DOT Standard Specification for HIGHWAY and STRUCTURE CONSTRUCTION latest edition.
- 2. Color:

Background - White Message - Black

- 3. Message Series C
- 4. Corners may be square or rounded when base material is plywood but borders shall be rounded as shown. When base material is metal, the corners and borders shall be rounded.

3/8 1/2 4 1/8 8 1/2 5 3/4 24 30 | 1 1/8 5.0 3 36 42 | 1 1 1 1 1 1 1 1 1 1 1 1 1 5∕8 3/4 6 1/8 12 5/8 8 5/8 10.5 4 5

COUNTY:

STANDARD SIGN S5-2

WISCONSIN DEPT OF TRANSPORTATION

APPROVED For State Traffic Engineer

DATE 3/8/11

SHEET NO:

FILE NAME : C:\Users\PROJECTS\tr_stdplate\S52.DGN

PROJECT NO:

HWY:

PLOT DATE: 08-MAR-2011 08:54

PLOT NAME :

PLOT BY: mscj9h

PLOT SCALE: 4.965868:1.000000

- 1. Sign is Type II Type F Reflective reference WIS DOT Standard Specification for HIGHWAY and STRUCTURE CONSTRUCTION latest edition.
- 2. Color:

Background - Yellow-Green Message - Black

- 3. Corners may be square or rounded when base material is plywood but borders shall be rounded as shown. When base material is metal, the corners and borders shall be rounded.
- 4. S16-7R are the same as S16-7L except the arrow is reversed along the vertical centerline.

E —	
C H	
<u></u>	>
S16-7L	

SIZE	Α	В	С	D	Ε	F	G	Н	I	7	K	L	M	N	0	Р	0	R	S	Т	U	٧	W	X	Y	Z	Areg sq. ft.
1	24	12	3/8	3/8	1 1/8	3	30°	5 3/4	4	1/2	7																2.0
25	30	18	3/8	1/2	1 1/8	4 ½	30°	8 ½	6	5/8	10 1/4																3.75
2M	30	18	3/8	1/2	1 1/8	4 ½	30°	8 ½	6	5/8	10 1/4																3.75
3	30	18	3/8	1/2	1 1/8	4 1/2	30°	8 ½	6	5/8	10 1/4																3.75
4	48	24	1/2	5/8	1 3/8	6	30°	11 1/2	8	1	14																8.0
5																											

STANDARD SIGN S16-7

WISCONSIN DEPT OF TRANSPORTATION

APPROVED Matthew & Rauch

For State Traffic Engineer

DATE 7/22/13 PLATE NO. S16-7.1

SHEET NO:

HWY:

COUNTY:

PLOT BY : mscj9h

PLOT NAME :

PLOT SCALE : 3.969517:1.000000

WISDOT/CADDS SHEET 42

FILE NAME : C:\CAEFiles\Projects\tr_stdplate\S167.dgn


PROJECT NO:

PLOT DATE: 19-AUG-2013 14:55

- 1. Sign is Type II Type F Reflective reference WIS DOT Standard Specification for HIGHWAY and STRUCTURE CONSTRUCTION latest edition.
- 2. Color:

Background - Yellow-Green Message - Black

- 3. Message Series C
- 4. Corners may be square or rounded when base material is plywood but borders shall be rounded as shown. When base material is metal, the corners and borders shall be rounded.

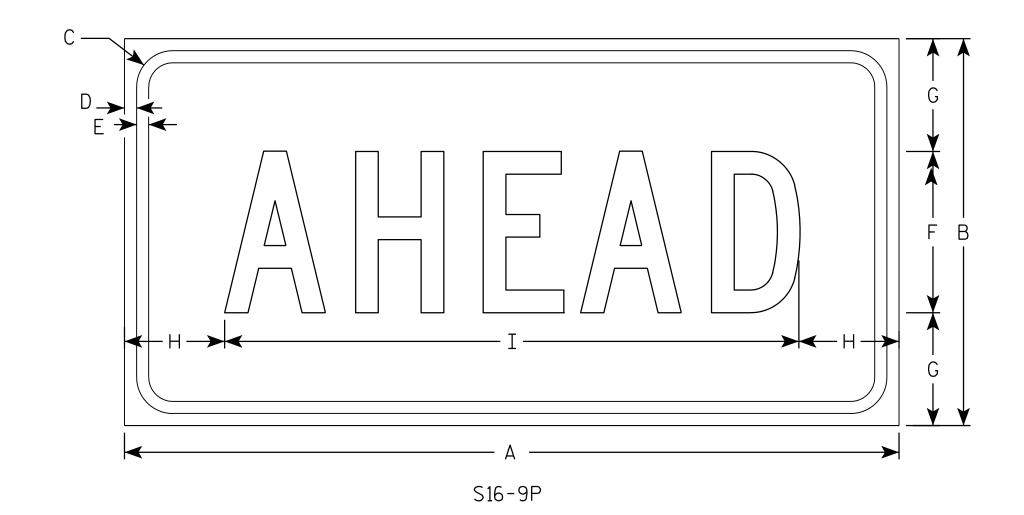

SIZE	Α	В	С	D	E	F	G	Н	I	J	K	L	М	N	0	Р	0	R	S	Т	U	٧	W	Х	Y	Z	Areo sq. ft.
1	24	12	1 1/8	3/8	3/8	5	3 1/2	3 1/8	17 3/4																		2.0
25	30	18	1 1/8	3/8	1/2	7	5 1/2	2 3/4	24 1/2																		3.75
2M	30	18	1 1/8	3⁄8	1/2	7	5 1/2	2 3/4	24 1/2																		3.75
3	30	18	1 1/8	3/8	1/2	7	3 1/2	2 3/4	24 1/2																		3.75
4	48	24	1 3/8	1/2	5/8	10	7	6 1/8	35 ¾																		8.0
5																											

COUNTY:

STANDARD SIGN S16-9P

WISCONSIN DEPT OF TRANSPORTATION

APPROVED

Matther R Rauch

For State Traffic Engineer

DATE 7/22/13

SHEET NO:

HWY:

PROJECT NO:

PLOT NAME :

PLATE NO. S16-9P.1

- 1. Sign is Type II Type F Reflective reference WIS DOT Standard Specification for HIGHWAY and STRUCTURE CONSTRUCTION latest edition.
- 2. Color:

Background - Yellow Message - Black

- 3. Corners may be square or rounded when base material is plywood but borders shall be rounded as shown. When base material is metal, the corners and borders shall be rounded.
- 4. W1-1L is the same as W1-1R except the arrow is reversed along the vertical centerline.

A P N N S N N S N N N N N N N N N N N N N
A1_1L/

SIZE	Α	В	С	D	Е	F	G	Н	I	J	К	L	M	N	0	Р	0	R	S	T	U	٧	W	X	Y	Z	Area sq. ft.
1	24		1 1/8	3/8	1/2		3	3 1/2	7 3/4	5	2 1/2	7 ⁄8	4	1/2	7	9 1/2		5/8	3 1/4								4.0
1 2S	36		1 %	5/8	3/4		4 1/2	5 1/4	11 %	7 1/2	3 %	1 1/4	6	3/4	10 1/2	14 1/4		1	4 %								9.0
2M 3	36		1 %	5/8	₹4		4 1/2	5 1/4	11 %	7 1/2	3 %	1 1/4	6	3/4	10 1/2	14 1/4		1	4 1/8								9.0
3	36		1 %	5/8	3∕4		4 1/2	5 1/4	11 %	7 1/2	3 %	1 1/4	6	3/4	10 1/2	14 1/4		1	4 1/8								9.0
4	48		2 1/4	3/4	1		6	7	15 1/2	10	4 1/8	1 %	8	1	14	19		1 1/4	6 1/2								16.0
5	48		2 1/4	3/4	1		6	7	15 1/2	10	4 1/8	1 %	8	1	14	19		1 1/4	6 1/2								16.0

COUNTY:

STANDARD SIGN W1-1

WISCONSIN DEPT OF TRANSPORTATION

APPROVED Matthe

For State Traffic Engineer

DATE 5/15/12 PLATE NO. W1-1.11

SHEET NO:

FILE NAME : C:\CAEFiles\Projects\tr_stdplate\W11.DGN

PROJECT NO:

HWY:

PLOT DATE: 15-MAY-2012 13:47

PLOT NAME :

PLOT BY: mscsja

PLOT SCALE: 7.939035:1.000000

- 1. Sign is Type II Type F Reflective reference WIS DOT Standard Specification for HIGHWAY and STRUCTURE CONSTRUCTION latest edition.
- 2. Color:

Background - Yellow Message - Black

3. Corners may be square or rounded when base material is plywood but borders shall be rounded as shown. When base material is metal, the corners and borders shall be rounded.

c —	A A
	G
↑ ↑ ↑ ↑ ↑ ↑ ↑ ↑ ↑ ↑ ↑ ↑ ↑ ↑ ↑ ↑ ↑ ↑ ↑	_
$\begin{array}{c ccccccccccccccccccccccccccccccccccc$	
W1-6	

SIZE	Α	В	С	D	E	F	G	Н	I	J	К	L	М	N	0	Р	0	R	S	Т	U	٧	W	X	Y	Z	Area sq. ft.
1	36	18	1 1/8	3/8	3/8		9	10	3/4	5 %	4 3/4	2 3/8	14 %	29 1/4													4.5
2S	48	24	1 3/8	1/2	5/8		12	13 1/4	1	7 1/2	6 1/2	3 1/4	19 1/2	39													8.0
2M	48	24	1 3/8	1/2	5/8		12	13 1/4	1	7 1/2	6 1/2	3 1/4	19 1/2	39													8.0
3	60	30	1 3/8	1/2	5/8		15	16 1/4	1 1/4	9 1/4	8	4	24 3/8	48 3/4													12.5
4	60	30	1 3/8	1/2	5/8		15	16 1/4	1 1/4	9 1/4	8	4	24 3/8	48 3/4													12.5
5	96	48	2 1/4	3∕4	1		24	26 1/2	2	15	13	6 1/2	39	78													32.0

COUNTY:

STANDARD SIGN W1-6

WISCONSIN DEPT OF TRANSPORTATION

APPROVED

For

DATE 6/7/10 PLATE NO. W1-6.8

SHEET NO:

HWY:


PROJECT NO:

PLOT NAME :

- 1. Sign is Type II Type F Reflective reference WIS DOT Standard Specification for HIGHWAY and STRUCTURE CONSTRUCTION latest edition.
- 2. Color:

Background - Yellow Message - Black

3. Corners may be square or rounded when base material is plywood but borders shall be rounded as shown. When base material is metal, the corners and borders shall be rounded.

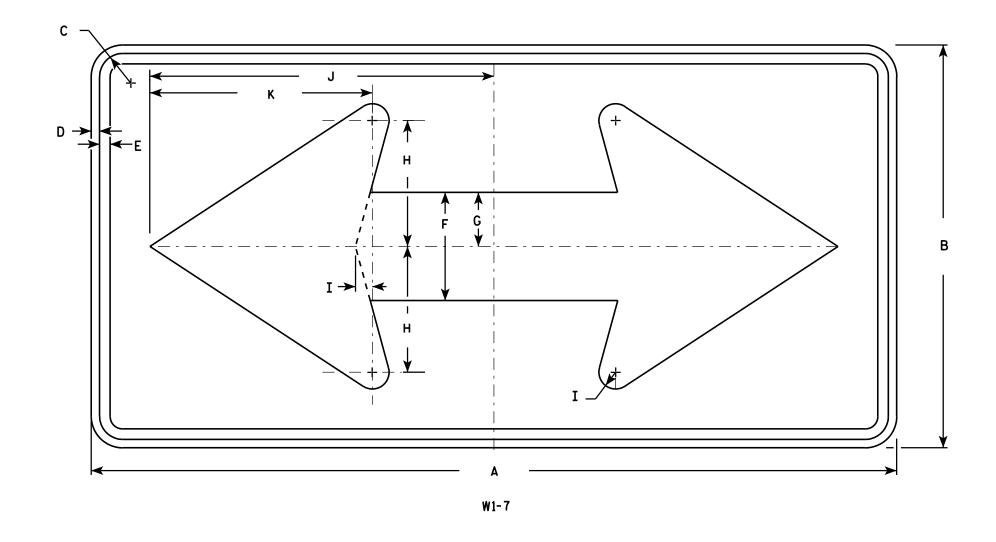

SIZE	Α	В	С	D	E	F	G	Н	I	J	K	L	М	N	0	Р	0	R	S	T	U	٧	₩	Х	Y	Z	Area sq. ft.
1	36	18	1 1/8	3⁄8	1/2	5	2 1/2	5 ¾	3/4	15 5/8	10 1/8																4.5
2S	48	24	1 3/8	1/2	5/8	6 1/2	3 1/4	7 1/2	1	20 1/2	13 1/4																8.0
2M	48	24	1 3/8	1/2	5/8	6 1/2	3 1/4	7 1/2	1	20 1/3	13 1/4																8.0
3	60	30	1 3/8	1/2	5/8	8	4	9 1/4	1 1/4	25 3/8	16 1/4																12.5
4	60	30	1 3/8	1/2	5/8	8	4	9 1/4	1 1/4	25 3/	16 1/4																12.5
5	96	48	2 1/4	3/4	1	13	6 1/2	15	2	41	26 1/2																32.0

COUNTY:

STANDARD SIGN W1-7

WISCONSIN DEPT OF TRANSPORTATION

APPROVED

Matthew R

For State Traffic Engineer

DATE 6/7/10 PLATE NO. W1-7.7

SHEET NO:

FILE NAME : C:\Users\PROJECTS\tr_stdplate\W17.DGN

PROJECT NO:

HWY:

PLOT DATE: 07-JUN-2010 12:35

PLOT BY : ditjph

PLOT NAME :


PLOT SCALE: 5.720679:1.000000

- 1. Sign is Type II Type F Reflective reference WIS DOT Standard Specification for HIGHWAY and STRUCTURE CONSTRUCTION latest edition.
- 2. Color: *

 Background YELLOW*

 Message BLACK
- 3. Message Series C for numbers Series E for wording
- 4. Substitute appropriate numerals and optically adjust spacing to achieve proper balance

*Speed Limit Sign shall have a White Background

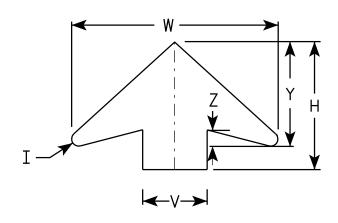

ARROW DETAIL

SIZE	Α	В	С	D	E	F	G	н	I	J	K	L	М	N	0	Р	0	R	S	T	U	٧	W	X	Y	Z	Area sq. ft
1																											
25	36		1 1/8	5/8	3/4	14 1/2	9 1/2	11 1/2	5/8	24	2	3	1	12	7 1/8	1 1/2	3/8	5 3/4	7 1/4	7 1/8	9	6	19 1/4	3/8	9 3/4	1 %	9.0
2M	36		1 %	5/8	3/4	14 1/2	9 1/2	11 1/2	5/8	24	2	3	1	12	7 1/8	1 1/2	3/8	5 3/4	7 1/4	7 1/8	9	6	19 1/4	3/8	9 3/4	1 %	9.0
3	36		1 %	5/8	3/4	14 1/2	9 1/2	11 1/2	5/8	24	2	3	1	12	7 1/8	1 1/2	3∕8	5 3/4	7 1/4	7 1/8	9	6	19 1/4	3/8	9 3/4	1 %	9.0
4	48		2 1/4	3/4	1	19 1/4	10 3/4	17 3/8	1 /8	30	2 1/4	4	1 1/4	15	10	1 %	1/2	8	9 1/4	9 3/8	12	8	25 %	3∕8	13	2	16.0
5	48		2 1/4	3/4	1	19 1/4	10 3/4	17 3/8	7 ⁄8	30	2 1/4	4	1 1/4	15	10	1 5/8	1/2	8	9 1/4	9 3/8	12	8	25 5/8	3/8	13	2	16.0

STANDARD SIGN W3-5

WISCONSIN DEPT OF TRANSPORTATION

APPROVED

Matther R Rauch.

DATE 5/29/12 PLATE NO. W3-5.5


SHEET NO:

PROJECT NO:

- 1. Sign is Type II Type F Reflective reference WIS DOT Standard Specification for HIGHWAY and STRUCTURE CONSTRUCTION latest edition.
- 2. Color:

Background - Yellow Message - Black

- 3. Corners may be square or rounded when base material is plywood but borders shall be rounded as shown. When base material is metal, the corners and borders shall be rounded.
- 4. W4-2L is the same as W4-2R except the symbolis reversed along the vertical centerline.

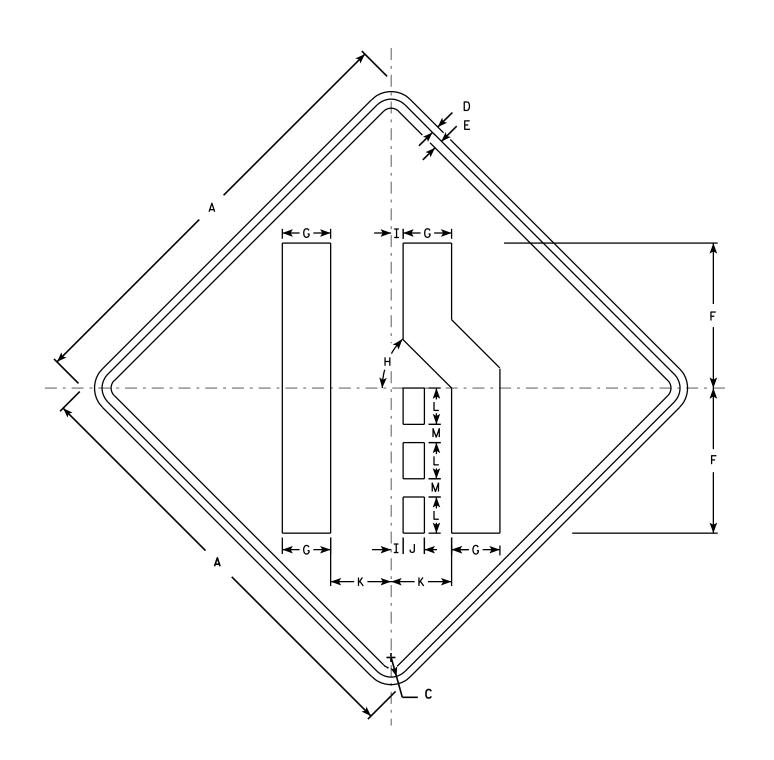

W4-2R

Z	Y	Х	W	٧	U	T	S	R	0	Р	0	N	M	L	K	J	I	Н	G	F	E	D	С	В	Α	SIZE
													1 1/4	2 1/2	4 1/4	1 1/2	1 / ₈	45°	3 %	10	5/8	1/2	1 3/8		30	1
	1												1 1/2	3	5	1 3/4	1	45°	4	12	3/4	5/8	1 %		36	25
	1												1 1/2	3	5	1 3/4	1	45°	4	12	3/4	5/8	1 %		36	2M
9													1 1/2	3	5	1 3/4	1	45°	4	12	3/4	5/8	1 1/8		36	3
1													2	4	6 ¾	2 3/8	1 1/4	45°	5	16	1	3/4	2 1/4		48	4
	1												2	4	6 3/4	2 3/8	1 1/4	45°	5	16	1	3/4	2 1/4		48	5
=	=												2	4	6 3/4	2 3/8	1 1/4	45°	5 3/8	16	1	3 /4	2 1/4	NO:	48 JECT	

STANDARD SIGN W4-2

WISCONSIN DEPT OF TRANSPORTATION

APPROVED

DATE 3/12/13


PLATE NO. W4-2.14 SHEET NO:

For State Traffic Engineer

FILE NAME : C:\CAEFiles\Projects\tr_stdplate\W42.DGN

PLOT DATE: 12-MAR-2013 11:09

PLOT BY: mscsja

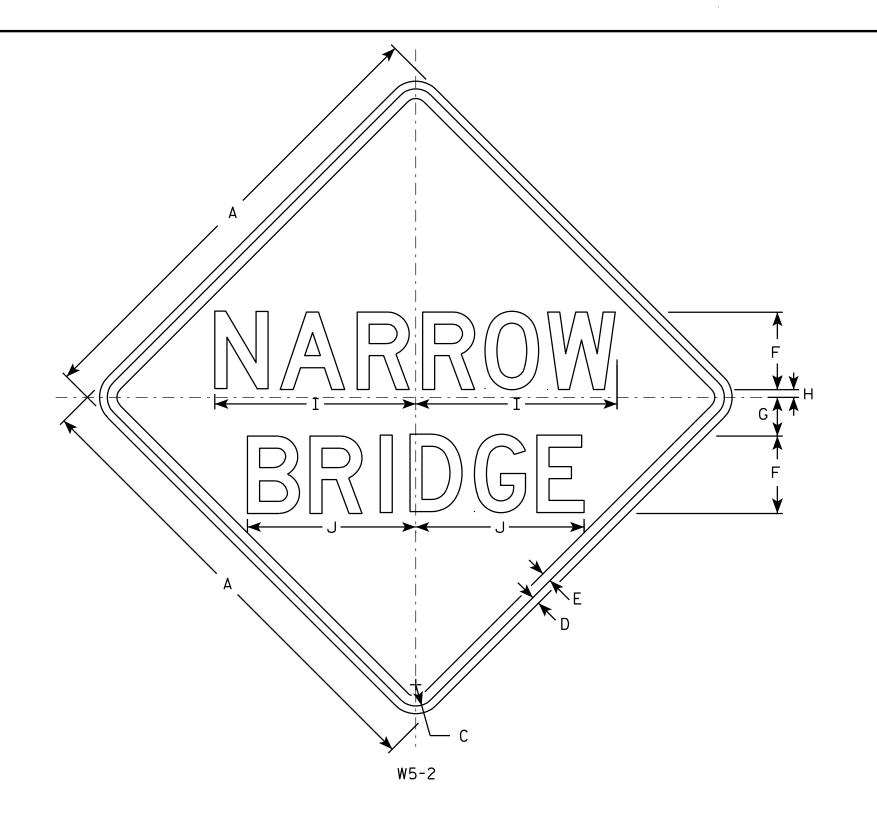

- 1. Sign is Type II Type F Reflective reference WIS DOT Standard Specification for HIGHWAY and STRUCTURE CONSTRUCTION latest edition.
- 2. Color:

Background - Yellow Message - Black

- 3. Message Series D
- 4. Corners may be square or rounded when base material is plywood but borders shall be rounded as shown. When base material is metal, the corners and borders shall be rounded.

SIZE A 1/2 5/8 5 2 1/2 30 1 3/8 1/2 13 10 1/8 6.25 2S 36 1 5/8 5/8 3/4 3/₄ | 15 5/₈ | 13 1/₈ 6 9.0 2M 36 1 5/8 5/8 ₹4 15 % 13 1/8 6 9.0 3 5/8 3/₄ | 15 5/₈ | 13 1/₈ 36 1 1/8 ₹4 9.0 2 1/4 3/4 3/₄ 20 3/₄ 17 3/₈ 4 16.0 5 HWY: COUNTY: PROJECT NO:

STANDARD SIGN W5 - 2

WISCONSIN DEPT OF TRANSPORTATION

APPROVED

for State Traffic Engineer DATE 03/12/13 PLATE NO. W5-2.8

SHEET NO:

FILE NAME : C:\CAEFiles\Projects\tr_stdplate\W52.DGN

PLOT DATE: 12-MAR-2013 13:50

PLOT NAME :

PLOT BY: mscsja

PLOT SCALE: 6.202372:1.000000





- 1. Sign is Type II Type F Reflective reference WIS DOT Standard Specification for HIGHWAY and STRUCTURE CONSTRUCTION latest edition.
- 2. Color:

Background - Yellow Message - Black

- 3. Message Series D
- 4. Corners may be square or rounded when base material is plywood but borders shall be rounded as shown. When base material is metal, the corners and borders shall be rounded.
- 5. W9-1L same as W9-1R except the word Left replaces Right.

	I -			J —							-1R						G A		
+	C 1 3/	D I/-	E 5/	F	G	9 I/-	I	J 7 5/	K	L L	M 7 5/	N 5/	0	Р	0	R	S	T	U

SIZE	Α	В	С	D	E	F	G	Н	I	J	К	L	M	N	0	Р	0	R	S	T	U	v	W	X	Y	Z	Area sq. ft.
1	30		1 3/8	1/2	5/8	5	1 1/2	2 1/2	7 1/8	7 %	9 1/4	8 1/8	7 %	8 %													6.25
2S	36		1 5/8	5/8	3/4	6	2	3	8 1/2	9 1/8	11	9 3/4	9	10 3/8													9.0
2M	36		1 5/8	5/8	3/4	6	2	3	8 1/2	9 1/8	11	9 3/4	9	10 3/8													9.0
3	36		1 5/8	5/8	3/4	6	2	3	8 1/2	9 1/8	11	9 3/4	9	10 3/8													9.0
4	36		1 5/8	5/8	3/4	6	2	3	8 ½	9 1/8	11	9 3/4	9	10 3/8													9.0
5	48		2 1/4	3/4	1	8	3	4	11 1/4	12 1/4	14 3/4	12 1/8	12 1/4	13 %													16.0
PRO.	JECT	NO:																									

STANDARD SIGN W9-1

WISCONSIN DEPT OF TRANSPORTATION

APPROVED

For State Traffic Engineer

DATE 03/18/13

PLATE NO. W9-1.8

SHEET NO:

1. Sign is Type II - Type F Reflective - reference WIS DOT Standard Specification for HIGHWAY and STRUCTURE CONSTRUCTION latest edition.

2. Color:

Background - Yellow Message - Black

3. Corners may be square or rounded when base material is plywood but borders shall be rounded as shown. When base material is metal, the corners and borders shall be rounded.

A T T T T T T T T T T T T T T T T T T T	
W11-6	- 11

3/8 9 1/2 4 1/2 10 1/4 1 1/8 24 4.0 25 11 1/2 5 5/8 12 3/4 1 3/8 1/2 5/8 6.25 30 2M 1 3/8 1/2 11 1/2 5 5/8 12 3/4 30 6.25 3 1 1/8 5/8 3/4 14 1/8 6 3/4 15 1/4 9.0 36 4 3/4 48 2 1/4 19 9 20 1/2 16.0 5

COUNTY:

STANDARD SIGN W11-6

WISCONSIN DEPT OF TRANSPORTATION

APPROVED Matther R Rauch ∱er State Traffic Engineer DATE 3/13/13 PLATE NO. W11-6.8

SHEET NO:

FILE NAME : C:\CAEFiles\Projects\tr_stdplate\W116.DGN

HWY:

PROJECT NO:

PLOT DATE: 13-MAR-2013 12:57

PLOT BY : mscj9h

PLOT NAME :

PLOT SCALE : 5.954276:1.000000

WISDOT/CADDS SHEET 42


Ε





- 1. Sign is Type II Type F Reflective reference WIS DOT Standard Specification for HIGHWAY
 - and STRUCTURE CONSTRUCTION latest edition.
- 2. Color:

Background - Yellow Message - Black

- 3. Message Series D
- 4. Corners may be square or rounded when base material is plywood but borders shall be rounded as shown. When base material is metal, the corners and borders shall be rounded.
- 5. Substitute appropriate numerals and optically adjust spacing of numerals, hyphen, foot & inch marks to achieve proper balance.

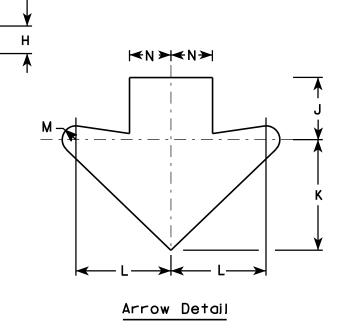

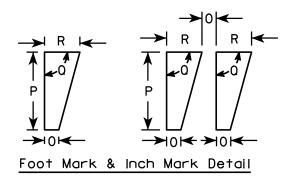

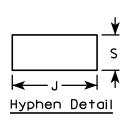

SIZE	Α	В	С	D	Ε	F	G	н	I	J	K	L	М	N	0	Р	0	R	S	Т	U	٧	W	X	Y	Z	Are sq.
1	30		1 3/8	1/2	5/8		5	1 %	3 3/8	3 3/4	6 %	5 3/4	3/4	2 1/2	1/2	2 1/4	90°	1	1 1/8								6.2
25	36		1 %	5/8	₹4		6	2	4	4 1/2	8	6 %	1	3	1/2	2 3/4	90°	1 1/4	1 %								9.0
2M	36		1 %	5/8	₹4		6	2	4	4 1/2	8	6 %	1	3	1/2	2 3/4	90°	1 1/4	1 %								9.
3	36		1 %	5/8	₹4		6	2	4	4 1/2	8	6 %	1	3	1/2	2 3/4	90°	1 1/4	1 %								9.
4	36		1 %	5/8	3/4		6	2	4	4 1/2	8	6 %	1	3	1/2	2 3/4	90°	1 1/4	1 %								9.
5	48		2 1/4	3/4	1		8	2 5/8	5 1/2	5 %	10 %	9 1/4	1 3/8	4	5/8	3 %	90°	1 5/8	2 1/2								16

COUNTY:

W12-2

HWY:

STANDARD SIGN
W12-2

WISCONSIN DEPT OF TRANSPORTATION

APPROVED

Matthew R Rauch
For State Traffic Engineer
DATE 3/13/13 PLATE NO. W12-2.9

SHEET NO:

FILE NAME: C:\CAEFiles\Projects\tr_stdplate\W122.DGN


PROJECT NO:

PLOT DATE: 13-MAR-2013 13:27

PLOT BY: mscj9h

PLOT NAME :

PLOT SCALE: 6.946657:1.000000

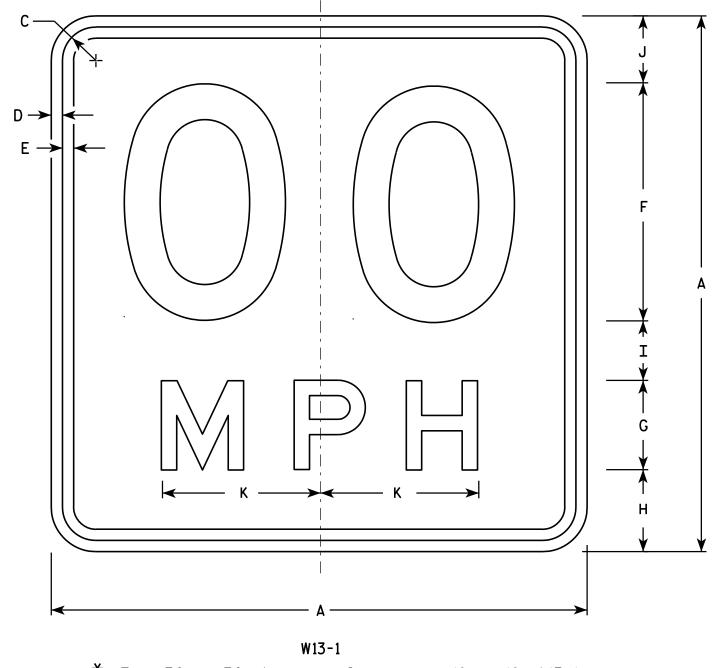

- 1. Sign is Type II Type F Reflective reference WIS DOT Standard Specification for HIGHWAY and STRUCTURE CONSTRUCTION latest edition.
- 2. Color:

Background - Yellow Message - Black

- 3. Message Series See Note 6
- 4. Corners may be square or rounded when base material is plywood but borders shall be rounded as shown. When base material is metal, the corners and borders shall be rounded.
- 5. Substitute appropriate numerals and optically space about centerline to achieve proper balance.
- 6. Line 1 is Series D Line 2 is Series E

* For 30" \times 30" Warning Signs, use 18" \times 18" W13-1 signs. For 36" \times 36" Warning Signs, use 24" \times 24" W13-1 signs.

SIZE	A	В	С	D	E	F	G	Н	I	J	К	L	М	N	0	Р	0	R	S	T	U	٧	W	X	Y	Z	Area sq. ft.
1	18		1 1/8	3∕8	3/8	8	3	2 3/4	2	2 1/4	5 3/8																2.25
* 2S	18		1 1/8	3∕8	3/8	8	3	2 3/4	2	2 1/4	5 %																2.25
* 2M	18		1 1/8	3/8	3/8	8	3	2 3/4	2	2 1/4	5 3/8																2.25
3	24		1 1/8	3/8	1/2	10	4	4	2 3/4	3 1/4	6 5/8																4.00
4	36		1 1/8	5/8	3/4	16	6	5 1/2	4	4 1/2	10 %																9.00
5	36		1 5/8	5/8	3/4	16	6	5 1/2	4	4 1/2	10 %																9.00

STANDARD SIGN W13-1

WISCONSIN DEPT OF TRANSPORTATION

APPROVED

Matthew & Ram

 f_{or} State Traffic Engineer S1/12 PLATE NO. W13-1.16

DATE <u>5/31/12</u>

SHEET NO:


FILE NAME : C:\CAEFiles\Projects\tr_stdplate\W131.DGN

PLOT DATE: 31-MAY-2012 10:57

PLOT NAME :

PLOT BY: mscsja

PLOT SCALE: 3.225232:1.000000

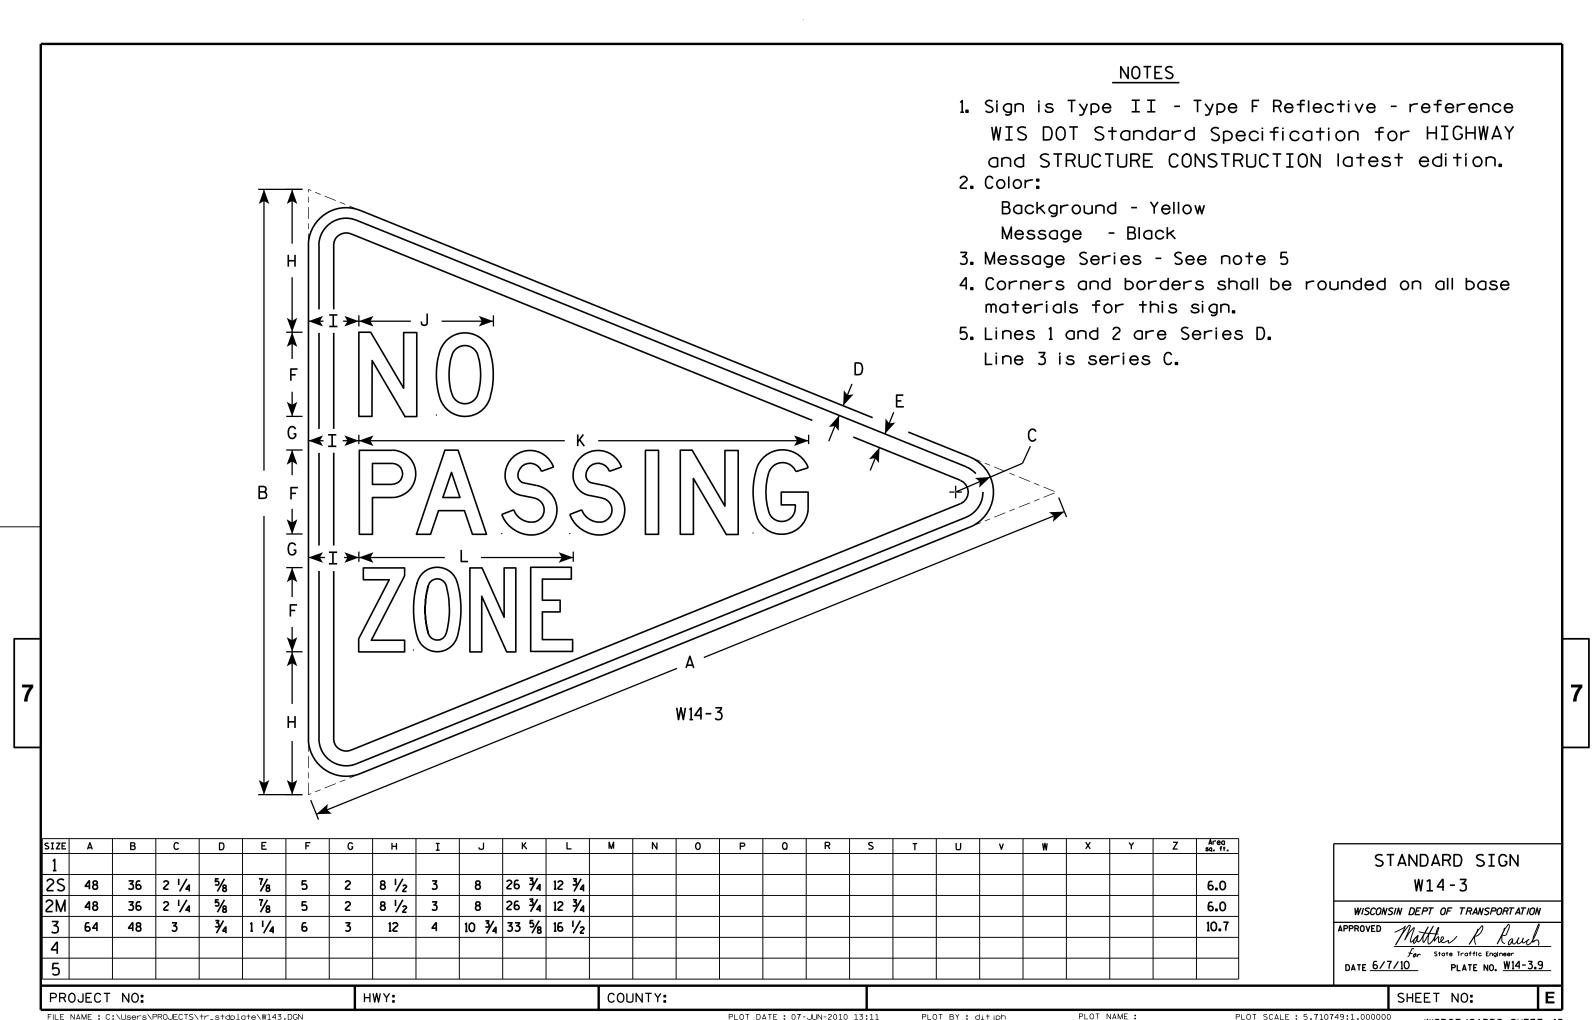

FILE NAME : C:\Users\PROJECTS\tr_stdplate\W143.DGN

PLOT DATE: 07-JUN-2010 13:11

PLOT BY: ditjph

PLOT SCALE: 5.710749:1.000000

Notes



Wisconsin Department of Transportation

Dedicated people creating transportation solutions through innovation and exceptional service.

http://www.dot.wisconsin.gov