### LAX JUNE 2016

#### ORDER OF SHEETS

Estimate of Quantities Miscellaneous Quantities Plan and Profile Section No. 5 Standard Detail Drawings

Sign Plates

TOTAL SHEETS = 102

#### Section No. 1 Section No. 2 Typical Sections and Details Section No. 3 Section No. 3

#### DESIGN DESIGNATION

A.A.D.T. 2018 = 21,500 A.A.D.T. 2038 = 25,500 D.H.V. = 13.515 D.D. = 53/47 = 9.2% DESIGN SPEED = 35 MPH ESALS = 4,300,000

#### CONVENTIONAL SYMBOLS

PI AN

CORPORATE LIMITS PROPERTY LINE LOT LINE LIMITED HIGHWAY EASEMENT EXISTING RIGHT OF WAY PROPOSED OR NEW R/W LINE SLOPE INTERCEPT REFERENCE LINE EXISTING CULVERT PROPOSED CULVERT

COMBUSTIBLE FLUIDS

MARSH AREA

WOODED OR SHRUB AREA

GRADE LINE ORIGINAL GROUND MARSH OR ROCK PROFILE (To be noted as such) SPECIAL DITCH GRADE ELEVATION CULVERT (Profile View) UTILITIES ELECTRIC

TELEPHONE POLE

PROFILE

FIBER OPTIC SANITARY SEWER STORM SEWER TELEPHONE UTILITY PEDESTAL POWER POLE

₫

# STATE OF WISCONSIN DEPARTMENT OF TRANSPORTATION


PLAN OF PROPOSED IMPROVEMENT

# LANG DRIVE, C LA CROSSE

LACROSSE STREET TO B-32-62

## **STH 35** LA CROSSE COUNTY

STATE PROJECT NUMBER 5221-03-71

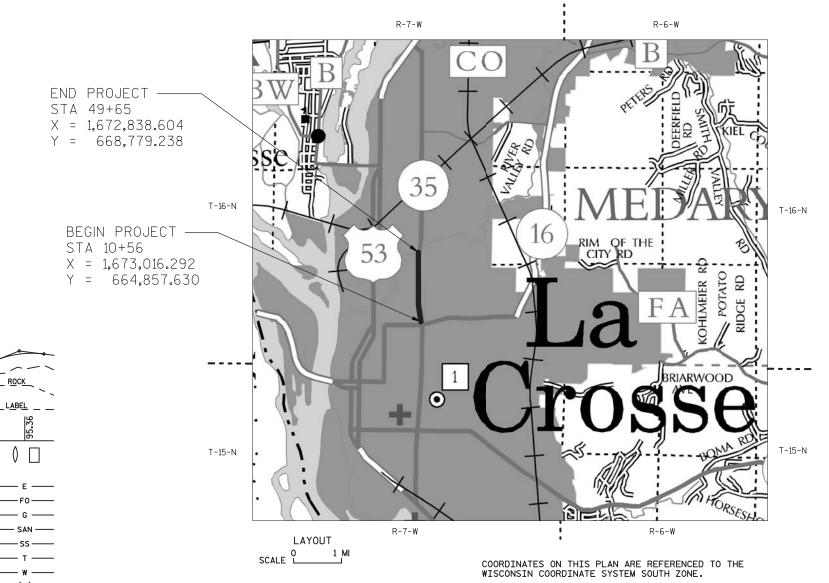

STATE PROJECT	PROJECT	CONTRACT
5221-03-71	WISC 2016220	1

FEDERAL PROJECT

#### STATE OF WISCONSIN DEPARTMENT OF TRANSPORTATION

PREPARED BY WISDOT Surveyor Designer Project Manage MIKE RUD Regional Supervisor.

TOTAL NET LENGTH OF CENTERLINE = 0.740 MI

COORDINATE SYSTEM.

ELEVATIONS ON THIS PLAN ARE REFERENCED TO AN ASSUMED

THERE ARE UTILITY FACILITIES WITHIN THE PROJECT THAT ARE NOT SHOWN ON THE PLANS. THE CONTRACTOR SHALL COORDINATE HIS CONSTRUCTION ACTIVITIES WITH A CALL TO DIGGERS HOTLINE AND/OR A DIRECT CALL TO THE UTILITIES THAT HAVE FACILITIES IN THE AREA. NOT ALL UTLLITIES ARE MEMBERS OF DIGGERS HOTLINE.

**GENERAL NOTES** 

NO TREES OR SHRUBS ARE TO BE REMOVED WITHOUT APPROVAL OF THE ENGINEER.

CONTRACTOR WILL BE RESPONSIBLE FOR RESHAPING AND SEEDING ANY PREVIOUSLY GRASSED AREAS WHICH ARE DISTURBED BY HIS OPERATION OUTSIDE OF THE NORMAL CONSTRUCTION LIMITS.

PURSUANT TO CHATPER 59 OF THE WISCONSIN STATUTES, THE CONTRACTOR SHALL CAREFULY MAKE A SEARCH FOR EVIDENCE OF A LANDMARK IN ALL AREAS WHERE SUCH A LANDMARK MAY EXIST.

WORK WITH THE UTMOST CARE AND PROTET ALL SURVEY MARKERS. REMOVAL OF ANY SURVEY MARKERS IS TO BE WITH THE APPROVAL OF THE ENGINEER.

HMA PAVEMENT WEIGHT CALCULATIONS ARE BASED ON 112 LB/SY/IN.

PLACE 2" HMA PAVEMENT IN ONE LAYER. PLACE 7" HMA PAVEMENT IN THREE LAYERS, 2" UPPER AND 2.5" LOWER LAYERS.

APPLY TACK COAT BETWEEN NEW LAYERS OF HMA PAVEMENT AND EXISTING PAVEMENT AT A RATE OF 0.07 GAL/SY. APPLY TACK COAT BETWEEN NEW LAYERS OF HMA PAVEMENT AT A RATE OF 0.05 GAL/SY.

THE CONTRACTOR'S PAVING OPERATIONS SHALL BE CONSISTENT WITH THE PLAN TYPICAL SECTIONS AND CONSTRUCTED TO PREVENT HMA LONGITUDINAL JOINTS FROM BEING LOCATIONED WITHIN A DRIVING. TURNING. BIKE OR PARKING LANE.

#### **UTILITY CONTACTS**

CITY OF LA CROSSE, SEWER CENTURY LINK, COMMUNICATION TOM MURRAY RANDY TURTENWALD 333 N. FRONT STREET 400 LA CROSSE STREET LA CROSSE, WI 54601 LA CROSSE, WI 54601 PHONE: 608-796-7869 PHONE: 608-789-7505 MOBILE: 608-780-0895 MOBILE: N/A

CITY OF LA CROSSE, WATER EXCEL ENERGY, ELECTRICITY RANDY TURTENWALD JAYMIE HOLTE 400 LA CROSSE STREET 3215 COMMERCE STREET LA CROSSE, WI 54601 LA CROSSE, WI 54603 PHONE: 608-789-7505 PHONE: 608-789-3698 MOBILE: N/A MOBILE: 608-780-9881

EXCEL ENERGY, GAS/PETROLEUM EXCEL ENERGY, TRANSMISSION

WINDSTREAM KDL, INC, COMMUNICATION

JAYMIE HOLTE **BRUCE ZEMKE** 

3215 COMMERCE STREET 414 NICOLLER MALL, MP-8 LA CROSSE, WI 54603 MINNEAPOLIS, MN 55401 PHONE: 608-789-3698 PHONE: 612-330-7815 MOBILE: 608-780-9881 MOBILE: 651-214-2620

NORTHERN NATURAL GAS COMPANY, GAS/PETROLEUM

LEONARD KLAAS AARON GRODI 5557 COUNTY D 1858 WRIGHT STREET PLATTEVILLE, WI 53818 MADISON, WI 53704 PHONE: 402-530-2806 PHONE: 608-819-5014 MOBILE: 608-778-8514 MOBILE: 919-770-1778

#### **DESIGN CONTACTS**

TODD WALDO PROJECT MANAGER WISDOT SW REGION 3550 MORMON COULEE ROAD LA CROSSE, WI 54601 PHONE: 608-386-6408 EMAIL: Todd.Waldo@dot.wi.gov

ALEIGHA BURG PROJECT DESIGNER WISDOT SW REGION 3550 MORMON COULEE ROAD LA CROSSE, WI 54601 PHONE:608-317-9083

EMAIL: Aleigha.Burg@dot.wigov

#### **ENVIRONMENTAL CONTACT**

KAREN KALVELAGE

ENVIRONMENTAL ANALYSIS & REVIEW SPECIALIST WISCONSIN DEPT. OF NATURAL RESOURCES

WEST CENTRAL REGION 3550 MORMON COULEE ROAD LA CROSSE, WI 54601 PHONE: (608) 785-9115

EMAIL: Karen.Kalvelage@wisconsin.gov


#### STANDARD ABBREVIATIONS

AGG	AGGREGATE	NC	NORMAL CROWN
<	ANGLE	NB	NORTHBOUND
AE, AEW	APRON ENDWALL	NOR	NORMAL
ASPH	ASPHALTIC	NO	NUMBER
A.D.T.	AVERAGE DAILY TRAFFIC	PAV'T	PAVEMENT
A.A.D.T.	ANNUAL AVERAGE DAILY TRAFFIC	PC	POINT OF CURVATURE
Δ	CENTRAL ANGLE OR DELTA	Pl	POINT OF INTERSECTION
CMCP	CORRUGATED METAL CULVERT PIPE	PT	POINT OF TANGENCY
CMP	CORRUGATED METAL PIPE	PE	PRIVATE ENTRANCE
CABC	CRUSHED A GGREGATE BASE COURSE	R	RADIUS OR RANGE
CP	CONTROL POINT OR CULVERT PIPE	RCCP	REINFORCED CONCRETE CULVERT PIF
D	DEGREE OF CURVE	REQ'D	REQUIRED
D.H.V.	DESIGN HOURLY VOLUME	SHLD	SHOULDER(S)
D.D.	DIRECTIONAL DISTRIBUTION	SB	SOUTHBOUND
EB	EASTBOUND	S.D.D.	STANDARD DETAIL DRAWING(S)
ESALS	EQUIVALENT SINGLE AXLE LOADS	T.	PERCENT TRUCKS
EXC	EXCAVATION	TYP	TYPICAL
FERT	FERTILIZER	VAR	VARIABLE
CWT	HUNDRED WEIGHT	VC	VERTICAL CURVE
INTER	INTERSECTION	VPC	VERTICAL POINT OF CURVATURE
L	LENGTH OF CURVE	VPI	VERTICAL POINT OF INTERSECTION
LC	LONG CHORD	VPT	VERTICAL POINT OF TANGENCY
MGAL	1000 GALLONS	WB	WESTBOUND




Ε HWY: STH 35 **COUNTY: LA CROSSE GENERAL NOTES** SHEET: PROJECT NO: 5221-03-71

PIPE

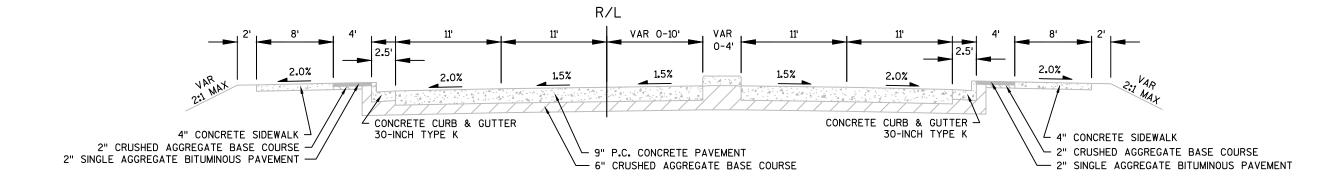

EXISTING TYPICAL SECTION STH 35 STA 10+56 TO STA 13+20

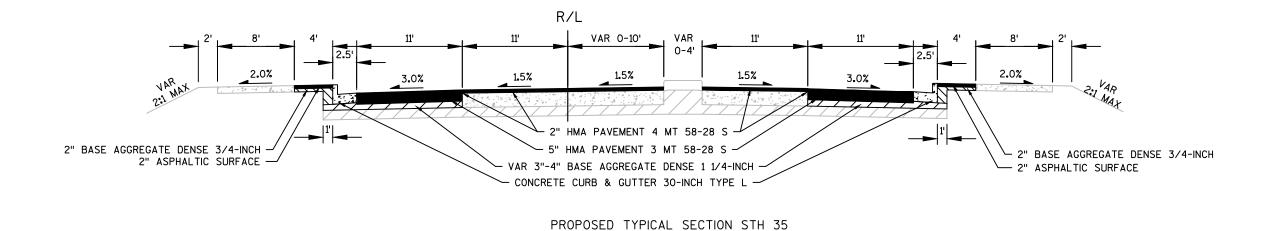

NOTE: SEE CONSTRUCTION DETAIL FOR OUTSIDE LANE AND CURB AND GUTTER REPLACEMENT

COUNTY: LA CROSSE TYPICAL SECTIONS SHEET E PROJECT NO:5221-03-71 HWY:STH 35 FILE NAME : H:\52210301\_C3D\SHEETSPLAN\020301\_TS.DWG

STA 10+56 TO STA 13+20

30-INCH TYPE K

#### EXISTING TYPICAL SECTION STH 35 STA 13+20 TO STA 49+65

9" P.C. CONCRETE PAVEMENT


- 6" CRUSHED AGGREGATE BASE COURSE


30-INCH TYPE K

4" CONCRETE SIDEWALK

- 2" CRUSHED AGGREGATE BASE COURSE

2" SINGLE AGGREGATE BITUMINOUS PAVEMENT

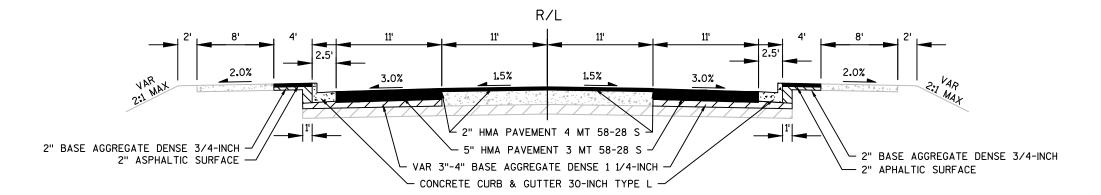

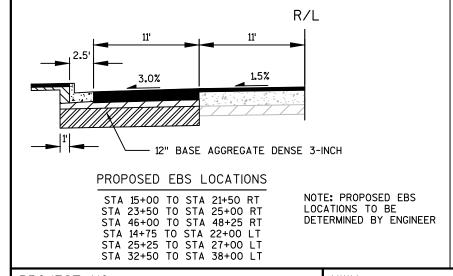

PROPOSED TYPICAL SECTION STH 35 STA 13+20 TO STA 49+65

> NOTE: SEE CONSTRUCTION DETAIL FOR OUTSIDE LANE AND CURB AND GUTTER REPLACEMENT

HWY:STH 35 TYPICAL SECTIONS Ε **PROJECT NO:**5221-03-71 COUNTY: LA CROSSE SHEET FILE NAME : H:\52210301\_C3D\SHEETSPLAN\020301\_TS.DWG PLOT BY: BURG, ALEIGHA J PLOT NAME:


PLOT DATE: 4/1/2016 3:42 PM


4" CONCRETE SIDEWALK


2" CRUSHED AGGREGATE BASE COURSE -


2" SINGLE AGGREGATE BITUMINOUS PAVEMENT —



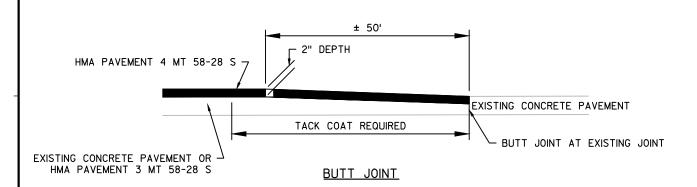

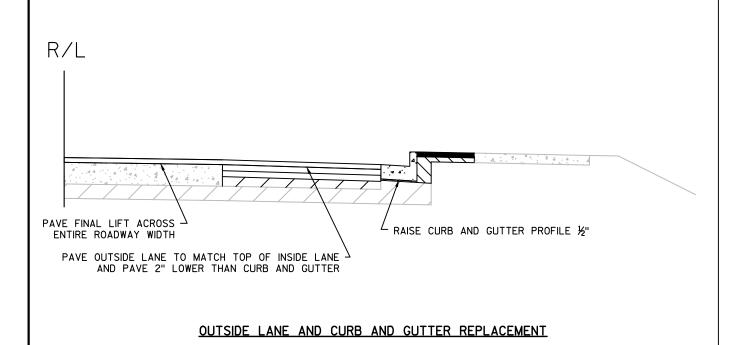


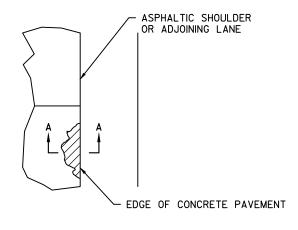


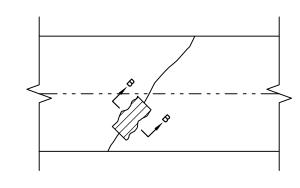

PLAN VIEW

PLAN VIEW

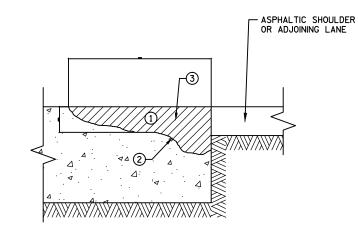

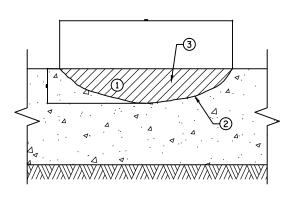

SECTION A-A

SECTION B-B

- 1 REMOVE ALL UNSOUND AND DETERIORATED MATERIAL.
- ② BLOW OUT REPAIR AREAS WITH 80 PSI MINIMUM COMPRESSED AIR AND APPLY TACK COAT.
- 3) ASPHALTIC SURFACE INCIDENTAL TO ITEM

EDGE REPAIR


- 1 REMOVE ALL UNSOUND AND DETERIORATED MATERIAL.
- ② BLOW OUT REPAIR AREAS WITH 80 PSI MINIMUM COMPRESSED AIR AND APPLY TACK COAT.
- 3 ASPHALTIC SURFACE INCIDENTAL TO ITEM


CRACK/JOINT REPAIR

CONCRETE JOINT AND CRACK CLEANING

PROJECT NO:5221-03-71 HWY:STH 35 COUNTY:LA CROSSE CONSTRUCTION DETAILS SHEET **E** 



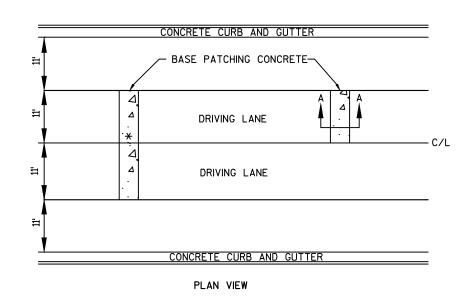

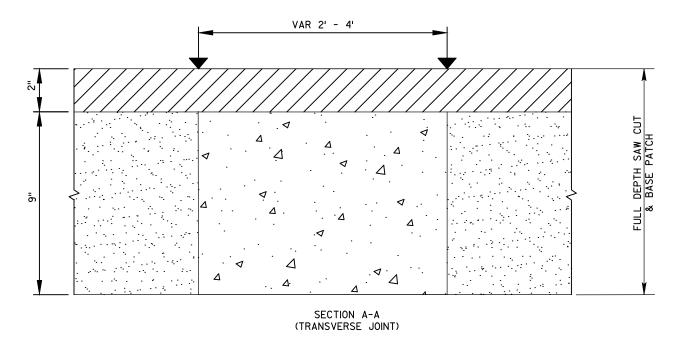

HMA PAVEMENT 4 MT 58-28 S

. 4 ·

BASE PATCHING CONCRETE




EXISTING P.C. CONCRETE PAVEMENT TO REMAIN



FULL DEPTH SAW CUT REQUIRED

\* HAND-TOOLED JOINT - 3" DEPTH

### BASE PATCHING CONCRETE

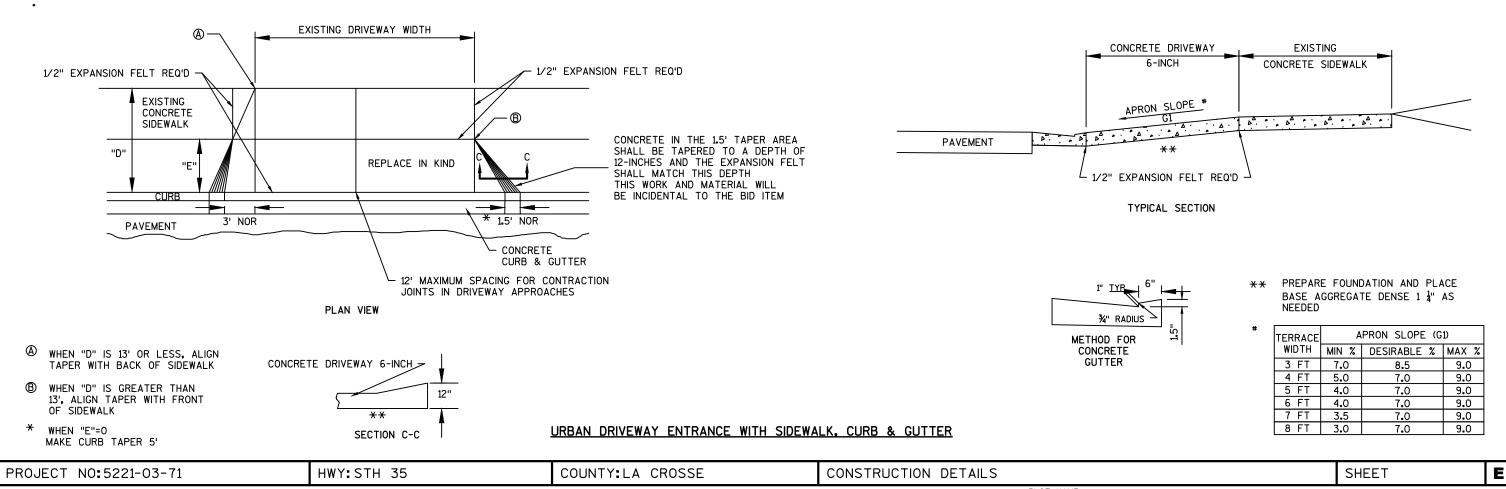

FILE NAME: H:\52210301\_C3D\SHEETSPLAN\021001\_CD.DWG


PLOT DATE : 3/28/2016 12:21 PM

PLOT BY : BURG, ALEIGHA J


PLOT NAME :


PLOT SCALE : 1 IN:10 FT


WISDOT/CADDS SHEET 42

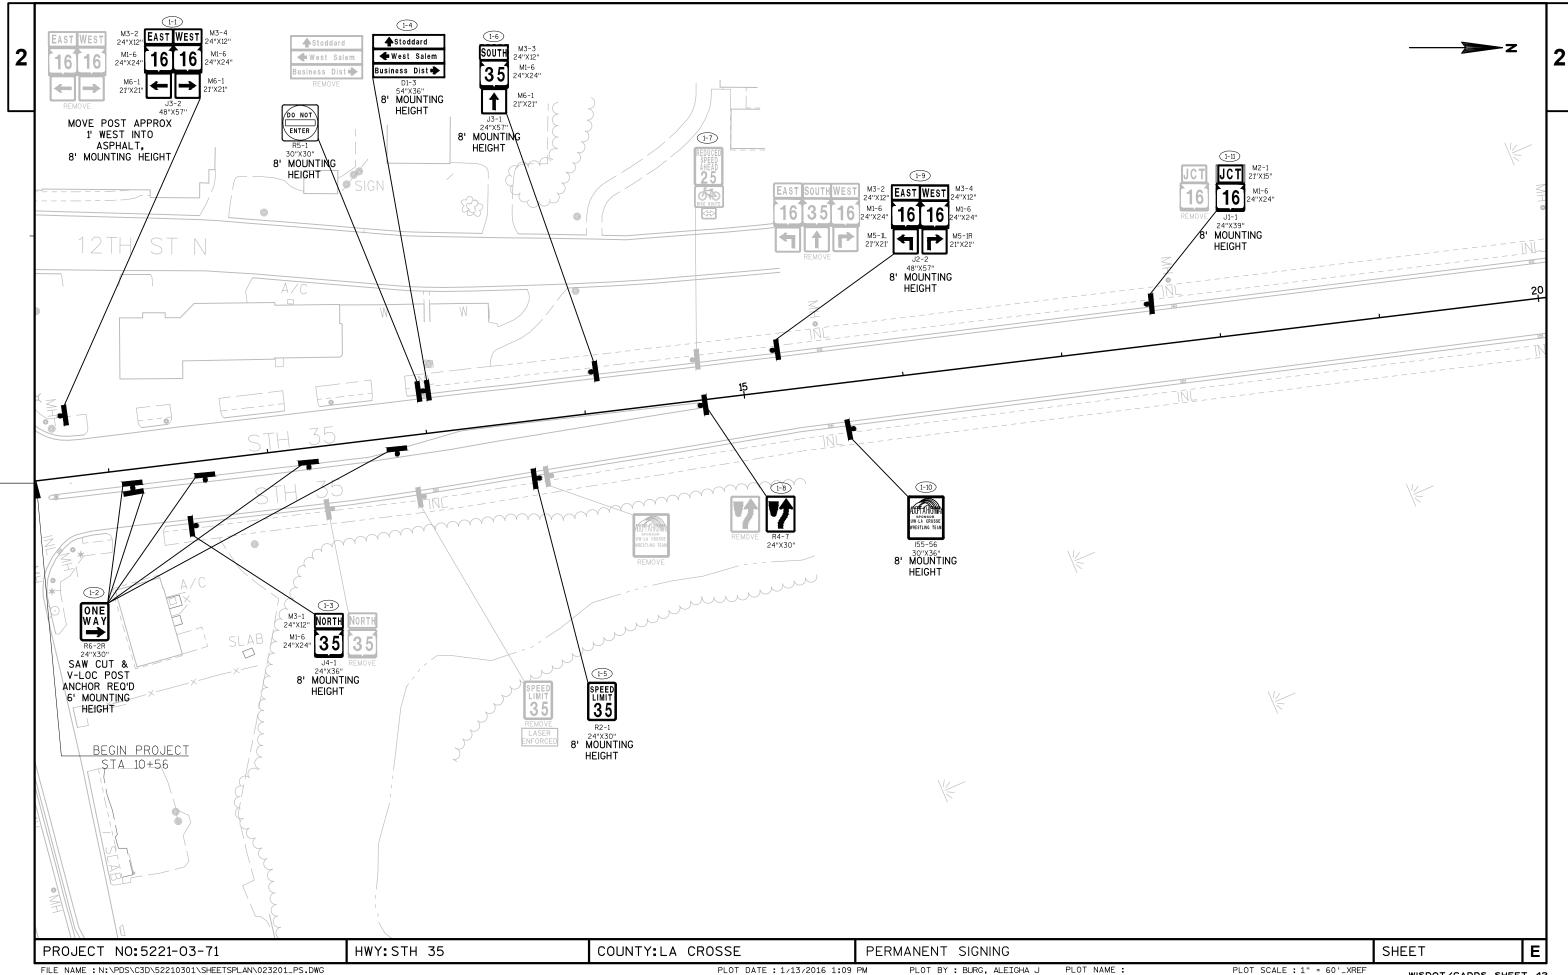


PLOT DATE : 1/13/2016 1:09 PM PLOT BY : BURG, ALEIGHA J PLOT NAME : PLOT SCALE : 1" = 60'\_XREF WISDOT/CADDS SHEET 42

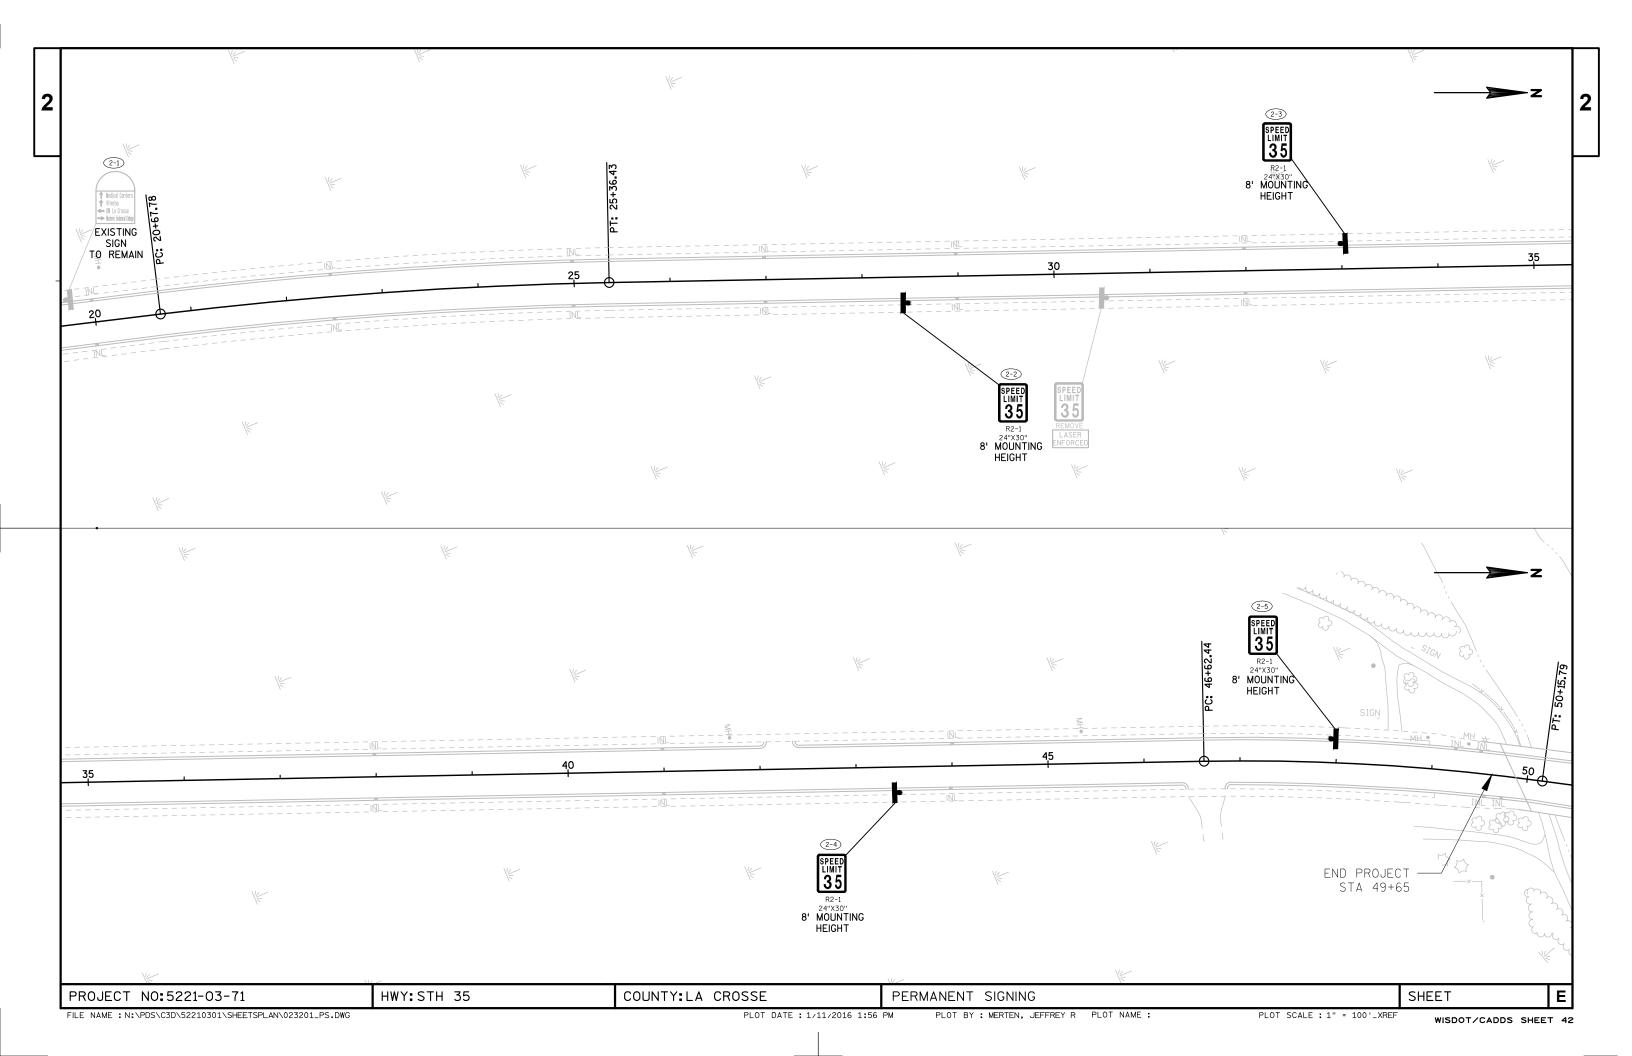

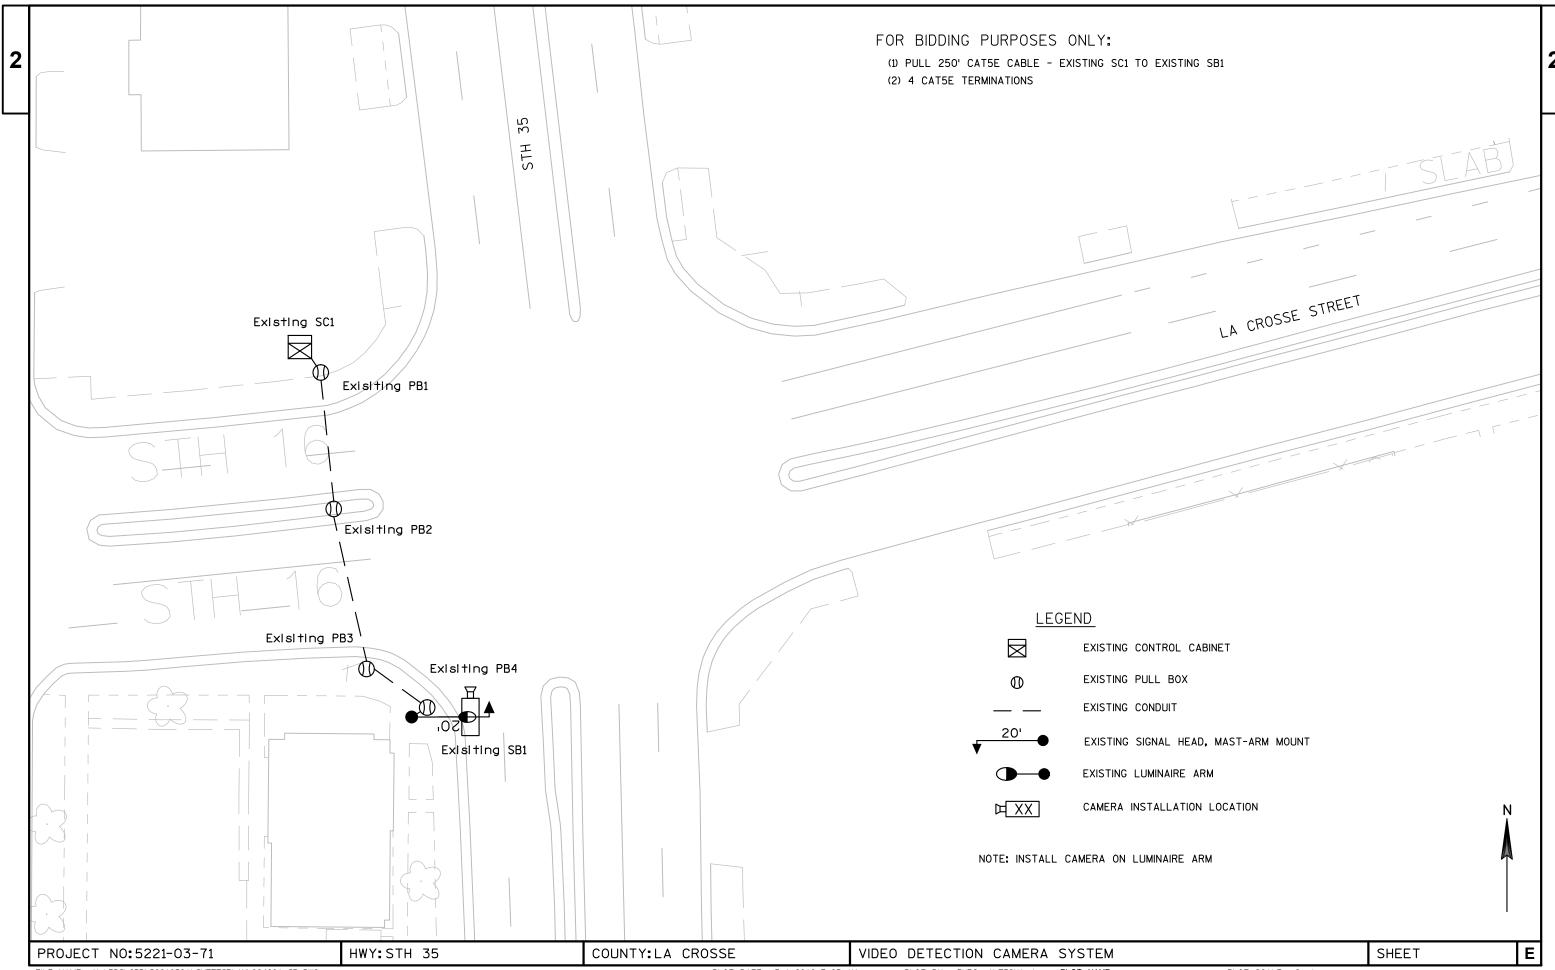

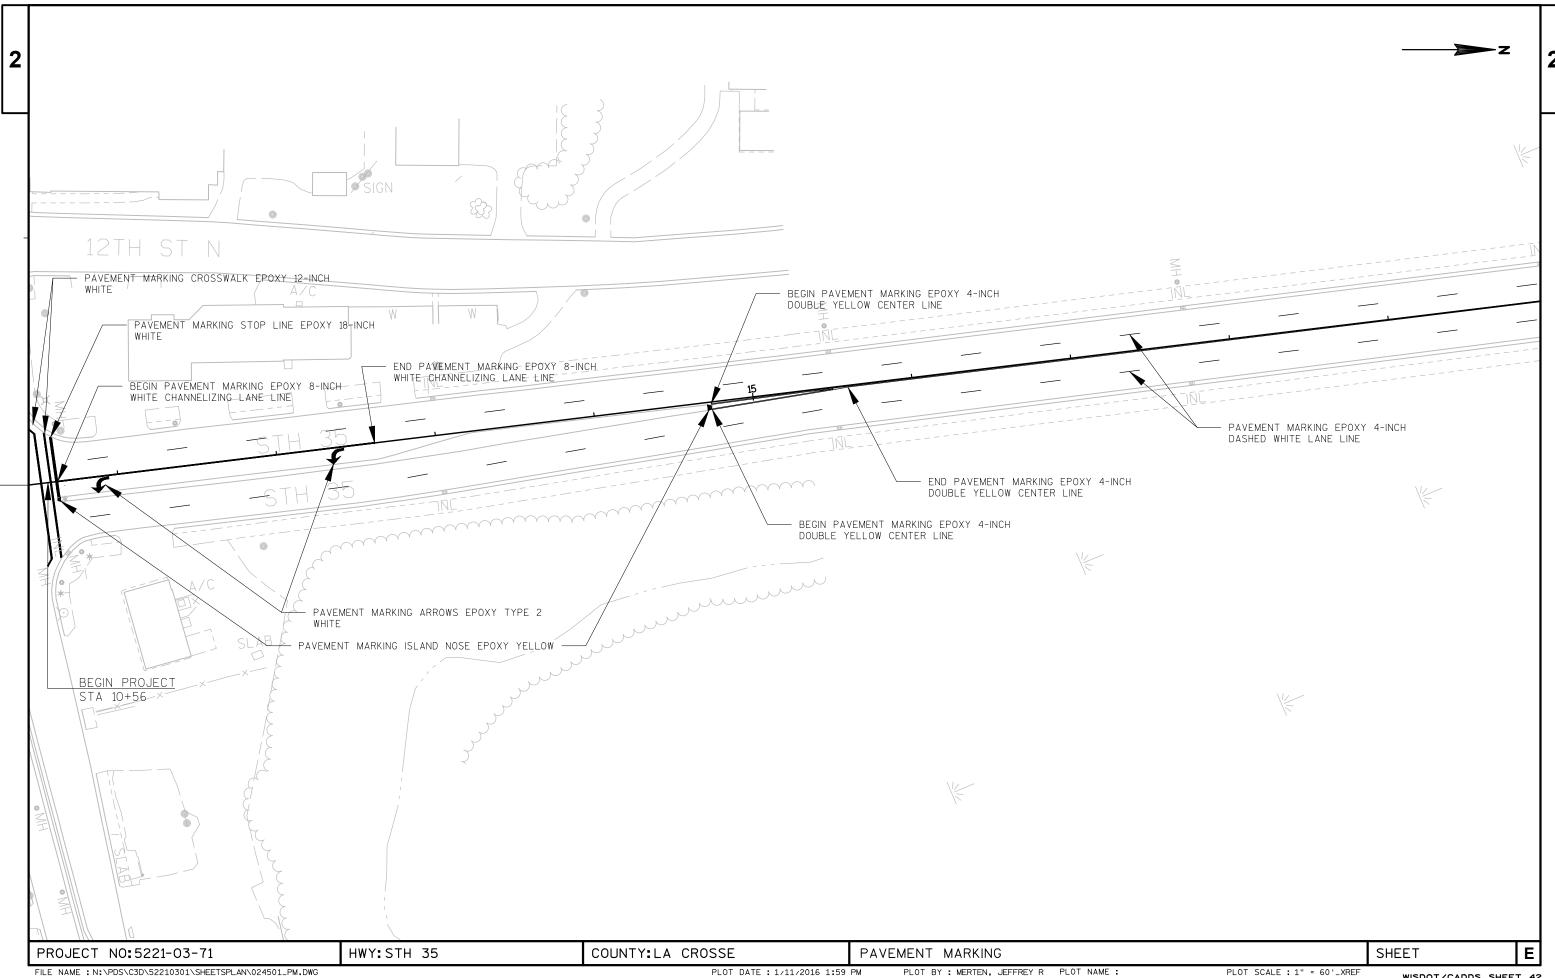


WISDOT/CADDS SHEET 42

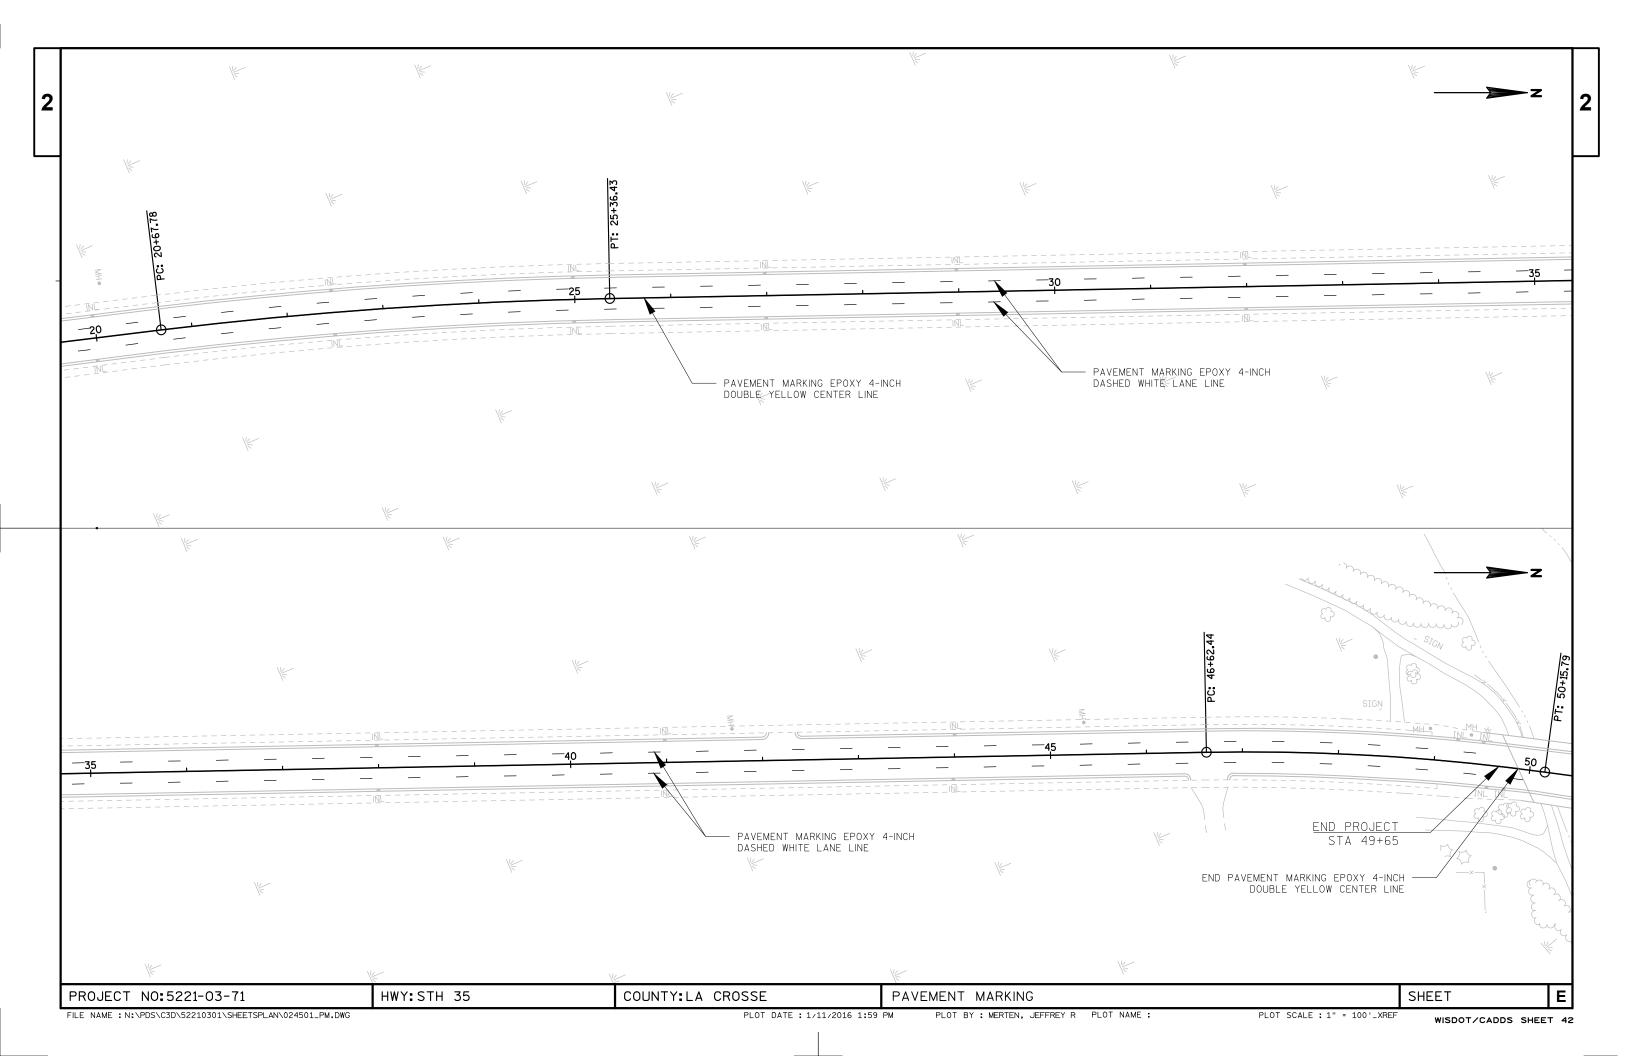





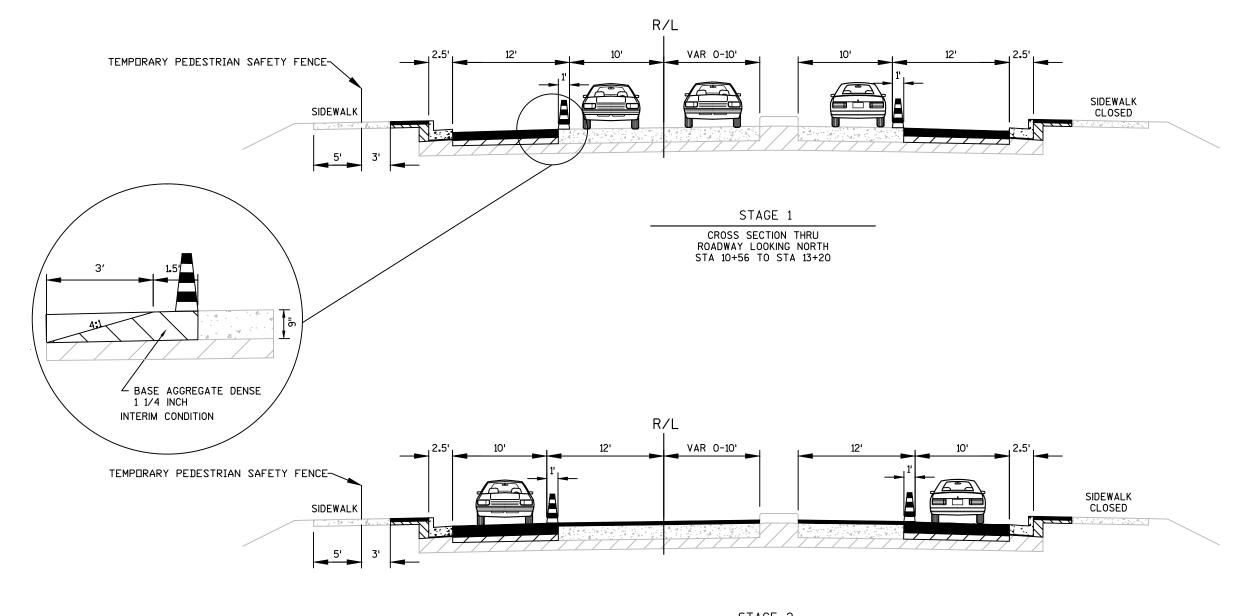

STAGE 2

CROSS SECTION THRU ROADWAY LOOKING NORTH STA 10+56 TO STA 13+20

**PROJECT NO:**5221-03-71

HWY:STH 35

COUNTY: LA CROSSE


TRAFFIC CONTROL TYPICAL SECTIONS

SHEET

PLOT SCALE : 1 IN:10 FT

E



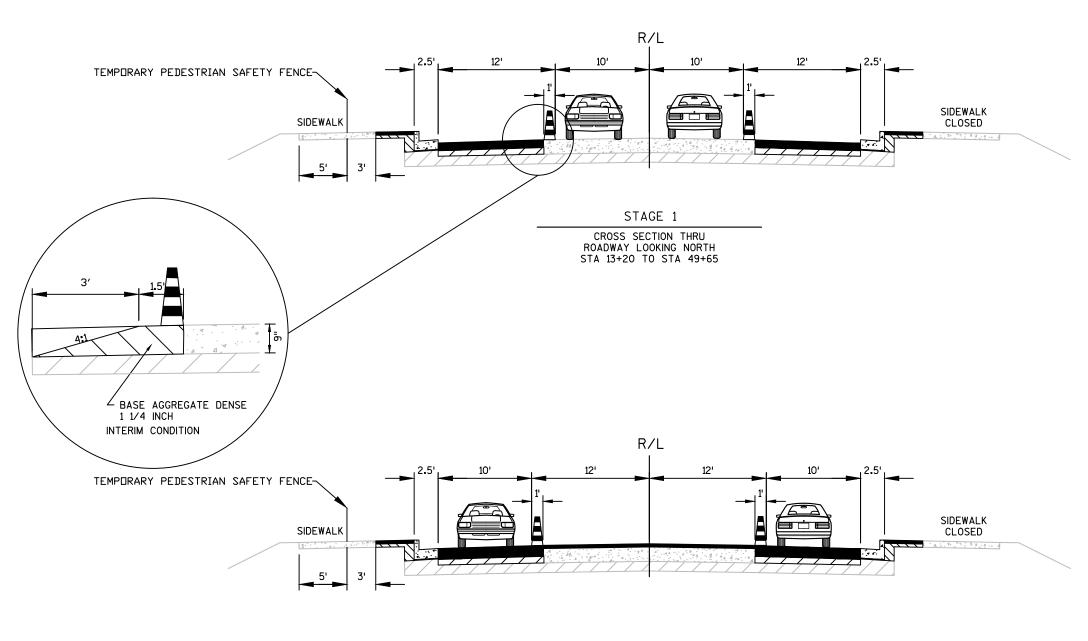


STAGE 2


CROSS SECTION THRU ROADWAY LOOKING NORTH STA 13+20 TO STA 49+65


PROJECT NO:5221-03-71 HWY:STH 35 COUNTY:LA CROSSE TRAFFIC CONTROL TYPICAL SECTIONS SHEET E


14


WISDOT/CADDS SHEET 42

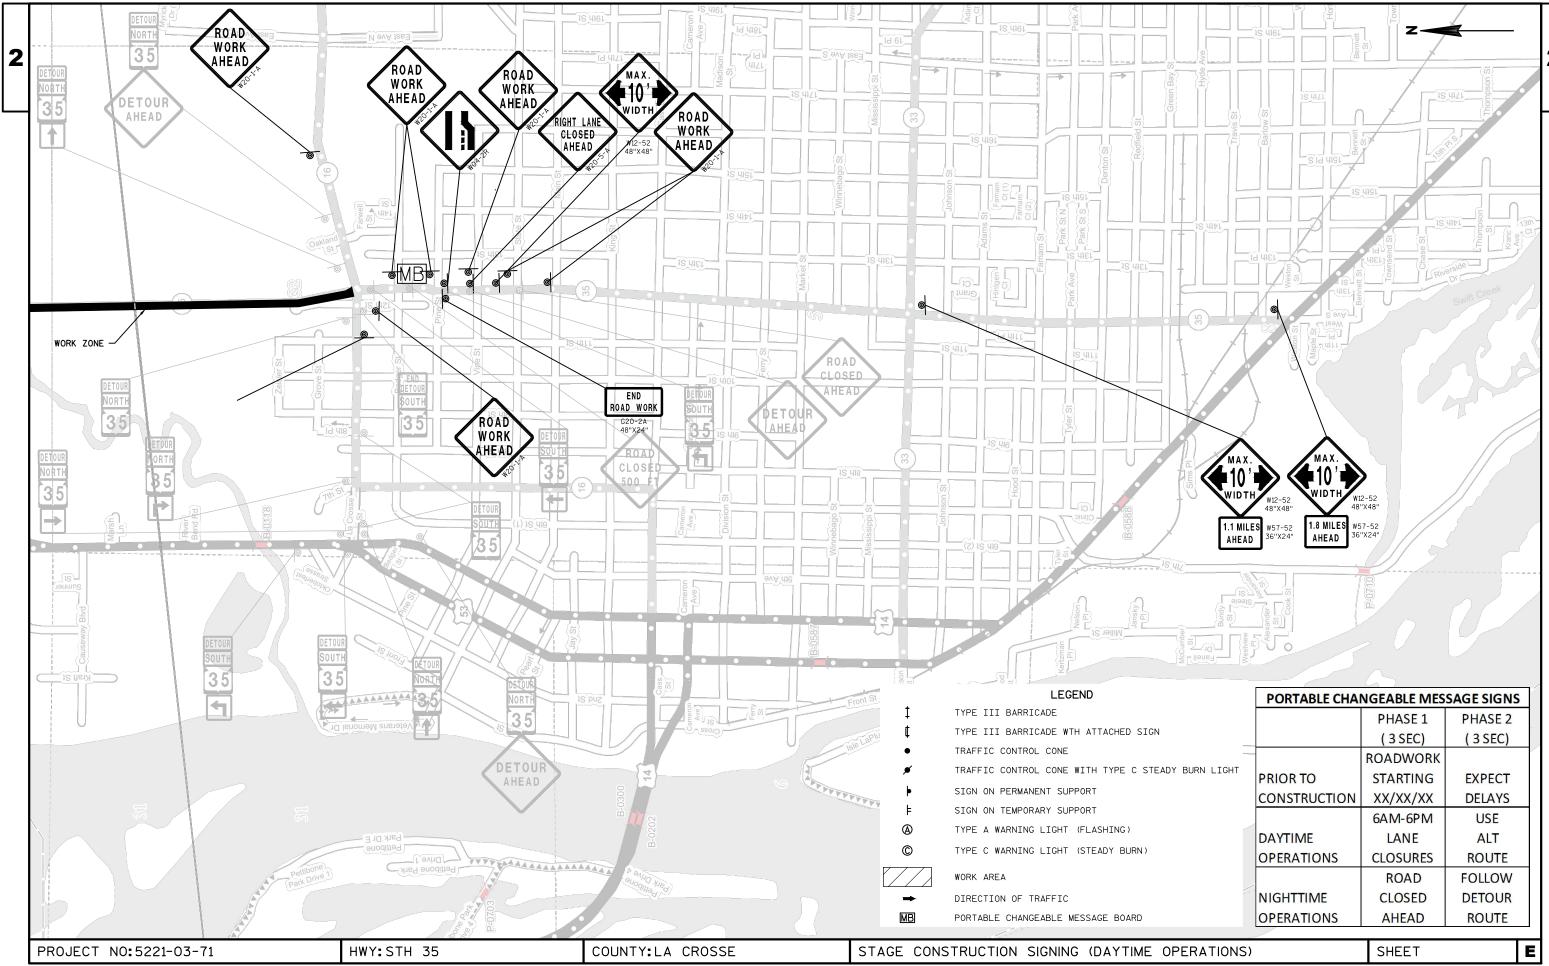


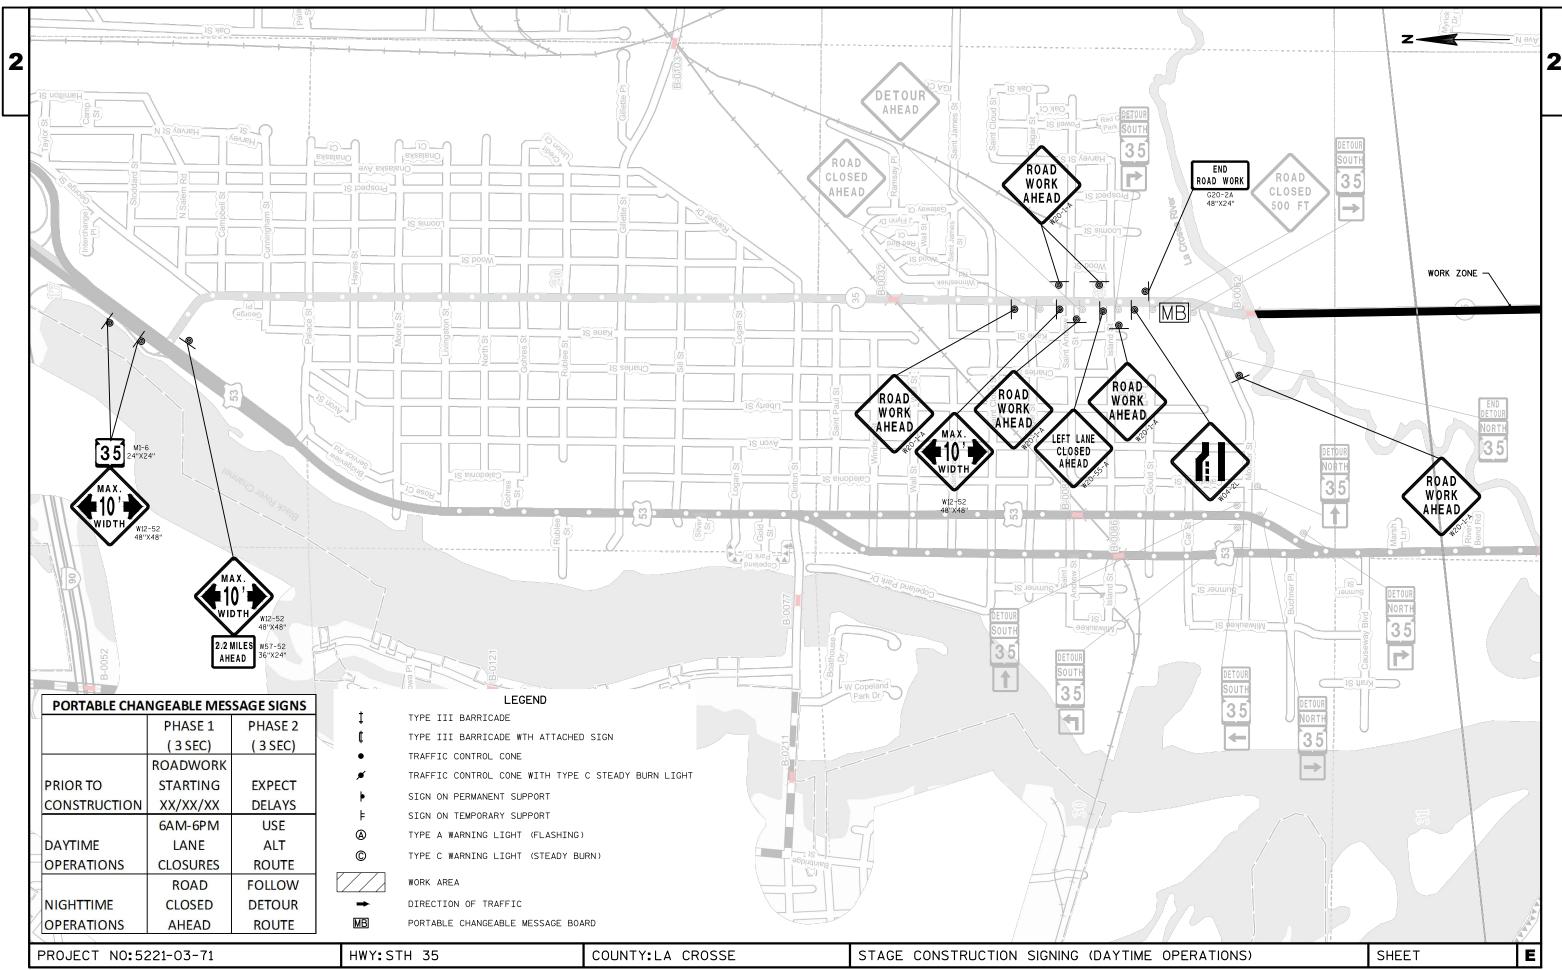


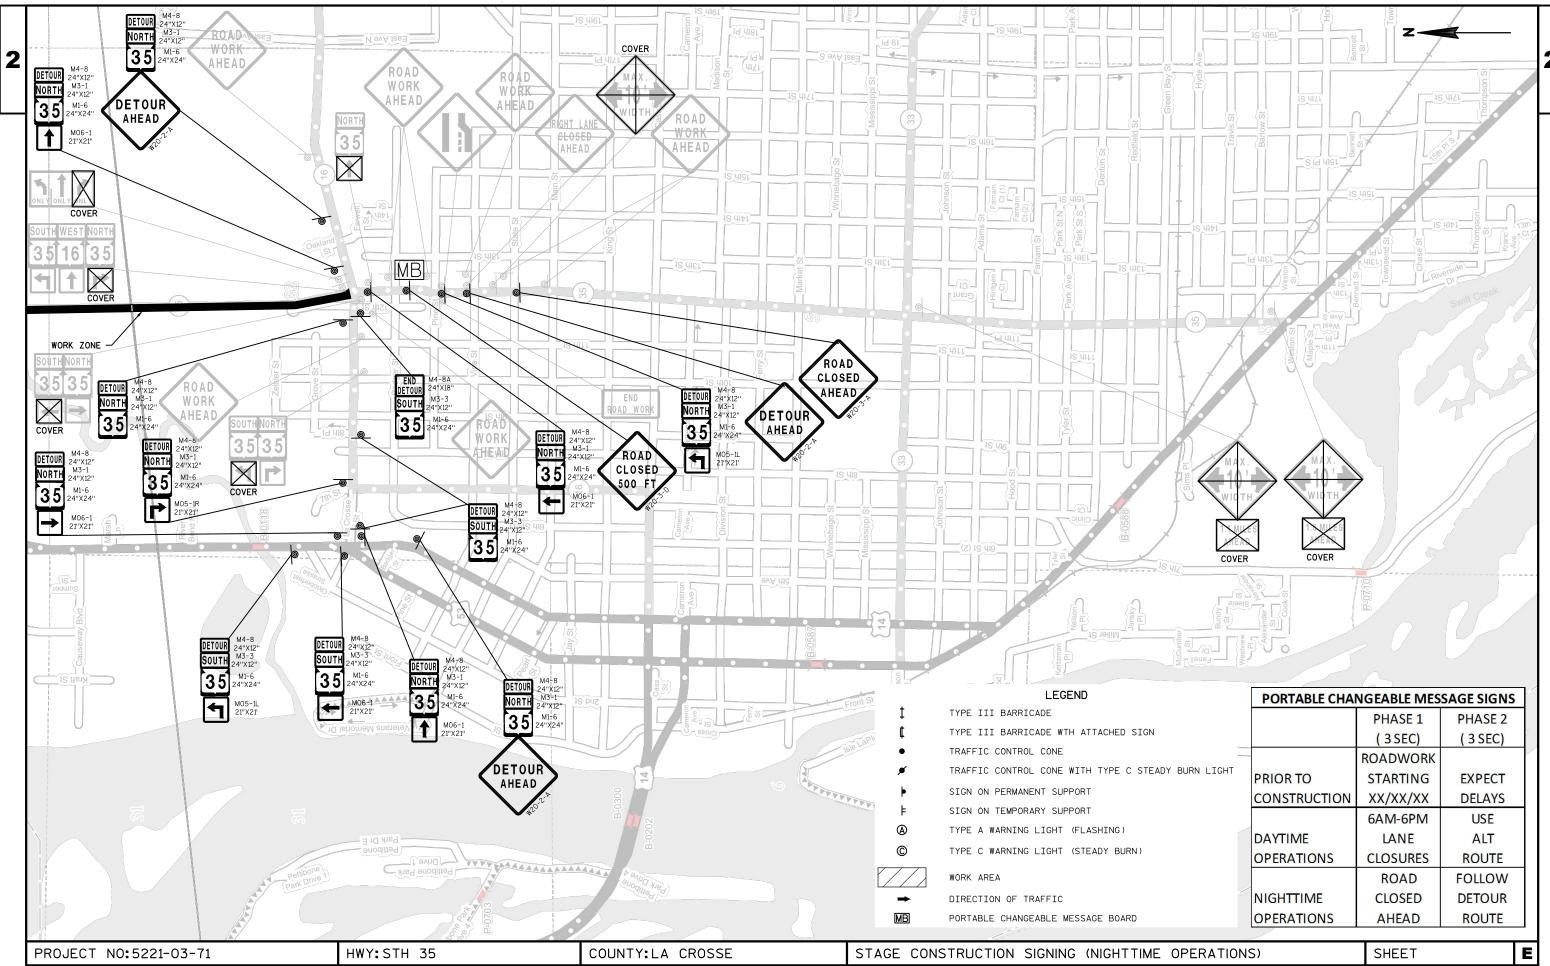


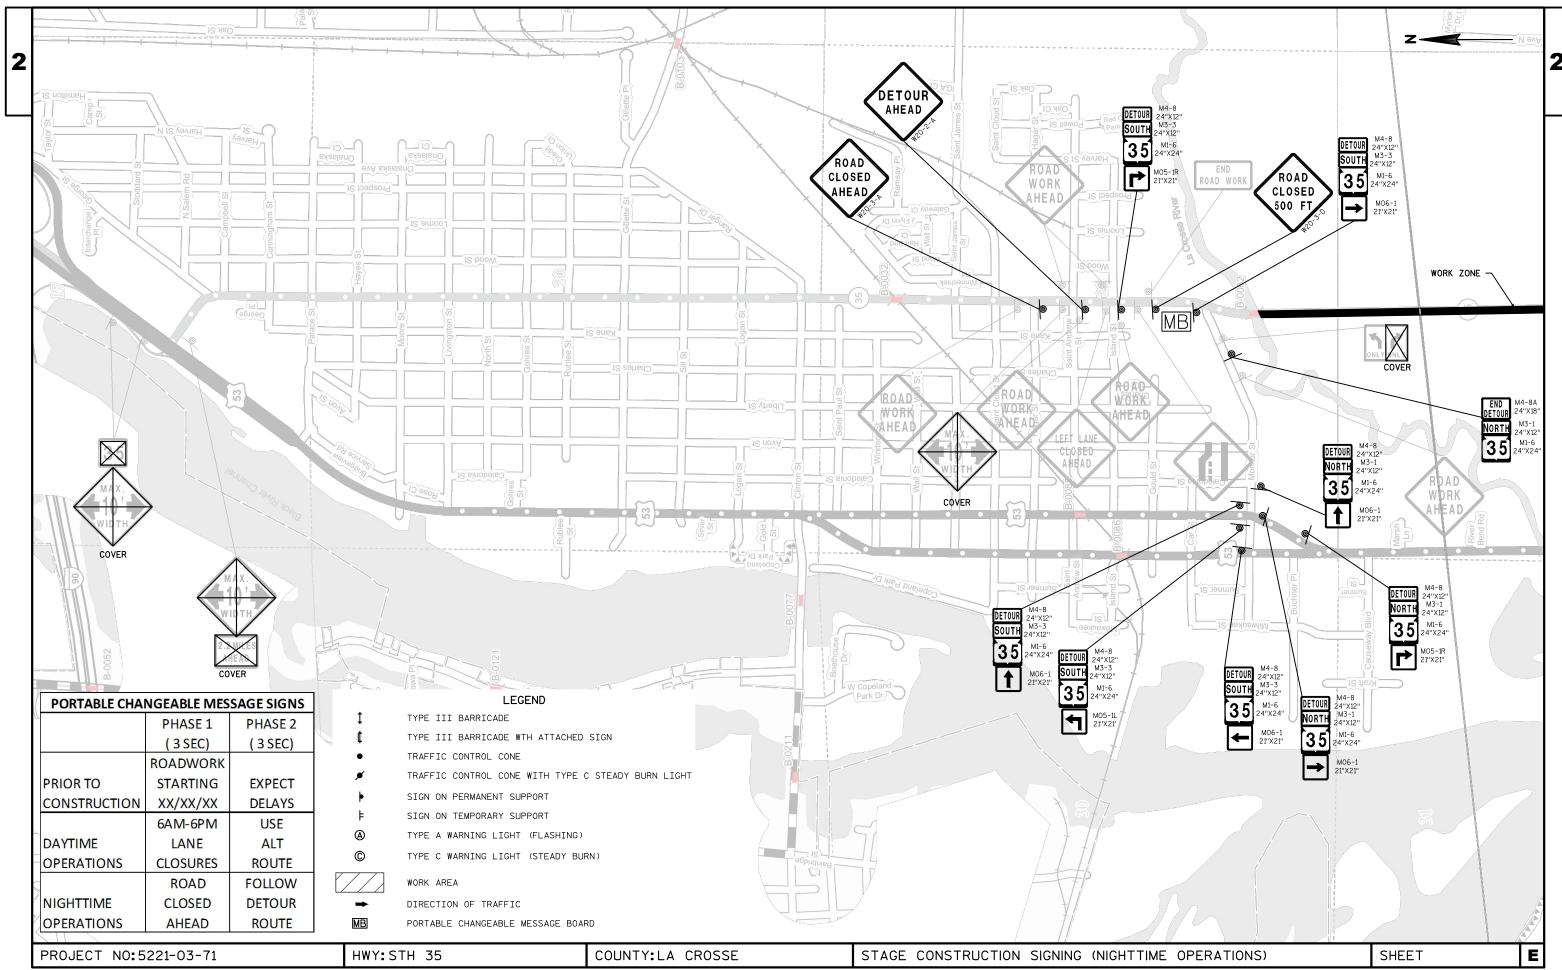


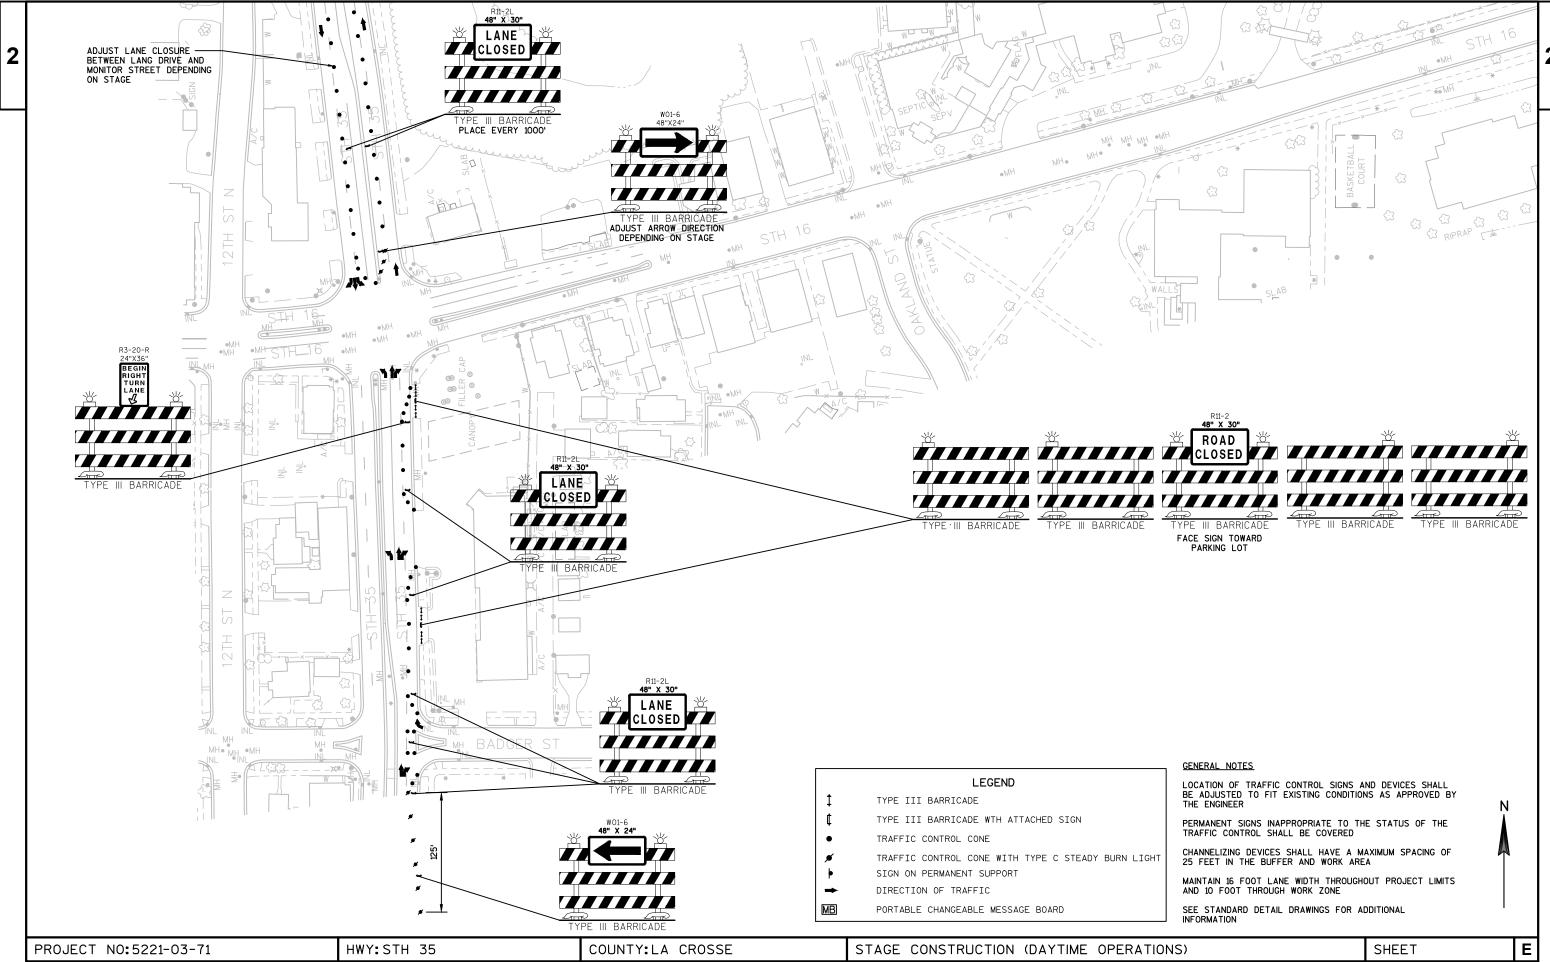


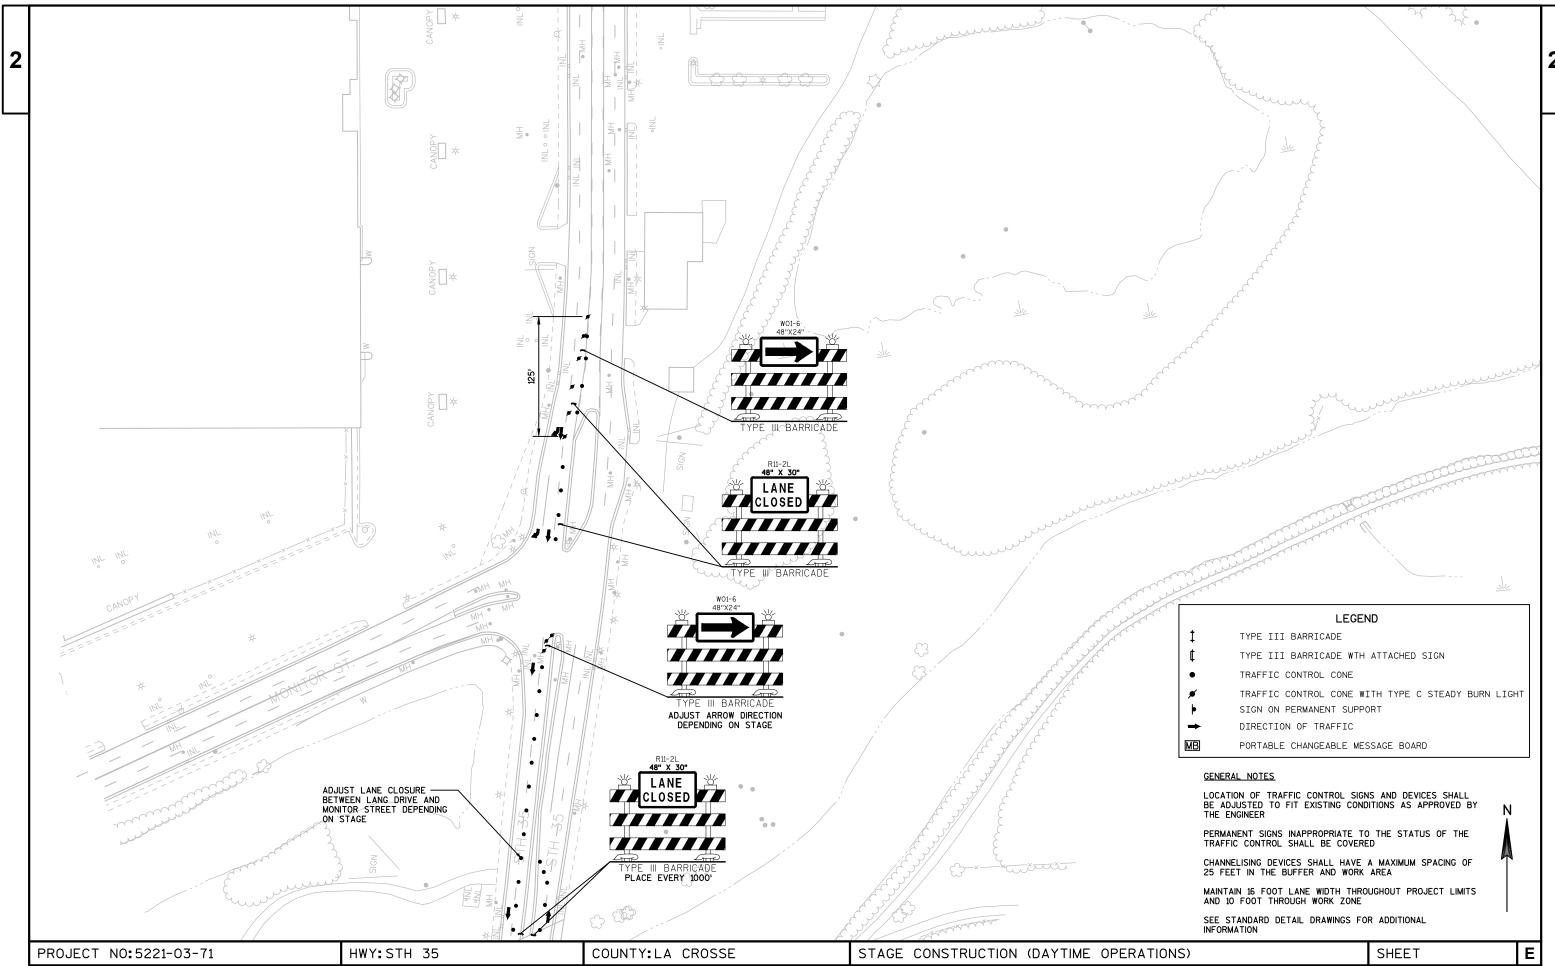

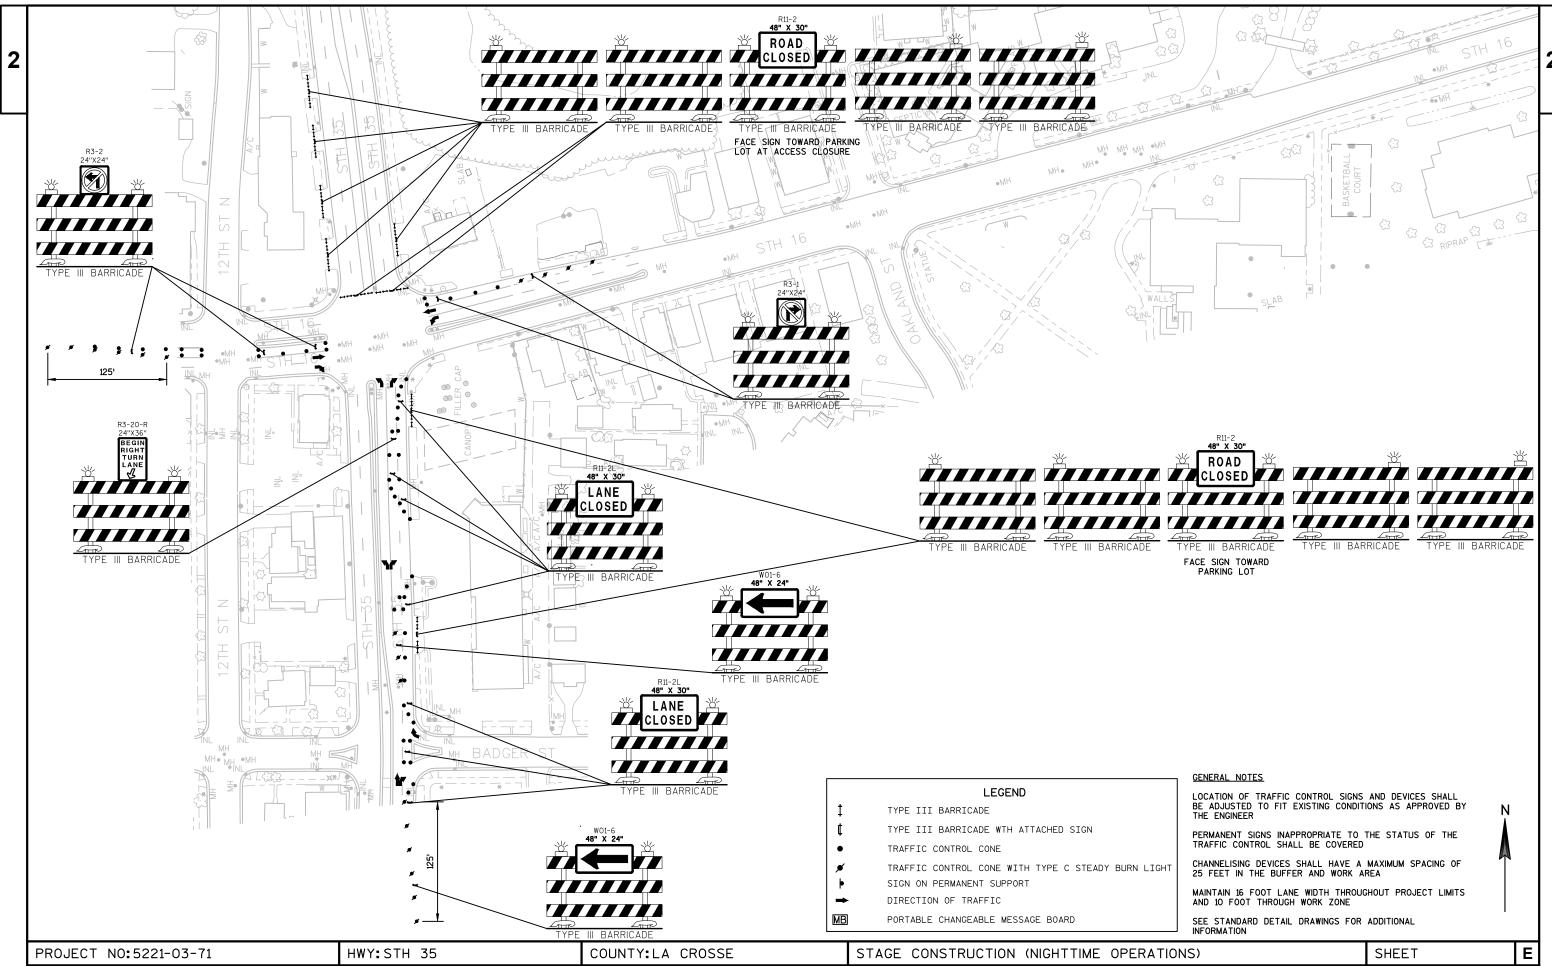

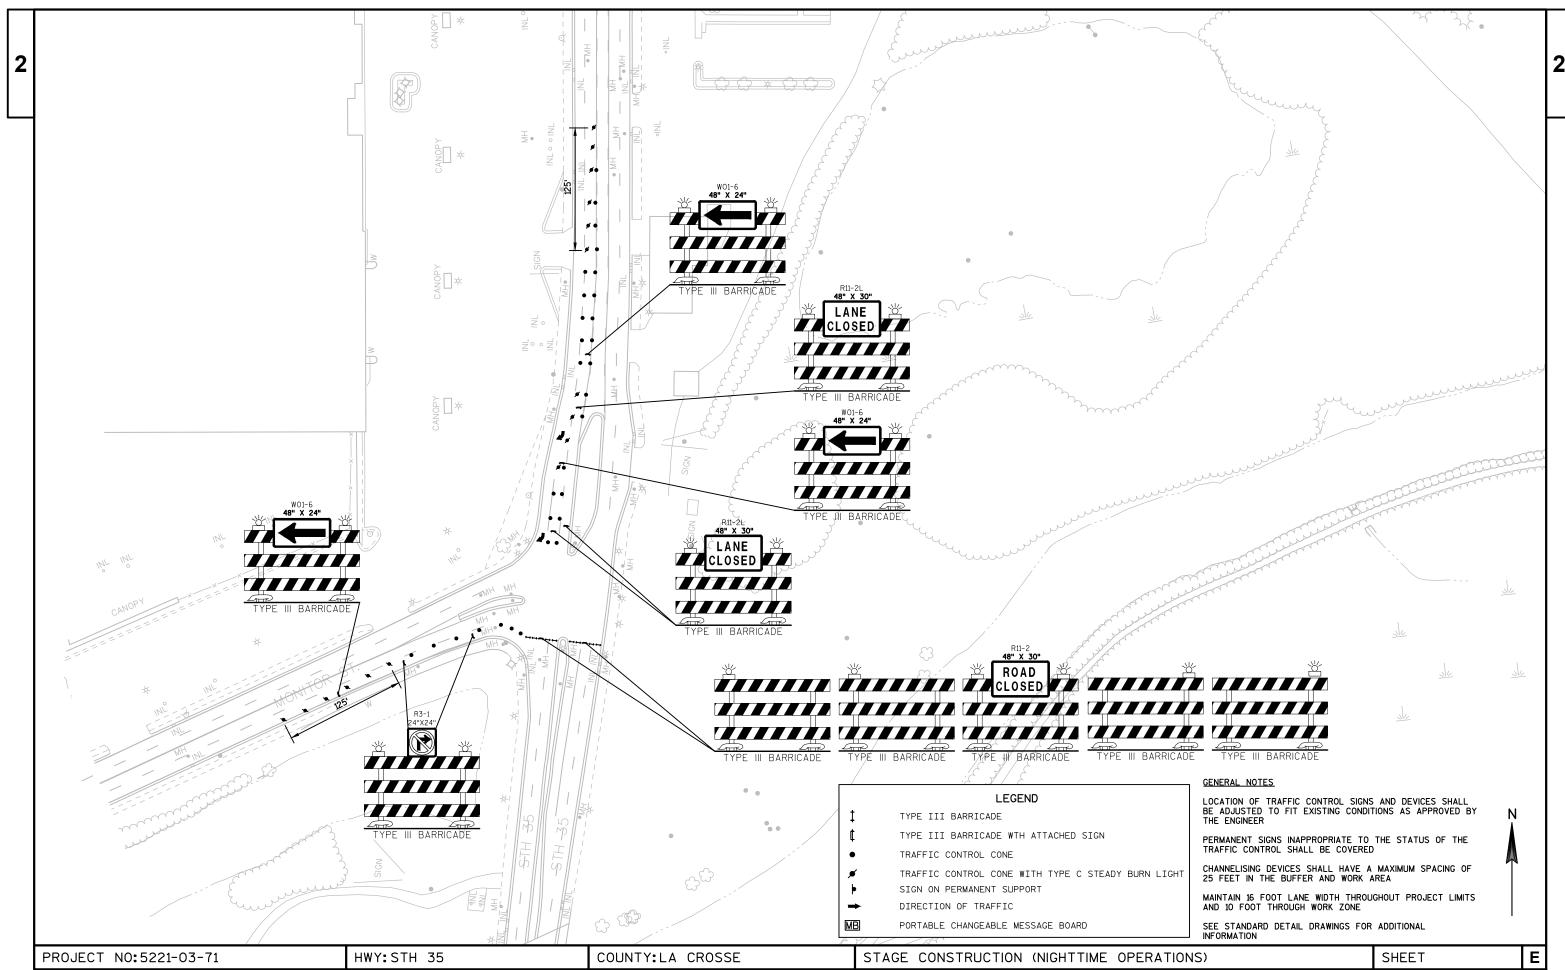

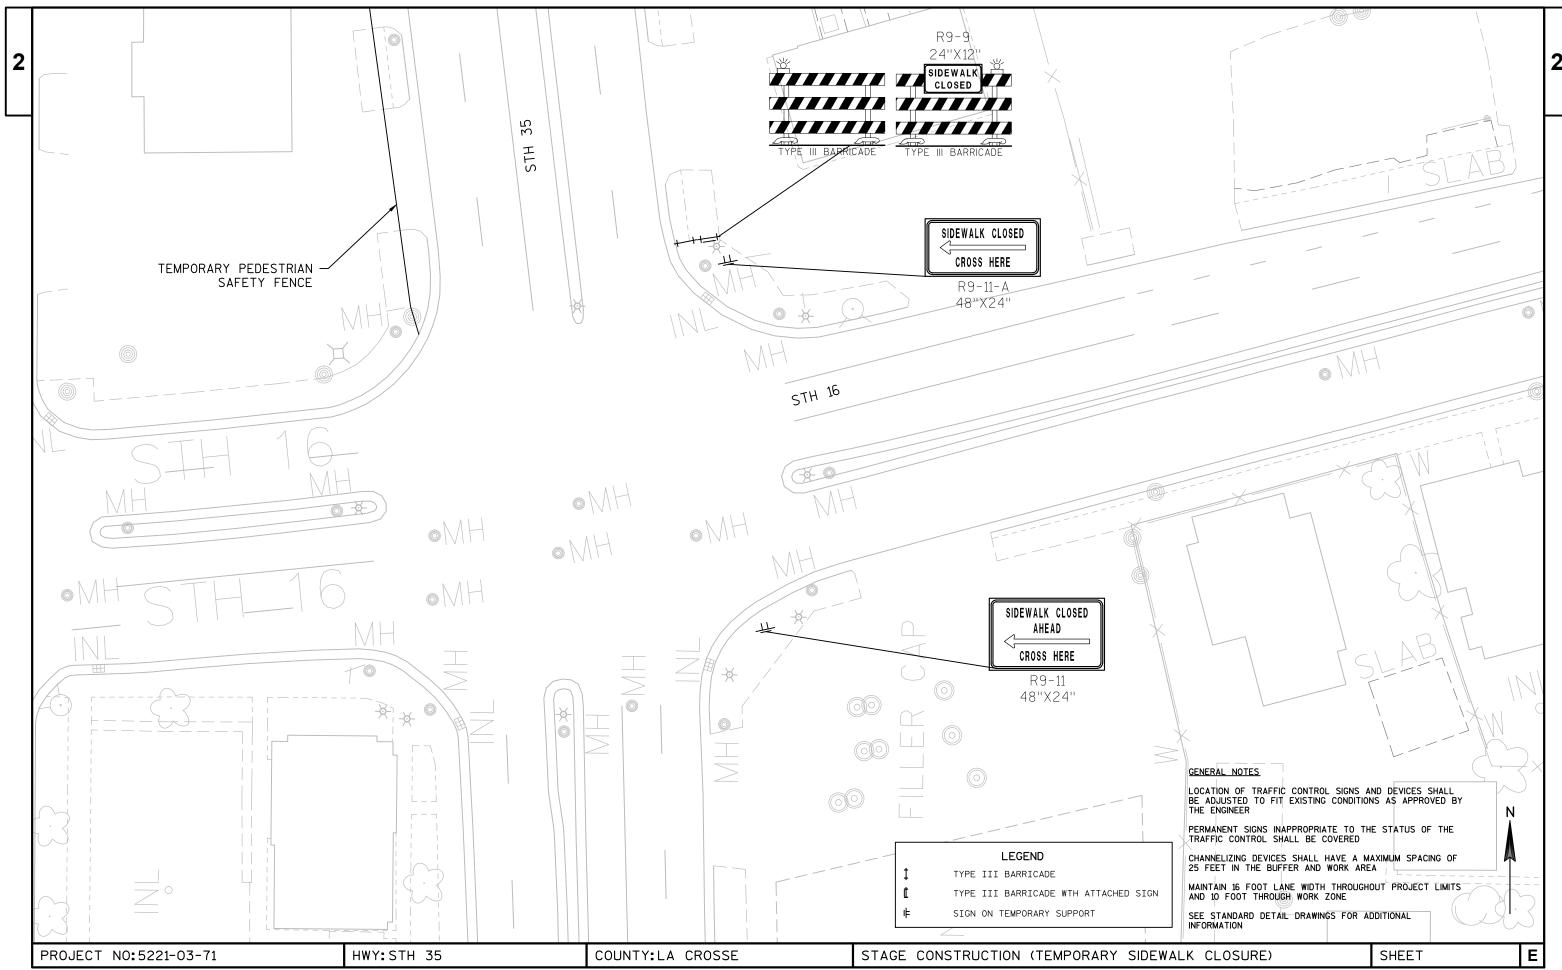

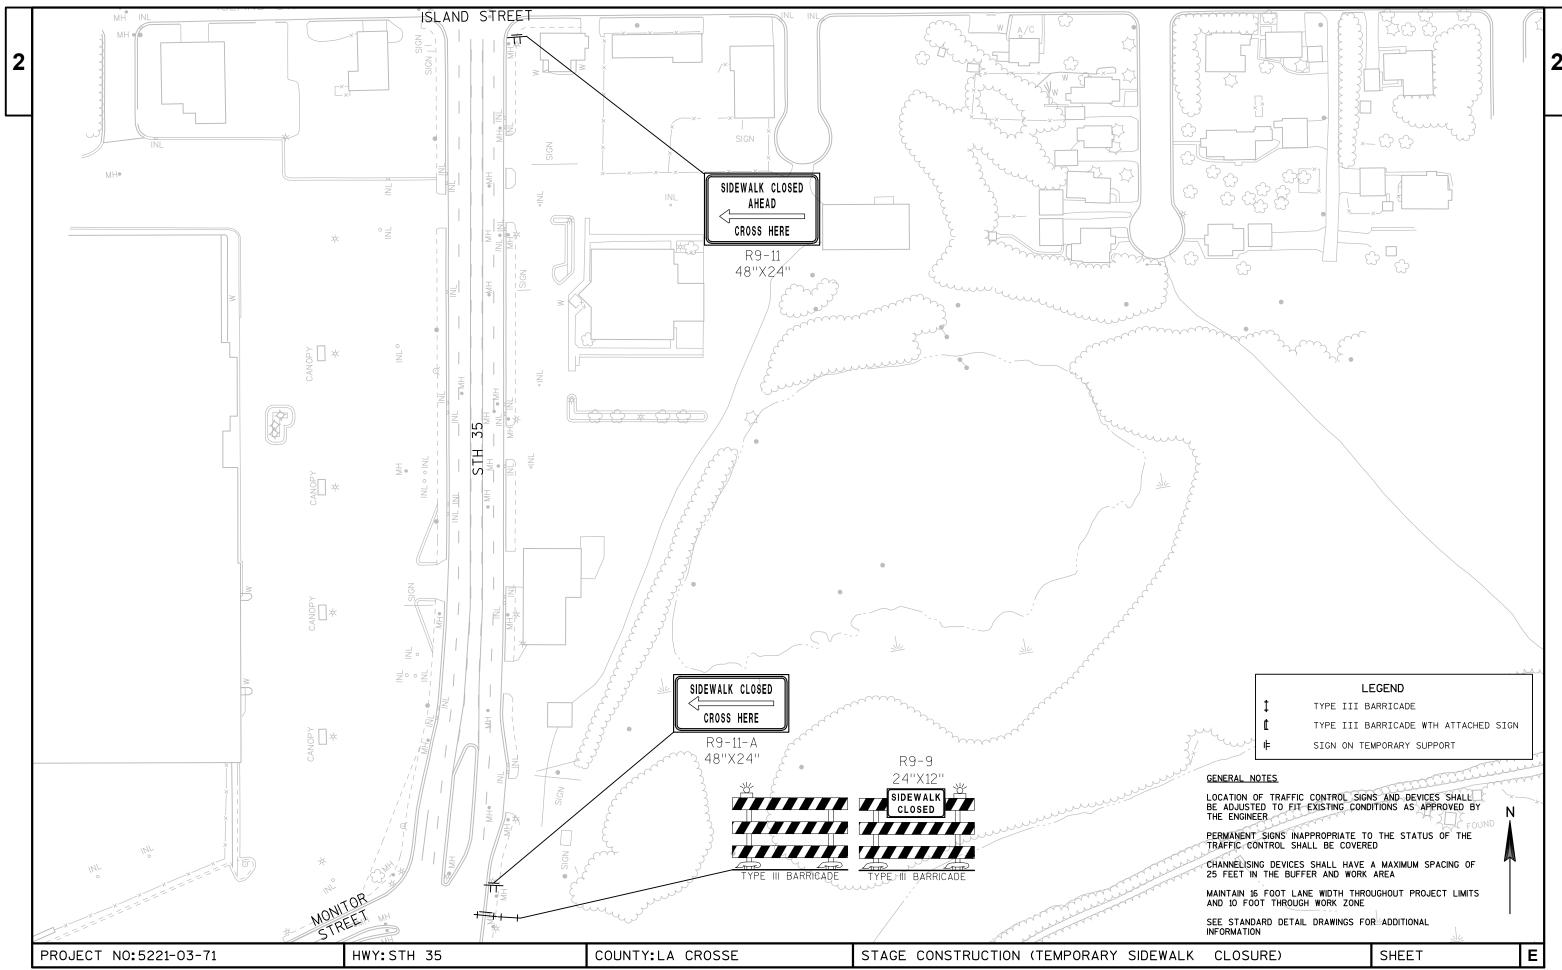

DATE 06	SAPR16	E S T	TIMAT	E O F Q U A N	
LI NE NUMBER	LTEM	ITEM DESCRIPTION	UNI T	TOTAL	5221-03-71 QUANTI TY
0010	204. 0100	Removing Pavement	SY	11, 827. 000	11, 827. 000
0020	204. 0105	Removing Pavement Butt Joints	SY	301.000	301. 000
0030	204. 0110	Removing Asphaltic Surface	SY	3, 285. 000	3, 285. 000
0040	204. 0115	Removing Asphaltic Surface Butt Joints	SY	244. 000	244. 000
0050	204. 0155	Removing Concrete Sidewalk	SY	59. 000	59. 000
0060	205. 0100	Excavation Common	CY	1, 458. 000	1, 458. 000
0070	211. 0100	Prepare Foundation for Asphaltic Paving	LS	1. 000	1, 430. 000
		(project) 01. 5221-03-71			
0800	213. 0100	Finishing Roadway (project) 01.	EACH	1. 000	1. 000
0000	005 0440	5221-03-71	TON	7/0 000	7/0.000
0090	305. 0110	Base Aggregate Dense 3/4-Inch	TON	769. 000	769. 000 2, 450. 000
0100	305. 0120	Base Aggregate Dense 1 1/4-Inch	TON	2, 450. 000	2, 450. 000
0110	305. 0130	Base Aggregate Dense 3-Inch	TON	2, 924. 000	2, 924. 000
0120	312. 0110	Select Crushed Material	TON	245. 000	245. 000
0130	390. 0303	Base Patching Concrete	SY	1, 775. 000	1, 775. 000
0140	416. 0160	Concrete Driveway 6-Inch	SY	98.000	98. 000
0150	416. 0610	Drilled Tie Bars	EACH	3. 000	3. 000
0160	420. 1000	Continuous Diamond Crinding Concrete	SY	9, 514. 000	9, 514. 000
0100	420. 1000	Continuous Diamond Grinding Concrete Pavement	31	9, 314.000	9, 314.000
0170	455. 0605	Tack Coat	GAL	1, 645. 000	1, 645. 000
0170	460. 2000	Incentive Density HMA Pavement	DOL	1, 400. 000	1, 400. 000
0190		Reheating HMA Pavement Longitudinal	LF	11, 700. 000	11, 700. 000
		Joi nts		,	,
0200	460. 6223	HMA Pavement 3 MT 58-28 S	TON	2, 676. 000	2, 676. 000
0210	460. 6224	HMA Pavement 4 MT 58-28 S	TON	2, 173. 000	2, 173. 000
0210	465. 0105	Asphaltic Surface	TON	370. 000	370. 000
0230	601. 0419	Concrete Curb & Gutter 30-Inch Type L	LF	7, 852. 000	7, 852. 000
0230	602. 0415	Concrete Sidewalk 6-Inch	SF	63. 000	63. 000
0250	602. 0515	Curb Ramp Detectable Warning Field	SF	20. 000	20. 000
		Natural Patina	-	000	
0260	611. 8115	Adjusting Inlet Covers	EACH	29. 000	29. 000
0270	618. 0100	Maintenance And Repair of Haul Roads	EACH	1. 000	1. 000
U38U	619. 1000	(project) 01. 5221-03-71 Mobilization	EACH	1. 000	1. 000
0280 0290	620. 0200	Concrete Median Blunt Nose	SF	8. 000	8. 000
0300	624. 0100	Water	MGAL	27. 000	27. 000
0310	628. 1905	Mobilizations Erosion Control	EACH	2.000	2. 000
0320	628. 1910	Mobilizations Emergency Erosion Control	EACH	1. 000	1. 000
0330	628. 7020	Inlet Protection Type D	EACH	29. 000	29. 000
0340	634. 0616	Posts Wood 4x6-Inch X 16-FT	EACH	10.000	10.000
0350	634. 0618	Posts Wood 4x6-Inch X 18-FT	EACH	3. 000	3. 000
0360	637. 2210	Signs Type II Reflective H	SF	34. 000	34.000
0370	637. 2210	Signs Type II Reflective F	SF	111. 000	111. 000
0380	638. 2602	Removing Signs Type II	EACH	10. 000	10. 000
0390	638. 3000	Removing Small Sign Supports	EACH	10. 000	10. 000
0400	642. 5001	Field Office Type B	EACH	1. 000	1. 000
0410	643. 0100	Traffic Control (project) 01. 5221-03-71	EACH	1.000	1. 000
0420	643. 0410	Traffic Control Barricades Type II	DAY	180. 000	180. 000
0430	643. 0420	Traffic Control Barricades Type III	DAY	4, 140. 000	4, 140. 000
0440	643. 0705	Traffic Control Warning Lights Type A	DAY	6, 300. 000	6, 300. 000
0450	643. 0715	Traffic Control Warning Lights Type C	DAY	1, 665. 000	1, 665. 000
0460	643. 0900	Traffic Control Signs	DAY	3, 690. 000	3, 690. 000
0470	643. 0920	Traffic Control Covering Signs Type II	EACH	720. 000	720. 000
0480	643. 1050	Traffic Control Signs PCMS	DAY	90. 000	90. 000
-		<b>9</b>		<del>-</del>	<del>-</del>

DATE 06	6APR16	EST	IMAT	E OF QUAN		
LINE	LTEM	LTEM DECCRIPTION	LINII T	TOTAL	5221-03-71	
NUMBER		ITEM DESCRIPTION	UNIT	TOTAL	QUANTI TY	
0490	643. 2000	Traffic Control Detour (project) 01. 5221-03-71	EACH	1. 000	1. 000	
0500	643. 3000	Traffic Control Detour Signs	DAY	4, 320. 000	4, 320. 000	
0510	644. 1616. S	Temporary Pedestrian Safety Fence	LF	3, 909. 000	3, 909. 000	
0520	646. 0126	Pavement Marking Epoxy 8-Inch	LF	200.000	200.000	
0530	646. 0406	Pavement Marking Same Day Epoxy 4-Inch	LF	9, 144. 000	9, 144. 000	
0540	646.0600	Removing Pavement Markings	LF	79.000	79. 000	
0550	647. 0166	Pavement Marking Arrows Epoxy Type 2	EACH	2.000	2. 000	
		3				
0560	647. 0566	Pavement Marking Stop Line Epoxy 18-Inch	LF	35.000	35. 000	
0570	647.0606	Pavement Marking Island Nose Epoxy	EACH	2.000	2. 000	
0580	647. 0776	Pavement Marking Crosswalk Epoxy 12-Inch	LF	158. 000	158. 000	
0590	649. 0400	Temporary Pavement Marking Removable	LF	250.000	250.000	
		Tape 4-Inch				
0600	649. 0402	Temporary Pavement Marking Paint 4-Inch	LF	7, 182. 000	7, 182. 000	
0610	650. 5500	Construction Staking Curb Gutter and	LF	7, 852. 000	7, 852. 000	
		Curb & Gutter				
0620	650.8000	Construction Staking Resurfacing	LF	3, 909. 000	3, 909. 000	
		Reference				
0630	650. 9910	Construction Staking Supplemental	LS	1.000	1. 000	
		Control (project) 01. 5221-03-71				
0640	690. 0250	Sawing Concrete	LF	20, 976. 000	20, 976. 000	
0650	ASP. 1TOA	On-the-Job Training Apprentice at \$5.	HRS	500.000	500.000	
		00/HR				
0660	ASP. 1T0G	On-the-Job Training Graduate at \$5.00/HR		300.000	300.000	
0670	SPV. 0045	Special 01. Traffic Control Cones	DAY	21, 285. 000	21, 285. 000	
0680	SPV. 0060	Special 01. Install Posts Steel	EACH	4.000	4.000	
		U-Channel				
0690	SPV. 0060	Special 02. Install V-Loc Post Anchors	EACH	4.000	4. 000	
0700	SPV. 0090	Special O1. Concrete Joint and Crack	LF	3, 909. 000	3, 909. 000	
		Cl eani ng		•	•	
0710	SPV. 0105	Special 01. Install State Furnished	LS	1. 000	1. 000	
		Video Detection System				
		-				

#### REMOVING PAVEMENT

# 204. 0100

					204.0100	
CATEGORY	STATI ON	T0	STATI ON	LOCATI ON	SY	REMARKS
0010	10+56	-	49+65	RT	5864	NORTHBOUND LANE
0010	10+56	-	49+65	LT	5864	SOUTHBOUND LANE
0010	11+13			RT	15	DRI VEWAY
0010	11+10			LT	15	DRI VEWAY
0010	11+60			LT	15	DRI VEWAY
0010	12+25			LT	9	DRI VEWAY
0010	12+80			LT	9	DRI VEWAY
0010	42+20			LT	15	DRI VEWAY
0010	46+65			RT	20	DRI VEWAY
0010	10+56	-	13+20	RT	1	MEDI AN
				TOTAL		
				0010	11827	

#### REMOVING PAVEMENT BUTT JOINTS

					204. 0105	
CATEGORY	STATI ON	T0	STATI ON	LOCATI ON	SY	REMARKS
0010	10+56	-	11+06	RT	61	NORTHBOUND LANE
0010	10+56	-	10+59	RT	1	MEDIAN NOSE
0010	10+56	-	11+06	LT	61	SOUTHBOUND LANE
0010	10+56	-	11+06	RT	56	LEFT TURN LANE
0010	49+15	-	49+65	RT	61	NORTHBOUND LANE
0010	49+15	-	49+65	LT	61	SOUTHBOUND LANE
				TOTAL 0010	301	

#### REMOVING ASPHALTIC SURFACE

					204. 0110		
CATEGORY	STATI ON	T0	STATI ON	LOCATI ON	SY	REMARKS	
0010	10+78	-	10+96	RT	8	NORTHBOUND	TERRACE
0010	11+30	-	46+42	RT	1561	NORTHBOUND	TERRACE
0010	46+87	-	49+05	RT	97	NORTHBOUND	TERRACE
0010	11+75	-	12+14	LT	17	SOUTHBOUND	TERRACE
0010	12+35	-	12+69	LT	15	SOUTHBOUND	TERRACE
0010	12+90	-	42+04	LT	1295	SOUTHBOUND	TERRACE
0010	42+37	-	48+95	LT	292	SOUTHBOUND	TERRACE
				TOTAL 0010	3285		

#### REMOVING ASPHALTIC SURFACE BUTT JOINTS

					204. 0115	
CATEGORY	STATI ON	TO	STATI ON	LOCATI ON	SY	REMARKS
0010	10+56	-	11+06	RT	61	NORTHBOUND LANE
0010	10+56	-	11+06	LT	61	SOUTHBOUND LANE
0010	49+15	-	49+65	RT	61	NORTHBOUND LANE
0010	49+15	-	49+65	LT	61	SOUTHBOUND LANE
				TOTAL 0010	244	

#### REMOVING CONCRETE SIDEWALK

CATEGORY	STATI ON	TO	STATI ON	LOCATI ON	204. 0155 SY	REMARKS
0010	10+54	_	10+64	RT	20	NORTHBOUND
0010	10+64	-	10+78	RT	12	NORTHBOUND
0010	10+49	-	10+65	LT	14	SOUTHBOUND
0010	10+65	-	10+90	LT	4	SOUTHBOUND
0010	11+22	_	11+42	LT	9	SOUTHBOUND
				T0TAL 0010	59	

#### EXCAVATION COMMON

					205. 0100	
CATEGORY	STATI ON	T0	STATI ON	LOCATI ON	CY	REMARKS
0010	15+00	-	21+50	RT	349	NORTHBOUND
0010	23+50	-	25+00	RT	81	NORTHBOUND
0010	46+00	-	48+25	RT	121	NORTHBOUND
0010	14+75	-	22+00	LT	389	SOUTHBOUND
0010	25+25	-	27+00	LT	94	SOUTHBOUND
0010	32+50	-	38+00	LT	295	SOUTHBOUND
0010	10+56	-	49+65	RT/LT	129	UNDI STRI BUTED
				TOTAL 0010	1458	

PROJECT NO: 5221-03-71 HWY: STH 35 COUNTY: LA CROSSE MISCELLANEOUS QUANTITIES SHEET: **E** 

FILE NAME : N:\PDS\...\030200\_mq.pptx PLOT BY : A.R.H. PLOT NAME : PLOT NAME : PLOT SCALE : 1:1

3
_

Ε

#### BASE AGGREGATE DENSE BASE PATCHING CONCRETE 305. 0110 305.0120 305. 0130 390.0303 STATION TO STATION LOCATION REMARKS BASE **BASE** BASE CATEGORY SY AGGREGATE AGGREGATE AGGREGATE DENSE **DENSE DENSE** 624.0100 0010 10+56 - 13+00 RT 24 LEFT TURN LANE JOINTS 3/4-INCH 1 1/4-INCH 3-I NCH WATER 0010 10+56 - 49+65 RT 452 NORTHBOUND LANE JOINTS CATEGORY STATION TO STATION LOCATION TON TON TON MGAL REMARKS 0010 - 49+65 LT 438 10+56 SOUTHBOUND LANE JOINTS 0010 11+38 11+58 LT 25 SOUTHBOUND LANE PANEL 25 0010 10+78 - 49+05 243 0010 12+58 12+78 LT SOUTHBOUND LANE PANEL RT C&G BACKFILL \_\_\_ 0010 11+75 - 48+95 LT 237 C&G BACKFILL ---0010 75 0010 10+78 - 49+05 RT 147 TERRACE 16+20 16+80 LT SOUTHBOUND LANE PANELS \_ 11+75 16+20 RT 25 0010 - 48+95 LT 142 TERRACE 0010 16+40 NORTHBOUND LANE PANEL \_\_\_ \_\_\_ \_\_\_ 25 0010 10+56 - 49+65 RT 1225 ---NORTHBOUND LANE 0010 17+00 17+20 LT SOUTHBOUND LANE PANEL RT 0010 19+00 20+00 125 SOUTHBOUND LANE PANELS 0010 10+56 LT LT 50 - 49+65 1225 SOUTHBOUND LANE 0010 19+60 20+00 NORTHBOUND LANE PANELS 0010 15+00 21+50 RT 768 NORTHBOUND LANE \_\_\_ \_\_\_ \_\_\_ 0010 23+50 25+00 RT 177 NORTHBOUND LANE 0010 21+00 21+60 LT 75 NOTHBOUND LANE PANELS 0010 46+00 - 48+25 0010 25+02 25+22 RT 25 RT 266 NORTHBOUND LANE NOTHBOUND LANE PANEL \_\_\_ \_\_\_ \_\_\_ 0010 14+75 - 22+00 LT 856 SOUTHBOUND LANE 0010 25+62 26+12 LT 63 SOUTHBOUND LANE PANELS ------28+02 25 0010 27+82 LT SOUTHBOUND LANE PANEL 0010 25+25 27+00 LT 207 SOUTHBOUND LANE 0010 28+22 \_ 28+42 RT 25 NOTHBOUND LANE PANEL ---------0010 32+50 38+00 LT 650 SOUTHBOUND LANE ---------0010 10+56 RT/LT 27 BASE AGGREGATE DENSE 0010 46+53 RT 25 49+65 46+73 SOUTHBOUND LANE PANELS \_\_\_ \_\_\_ \_\_\_ 47+03 - 47+23 RT 25 0010 SOUTHBOUND LANE PANELS 0010 48+36 - 48+68 LT 37 SOUTHBOUND LANE PANELS TOTAL 0010 769 2450 2924 27 0010 48+68 \_ 49+03 RT 50 NOTHBOUND LANE PANELS 0010 10+56 - 49+65 RT/LT 161 UNDI STRI BUTED 1775 TOTAL 0010 SELECT CRUSHED MATERIAL 312.0110 LOCATI ON CATEGORY STATION TO STATION TON REMARKS DRILLED TIE BARS 0010 10+56 - 49+65 RT/LT 245 UNDI STRI BUTED 416.0610 CATEGORY STATION LOCATION **EACH** REMARKS TOTAL 0010 245 0010 14+72 RT 3 CONCRETE MEDIAN BLUNT NOSE TOTAL 0010 3 CONCRETE DRIVEWAY 6-INCH 416.0160 CONTINUOUS DIAMOND GRINDING CONCRETE PAVEMENT STATI ON LOCATI ON SY CATEGORY REMARKS 420. 1000 0010 11+13 RT 15 DRI VEWAY STATION TO STATION LOCATION SY CATEGORY REMARKS 0010 11+10 LT 15 DRI VEWAY 15 0010 11+60 LT DRI VEWAY 0010 11+06 49+15 4655 NORTHBOUND LANE 0010 12+25 LT 9 DRI VEWAY 0010 11+06 \_ 49+15 LT 4655 SOUTHBOUND LANE 9 0010 12+80 LT DRI VEWAY 0010 11+06 - 13+20 RT 204 LEFT TURN LANE 0010 42+20 LT 15 DRI VEWAY 0010 46+65 RT 20 DRI VEWAY 9514 TOTAL 0010 TOTAL 0010 98 HWY: STH 35 **COUNTY: LA CROSSE** MISCELLANEOUS QUANTITIES SHEET: PROJECT NO: 5221-03-71

#### HMA PAVEMENT

CATEGORY	STATI ON	TO	STATI ON	LOCATI ON	PAVI NG AREA SY	455. 0605 TACK COAT GAL	460. 6223 HMA PAVEMENT 3 MT 58-28 S TON	460. 6224 HMA PAVEMENT 4 MT 58-28 S TON	465. 0105 ASPHALTI C SURFACE TON	REMARKS
,										
0010	10+56	_	49+65	RT	4778	478	1338	535		NORTHBOUND OUTSIDE LANE
0010	10+56	-	49+65	LT	4778	478	1338	535		SOUTHBOUND OUTSIDE LANE
0010	10+56	-	49+65	RT	4778	334		535		NORTHBOUND INSIDE LANE
0010	10+56	-	49+65	LT	4778	334		535		SOUTHBOUND INSIDE LANE
0010	10+56	-	13+20	LT	293	21		33		SOUTHBOUND LEFT TURN LANE
0010	10+78	_	10+96	RT	8				1	NORTHBOUND TERRACE
0010	11+30	-	46+42	RT	1561				175	NORTHBOUND TERRACE
0010	46+87	-	49+05	RT	97				11	NORTHBOUND TERRACE
0010	11+75	-	12+14	LT	17				2	SOUTHBOUND TERRACE
0010	12+35	-	12+69	LT	27				3	SOUTHBOUND TERRACE
0010	12+90	-	42+04	LT	1295				145	SOUTHBOUND TERRACE
0010	42+37	-	48+95	LT	292				33	SOUTHBOUND TERRACE
				TOTAL 0010	=	1645	2676	2173	370	

#### REHEATING HMA LONGITUDINAL JOINTS

#### CONCRETE CURB & GUTTER 30-INCH TYPE L

					460. 4110. S	
CATEGORY	STATI ON	T0	STATI ON	LOCATI ON	LF	REMARKS
0010	10+56	-	49+65	RT	3900	NORTHBOUND LANES
0010	10+56	_	49+65	LT	3900	SOUTHBOUND LANES
0010	10+56	_	49+65	CL	3900	CENTERLI NE
				TOTAL 0010	11700	

#### CONCRETE SIDEWALK 6-INCH

					602. 0415	
CATEGORY	STATI ON	T0	STATI ON	LOCATI ON	SF	REMARKS
						_
0010	10+54	_	10+64	RT	20	NORTHBOUND
0010	10+64	-	10+78	RT	12	NORTHBOUND
0010	10+49	-	10+65	LT	14	SOUTHBOUND
0010	10+65	_	10+90	LT	4	SOUTHBOUND
0010	11+22	_	11+42	LT	9	SOUTHBOUND
0010	10+56	-	13+20	RT	4	MEDI AN
				TOTAL 0010	63	

#### CURB RAMP DETECTABLE WARNING FIELD NATURAL PATINA

			602. 0515	
CATEGORY	STATI ON	LOCATI ON	SF	REMARKS
				_
0010	10+59	RT	10	NORTHBOUND
0010	10+57	LT	10	SOUTHBOUND
		TOTAL 0010	20	

PROJECT NO: 5221-03-71 HWY: STH 35 COUNTY: LA CROSSE MISCELLANEOUS QUANTITIES SHEET: **E** 

### ADJUSTING INLET COVERS

#### CONCRETE MEDIAN BLUNT NOSE

#### INLET PROTECTION TYPE D

			611. 8115					620. 0200						628. 7020	
CATEGORY	STATI ON	LOCATI ON	EACH	REMARKS	CATEGORY	STATI ON	LOCATI ON	SF	REMARKS		CATEGORY	STATI ON	LOCATI ON	EACH	REMARKS
0010	10+60	RT	1		0010	14+72	RT	8	CONCRETE ME	EDIAN BLUNT NOSE	0010	10+60	RT	1	
0010	13+00	RT	1								0010	13+00	RT	1	
0010	13+00	LT	1				TOTAL 0010	8			0010	13+00	LT	1	
0010	15+50	RT	1								0010	15+50	RT	1	
0010	15+50	LT	1								0010	15+50	LT	1	
0010	17+75	RT	1								0010	17+75	RT	1	
0010	17+75	LT	1								0010	17+75	LT	1	
0010	20+00	RT	1								0010	20+00	RT	1	
0010	20+00	LT	1								0010	20+00	LT	1	
0010	22+50	RT	1								0010	22+50	RT	1	
0010	22+50	LT	1			MOBI	LIZATIONS E	MERGENCY ERO	SION CONTROL	<u>-</u>	0010	22+50	LT	1	
0010	25+00	RT	1								0010	25+00	RT	1	
0010	25+00	LT	1						628. 1910		0010	25+00 25+00	LT	1	
			1		CATEGORY	STATION T	O STATION	LOCATI ON	EACH	REMARKS				1	
0010	27+00	RT	1								0010	27+00	RT	1	
0010	27+00	LT	1		0010	10+56	- 49+87	RT/LT	1	PROJECT LIMITS	0010	27+00	LT	1	
0010	29+00	RT	1								0010	29+00	RT	1	
0010	29+00	LT	1					TOTAL 0010	1		0010	29+00	LT	1	
0010	32+00	RT	1								0010	32+00	RT	1	
0010	32+00	LT	1								0010	32+00	LT	1	
0010	38+00	RT	1								0010	38+00	RT	1	
0010	20.00	LT	1								0010	20.00	LT	1	
0010	38+00	LT	1								0010	38+00	LT	1	
0010	41+00	RT	1								0010	41+00	RT	l a	
0010	41+00	LT	1								0010	41+00	LT	1	
0010	44+00	RT	1					0NO ED0010N	CONTROL		0010	44+00	RT	1	
0010	44+00	LT	1				MOBI LI ZATI	ONS EROSION	CONTROL		0010	44+00	LT	1	
0010	49+25	LT	1						628. 1905		0010	49+25	LT	1	
0010	49+50	LT	1		CATEGORY	STATI ON T	TO STATION	LOCATI ON	EACH	REMARKS	0010	49+50	LT	1	
0010	49+55	RT	1								0010	49+55	RT	1	
0010	49+75	RT	1		0010	10+56	- 49+87	RT/LT	2	PROJECT LIMITS	0010	49+75	RT	1	
		TOTAL 0010	29					TOTAL 0010	2				TOTAL 0010	29	

PROJECT NO: 5221-03-71 HWY: STH 35 COUNTY: LA CROSSE MISCELLANEOUS QUANTITIES SHEET: **E** 

FILE NAME : N:\PDS\...\030200\_mq.pptx PLOT BY : A.R.H. PLOT NAME : PLOT NAME : PLOT SCALE : 1:1

J

#### PERMANENT SIGNING

										637. 2210	637. 2230	638. 2602	REMOVI NG	
								POSTS WOOL		SIGNS	SIGNS	REMOVI NG	SMALL	
								634. 0616	634. 0618	TYPE II	TYPE II	SIGNS	SI GN	
	SIGN	APPROX		SI GN			SI ZE	16-FT	18-FT	REFLECT H	REFLECT F	TYPE II	SUPPORTS	
CATEGORY	NO	STATI ON	LOCATI ON	CODE	DESCRI PTI ON	MESSAGE	INXIN	EACH	EACH	SF	SF	EACH	EACH	REMARKS
0010	1 1	10+75	LT	J2-2	ROUTE TURN ASSEMBLY	EAST, WEST	48 X 57		1		19. 0	1	1	
0010	1-1		LT			STH 16, STH 16			•			•	•	
0010						RT ARROW, LT ARROW								
0010	 1-2	 11+15	MEDI AN	 R6-2R	 ONE WAY RT ARROW	·	24 X 30			25. 0				*5 NEW SIGNS
0010														
0010	1-3	11+40	RT	J4-1	REASSURANCE ASSEMBLY	NORTH	24 X 36	1			6. 0	1	1	
0010						STH 35								
0010	1-4	13+00	LT	D1-3	TRI PLE DESTINATION/ARROW	AHEAD ARROW, STODDARD	54 X 36	2			13. 5	1	1	
0011					DO NOT ENTER		36 X 36			9. 0				NEW SIGN
0010						LT ARROW, WEST SALEM								
0010						BUSINESS DIST, RT ARROW								
0010	1-5	13+60	RT	R2-1	SPEED LIMIT	35	24 X 30	1			5. 0	1	1	
0010					LASER ENFORECED									REMOVED WITH SIGN NO 1-5
0010	1-6	14+10	LT	J2-1	ROUTE TURN ASSEMBLY	SOUTH	24 X 57		1		9. 5	1	1	
0010						STH 35								
0010						AHEAD ARROW								
0010	1-7	14+75	LT		REDUCED SPEED, BIKE ROUTE							1	1	REMOVE
0010	1-8	14+75	MEDI AN	R4-7	KEEP RIGHT SYMBOL		24 X 30				5. 0	1	1	
0010	1-9	15+25	LT	J2-2	ROUTE TURN ASSEMBLY	EAST, WEST	48 X 57		1		19. 0			REMOVED WITH SIGN NO 1-6
0010						STH 16, STH 16								
0010						LT AND RT ADVANCE TURN ARROV	N							
0010	1-10	15+60	RT	I 55-56	ADOPT-A-HI GHWAY SPONSOR	UW-LA CROSSE WRESTLING TEAM	1 30 X 36	1			7. 5	1	1	
0010	1-11	17+60	LT	J1-1	JUNCTION ASSEMBLY	JCT	24 X 39	1			6. 5	1	1	
0010						STH 16								
0010	2-1	19+90	LT		CITY SIGN									EXISTING SIGN TO REMAIN
0010	2-2	28+50	RT	R2-1	SPEED LIMIT 35	35	24 X 30	1			5. 0	1	1	
0010					LASER ENFORECED									REMOVED WITH SIGN NO 2-2
0010	2-3	33+00	LT	R2-1	SPEED LIMIT 35	35	24 X 30	1			5. 0			NEW SIGN
0010	2-4	43+50	RT	R2-1	SPEED LIMIT 35	35	24 X 30	1			5. 0			NEW SI GN
0010	2-5	48+00	LT	R2-1	SPEED LIMIT 35	35	24 X 30	1			5. 0			NEW SIGN
3010	2 0	10100		114 1	OI LLD LI WILL GO	33	21 X 30	•			5. 0			51 51
							TOTAL 0010	10	3	34.0	111. 0	10	10	

\*CITY OF LA CROSSE WILL PROVIDE POSTS STEEL U-CHANNEL AND V-LOC POST ANCHORS. SEE SPECIAL PROVISIONS FOR ADDITIONAL INFORMATION.

#### PERMANENT SIGNING SPECIAL

CATEGORY	STATI ON	TO	STATI ON	LOCATION	SPV. 0060. 01 I NSTALL POSTS STEEL U-CHANNEL EACH	SPV. 0060. 02 I NSTALL V-LOC POST ANCHORS EACH	REMARKS
CATEGURY	STATION	TO	STATION	LOCATI ON	EACH	EACH	REWARKS
0010	10+56	-	13+20	RT	4	4	MEDIAN SIGNING
				TOTAL 0010	4	4	

PROJECT NO: 5221-03-71 HWY: STH 35 COUNTY: LA CROSSE MISCELLANEOUS QUANTITIES SHEET: **E** 

FILE NAME: N:\PDS\...\030200\_mq.pptx PLOT DATE: June 14, 1911

E: June 14, 1911 PLOT BY: A.R.H.

PLOT NAME :

PLOT SCALE: 1:1

638. 3000

I	RAF	FI	C	CONT	ROL	

																											ļ
										643.	0705	643.	0715			643	0920					SPV. O	045. 01 Al 01				ļ
						643	3. 0410	643.	. 0420	WARN		WARN				COVE		643.	1050	643. 30	000		FFI C				i
					SERVI CE		RI CADES		CADES	LI GH		LI GH		643.	0900		GNS	SIG		DETOU			TROL				j
					PERI OD		PE II	-	E III	TYP			PE C	_	GNS	TYP		PCI		SIGN			NES				ļ
_	CATEGORY	LOCATI ON	SIGN CODE	MESSAGE	DAYS	NO	DAY	NO	DAY	NO	DAY	NO	DAY	NO	DAY	NO	EACH	NO	DAY	NO I	)AY	NO	DAY	REMARKS			_ ⁻
	0010	SOUTH OF WORK ZONE	W20-1-A	ROAD WORK AHEAD	45	0	0	0	0	0	0	0	0	8	360	0	0	1	45	0	0	0	0	STAGE CONS	Γ SIGNING (I	DT OP) P	. 1
3	0010	SOUTH OF WORK ZONE	W04-2R	WORK ZONE LANE ENDS	45	0		0	0	0	0	0	0	1	45	0	0	0	0	0	0	0	0		T SIGNING (I		
J	0010	SOUTH OF WORK ZONE	G20-2A	END ROAD WORK	45	0	0	0	0	0	0	0	0	1	45	0	0	0	0	0	0	0	0		T SIGNING (I		
	0010	SOUTH OF WORK ZONE	W20-5-A	RT LANE CLOSED AHEAD	45	0	0	0	0	0	0	0	0	1	45	0	0	0	0	0	0	0	0	STAGE CONS	T SIGNING (I	DT OP) P	. 1
	0010	SOUTH OF WORK ZONE	W12-52	MAX 10' WIDTH	45	0	0	0	0	0	0	0	0	3	135	0	0	0	0	0	0	0	0	STAGE CONS	T SIGNING (I	DT OP) P	1
	0010	SOUTH OF WORK ZONE	W57-52	XX MILES AHEAD	45	0	0	0	0	0	0	0	0	2	90	0	0	0	0	0	0	0	0	STAGE CONS	Γ SIGNING (I	DT OP) P	1
	0010	NORTH OF WORK ZONE	W20-1-A	ROAD WORK AHEAD	45	0		0	0	0	0	0	0	6	270	0	0	1	45	0	0	0	0		Γ SIGNING (I		
	0010	NORTH OF WORK ZONE	WO4-2R	WORK ZONE LANE ENDS	45	0	0	0	0	0	0	0	0	1	45	0	0	0	0	0	0	0	0		Γ SIGNING (I	-	- 1
	0010	NORTH OF WORK ZONE	G20-2A	END ROAD WORK	45	0	0	0	0	0	0	0	0	1	45	0	0	0	0	0	0	0	0		T SIGNING (I	-	- 1
	0010	NORTH OF WORK ZONE	W20-5-A	LT LANE CLOSED AHEAD	45	0		0	0	0	0	0	0	1	45	0	0	0	0	0	0	0	0		T SIGNING (I		
	2012	NORTH OF WORK TONE	W4.0 F0	111 A OL WI DTU	45	•								ā	100	•	•		•	•	•			07105 0010	T 01 01 110 (1	DT (D) D	
	0010	NORTH OF WORK ZONE	W12-52	MAX 10' WI DTH	45	0		0	0	0	0	0	0	4	180	0	0	0	0		0	0	0		T SIGNING (I	•	
	0010	NORTH OF WORK ZONE	W57-52	XX MI LES AHEAD	45	0		0	0	0	0	0	0	1	45	0	0	0	0	0	0	0	0		T SIGNING (I	•	
	0010	NORTH OF WORK ZONE	M1-6	STH 35	45 45	0	0	0	0	0	0	0	0	2	90	0	0	0	0	, ,	0	0	0		T SIGNING (I	•	
	0010 0010	SOUTH OF WORK ZONE SOUTH OF WORK ZONE	MO6-1 M4-8	DI RECTI ONAL ARROW DETOUR	45 45	0	0 0	0	0 0	2 0	90 0	0 0	0 0		270 585	0 0	0 0		ΓSIGNING (I ΓSIGNING (I	•							
	0010	SOUTH OF WORK ZOINE	IVI4-0	DETOUR	43	U	U	U	U	U	U	U	U	U	U	U	U	U	U	15 3	000	U	U	STAGE CONS	i Si Givi ivo (i	NI OP) P	'
	0010	SOUTH OF WORK ZONE	M3-3	SOUTH	45	0		0	0	0	0	0	0	0	0	0	0	0	0		225	0	0		T SIGNING (I		
	0010	SOUTH OF WORK ZONE	M1-6	STH 35	45	0		0	0	0	0	0	0	0	0	0	0	0	0	14	530	0	0		T SIGNING (I	•	
	0010	SOUTH OF WORK ZONE	MO5-1L	ADVANCE TURN ARROW	45	0	0	0	0	0	0	0	0	0	0	2	90	0	0		135	0	0		T SIGNING (I	•	
	0010	SOUTH OF WORK ZONE	W20-2-A	DETOUR AHEAD	45	0	0	0	0	0	0	0	0	0	0	0	0	0	0		135	0	0		T SIGNING (I	•	
	0010	SOUTH OF WORK ZONE	W20-3-A	ROAD CLOSED AHEAD	45	0	0	0	0	0	0	0	0	0	0	0	0	0	0	1	45	0	0	STAGE CONS	T SIGNING (I	NT OP) P	1
	0010	SOUTH OF WORK ZONE	W20-3-D	ROAD CLOSED 500 FT	45	0	0	0	0	0	0	0	0	0	0	0	0	0	0	1	45	0	0	STAGE CONS	T SIGNING (I	NT OP) P	. 1
	0010	SOUTH OF WORK ZONE	W12-52	MAX 10' WIDTH	45	0	0	0	0	0	0	0	0	0	0	3	135	0	0	0	0	0	0		T SIGNING (I	•	
	0010	SOUTH OF WORK ZONE	W57-52	XX MILES AHEAD	45	0	0	0	0	0	0	0	0	0	0	2	90	0	0		0	0	0		T SIGNING (I	•	
	0010	SOUTH OF WORK ZONE	M3-1	NORTH	45	0	0	0	0	0	0	0	0	0	0	0	0	0	0		105	0	0		T SIGNING (I	•	
	0010	SOUTH OF WORK ZONE	M4-8A	END DETOUR	45	0	0	0	0	0	0	0	0	0	0	0	0	0	0	1	45	0	0	STAGE CONS	Γ SIGNING (I	NT OP) P	1
	0010	SOUTH OF WORK ZONE	R3-8-W	VARIOUS ONLYS	45	0	0	0	0	0	0	0	0	0	0	1	45	0	0	0	0	0	0	STAGE CONS	T SIGNING (I	NT OP) P	. 1
	0010	NORTH OF WORK ZONE	MO6-1	DI RECTI ONAL ARROW	45	0	0	0	0	0	0	0	0	0	0	0	0	0	0	5 2	225	0	0		T SIGNING (I		
	0010	NORTH OF WORK ZONE	M4-8	DETOUR	45	0	0	0	0	0	0	0	0	0	0	0	0	0	0	8 3	360	0	0	STAGE CONS	T SIGNING (I	NT OP) P	2
	0010	NORTH OF WORK ZONE	M3-3	SOUTH	45	0	0	0	0	0	0	0	0	0	0	0	0	0	0	5 2	225	0	0	STAGE CONS	T SIGNING (I	NT OP) P	2
	0010	NORTH OF WORK ZONE	M1-6	STH 35	45	0	0	0	0	0	0	0	0	0	0	0	0	0	0	11 4	195	0	0	STAGE CONS	T SIGNING (I	NT OP) P	2
	0010	NORTH OF WORK ZONE	MO5-1L	ADVANCE TURN ARROW	45	0	0	0	0	0	0	0	0	0	0	0	0	0	0	3	135	0	0	STAGE CONS	Γ SIGNING (I	NT ()P) P	2
	0010	NORTH OF WORK ZONE	W20-2-A	DETOUR AHEAD	45	0	0	0	0	0	0	0	0	0	0	0	0	0	0		45	0	0		T SIGNING (I		
	0010	NORTH OF WORK ZONE	W20-3-A	ROAD CLOSED AHEAD	45	0	0	0	0	0	0	0	0	0	0	0	0	0	0		45	0	0		T SIGNING (I	•	
	0010	NORTH OF WORK ZONE	W20-3-D	ROAD CLOSED 500 FT	45	0	0	0	0	0	0	0	0	0	0	0	0	0	0		45	0	0		T SIGNING (I	•	
	0010	NORTH OF WORK ZONE	W12-52	MAX 10' WIDTH	45	0		0	0	0	0	0	0	0	0	4	180	0	0	0	0	0	0		T SIGNING (I	•	
	0010	NORTH OF WORK ZONE	W57-52	XX MILES AHEAD	ΛE	0	0	0	0	0	0	0	0	0	0	1	1E	0	0	0	0	0	0	STACE COME	Γ SIGNING (I	ע למט דוו	2
	0010	NORTH OF WORK ZONE	w57-5∠ M3-1	NORTH	45 45	0	0	0	0	0	0	0	0	0	0	0	45 0	0	0		0 180	0 0	0 0		ΓSIGNING (1 ΓSIGNING (1	•	
	0010	NORTH OF WORK ZONE	M4-8A	END DETOUR	45 45	0	0	0	0	0	0	0	0	0	0	0	0	0	0		45	0	0		ΓSIGNING (I	•	
	0010	NORTH OF WORK ZONE	R3-8-F	VARIOUS ONLYS	45 45	0	0	0	0	0	0	0	0	0	0	1	45	0	0	0	0	0	0		ΓSIGNING (I	•	
	0010	SOUTH OF WORK ZONE	R3-20-R	BEGIN RT TURN LANE	45	0	0	1	45	2	90	0	0	1	45	0	0	0	0	0	0	0	0		Γ (DAYTIME (	•	-
																								CONTI NUE	D ON NEX	(T PAGI	<u>:  </u>
ŀ	PRO IFCT	NO: 5221-03-71		HWY: STH 35			COLIN	TV·ΙΛ	CROSS	F			MIC	CELLA	NEOLIS	SOLIA	NTITIES							1	IEET:	1	E
L	INOUEUI	140. 0221-03-71		T 11W 1. O 111 30			COUN	LA					IVIIC	JULLLA	INLOUS	, WOAI	*1111EO	1						SI	ILL I.		<b>←</b> J.

PLOT SCALE: 1:1

į	CONTIN	IUED FROM I	PREVI OU	S PAGE							TRAFFI	C CO	NTROL														
	ATEGORY	LOCATI	ON	SIGN CODE	MESSAGE	SERVI CE PERI OD DAYS	TYPE	ADES	643. 04 BARRI CA TYPE I	ADES	643. 0 WARNI LI GHT TYPE NO	NG S A	643. 0 WARNI LI GHT TYPE NO	NG TS : C	643. 0 SI GI NO	NS	643. ( COVER SI G TYPE NO	ING NS II	643. SI G PCI NO	NS //S	643. 300 DETOUR SI GNS NO DA	SPECI O TRA COM	0045. 01 AL 01. AFFIC ITROL DNES DAY	- REMARKS			
— <u> ≚</u> 	0010	SOUTH OF WO		R11-2L	LANE CLOSI		0	0	,	225		450		270		225	0	0	0	0	0 0	32	1440	STAGE CONST	(DAVTI ME	OD) D 1	
3	0010 0010	SOUTH OF WO SOUTH OF WO	ORK ZONE ORK ZONE	WO1-6 R11-2L	RI GHT ARRO ROAD CLOSI	OW 45 ED 45	0	0 0	1 4 10 4	45 150	2 12	90 540	0 0	0 0	1 2	45 90	0	0	0	0	0 0	0 0	0 0	STAGE CONST STAGE CONST	(DAYTI ME (DAYTI ME	0P) P. 1 0P) P. 1	
     		STA 10+50 TO STA 10+50 TO		R11-2L W01-6	LANE CLOSI RI GHT ARRO		0	0		360 90		720 180	6 0	270 0	8 2	360 90	0	0	0	0	0 0	366 0	16470 0	STAGE CONST STAGE CONST		•	
<b>−</b> [	0010	NORTH OF WO		R11-2L	LANE CLOSE		0	0		90		180	0	0	2	90	0	0	0	0	0 0	0	0	STAGE CONST	•	•	
ļ	0010	NORTH OF WO		W01-6	RI GHT ARRO		0	0		45 00		90	0	0	1	45	0	0	0	0	0 0	0	0	STAGE CONST	•	•	
ł	0010 0010	SOUTH OF WO		R11-2L W01-6	LANE CLOSI RIGHT ARRO		0 0	0 0		90 45		180 90	3 0	135 0	2	90 45	0 0	0 0	0 0	0 0	0 0	11 0	495 0	STAGE CONST STAGE CONST		•	
	0010	SOUTH OF WO		R3-2	NO LEFT TU		0	0		135		270		270	3	135	0	0	0	0	0 0	20	900	STAGE CONST	•	•	
ļ	0010	SOUTH OF WO		R3-1	NO RIGHT TO		0	0		90		180		180	2	90	0	0	0	0	0 0	9	405	STAGE CONST	•	•	
ļ		STA 10+50 TO		R11-2L	ROAD CLOSI		0	0		575 45		890	0	0	7	315	0	0	0	0	0 0	0	0	STAGE CONST	•	•	
ł	0010 0010	NORTH OF WO		R11-2L W01-6	LANE CLOSI RI GHT ARRO		0 0	0 0		45 90		90 180	6 0	270 0	2	45 90	0 0	0 0	0 0	0 0	0 0	22 0	990 0	STAGE CONST		•	
	0010	NORTH OF WO		R3-1	NO RIGHT TU		0	0		90		180		270	2	90	0	0	0	0	0 0	13	585	STAGE CONST	•	•	
ļ		STA 10+50 TO		R11-2L	ROAD CLOSI		0	0		450		540	0	0	2	90	0	0	0	0	0 0	0	0	STAGE CONST	-	-	
ļ	0010	PROJECT L			W CLOSED AHEAD			90		0		90	0	0	2	90	0	0	0	0	0 0	0	0	STAGE CONST	•	-	
ł	0010 0010	PROJECT L PROJECT L		R9-11-A R9-9	SW CLOSED W// SIDEWALK CLO		2 0	90 0		0 180		90 180	0 0	0 0	2 2	90 90	0 0	0 0	0 0	0 0	0 0	0 0	0 0	STAGE CONST	•		•
İ	0010	1103201 2	- T WIT 13	Κ, ,	OI DEMMER OF	TOTAL 001		180		140		300		1665		3690		720		90	432		21285	=	(TEIII SII	SEGGORE	,
											<u>PAVEMEN</u>	IT MA	ARKI NG														
						646. 0126														6	649. 0400						
						EPOXY 8-I NCH	SAME DAY	6. 040 ′ S	SAME DAY		46. 0600		647. 016 ARROWS		647. 056 STOP LI	NE	647. 060 I SLAND		47. 0776 ROSSWAL	5 T	EMPORARY EMOVABLE	649.04 TEMPORA	ARY				
						CHANNELI ZI NG	EPOXY		EPOXY		EMOVI NG		EPOXY		EPOXY		NOSE		EPOXY	ı	TAPE	PAI N					
						LANE LINE WHITE	4-INCH YELLOW		4-I NCH WHI TE		AVEMENT ARKI NGS		TYPE 2 WHITE		18-I NC WHI TE		EPOXY YELLOW		12-INCH WHITE	l	4-I NCH WHI TE	4-I NC YELLO					
		CATEGORY	STATI ON	TO STATION	LOCATI ON	LF	LF		LF		LF		EACH		LF		EACH		LF		LF	LF		EMARKS	<u>.</u>		
		0010 0010	10+51 10+58		RT/LT RT/LT						79 								79 79								
		0010	10+62		RT/LT										35												
		0010	10+88		RT								1														
		0010	12+36	10 (0	RT	200							1														
		0010 0010	10+62 10+62	- 12+62 - 49+87	RT RT	200			981																		
		0010	10+62	- 49+87	LT				981								2										
		0010	14+73	- 15+50	CL		154															154					
		0010	14+73	- 49+87	CL		7028															7028					
		0010	10+56	- 49+87	CL _																250		TF	RAFFIC CONTROL	TAPERS		
				SUB	TOTAL 0010	200	7182		1962		79		2		35		2		158		250	7182					
					TOTAL 0010			9144																			_
	PROJECT	NO: 5221-03-	71		HWY: STH 35		c	COUNT	TY: LA CF	ROSS	E			MIS	SCELLAN	NEOU	S QUAN	TITIES	3					SHI	EET:		E

## TEMPORARY PEDESTRIAN SAFETY FENCE

					644. 1616. S	
CATEGORY	STATI ON	T0	STATI ON	LOCATI ON	LF	REMARKS
0010	10+56	-	49+65	RT	3909	PROJECT LIMITS
				TOTAL 0010	3909	

#### CONSTRUCTION STAKING CURB GUTTER AND CURB & GUTTER

					650. 5500	
CATEGORY	STATI ON	TO	STATI ON	LOCATI ON	LF	REMARKS
0010	10+74	-	49+65	RT	3926	NORTHBOUND
0010	10+74	-	49+65	LT	3926	SOUTHBOUND
				TOTAL 0010	7852	

#### CONSTRUCTION STAKING RESURFACING REFERENCE

				650. 8000	
CATEGORY	STATION TO	STATI ON	LOCATI ON	LF	REMARKS
0010	10+56 -	49+65	RT/LT	3909	PROJECT LIMITS
			T0TAL 0010	3909	

#### CONSTRUCTION STAKING SUPPLEMENTAL CONTROL (PROJECT) 01.5221-03-71

		650. 9910					
CATEGORY	STATI ON TO STATI ON	LOCATI ON	LS	REMARKS			
0010	10+56 - 49+65	RT/LT	1	PROJECT LIMITS			
		TOTAL 0010	1				

#### SAWING CONCRETE

					690. 0250	
CATEGORY	STATI ON	T0	STATI ON	LOCATI ON	LF	REMARKS
0010	10+56	-	49+65	RT	3923	NORTHBOUND OUTSIDE LANE REMOVAL
0010	10+56	-	49+65	LT	3923	SOUTHBOUND OUTSIDE LANE REMOVAL
0010	10+56	-	13+00	RT	264	BASE PATCHING LEFT TURN LANE
0010	10+56	-	49+65	RT	4810	BASE PATCHING NORTHBOUND INSIDE LANE
0010	10+56	-	49+65	LT	4654	BASE PATCHING SOUTHBOUND INSIDE LANE
0010	11+38	-	11+58	LT	62	BASE PATCHING SOUTHBOUND INSIDE LANE
0010	12+58	-	12+78	LT	62	BASE PATCHING SOUTHBOUND INSIDE LANE
0010	16+20	-	16+80	LT	142	BASE PATCHING SOUTHBOUND INSIDE LANES
0010	16+20	-	16+40	RT	62	BASE PATCHING NORTHBOUND INSIDE LANE
0010	17+00	-	17+20	LT	62	BASE PATCHING SOUTHBOUND INSIDE LANE
0010	19+00	-	20+00	RT	222	BASE PATCHING NORTHBOUND INSIDE LANES
0010	19+60	-	20+00	LT	102	BASE PATCHING SOUTHBOUND INSIDE LANES
0010	21+00	-	21+60	LT	142	BASE PATCHING SOUTHBOUND INSIDE LANES
0010	25+02	-	25+22	RT	62	BASE PATCHING NORTHBOUND INSIDE LANE
0010	25+62	-	26+12	LT	128	BASE PATCHING SOUTHBOUND INSIDE LANES
0010	27+82		28+02	LT	62	BASE PATCHING SOUTHBOUND INSIDE LANE
0010	28+22	-	28+42	RT	62	BASE PATCHING NORTHBOUND INSIDE LANE
0010	46+53	-	46+73	RT	62	BASE PATCHING NORTHBOUND INSIDE LANE

TOTAL 0010 20976

LT

RT

RT

RT/LT

#### SPECIAL 01. CONCRETE JOINT AND CRACK CLEANING

88

102

12

1906

MEDI AN

UNDI STRI BUTED

BASE PATCHING NORTHBOUND INSIDE LANE

BASE PATCHING SOUTHBOUND INSIDE LANE

BASE PATCHING NORTHBOUND INSIDE LANE

					SPV. 0090. 01	
CATEGORY	STATI ON	T0	STATI ON	LOCATI ON	LF	REMARKS
0010	10+56	-	49+65	CL/RT/LT	3909	UNDI STRI BUTED
				TOTAL 0010	3909	

#### SPECIAL 01. INSTALL STATE FURNISHED VIDEO DETECTION SYSTEM

					SPV. 0105. 01	
CATEGORY	STATI ON	T0	STATI ON	LOCATI ON	LS	REMARKS
0010	9+00	-	10+75	LT	1	STH 16/STH 35 INTERSECTION
				TOTAL 0010	1	

PROJECT NO: 5221-03-71 HWY: STH 35 COUNTY: LA CROSSE MISCELLANEOUS QUANTITIES SHEET: **E** 

0010

0010

0010

0010

0010


47+03 - 47+23


48+36 - 48+68


48+68 - 49+03


10+56 - 49+65

10+56 - 49+65

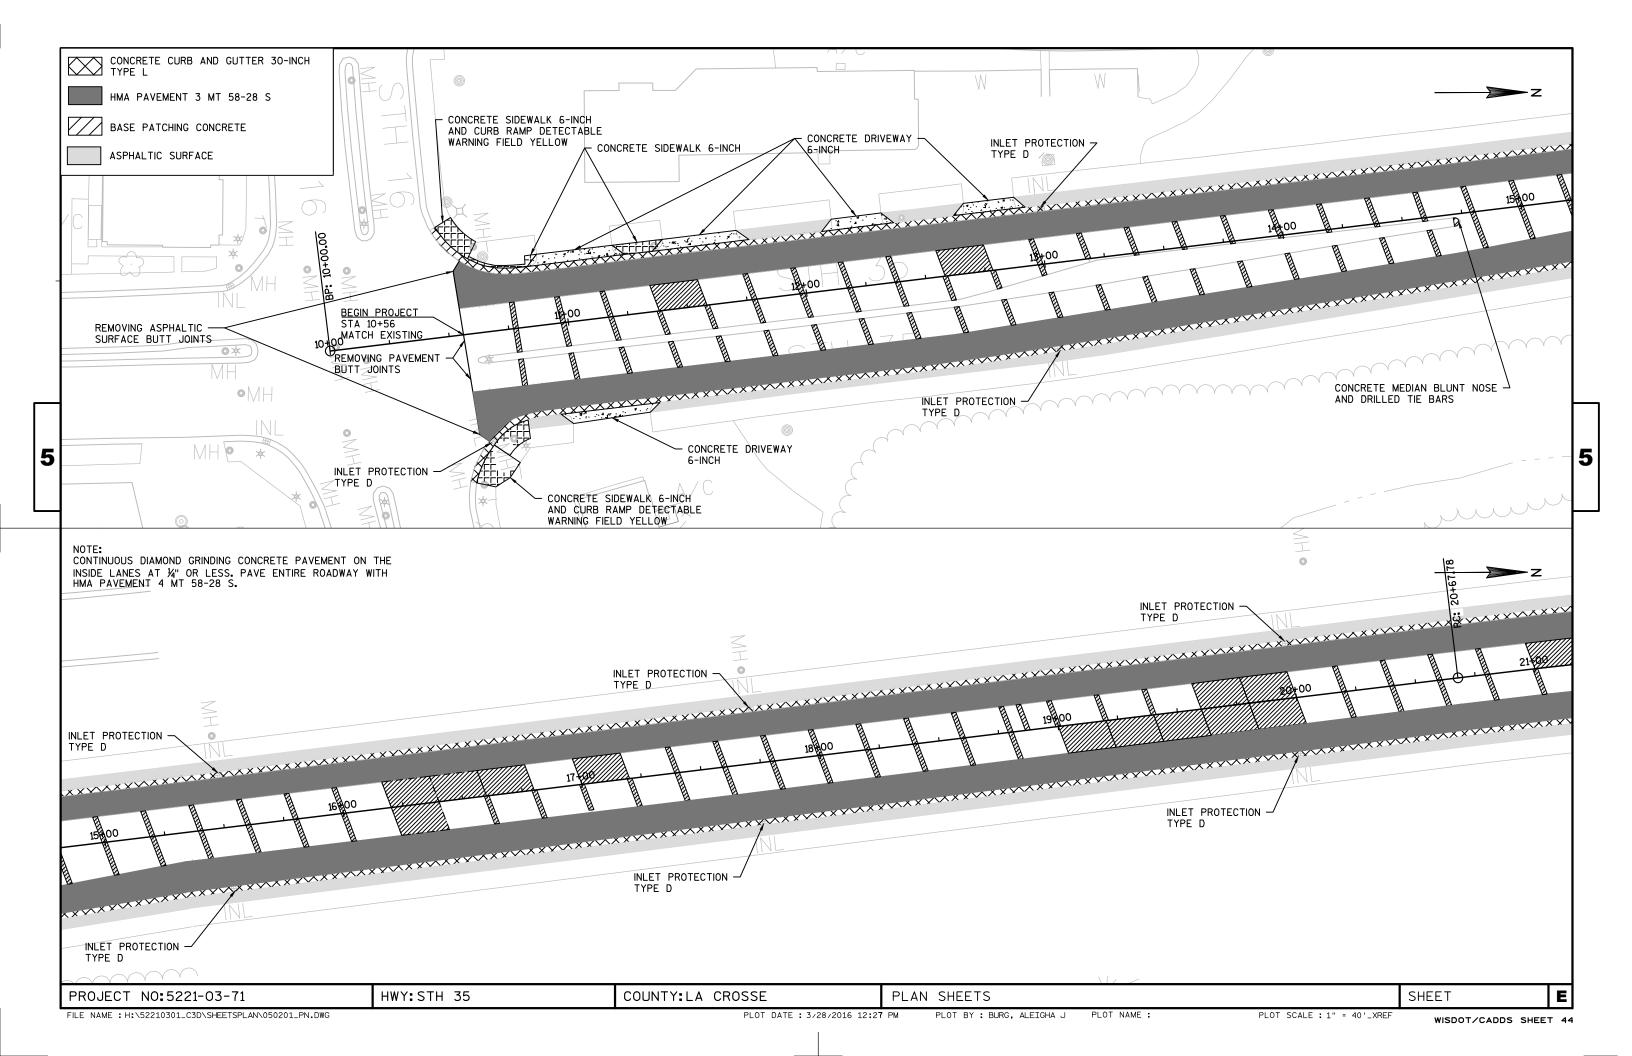

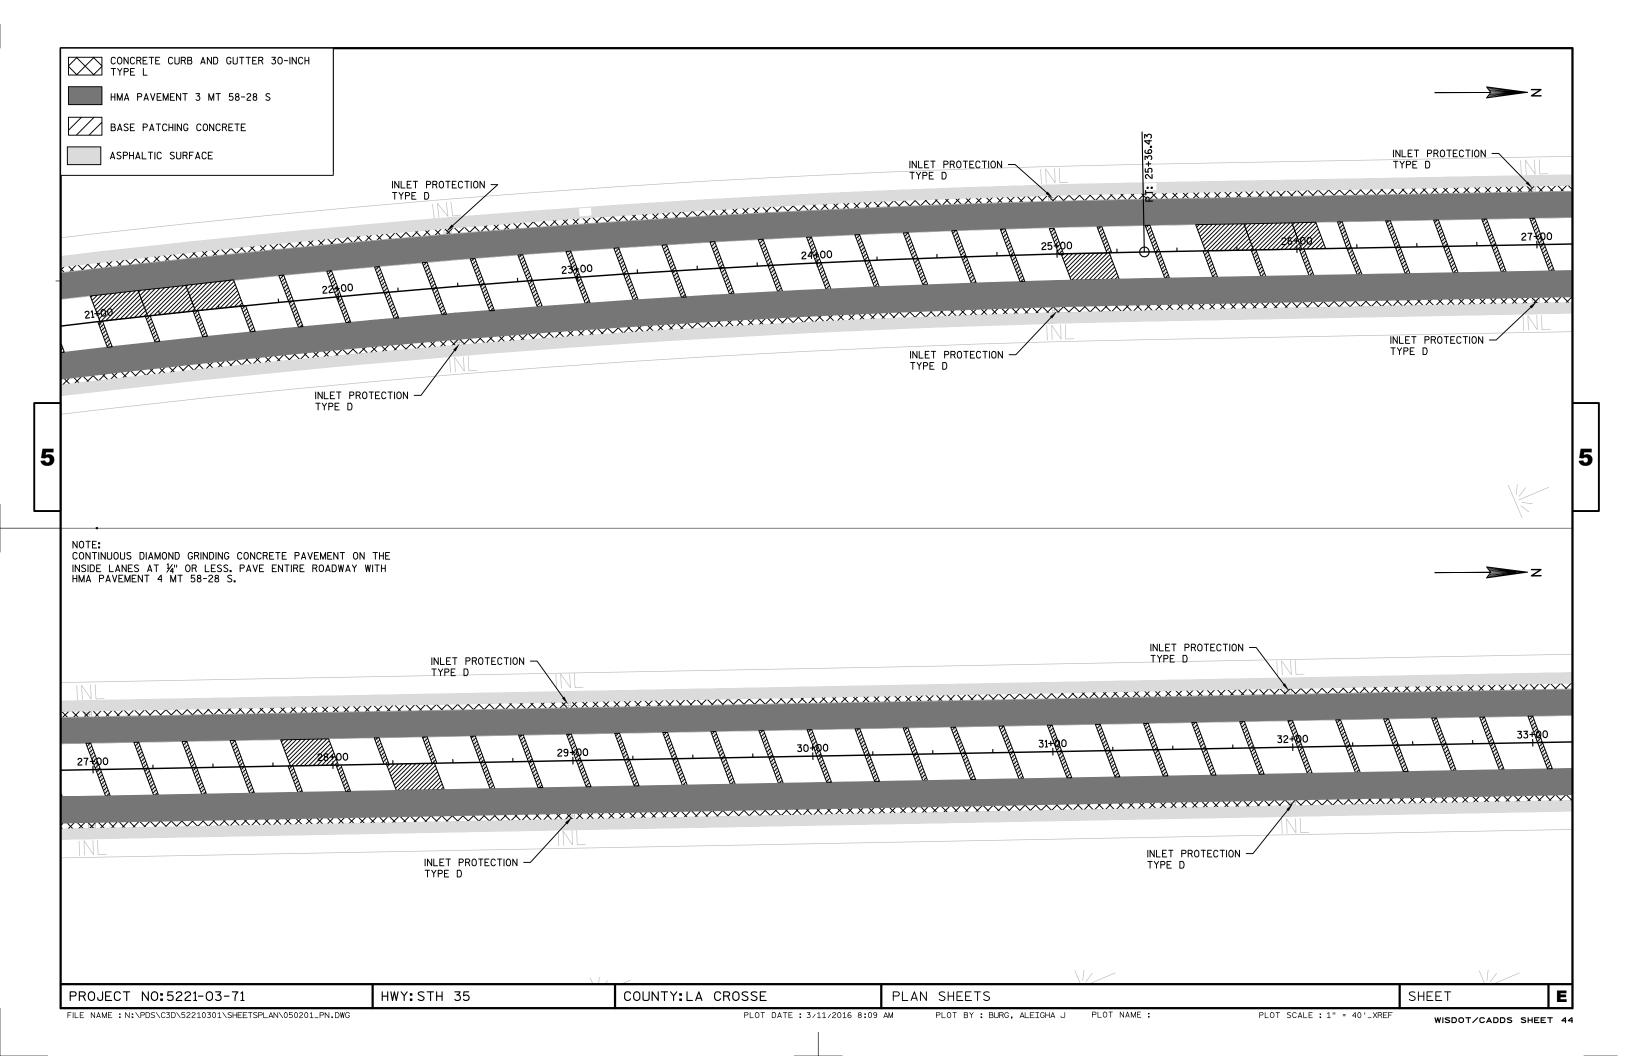


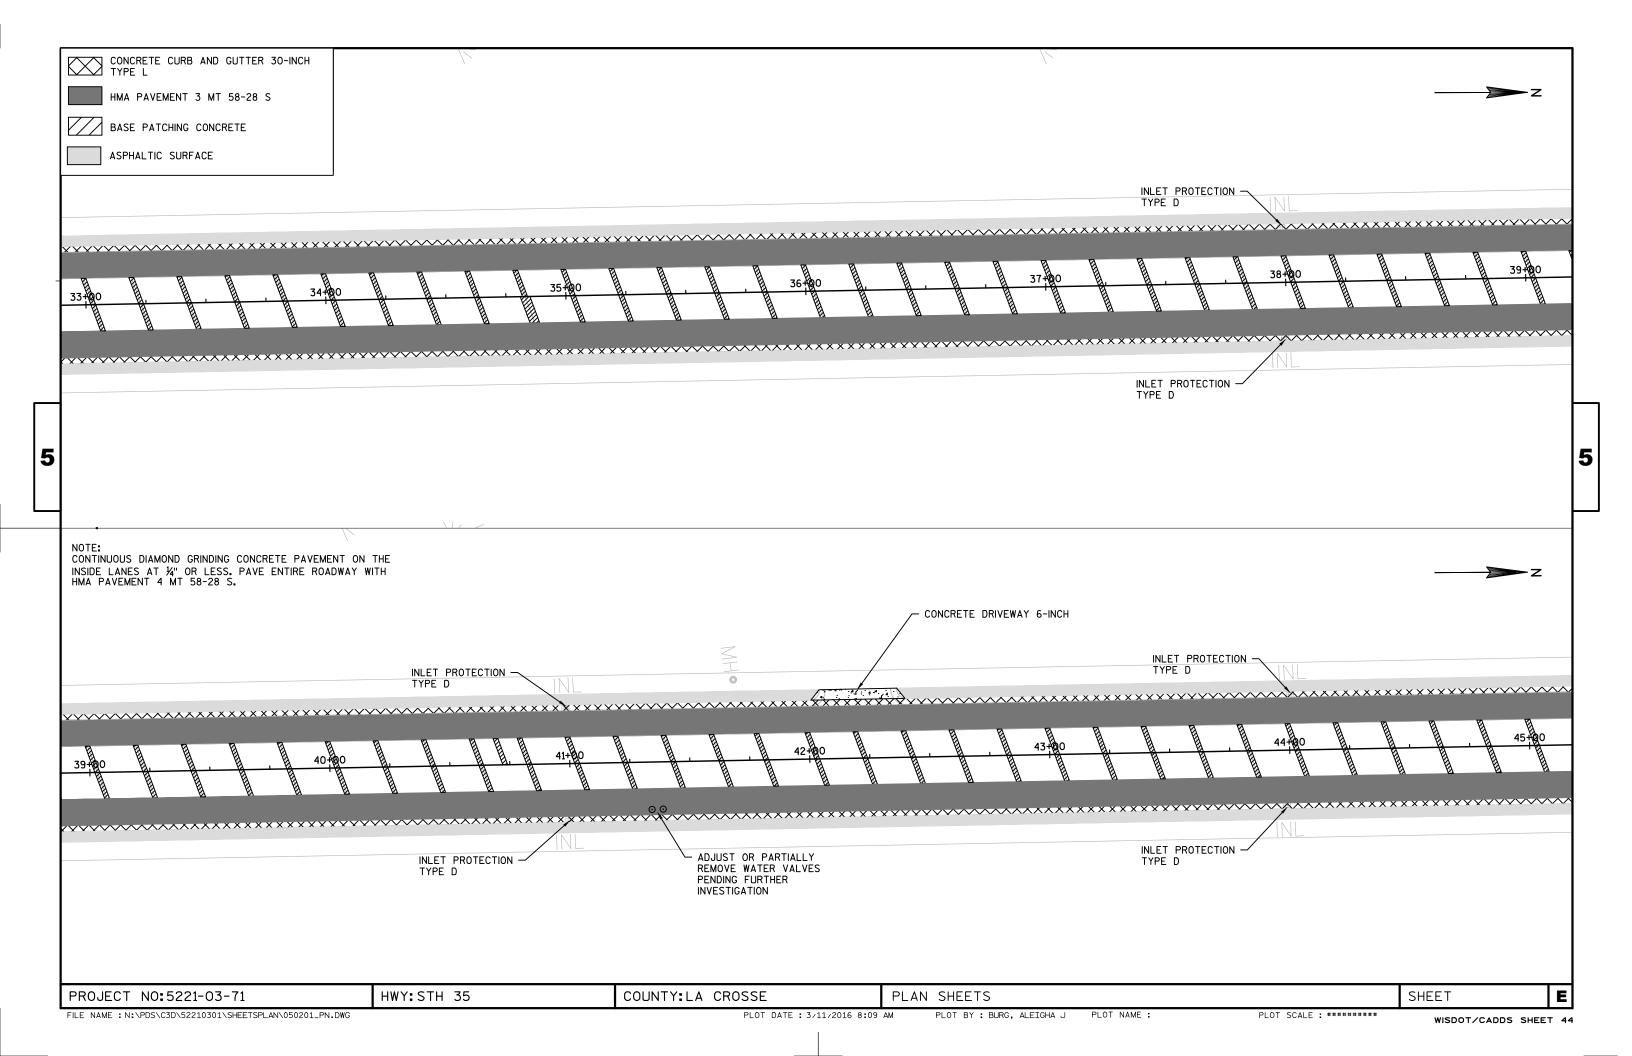


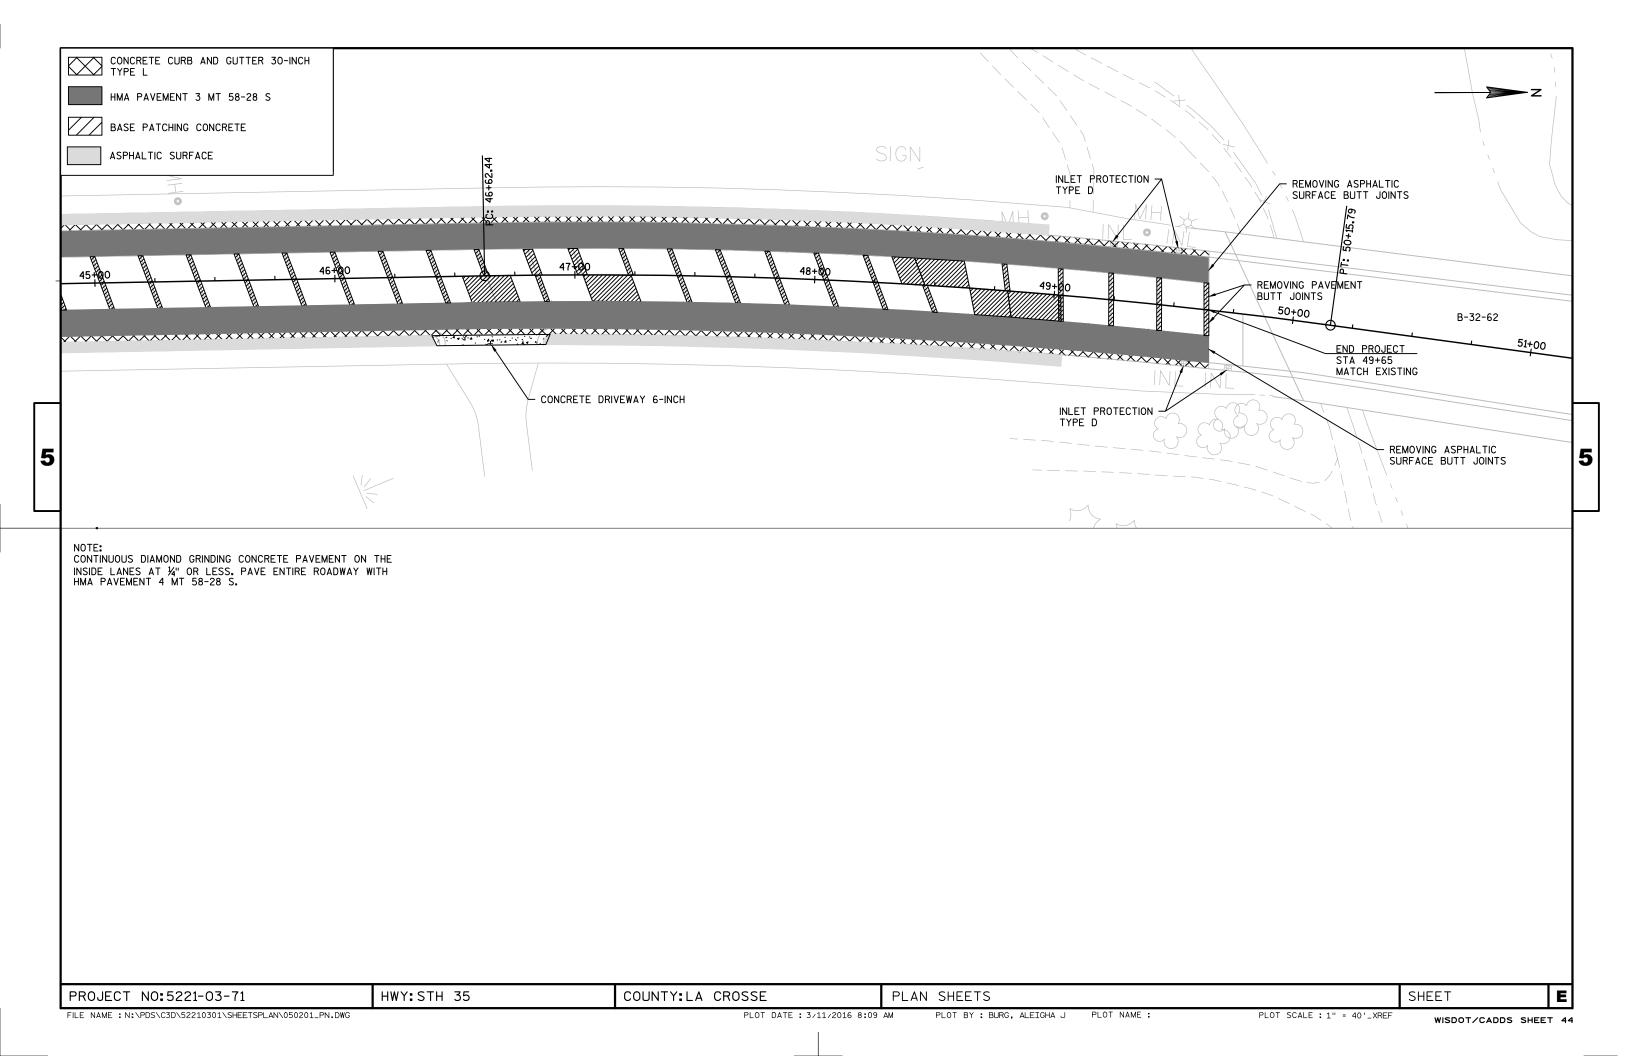



### Standard Detail Drawing List


08D01-18 08D05-16A	CONCRETE CURB, CONCRETE CURB AND GUTTER AND TIES CURB RAMPS TYPES 1 AND 1-A
08D05-16B	CURB RAMPS TYPES 2 AND 3
08D05-16C	CURB RAMPS TYPES 4A AND 4A1
	CURB RAMPS TYPE 4B AND 4B1
08D05-16E	CURB RAMPS TYPES 5, 6, 7A, 7B & 8
08E10-02	INLET PROTECTION TYPE A, B, C AND D
11B02-02	CONCRETE MEDIAN NOSE
	BASE PATCHING CONCRETE
13C14-06B	BASE PATCHING CONCRETE
	BASE PATCHING CONCRETE
	BARRICADES AND SIGNS FOR MAINLINE CLOSURES
	BARRICADES AND SIGNS FOR MAINLINE CLOSURES
	DETOUR SIGNING FOR MAINLINE CLOSURES
	TRAFFIC CONTROL, ADVANCE WARNING SIGNS 40 M.P.H. OR LESS
	PAVEMENT MARKING ARROWS
	PAVEMENT MARKING (MAINLINE)
15C08-16E	
	PAVEMENT MARKING (ISLANDS)
	STOP LINE AND CROSSWALK PAVEMENT MARKING
15D20-03	TRAFFIC CONTROL, SINGLE LANE CLOSURE, NON-FREEWAY/EXPRESSWAY
15D21-03	TRAFFIC CONTROL, INTERSECTION WITHIN SINGLE LANE CLOSURE
15D22-02	TRAFFIC CONTROL, TWO LANE CLOSURE, NON-FREEWAY/EXPRESSWAY
15D30-02A	TRAFFIC CONTROL, PEDESTRIAN ACCOMMODATION
15D30-02B 15D30-02C	TRAFFIC CONTROL, TEMPORARY ADA COMPLIANT PEDESTRIAN ACCOMMODATION TRAFFIC CONTROL. PEDESTRIAN ACCOMMODATION
13030-026	TRAFFIC CONTROL, PEDESTRIAN ACCOMMUDATION

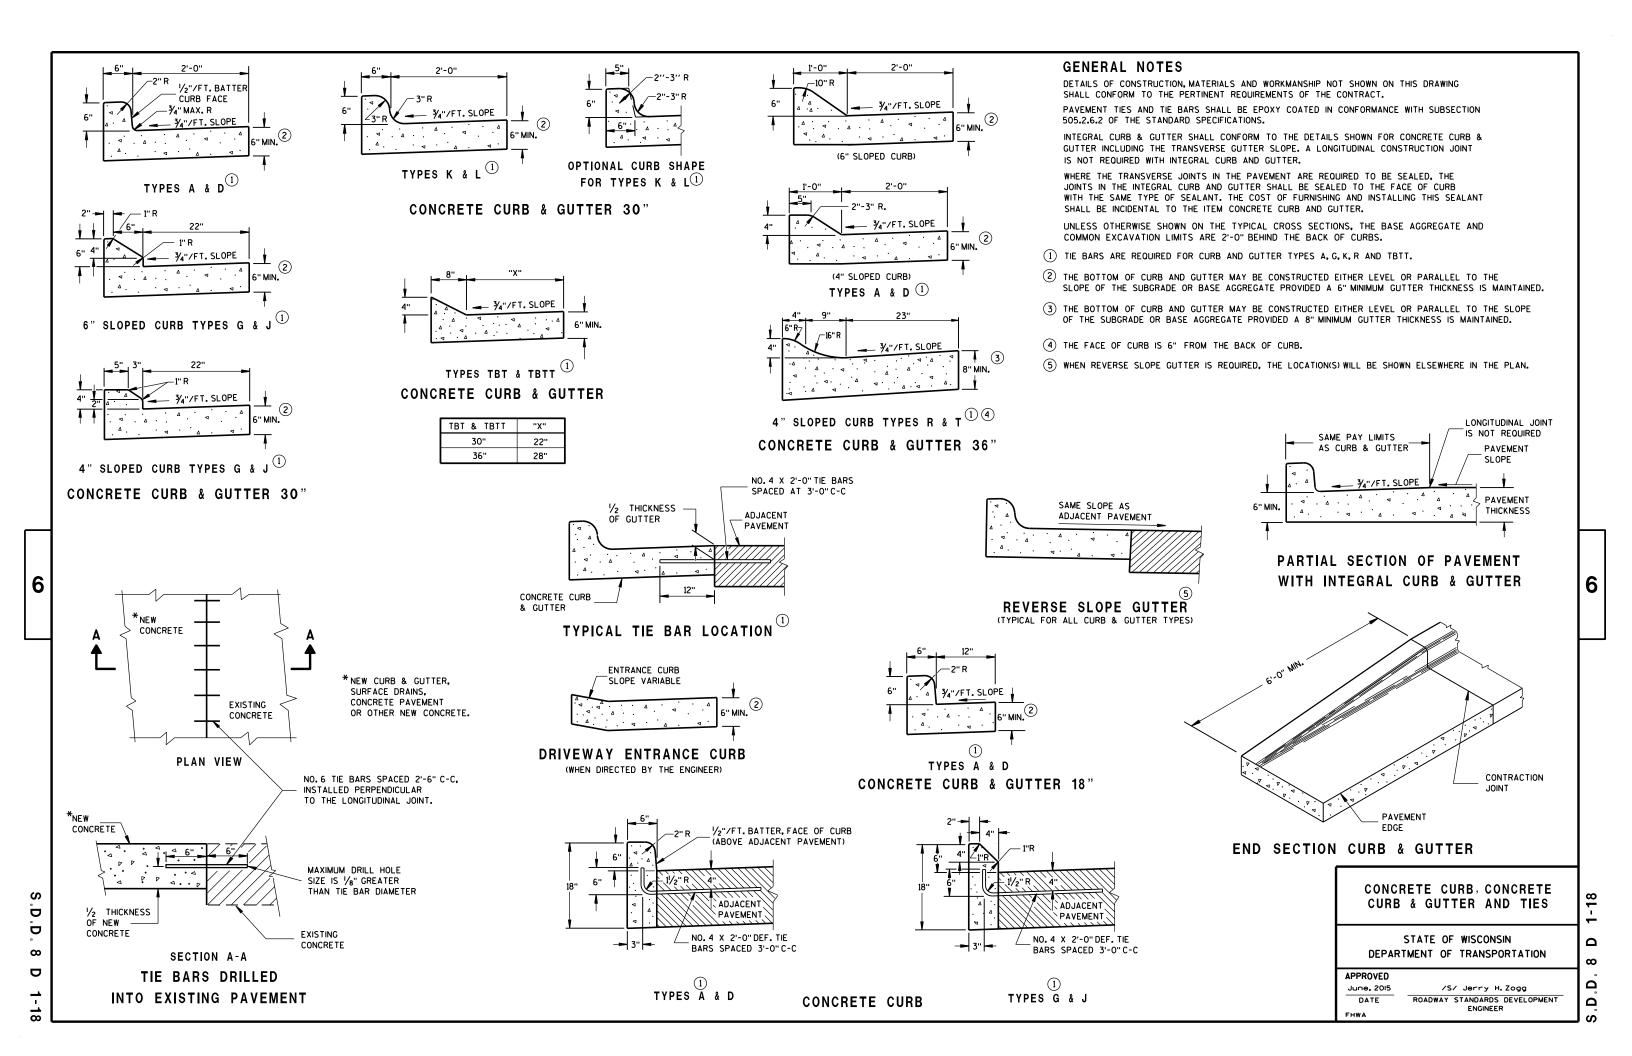

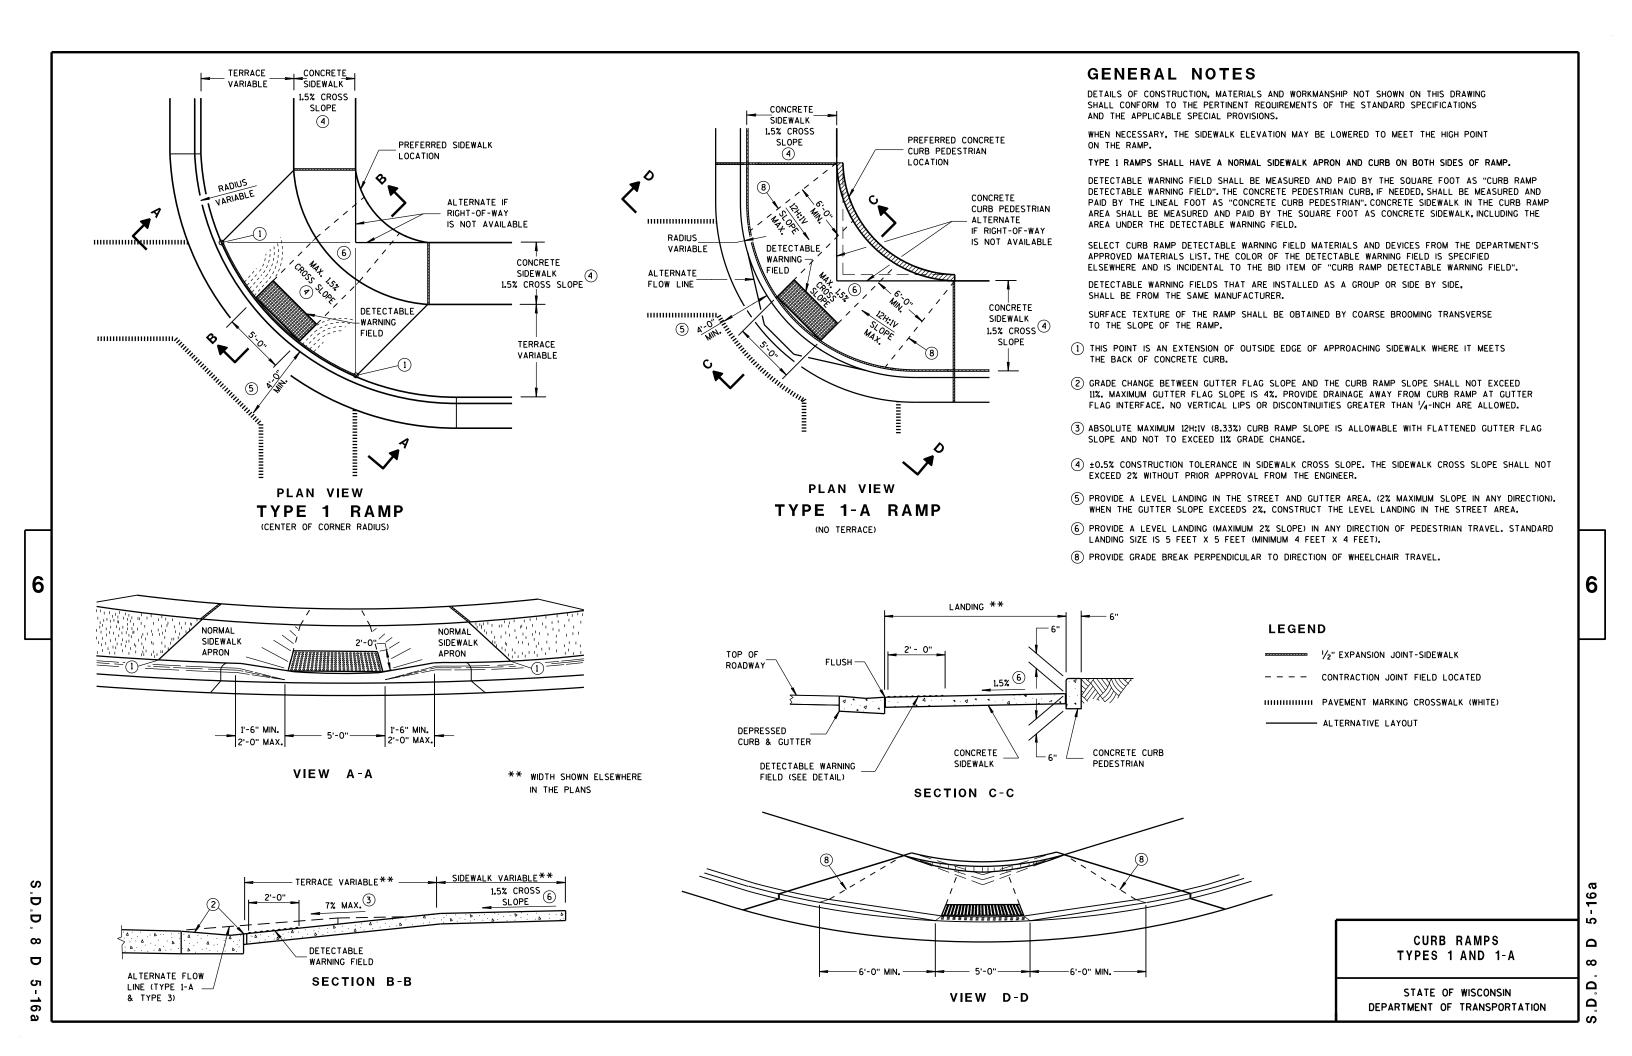

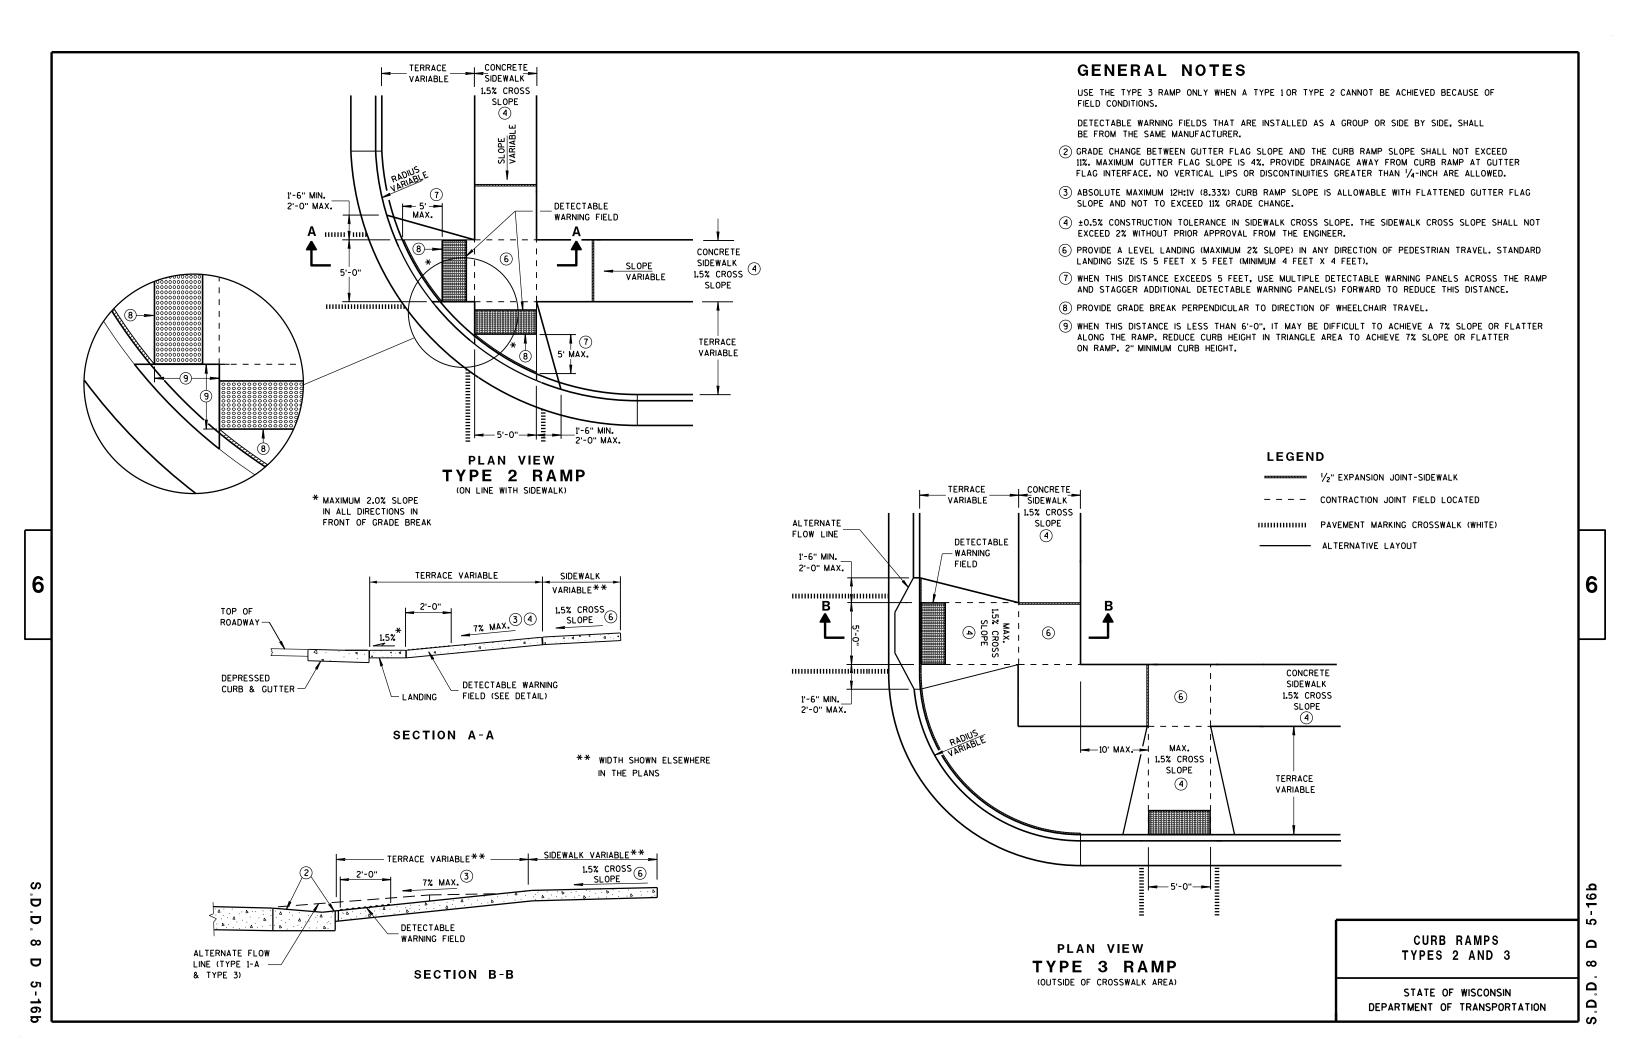

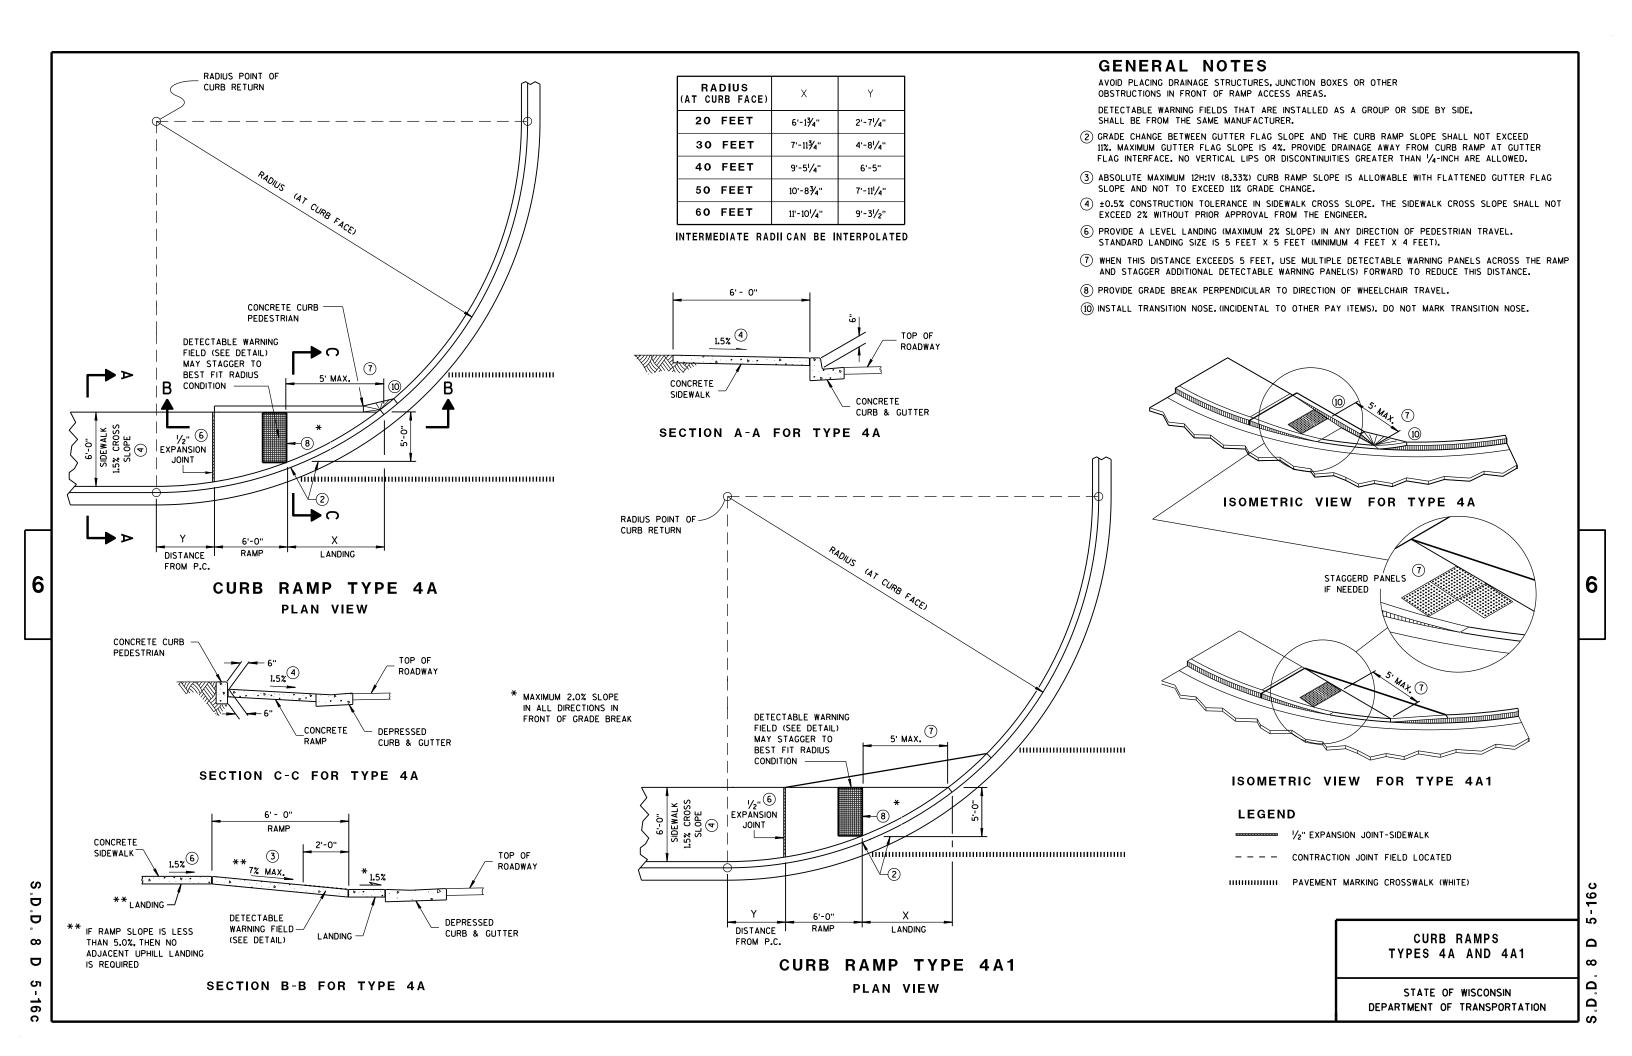

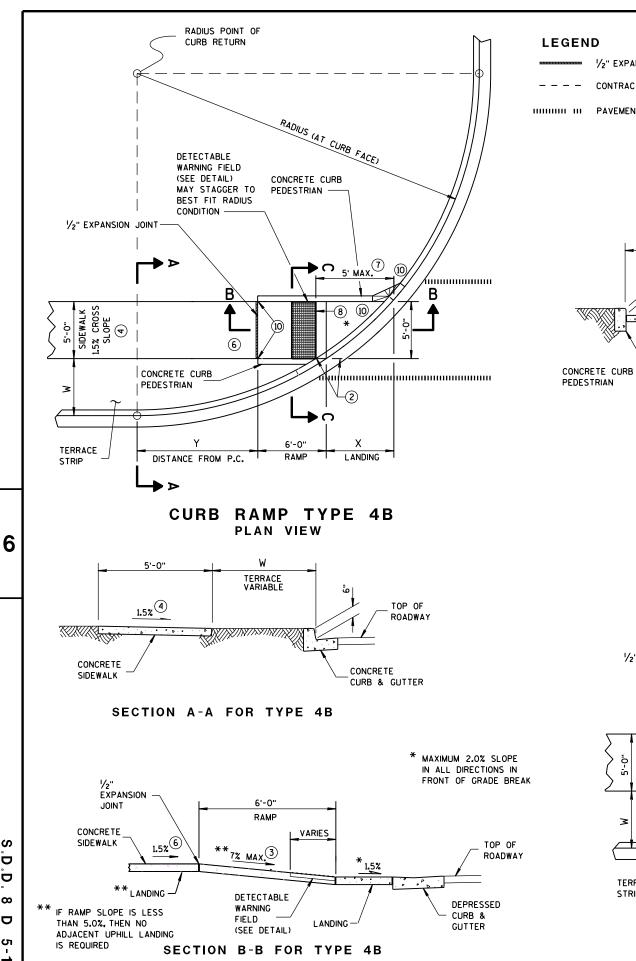

D

 $\infty$ 

D

16 d

#### W = 5' - 0" 7' - Ø" 3' - Ø" W = 4' - Ø" W = 6' - 0"RADIUS LEGEND AT CURB FACE ■ ½" EXPANSION JOINT-SIDEWALK 20 FEET 4'-81/2" 3'-7" 3'-11/2" 4'-61/2" 4'-1" 7'-23/4" 8'-31/2" 9'-21/2" 5'-51/2" 6'-0" CONTRACTION JOINT FIELD LOCATED 30 FEET 6'-51/2" 5'-91/4" 5'-21/2" 4'-8¾" 7'-31/4' 8'-11'/2" 10'-7" 12'-0" 13'-31/4" HIHHHH HI PAVEMENT MARKING CROSSWALK (WHITE) 40 FEET 8'-91/2" 9'-21/2" 11'-5'/4" 13'-41/2" 15'-3/4" 16'-71/4" 50 FEET 7'-61/2" 6'-11¾" 19'-6'/4" 11'-3/4" 15'-91/2"

10'-¾"

### **GENERAL NOTES**

12'-8¾"

11'-2'/2"

60 FEET

TOP OF

ROADWAY

TERRACE STRIP

VARIES O TO W

CONCRETE

CURB & GUTTER

5'-0" RAMP

VARIES

0 TO 6"

1.5%

SECTION C-C FOR TYPE 4B

INTERMEDIATE RADII CAN BE INTERPOLATED

7'-101/2"

22'-11/2"

20'-1¾"

AVOID PLACING DRAINAGE STRUCTURES, JUNCTION BOXES OR OTHER OBSTRUCTIONS IN FRONT OF RAMP ACCESS AREAS. DETECTABLE WARNING FIELDS THAT ARE INSTALLED AS A GROUP OR SIDE BY SIDE, SHALL BE FROM THE SAME MANUFACTURER.

17'-113⁄4"

8'-5¾"


(2) GRADE CHANGE BETWEEN GUTTER FLAG SLOPE AND THE CURB RAMP SLOPE SHALL NOT EXCEED 11%. MAXIMUM GUTTER FLAG SLOPE IS 4%. PROVIDE DRAINAGE AWAY FROM CURB RAMP AT GUTTER FLAG INTERFACE. NO VERTICAL LIPS OR DISCONTINUITIES GREATER THAN 1/4-INCH ARE ALLOWED.

9'-21/4"


- (3) ABSOLUTE MAXIMUM 12H:1V (8.33%) CURB RAMP SLOPE IS ALLOWABLE WITH FLATTENED GUTTER FLAG SLOPE AND NOT TO EXCEED 11% GRADE CHANGE.
- 4) ±0.5% CONSTRUCTION TOLERANCE IN SIDEWALK CROSS SLOPE, THE SIDEWALK CROSS SLOPE SHALL NOT EXCEED 2% WITHOUT PRIOR APPROVAL FROM THE ENGINEER.
- 6 PROVIDE A LEVEL LANDING (MAXIMUM 2% SLOPE) IN ANY DIRECTION OF PEDESTRIAN TRAVEL. STANDARD LANDING SIZE IS 5 FEET X 5 FEET (MINIMUM 4 FEET X 4 FEET).

15'-61/2"

- (7) WHEN THIS DISTANCE EXCEEDS 5 FEET, USE MULTIPLE DETECTABLE WARNING PANELS ACROSS THE RAMP AND STAGGER ADDITIONAL DETECTABLE WARNING PANEL(S) FORWARD TO REDUCE THIS DISTANCE.
- (8) PROVIDE GRADE BREAK PERPENDICULAR TO DIRECTION OF WHEELCHAIR TRAVEL.
- (I) INSTALL TRANSITION NOSE. (INCIDENTAL TO OTHER PAY ITEMS). DO NOT MARK TRANSITION NOSE.

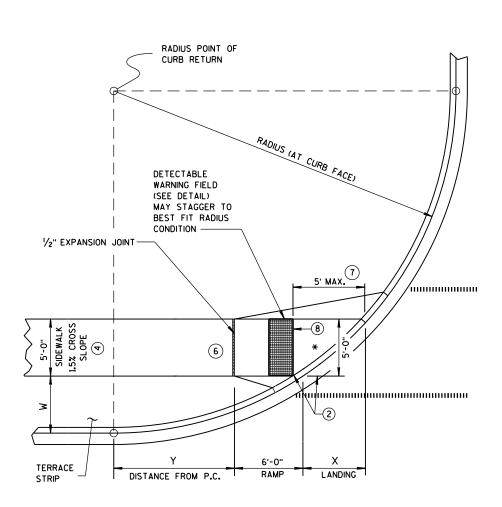


**CURB RAMP TYPE 4B1 PLAN VIEW** 

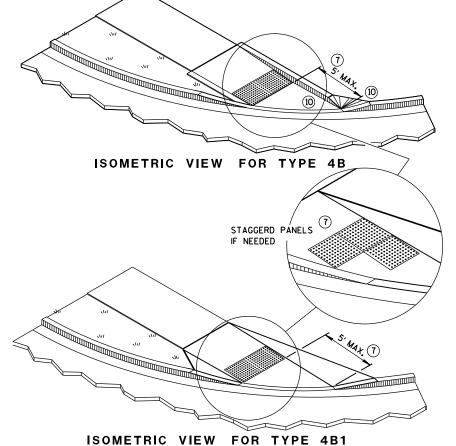

CURB RAMPS TYPE 4B AND 4B1

STATE OF WISCONSIN DEPARTMENT OF TRANSPORTATION

2 Ω  $\infty$ Ω

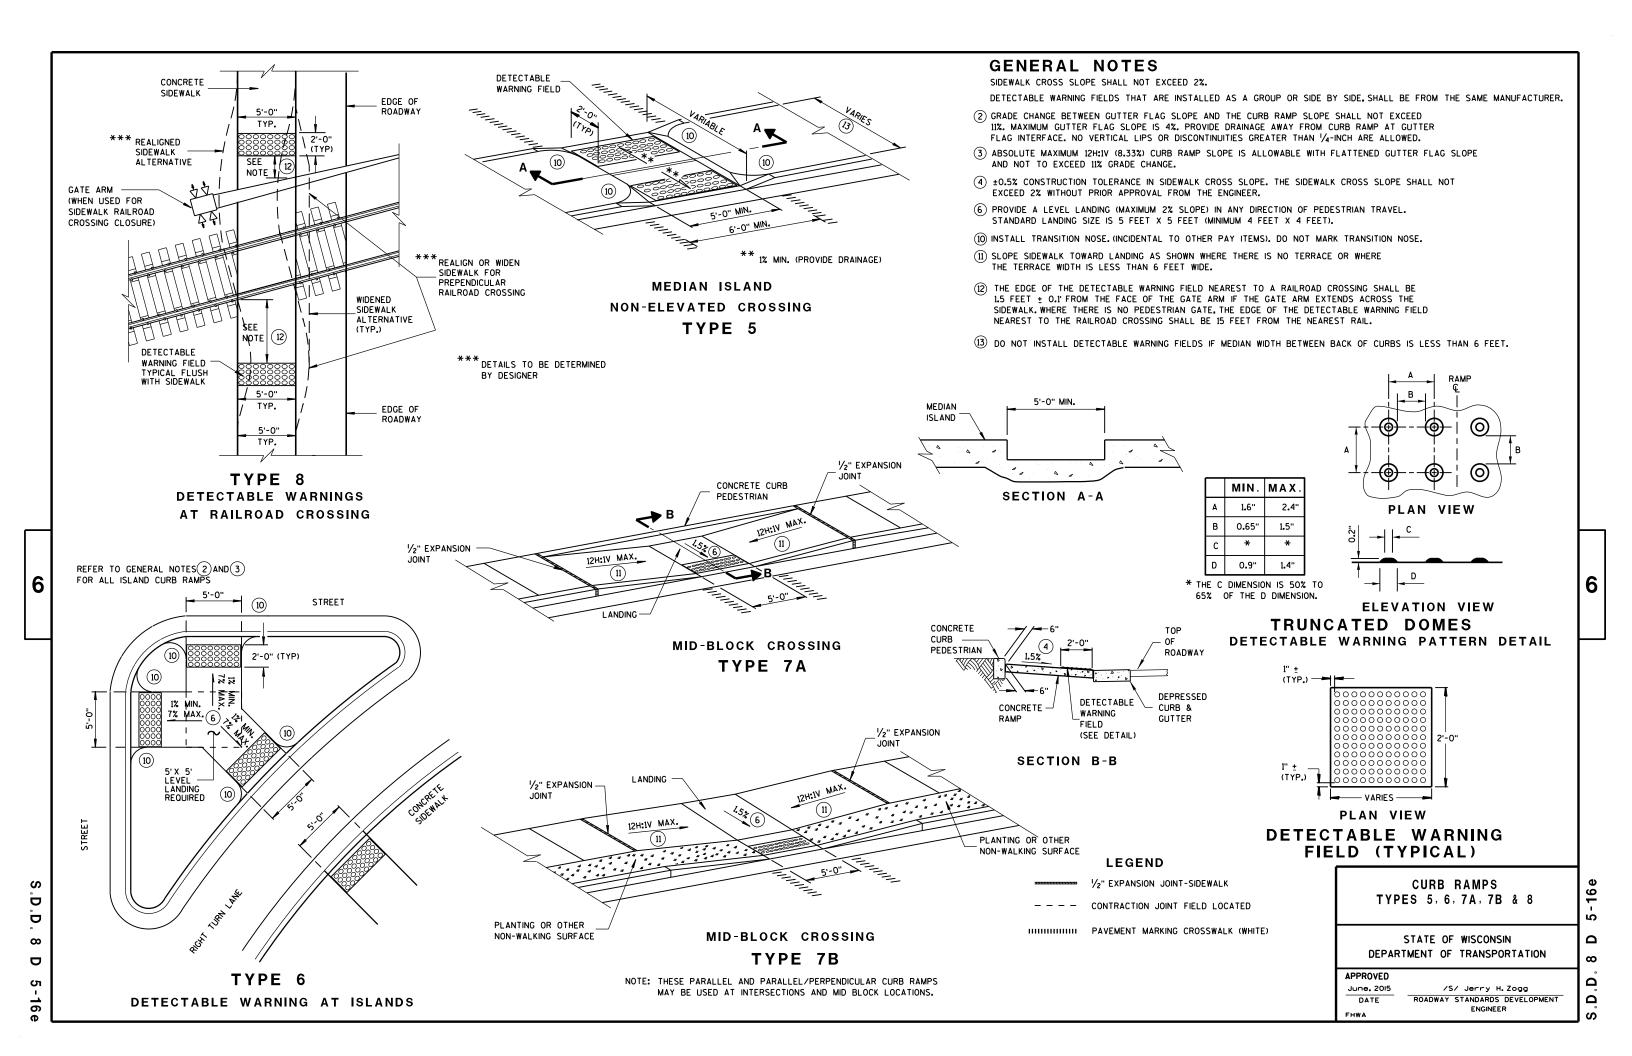





INLET PROTECTION, TYPE A

### **GENERAL NOTES**

INLET PROTECTION DEVICES SHALL BE MAINTAINED OR REPLACED AT THE DIRECTION OF THE ENGINEER.

MANUFACTURED ALTERNATIVES APPROVED AND LISTED ON THE DEPARTMENT'S EROSION CONTROL PRODUCT ACCEPTABILITY LIST MAY BE

WHEN REMOVING OR MAINTAINING INLET PROTECTION, CARE SHALL BE TAKEN SO THAT THE SEDIMENT TRAPPED ON THE GEOTEXTILE FABRIC DOES NOT FALL INTO THE INLET. ANY MATERIAL FALLING INTO THE INLET SHALL BE REMOVED IMMEDIATELY.

- 1) FINISHED SIZE, INCLUDING FLAP POCKETS WHERE REQUIRED, SHALL EXTEND A MINIMUM OF 10" AROUND THE PERIMETER TO FACILITATE MAINTENANCE OR REMOVAL.
- (2) FOR INLET PROTECTION, TYPE C (WITH CURB BOX), AN ADDITIONAL 18" OF FABRIC IS WRAPPED AROUND THE WOOD AND SECURED WITH STAPLES. THE WOOD SHALL NOT BLOCK THE ENTIRE HEIGHT OF THE CURB BOX OPENING.
- (3) FLAP POCKETS SHALL BE LARGE ENOUGH TO ACCEPT WOOD 2X4.



### INLET PROTECTION, TYPE C (WITH CURB BOX)

### **INSTALLATION NOTES**

### TYPE B & C

TRIM EXCESS FABRIC IN THE FLOW LINE TO WITHIN 3" OF THE GRATE.

THE CONTRACTOR SHALL DEMONSTRATE A METHOD OF MAINTENANCE, USING A SEWN FLAP, HAND HOLDS OR OTHER METHOD TO PREVENT ACCUMULATED SEDIMENT FROM ENTERING THE INLET.

#### TYPE D

DO NOT INSTALL INLET PROTECTION TYPE D IN INLETS SHALLOWER THAN 30", MEASURED FROM THE BOTTOM OF THE INLET TO THE TOP OF THE GRATE.

TRIM EXCESS FABRIC IN THE FLOW LINE TO WITHIN 3" OF THE GRATE.

THE INSTALLED BAG SHALL HAVE A MINIMUM SIDE CLEARANCE, BETWEEN THE INLET WALLS AND THE BAG, MEASURED AT THE BOTTOM OF THE OVERFLOW HOLES, OF 3". WHERE NECESSARY THE CONTRACTOR SHALL CINCH THE BAG, USING PLASTIC ZIP TIES, TO ACHIEVE THE 3" CLEARANCE, THE TIES SHALL BE PLACED AT A MAXIMUM OF 4" FROM THE BOTTOM OF THE BAG.

### INLET PROTECTION TYPE A, B, C, AND D

STATE OF WISCONSIN DEPARTMENT OF TRANSPORTATION

APPROVED


10/16/02

/S/ Beth Cannestra CHIEF ROADWAY DEVELOPMENT ENGINEER 6

0

ш


 $\infty$ 

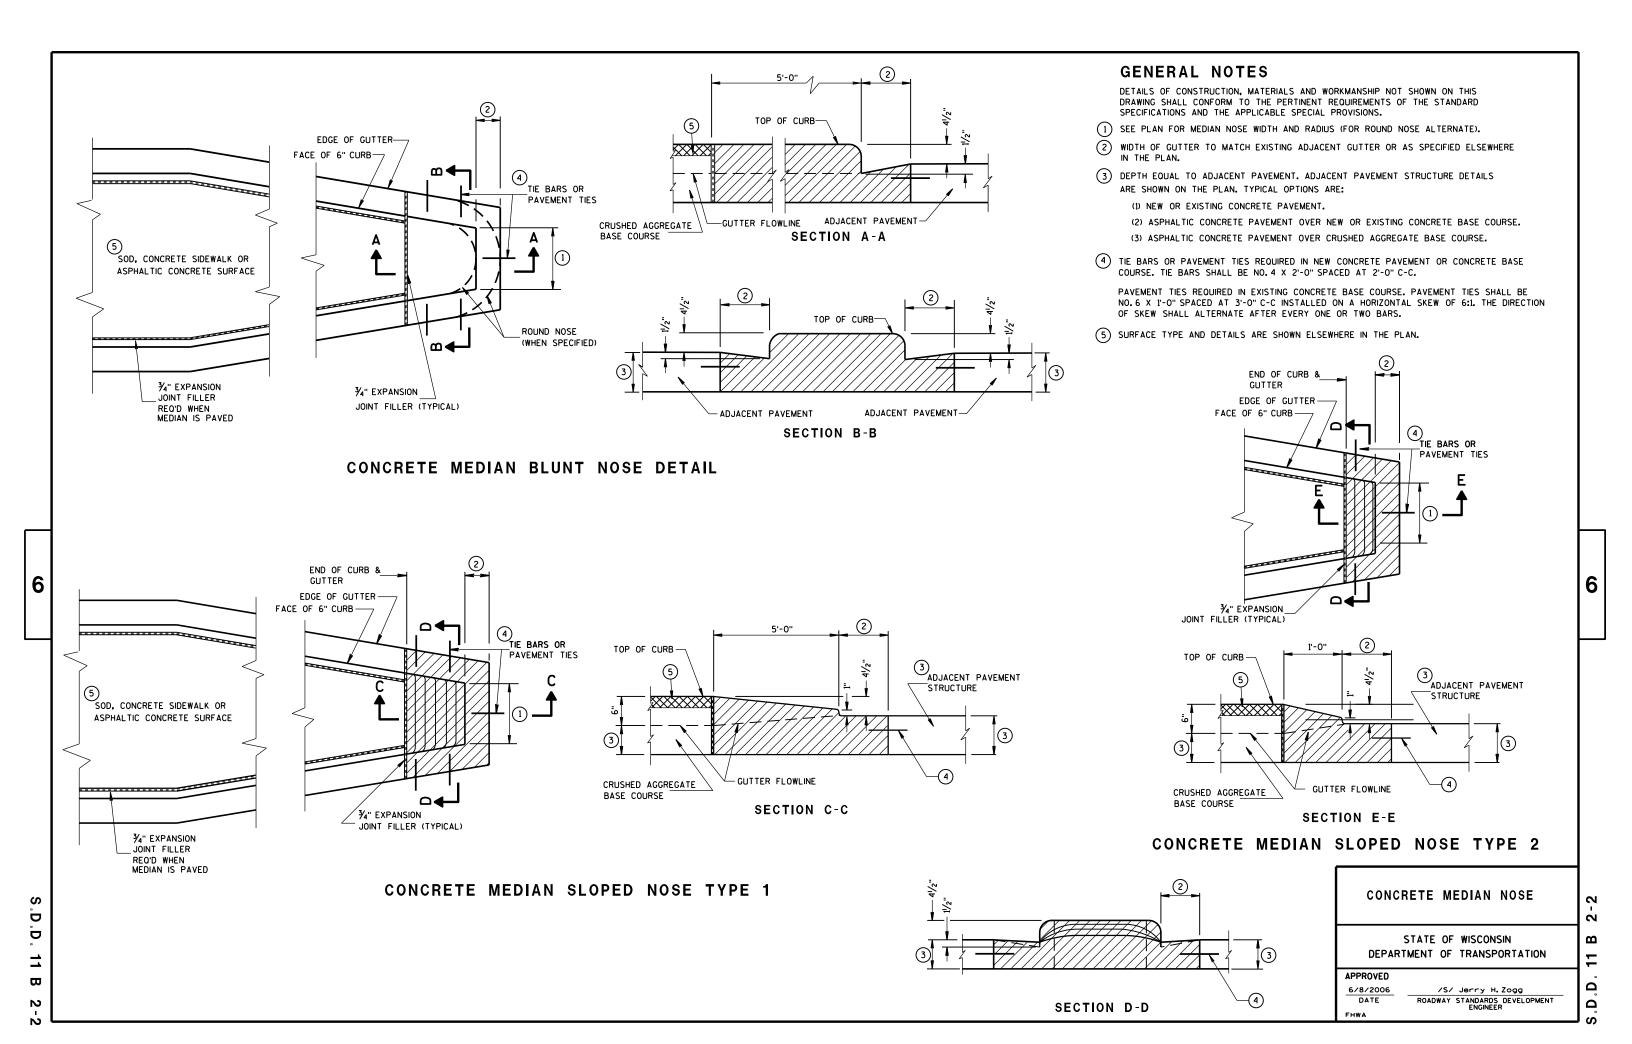


PROVIDE 6-FOOT MINIMUM DISTANCE FROM BOUNDARIES OF CONCRETE REPAIR AREAS TO ADJACENT TRANSVERSE JOINT OR CRACK.

THE LENGTH OF THE REPAIRS MAY VARY FROM THE DIMENSIONS SHOWN IF THE EXISTING CONCRETE PAVEMENT IS NONDOWELED AND THE PAVEMENT IS TO BE OVERLAID AFTER REPAIRING.

1 DOWEL BARS MIGHT NOT EXIST.

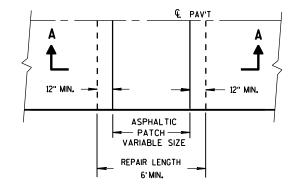


**PLAN VIEW** 

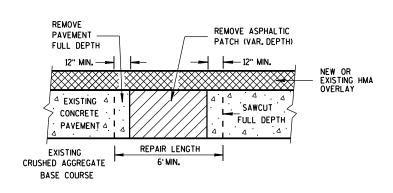


SECTION A-A

HMA PATCH REMOVAL

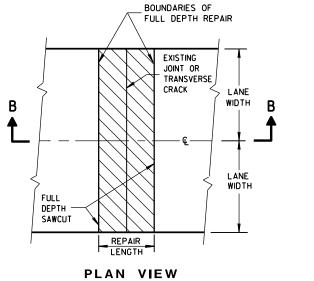


PLAN VIEW (DOUBLE LANE REPAIR)

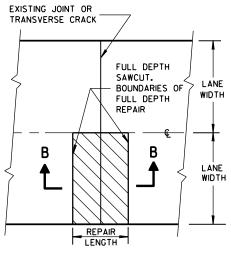

PLAN VIEW (SINGLE LANE REPAIR)

### FULL DEPTH CONCRETE PAVEMENT REMOVAL

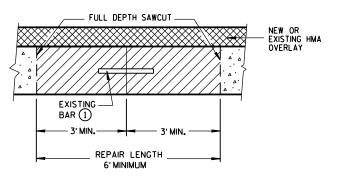

SECTION B-B


### **CONCRETE REMOVAL**

BASE PATCHING CONCRETE

STATE OF WISCONSIN
DEPARTMENT OF TRANSPORTATION

6


14-6a

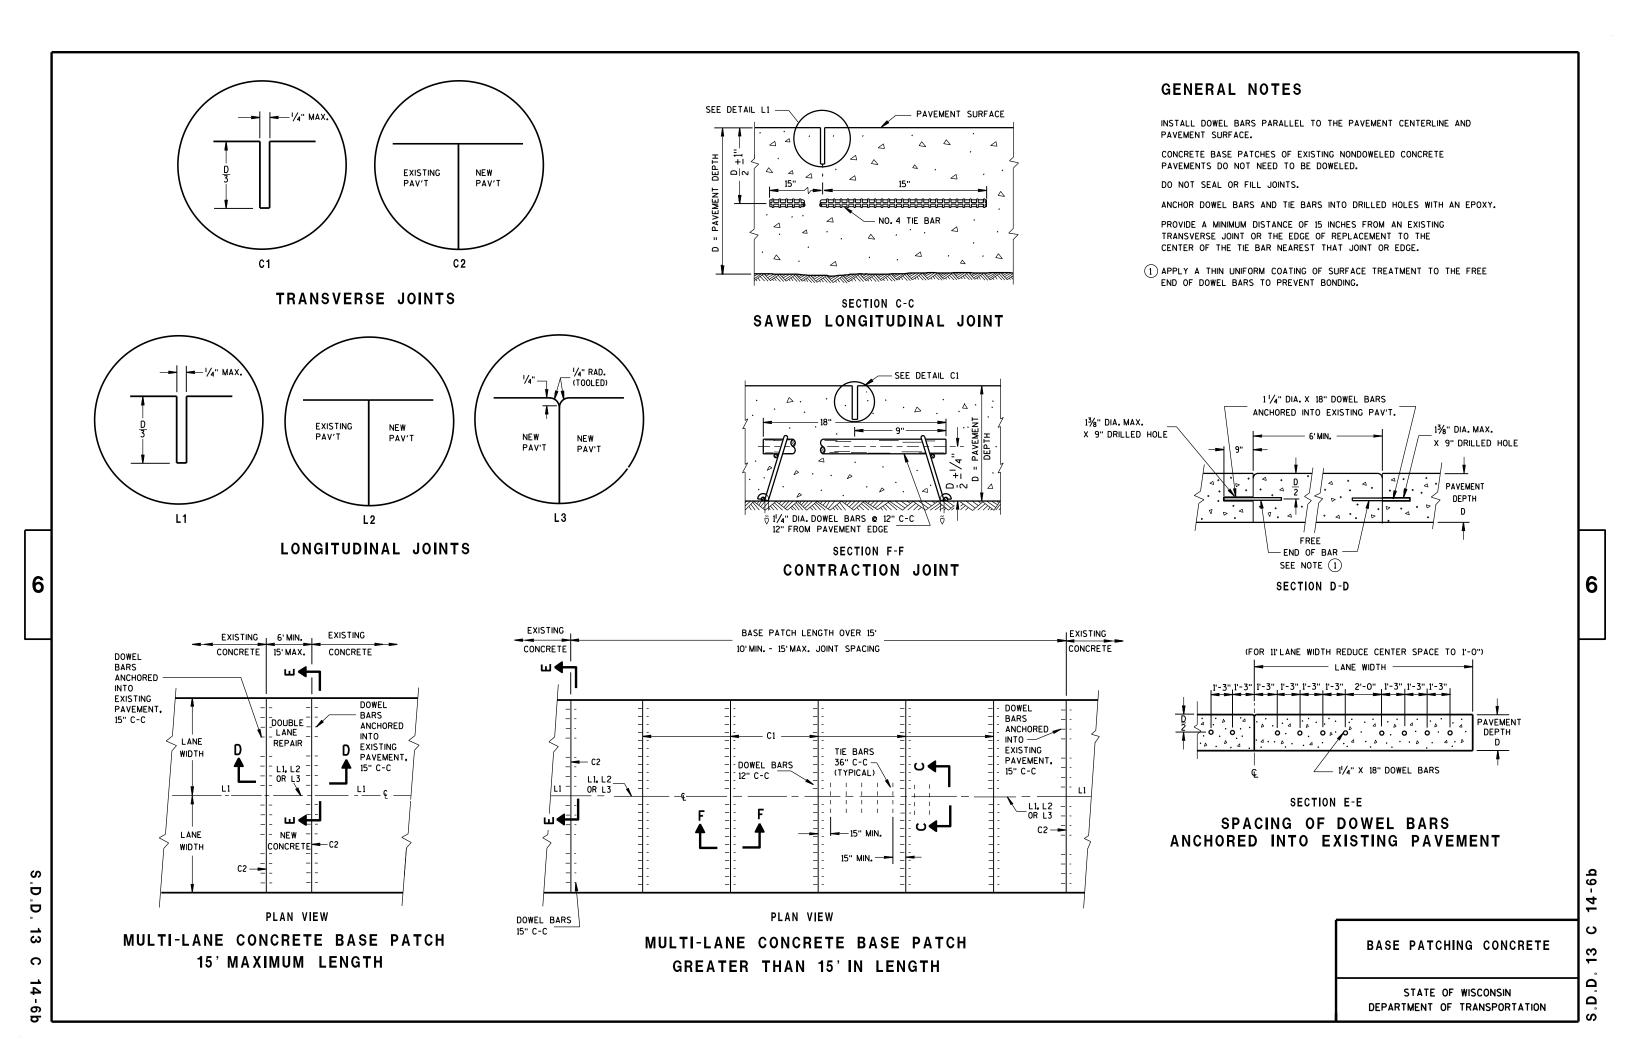

INTO EXISTING PAVEMENT

### GENERAL NOTES

- (1) USE AN ENGINEER-APPROVED BOND BREAKER (E.G. RELEASE AGENT, CURING COMPOUND) FOR SINGLE LANE BASE PATCHES UP TO 15 FEET IN LENGTH.
- (2) WITH THE APPROVAL OF THE ENGINEER, FOR SINGLE LANE PAVEMENT REPLACEMENTS LESS THAN 30 FEET IN LENGTH, DRILLED TIE BARS MAY BE INSTALLED ON 6:1 SKEW HORIZONTALLY, DIRECTION OF SKEW ALTERNATING WITH EACH SUCCESSIVE BAR. DRIVE SKEWED TIE BARS TO A DEPTH OF 6 INCHES IN A HOLE OF SUCH A DIAMETER AS TO PROVIDE A TIGHT DRIVEN FIT.
- 3 ANCHOR TIE BARS INTO DRILLED HOLES WITH AN EPOXY.

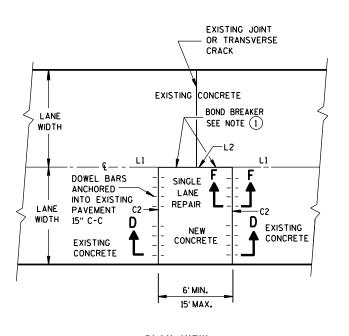

6


Ġ

D

13

C

PLAN VIEW
SINGLE LANE CONCRETE BASE PATCH
15' MAXIMUM LENGTH

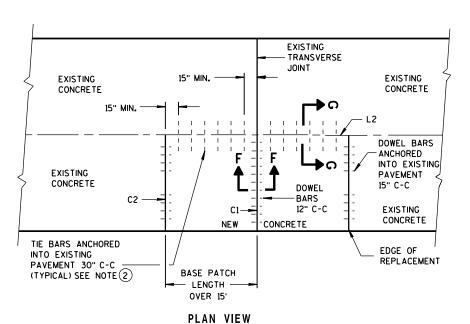

ELE LANE CONCRETE

SINGLE LANE CONCRETE BASE PATCH GREATER THAN 15' IN LENGTH

BASE PATCHING CONCRETE

STATE OF WISCONSIN
DEPARTMENT OF TRANSPORTATION

APPROVED

Sept., 2015
DATE

/S/ Peter Kemp, P.E.
PAVEMENT SUPERVISOR
FHWA

3.D.D. 13

4



### ROAD CLOSURE BARRICADE DETAIL

APPROACH VIEW



### DETAIL E LANE CLOSURE BARRICADE DETAIL APPROACH VIEW

SEE SDD 15C2-SHEET "a" FOR LEGEND

### **GENERAL NOTES**

THE EXACT NUMBER, LOCATION, AND SPACING OF ALL SIGNS AND BARRICADES SHALL BE ADJUSTED TO FIT FIELD CONDITIONS AS APPROVED BY THE ENGINEER.

ANY SIGNS TEMPORARY OR EXISTING, WHICH CONFLICT WITH TRAFFIC CONTROL "IN USE" SHALL BE REMOVED OR COVERED AS NEEDED AND AS APPROVED BY THE ENGINEER.

THE SPACING BETWEEN TRAFFIC CONTROL SIGNS SHOULD BE ADJUSTED TO NOT CONFLICT WITH AND SHOULD PROVIDE A DESIRABLE MINIMUM OF 200 FEET CLEARANCE TO EXISTING SIGNS THAT WILL REMAIN IN PLACE.

BARRICADES THAT MUST BE MOVED FOR A WORK OPERATION SHALL BE IMMEDIATELY RE-ESTABLISHED UPON COMPLETION OF THE OPERATION OR, FOR CONTINUING OPERATIONS, AT THE END OF EACH WORKING DAY.

SIGNS THAT WILL BE IN PLACE LESS THAN 7 CONTINUOUS DAYS AND NIGHTS MAY BE MOUNTED ON PORTABLE SUPPORTS.

ALL TYPE III BARRICADES SHALL HAVE RAILS REFLECTORIZED ON BOTH FACES. STRIPES SHALL BE PROPERLY SLOPED DOWN TOWARD THE TRAFFIC SIDE OR AS SHOWN IN THE ROAD CLOSURE BARRICADE DETAIL D FOR FULL ROAD CLOSURES.

TYPE "A" LOW-INTENSITY FLASHING WARNING LIGHTS SHALL BE VISIBLE ON BOTH SIDES OF THE

THE R11-2, R11-3, M4-9, R11-4 AND R10-61 SIGNS PLACED ON BARRICADES SHALL COVER NO MORE THAN THE TOP RAIL. THE SIGNS SHALL NOT COVER ANY PORTION OF THE MIDDLE OR BOTTOM RAILS.

"WO AND "MO" SIGNS ARE THE SAME AS "W" AND "M" SIGNS EXCEPT THE BACKGROUND IS ORANGE.

ALL SIGNS SHALL BE 48" X 48" UNLESS OTHERWISE NOTED BELOW:

R11-2 SHALL BE 48" X 30". R11-3, R11-4 AND R10-61 SHALL BE 60" X 30". M4-9 SHALL BE 30" X 24". M3-X SHALL BE 24" X 12". (36" X 18" IF NEEDED TO MATCH EXISTING SIGNS.) M4-8 SHALL BE 24" X 12". (30" X 15" IF NEEDED TO MATCH EXISTING SIGNS.) M1-4, M1-5A, AND M1-6 SHALL BE 24" X 24". (36" X 36" IF NEEDED TO MATCH EXISTING SIGNS.) MO5-1 AND MO6-1 SHALL BE 21" X 21". (30" X 30" IF NEEDED TO MATCH EXISTING SIGNS.) D1-X SHALL BE AS SHOWN ON SPECIFIC PROJECT SIGNING DETAIL SHEETS. R1-1 SHALL BE 36" X 36".

- (1) TWO WARNING LIGHTS SHALL BE PROVIDED ON THE CENTER BARRICADE AND A MINIMUM OF ONE WARNING LIGHT SHALL BE PROVIDED ON EACH OF THE OTHER BARRICADES WITHIN THE ROADWAY LIMITS. SPACING OF THE WARNING LIGHTS SHALL BE UNIFORM TO THE EDGE OF ROADWAY AS SHOWN (APPROX. 8-FOOT
- THESE SIGNS AND BARRICADES ARE NOT REQUIRED IF ROAD CLOSURE BEGINS AT INTERSECTION.
- FOR ROAD CLOSURE WITHOUT LOCAL ACCESS TO PROJECT, SEE ROAD CLOSURE BARRICADE DETAIL D.
- FOR ROAD CLOSURE WITH LOCAL ACCESS TO PROJECT, SEE LANE CLOSURE BARRICADE DETAIL E.
- FOR BRIDGE OR CULVERT REPLACEMENTS, SUBSTITUTE "BRIDGE OUT" INSTEAD OF "ROAD CLOSED" ON R11-2 AND R11-3 SIGNS.
- INSTALL DETOUR AND COMMUNITY GUIDE SIGNS AND ARROWS ONLY IF SPECIFIED IN THE CONTRACT. IF THERE ARE EXISTING ROUTE MARKER ASSEMBLIES THAT WILL REMAIN IN PLACE, ADJUST THE LOCATION OF THE DETOUR ROUTE SIGNS TO CORRESPOND WITH THE EXISTING ASSEMBLIES. MODIFY EXISTING SIGNS WHERE POSSIBLE. SEE SPECIFIC PROJECT DETOUR SIGNING DETAIL SHEETS. IF DETOUR SIGNS ARE BEING INSTALLED BY OTHERS. PLACE THE CONTRACTED TRAFFIC CONTROL SIGNS TO ALLOW FOR PLACEMENT OF ALL WARNING, DETOUR AND GUIDE SIGNS AS SHOWN.
- "EAST" CARDINAL DIRECTION MARKERS AND RIGHT TURN ARROWS ARE SHOWN. USE OTHER CARDINAL DIRECTIONS AND ARROWS AS APPROPRIATE.

### BARRICADES AND SIGNS FOR MAINLINE CLOSURES

2


2

Ω

STATE OF WISCONSIN DEPARTMENT OF TRANSPORTATION

/S/ Peter Amakobe Atepe

STATEWIDE WORK ZONE TRAFFIC SAFETY ENGINEER

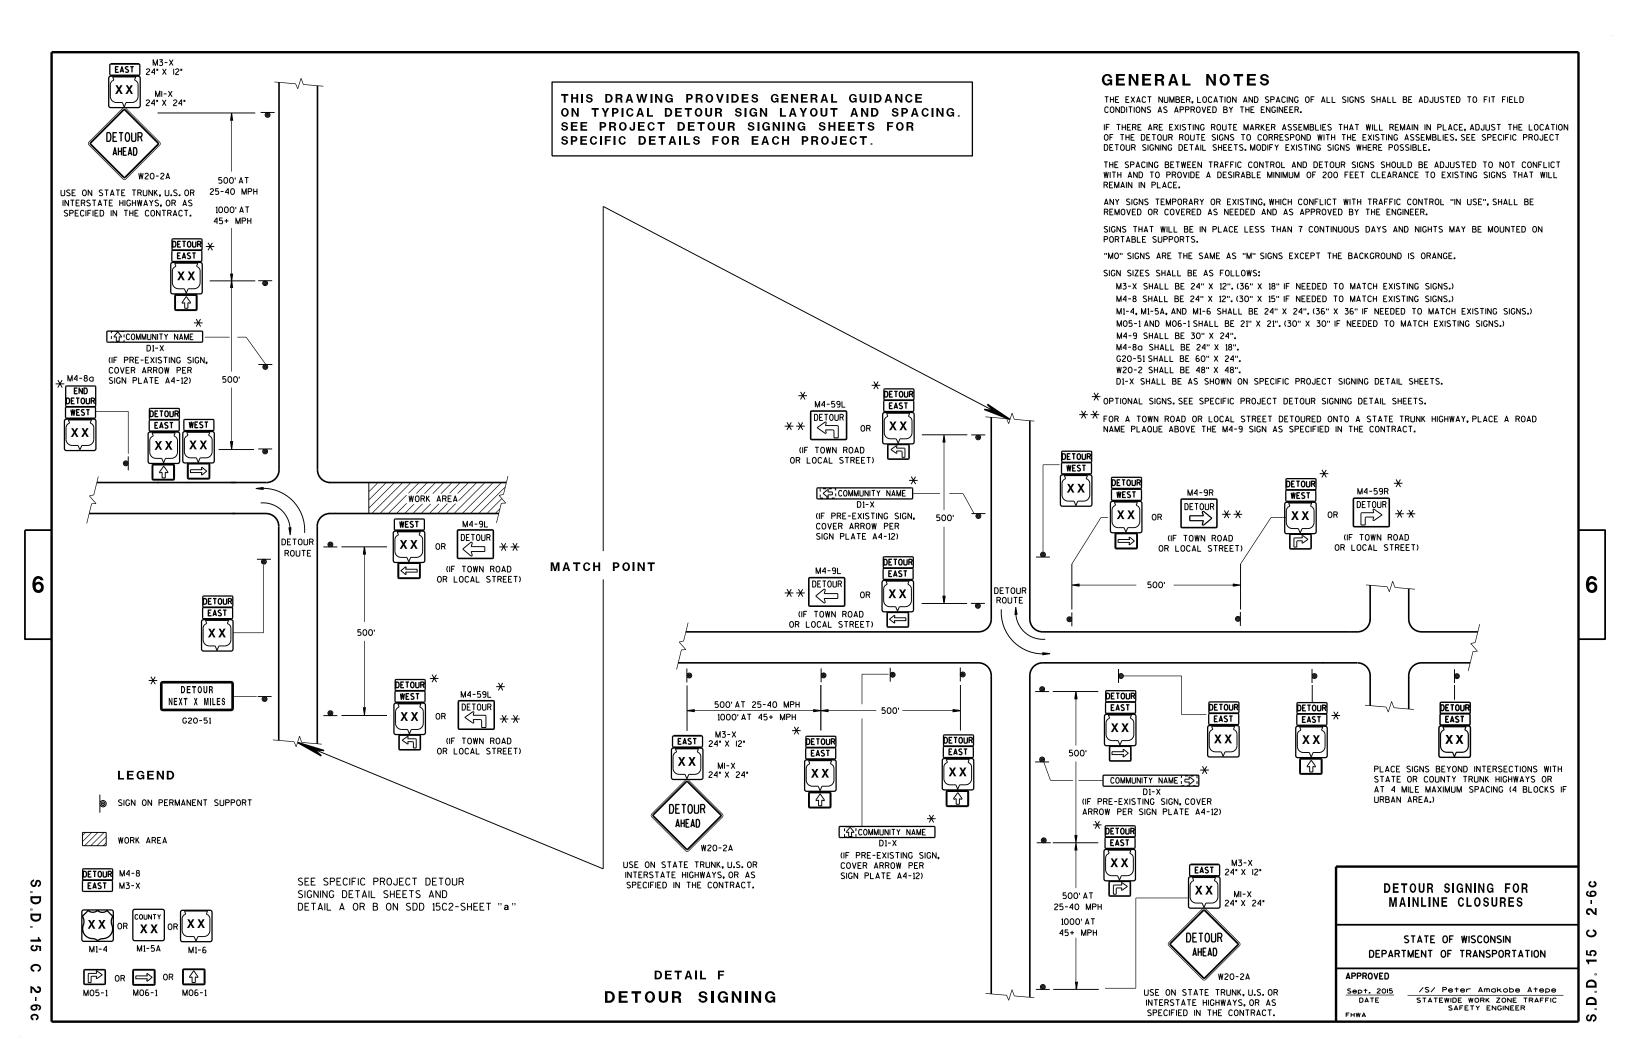

### **GENERAL NOTES**

6

S

D

D

15

C

THE EXACT NUMBER, LOCATION, AND SPACING OF ALL SIGNS AND DEVICES SHALL BE ADJUSTED TO FIT FIELD CONDITIONS.


THE SPACING BETWEEN TRAFFIC CONTROL SIGNS SHOULD BE ADJUSTED TO NOT CONFLICT WITH AND SHOULD PROVIDE A DESIRABLE MINIMUM OF 200 FEET CLEARANCE TO EXISTING SIGNS THAT WILL REMAIN IN PLACE.

ALL SIGNS ARE 48"×48" UNLESS OTHERWISE NOTED. IF NECESSARY DUE TO SPACE CONSTRAINTS, 36"×36" SIGNS MAY BE USED INSTEAD OF 48"×48" SIGNS.

SIGNS THAT WILL BE IN PLACE LESS THAN 7 CONTINUOUS DAYS AND NIGHTS MAY BE MOUNTED ON PORTABLE SUPPORTS.


IF A "STOP" SIGN MUST BE REMOVED FOR A WORK OPERATION, A TEMPORARY "STOP" SIGN SHALL BE PLACED PRIOR TO THE SIGN REMOVAL, OR A FLAGGER SHALL BE PROVIDED UNTIL THE SIGN IS RE-ESTABLISHED.

★ THE THIRD W20-1 SIGN IS REQUIRED ONLY IF THERE IS AN INTERSECTION BETWEEN THE "ROAD WORK 500 FT" SIGN AND THE WORK ZONE. ADJUST THE PLACEMENT OF THIS SIGN BASED ON INTERSECTION LOCATION AND OTHER FIELD CONDITIONS.

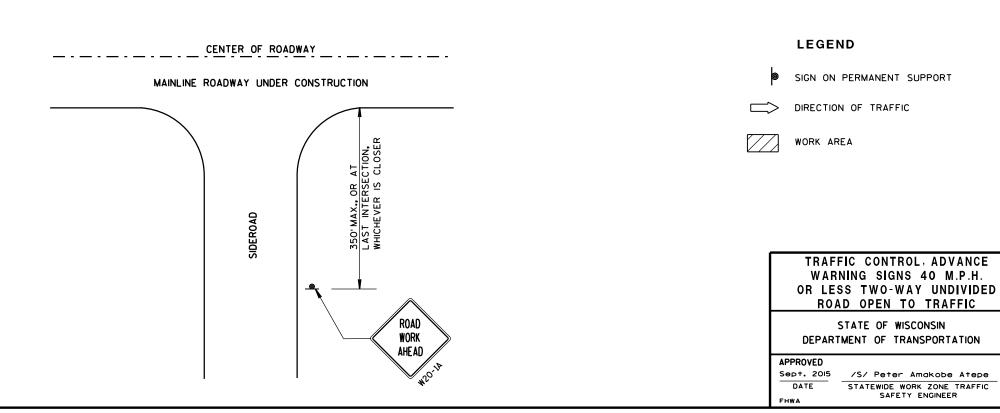



6


5-

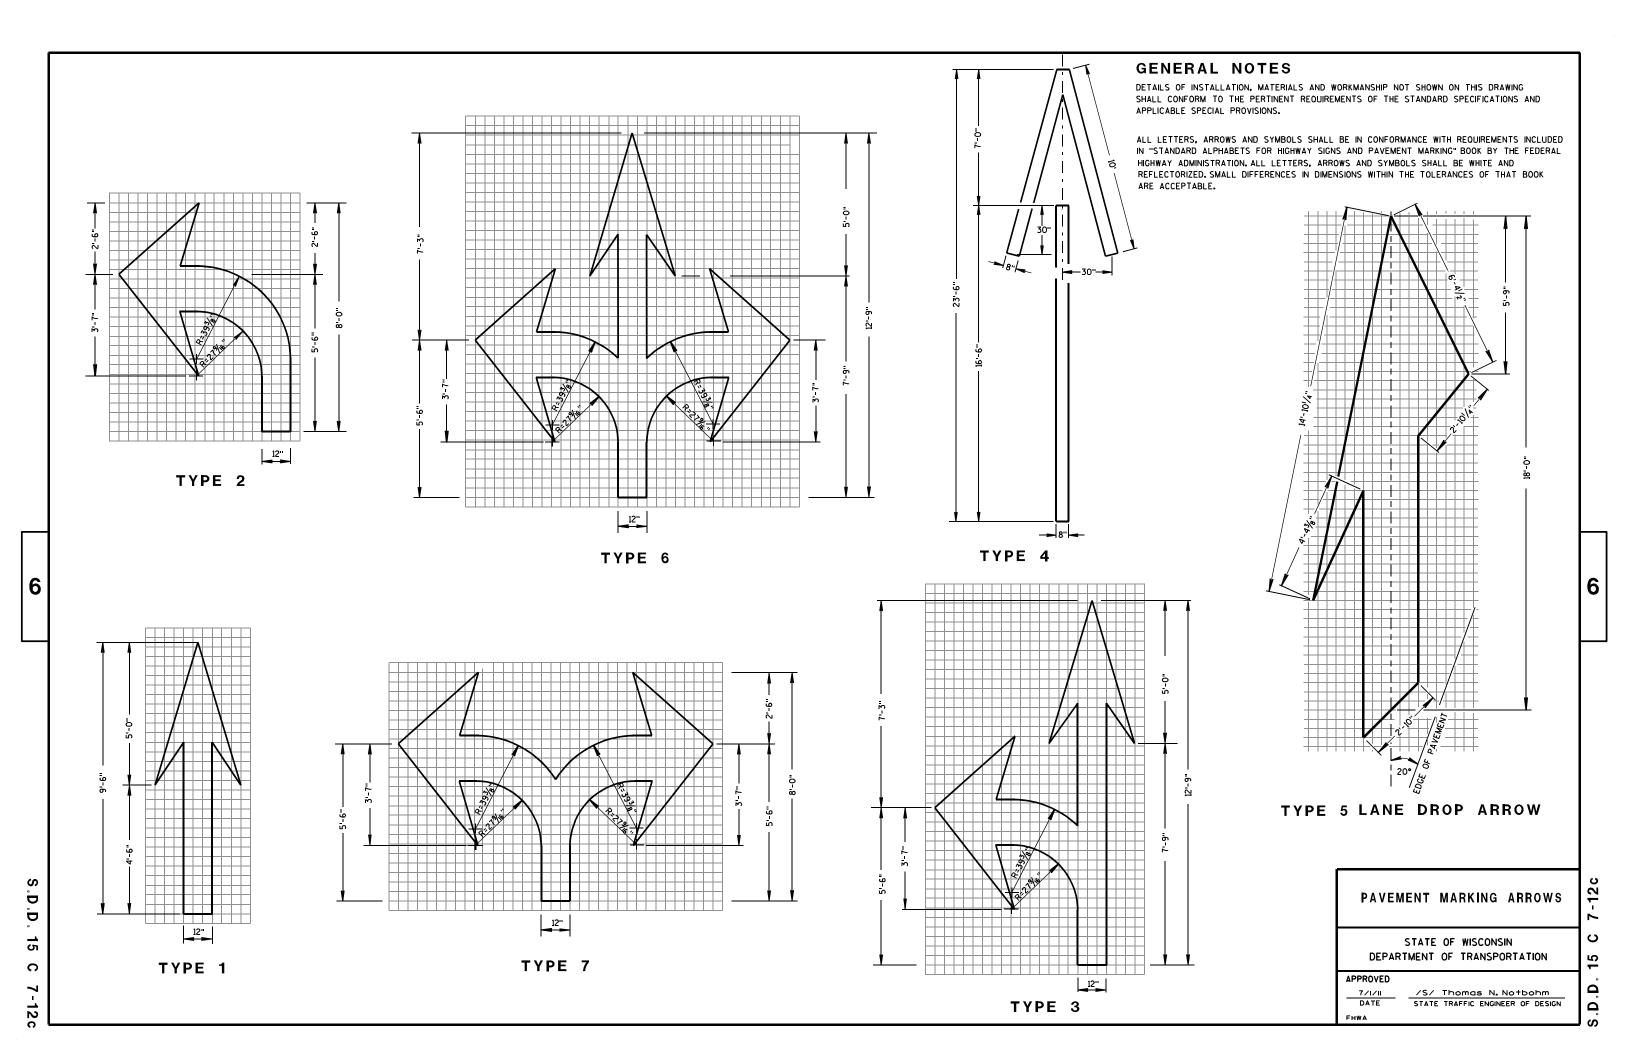




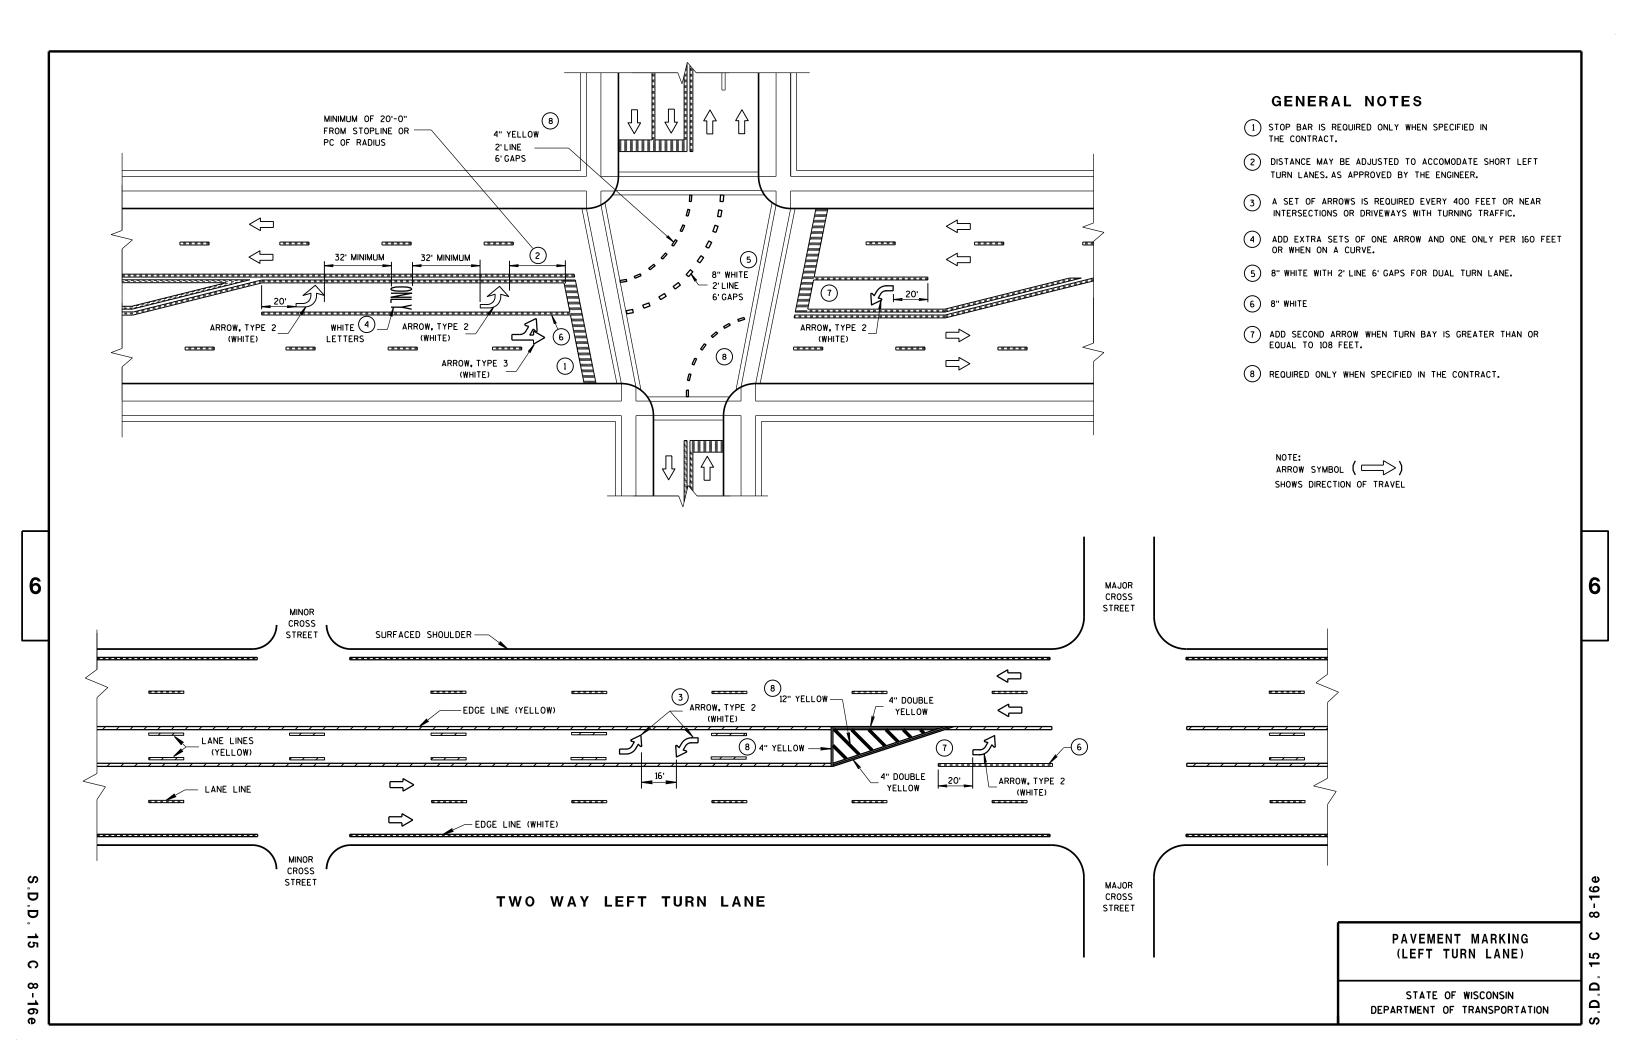


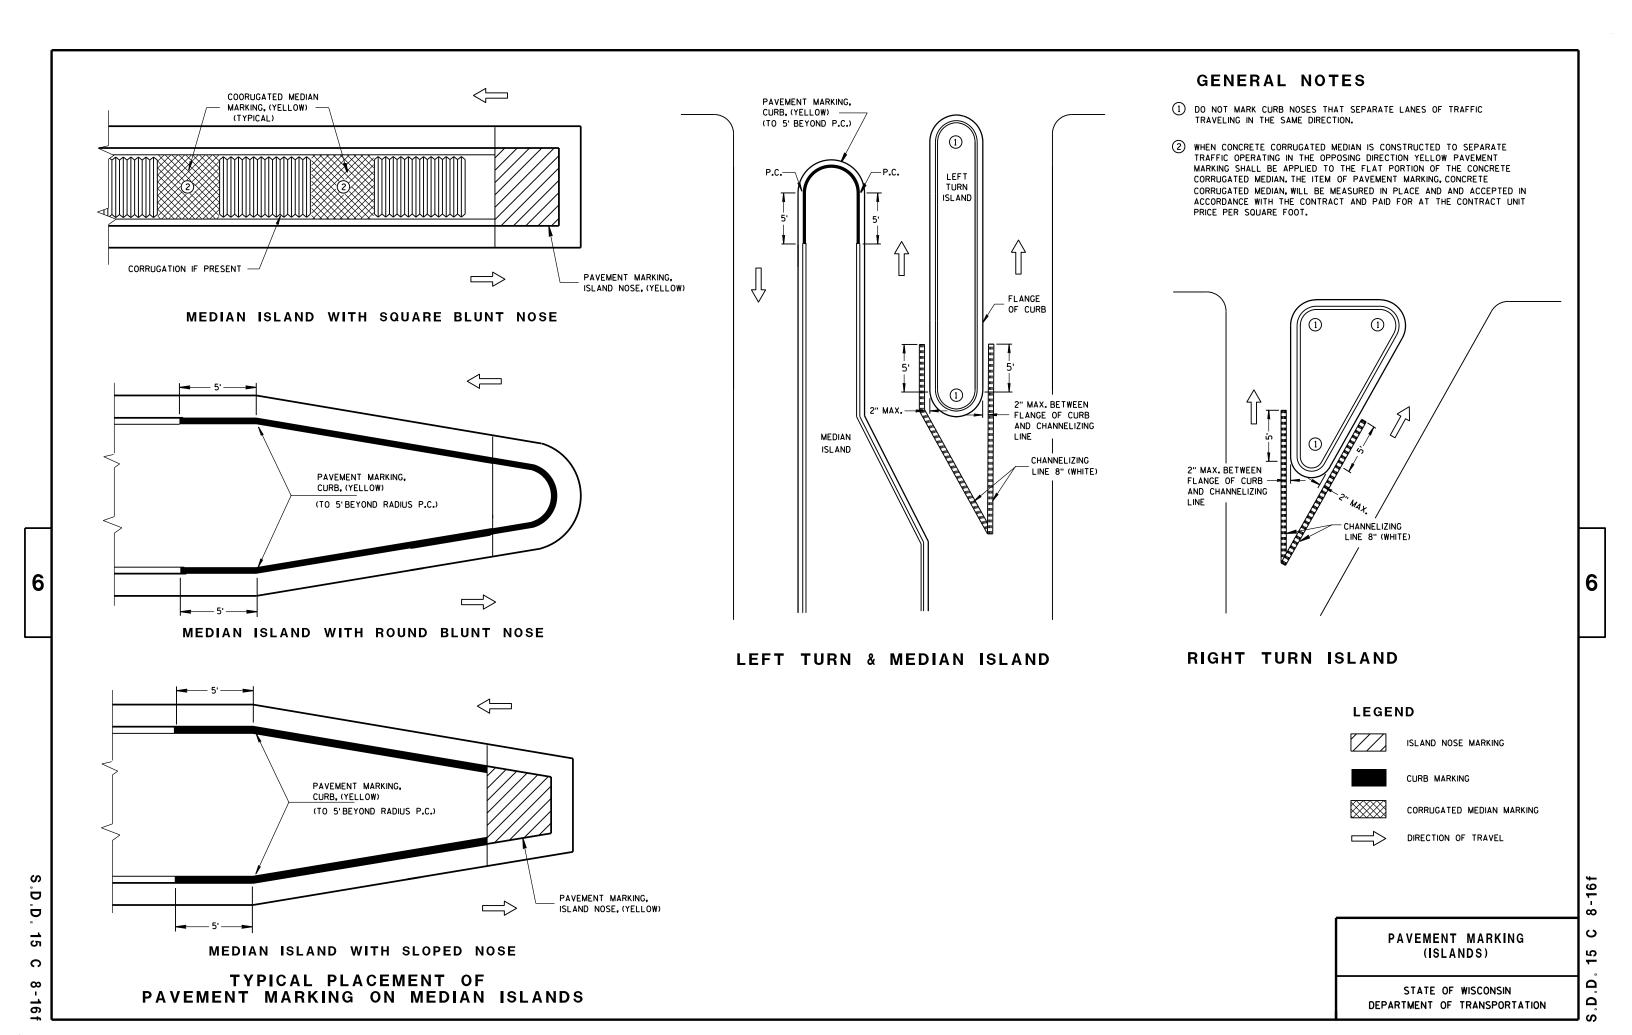

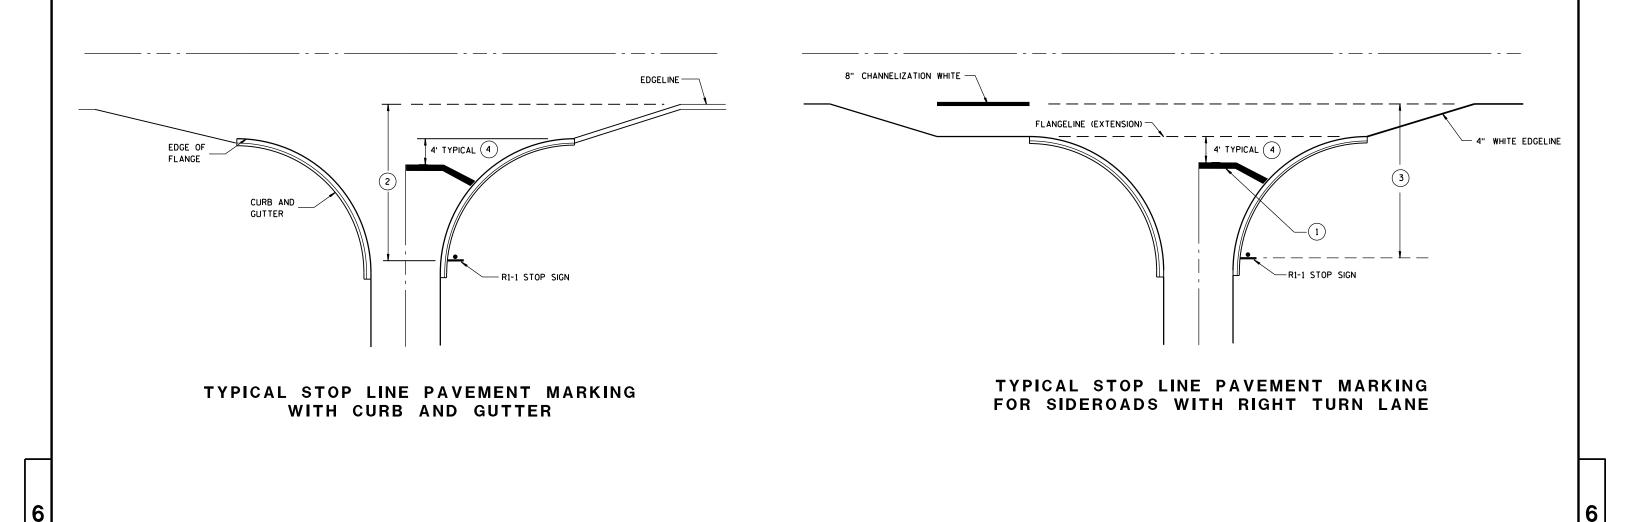

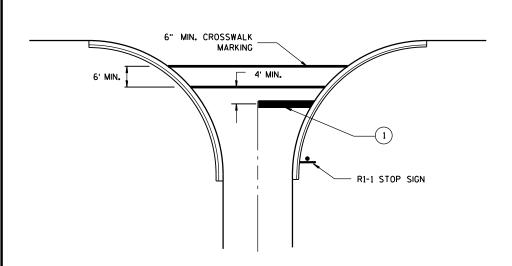

TYPICAL STOP LINE PAVEMENT MARKING FOR SIDEROADS WITH CROSSWALK MARKING

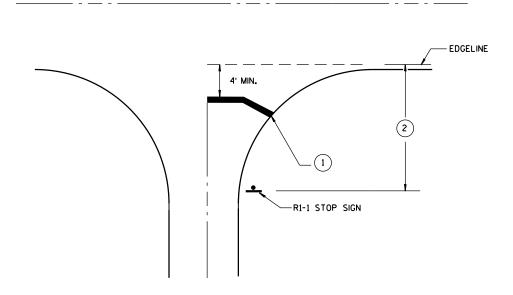

TYPICAL STOP LINE PAVEMENT MARKING WITHOUT CURB AND GUTTER

### GENERAL NOTES

- 1 18-INCH STOP LINES MAY BE DELETED OR ADDED BY THE PROJECT ENGINEER BASED ON VISIBILITY AND SIGHT LINES.
- 2 IF STOP SIGN IS LESS THAN OR EQUAL TO 40 FEET FROM THE EDGELINE THAN NO STOP LINE IS REQUIRED.
- (3) IF STOP SIGN IS LESS THAN OR EQUAL TO 30 FEET FROM THE FLANGELINE EXTENSION THAN NO STOP LINE IS REQUIRED.
- MOVE CLOSER TO EDGE OF TRAVEL LANE AS NEEDED FOR VISIBILITY AND SIGHT LINES.

### STOP LINE AND CROSSWALK PAVEMENT MARKING


STATE OF WISCONSIN DEPARTMENT OF TRANSPORTATION

APPROVED	
4/30/2013	/S/ Travis Feltes
DATE	STATE TRAFFIC ENGINEER
FHWA	

.D.D. 15 C 33-1

S.D.D.



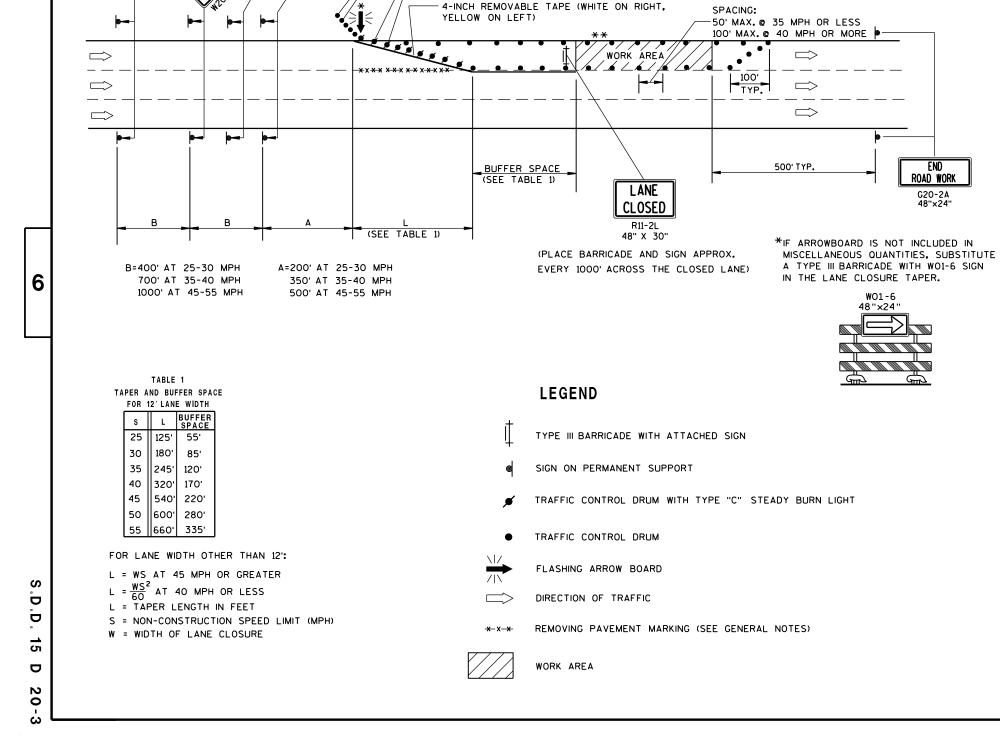

(5) DRUMS SPACED @ 10'

INTERVALS AS NEEDED IN

FRONT OF ARROW BOARD

25'@ 35 MPH OR LESS

50'@ 40 MPH OR MORE

TEMPORARY PAVEMENT MARKING.

SPACING:

ROAD WORK

NEXT\_\_\_MILES

G20-1

60" X 24"

CLOSED

AHEAD

AHEAD

### **GENERAL NOTES**

\*\*THE LINE OF DRUMS SHOWN ALONG THE MEDIAN/CENTERLINE

ADJACENT TO THE WORK AREA. FOR THIS CONDITION INSTALL

W20-1 "ROAD WORK AHEAD" SIGN FOR OPPOSING DIRECTION OF

IS REQUIRED ONLY WHERE THERE IS OPPOSING TRAFFIC

TRAFFIC, IN ADVANCE OF THE WORK AREA.

THIS LANE CLOSURE DETAIL IS TYPICAL FOR CLOSING THE LEFT LANE. FOR A RIGHT LANE CLOSURE, REVERSE THE TRAFFIC CONTROL.

THIS DETAIL MAY BE USED FOR ROADWAYS WITH EITHER TWO OR THREE LANES IN EACH DIRECTION.

THE EXACT NUMBER, LOCATION, AND SPACING OF ALL SIGNS AND DEVICES SHALL BE ADJUSTED TO FIT FIELD CONDITIONS AS APPROVED BY THE ENGINEER.

THE SPACING BETWEEN TRAFFIC CONTROL SIGNS SHOULD BE ADJUSTED TO NOT CONFLICT WITH AND SHOULD PROVIDE A DESIRABLE MINIMUM OF 200 FEET CLEARANCE TO EXISTING SIGNS THAT WILL REMAIN IN PLACE.

ALL SIGNS ARE 48"×48" UNLESS OTHERWISE NOTED. IF NECESSARY DUE TO SPACE CONSTRAINTS IN URBAN AREAS, 36" X 36" SIGNS MAY BE USED IF APPROVED BY DISTRICT TRAFFIC UNIT.

"WO" SIGNS ARE THE SAME AS "W" SIGNS EXCEPT THE BACKGROUND IS ORANGE.

SIGNS THAT WILL BE IN PLACE LESS THAN 7 CONTINUOUS DAYS AND NIGHTS, OR THAT WILL BE PLACED IN A CLOSED LANE, MAY BE MOUNTED ON PORTABLE SUPPORTS.

ANY SIGNS TEMPORARY OR EXISTING, WHICH CONFLICT WITH TRAFFIC CONTROL "IN USE" SHALL BE REMOVED OR COVERED AS NEEDED AND AS APPROVED BY THE ENGINEER.

REMOVE PAVEMENT MARKINGS AND PLACE TEMPORARY PAVEMENT MARKING, REMOVABLE TAPE IF LANE CLOSURE IS TO BE IN PLACE FOR 4 OR MORE CONTINUOUS DAYS AND NIGHTS.

ON UNDIVIDED ROADWAYS, OMIT THE SIGNS SHOWN ON LEFT SIDE OF ROAD.

W2O-1, G2O-1 AND G2O-2A SIGNS ARE NOT REQUIRED IF THE LANE CLOSURE IS WITHIN A LARGER WORK ZONE WHERE THESE SIGNS ARE ALREADY PRESENT.

OMIT G20-1 SIGNS IF LENGTH OF WORK AREA IS 2 MILES OR LESS.

CONSIDER GEOMETRICS WHEN LOCATING SIGNS AND ARROWBOARDS SO THE APPROACHING DRIVER HAS A CLEAR VIEW OF THE ARROWBOARDS AND LANE CLOSURE DRUMS.

PLACE THE ARROWBOARD AS CLOSE AS POSSIBLE TO THE BEGINNING OF THE LANE CLOSURE TAPER, PREFERABLY ON THE SHOULDER OR TERRACE.

CHANNELIZING DEVICES PLACED ADJACENT TO WORK AREA SHALL BE PULLED BACK FROM THE TRAVEL LANE WHEN WORK IS NOT IN PROGRESS.

BARRICADES IN A CLOSED LANE THAT MUST BE MOVED FOR A WORK OPERATION SHALL BE IMMEDIATELY RE-ESTABLISHED UPON COMPLETION OF THE OPERATION OR, FOR CONTINUING OPERATIONS, AT THE END OF EACH WORKING DAY.


WARNING LIGHTS ARE NOT REQUIRED IF THE LANE CLOSURE IS A DAYTIME ONLY OPERATION.


TRAFFIC CONTROL, SINGLE LANE CLOSURE, NON-FREEWAY/EXPRESSWAY

STATE OF WISCONSIN
DEPARTMENT OF TRANSPORTATION

APPROVED
Feb. 2015
DATE
STATE TRAFFIC ENGINEER OF DESIGN

S.D.D. 15 D 2

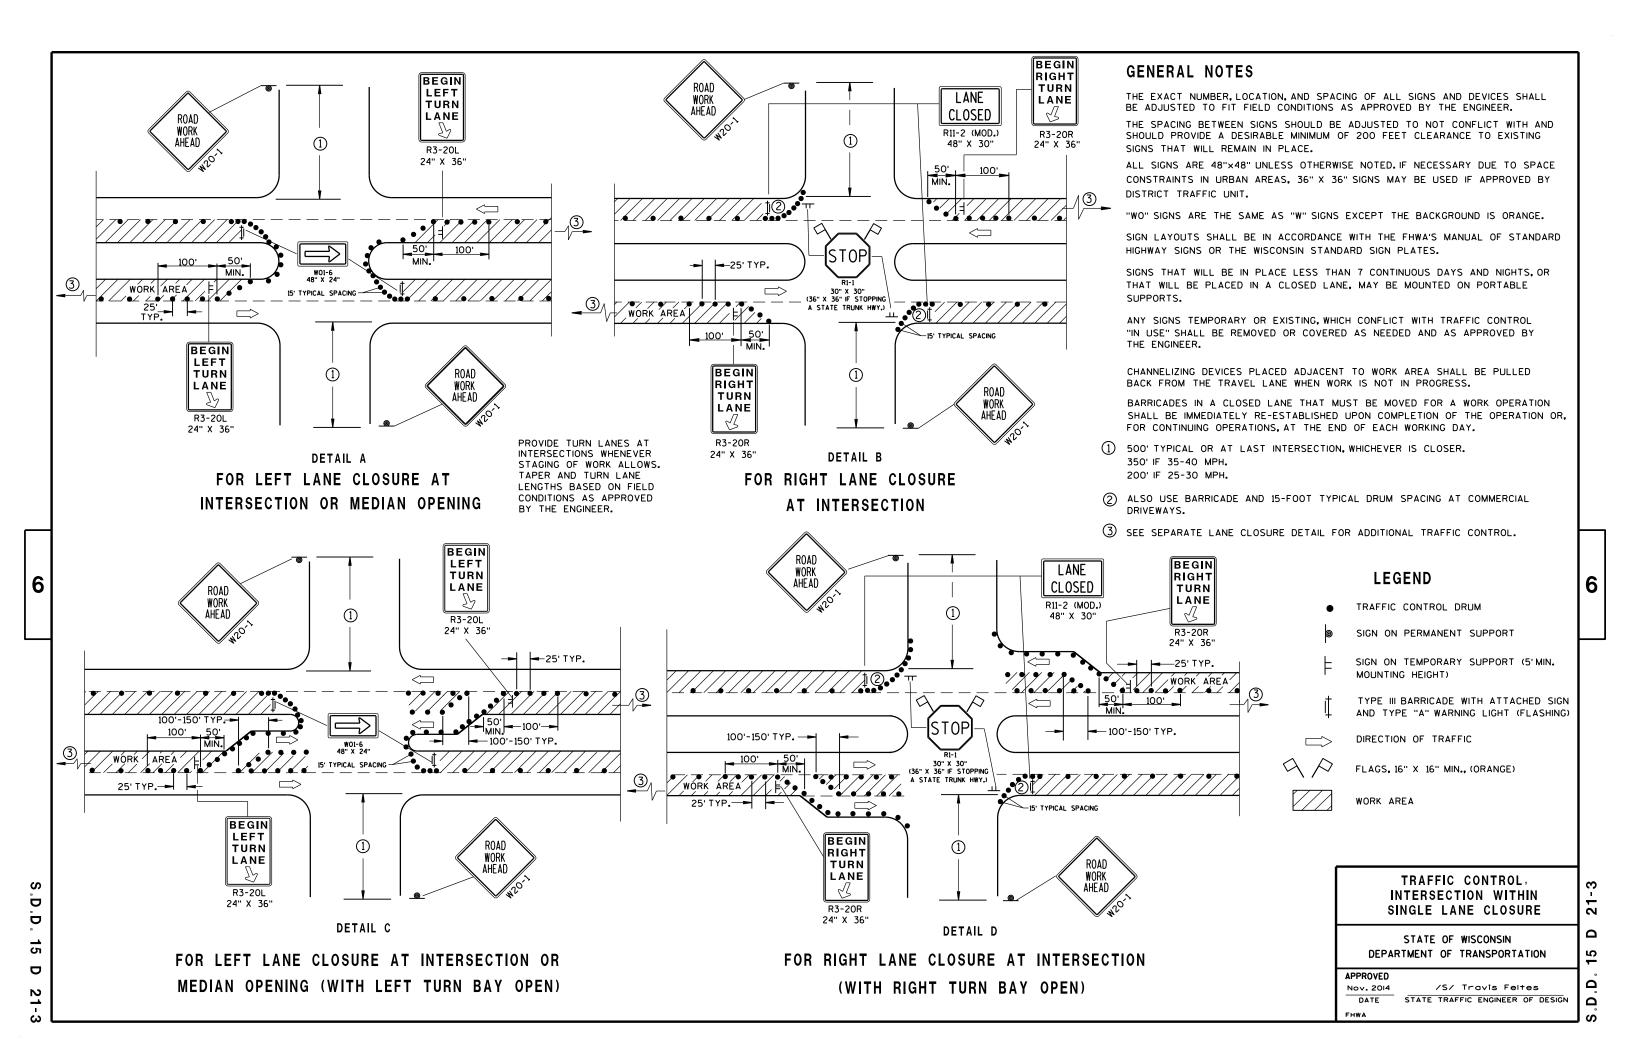

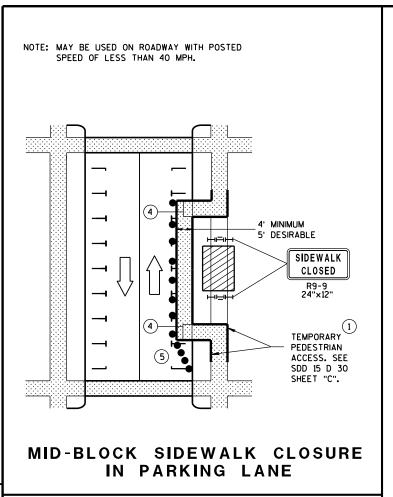

NOTE: LAYOUT SAME AS ABOVE. 4' MINIMUM 5' DESIRABLE SIDEWALK CLOSED RQ-Q TEMPORARY PEDESTRIAN ACCESS. SEE SDD 15 D 30 SHEET "C". SIDEWALK DIVERSION


6

Ö


Ö

15

D

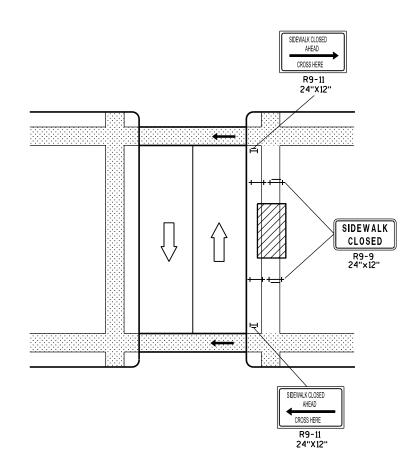

MID-BLOCK SIDEWALK CLOSURE

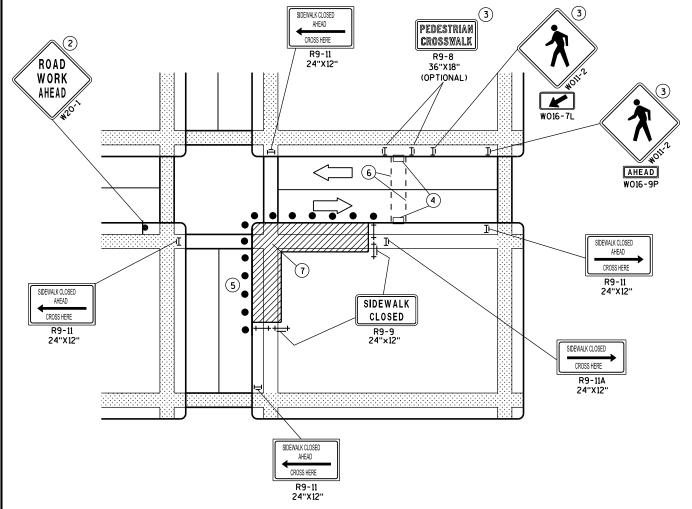

CORNER SIDEWALK CLOSURE WITH TEMPORARY CROSSWALK

### **GENERAL NOTES**

WHEN CLOSING OR RELOCATING CROSSWALKS OR SIDEWALKS, PROVIDE DETECABLE TEMPORARY FACILITIES AND INCLUDE ACCESSIBILITY FEATURES CONSISTENT WITH EXISTING PEDESTRIAN FACILITIES.

TEMPORARY TRAFFIC CONTROL DEVICES FOR PEDESTRIANS ARE SHOWN. OTHER DEVICES MAY BE NECESSARY TO CONTROL VEHICULAR TRAFFIC. STAGE WORK, AS NECESSARY, TO PROVIDE A TEMPORARY PEDESTRIAN ACCESS ROUTE AT ALL TIMES. FOR ROADWAYS WITH NO AVAILABLE DETOURS, MAINTAIN ONE OPEN SIDEWALK AT ALL TIMES.

"WO" SIGN IS THE SAME AS "W" SIGN EXCEPT THE BACKGROUND IS ORANGE.

FOR NIGHTTIME CLOSURE USE TYPE "A" FLASHING WARNING LIGHTS ON BARRICADES, SUPPORTING SIGNS AND CLOSING SIDEWALK. USE TYPE "C" STEADY BURN LIGHTS ON CHANNELIZING DEVICES SEPARATING THE WORK AREA FROM VEHICULAR TRAFFIC.

PEDESTRIAN TRAFFIC SIGNAL DISPLAY CONTROLLING CLOSED CROSSWALK SHALL BE COVERED OR DEACTIVATED.

POST MOUNTED SIGNS LOCATED ADJACENT TO A SIDEWALK SHALL HAVE A 7 FOOT MINIMUM CLEARANCE FROM THE BOTTOM OF THE SIGN TO THE SIDEWALK SURFACE.

ALTERNATE SIDEWALK WORK BETWEEN LEFT AND RIGHT SIDE OF ROADWAY TO MAINTAIN PEDESTRIAN ACCESS.

- 1) IF SIDEWALK CLOSURE AFFECTS AN ACCESSIBLE AND DETECTABLE FACILITY, MAINTAIN ACCESSIBILITY AND DETECTABILITY ALONG THE ALTERNATE PEDESTRIAN ROUTE.
- 2) "ROAD WORK AHEAD" SIGNS ARE NOT REQUIRED IF THE SIDEWALK CLOSURE OCCURS WITHIN A LARGER WORK ZONE WHERE ADVANCE WARNING SIGNS ARE ALREADY PRESENT, OR IF THE WORK AREA AND EQUIPMENT ARE MORE THAN 2 FEET BEHIND THE CURB.
- (3) IF TEMPORARY PEDESTRIAN CROSSWALK IS NOT PROVIDED, OMIT R9-8 AND WO11-2 SIGN ASSEMBLIES. IF PROVIDED INCLUDE ON BOTH SIDES OF THE CROSSWALK.
- (4) TEMPORARY CURB RAMPS. SEE SDD 15 D 30 SHEET "B".
- (5) DRUMS OR BARRICADES AT 25 FOOT SPACING. STREET PARKING SHALL BE PROHIBITED FOR AT LEAST 50 FEET IN ADVANCE OF THE MID-BLOCK CROSSWALK.
- (6) TEMPORARY PAVEMENT MARKING FOR CROSSWALK LINES.
- (7) LIMIT WORK TO ONE QUADRANT AT A TIME TO MINIMIZE PEDESTRIAN

#### **LEGEND**

SIGN ON PERMANENT SUPPORT

UNDER PEDESTRIAN TRAFFIC

TRAFFIC TRAFFIC CONTOL DRUM

DIRECTION OF

WORK AREA

PEDESTRIAN CHANNELIZATION DEVICE

TYPE II BARRICADE WITH/WITHOUT SIGN (ALL WITH ONE WARNING LIGHT, TYPE A. LOW-INTENSITY FLASHING)

TYPE III BARRICADE WITH/WITHOUT SIGN (ALL WITH ONE WARNING LIGHT, TYPE A, LOW-INTENSITY FLASHING)

### TRAFFIC CONTROL, PEDESTRIAN ACCOMMODATION

STATE OF WISCONSIN DEPARTMENT OF TRANSPORTATION S 0 က Ω Ω

PARALLEL TO CURB

TEMPORARY BUS STOP PAD

D

0


### GENERAL NOTES


NOTIFY THE BUS COMPANY 7 DAYS IN ADVANCE OF THE BUS STOP RELOCATION. ALTERNATE SIDEWALK WORK BETWEEN LEFT AND RIGHT SIDE OF ROADWAY TO MAINTAIN PEDESTRIAN ACCESS.

- (1) CURB RAMPS SHALL BE 48" MIN. WIDTH WITH A FIRM, STABLE AND SLIP RESISTANT SURFACE. INSTALL CONTRASTING DETECTABLE WARNING FIELD AT PEDESTRIAN STREET CROSSINGS. REFER TO SDD 8D5 SHEET "E".
- ② PROTECTIVE EDGING WITH A 2" MIN. HEIGHT SHALL BE INSTALLED WHEN A CURB RAMP OR LANDING PLATFORM HAS A VERTICAL DROP OF 6" OR GREATER OR HAS A SIDE APRON SLOPE STEEPER THAN 1:3 (33%). PROTECTIVE EDGING SHOULD BE CONSIDERED WHEN CURB RAMPS OR LANDING PLATFORMS HAVE A VERTICAL DROP OF 3" OR MORE.
- (3) DETECTABLE EDGING WITH 6" MIN. HEIGHT AND CONTRASTING COLOR SHALL BE INSTALLED ON ALL CURB RAMP LANDINGS WHERE THE WALKWAY CHANGES DIRECTION (TURNS).
- (4) CURB RAMPS AND LANDINGS SHALL HAVE A 1:50 (2%) MAX. CROSS-SLOPE.
- 5 CLEAR SPACE OF 48"X48" MIN. SHALL BE PROVIDED ABOVE AND BELOW THE CURB RAMP.
- (6) THE CURB RAMP WALKWAY EDGE SHALL BE MARKED WITH A YELLOW COLOR, 4" WIDE MARKING, UNLESS A CONTRASTING DETECTABLE WARNING FIELD IS PROVIDED.
- 7 DO NOT RESTRICT WATER FLOW IN THE GUTTER SYSTEM.
- (8) LATERAL JOINTS OR GAPS BETWEEN SURFACES SHALL BE LESS THAN 1/2" WIDTH.
- (9) CHANGES BETWEEN SURFACE HEIGHTS SHALL NOT EXCEED 1/2". LATERAL EDGES SHALL BE VERTICAL UP TO 1/4" HIGH, AND BEVELED AT 1:2 BETWEEN 1/4" AND 1/2".
- 5' WIDE MIN. WITH PEDSETRIAN SAFETY FENCE, 10' WIDE MIN. WITHOUT PEDESTRIAN SAFETY FENCE.

DEPARTMENT OF TRANSPORTATION

 $\frac{\text{March 2015}}{\text{DATE}} \hspace{0.1in} \frac{\text{/S/ TravIs Feltes}}{\text{STATE TRAFFIC ENGINEER OF DESIGN}}$ 

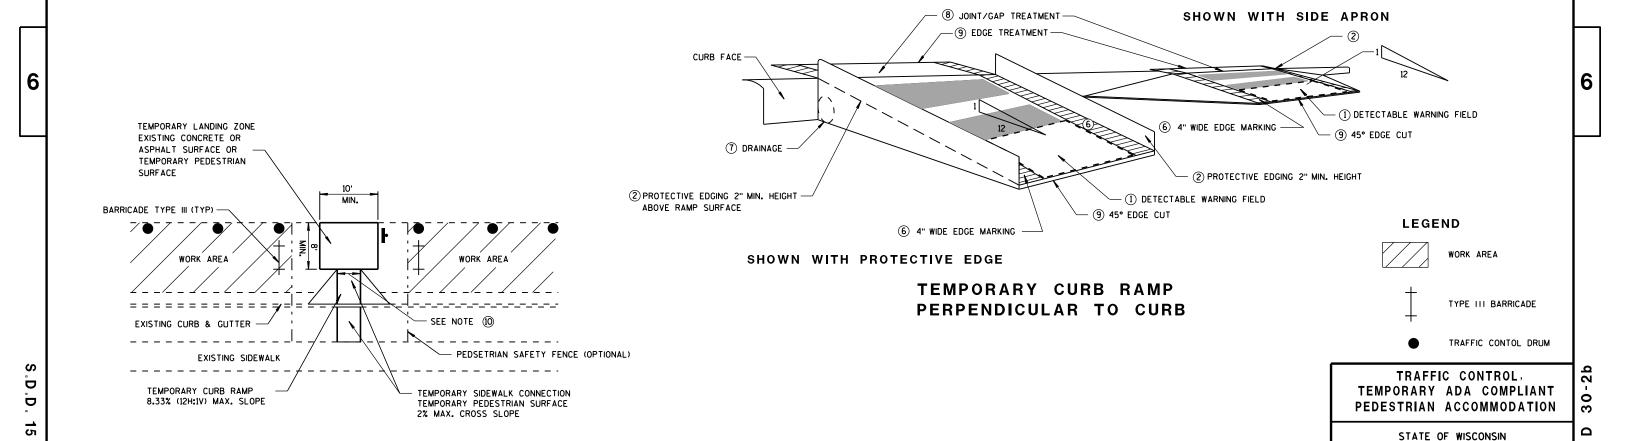

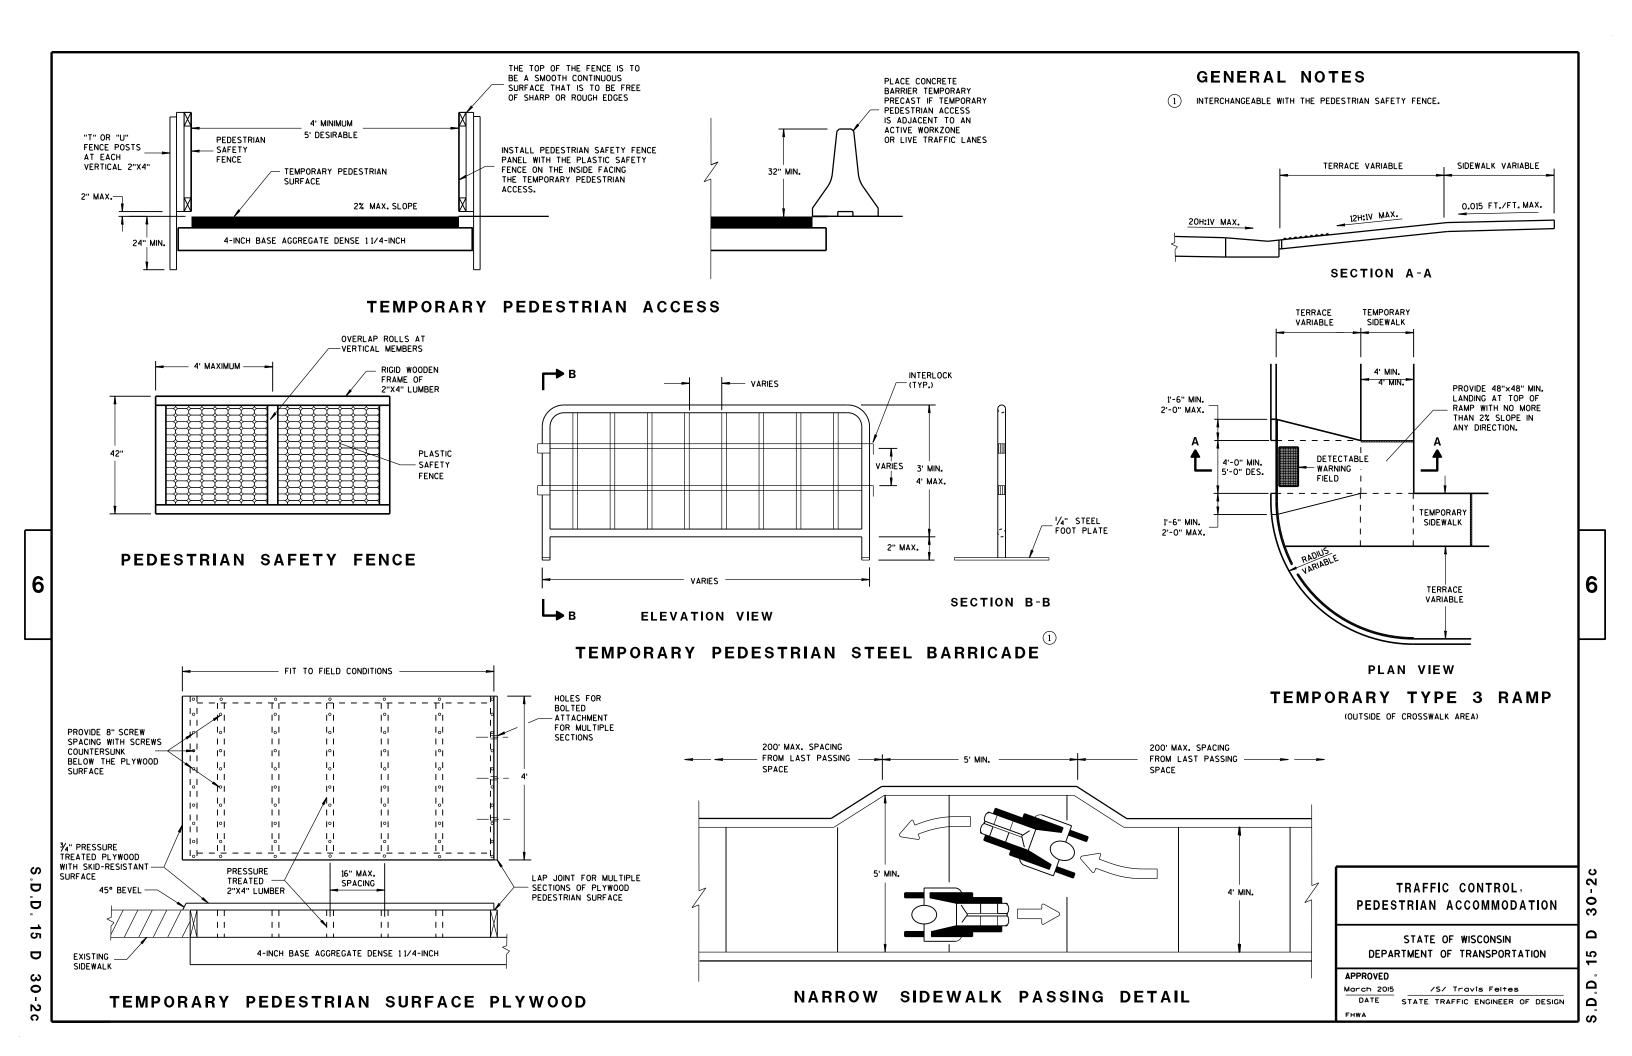


NOTES

- 1. All Signs are Type II Type H Reflective
- 2. Color:

Background - Green Message - White

3. Message Series - B

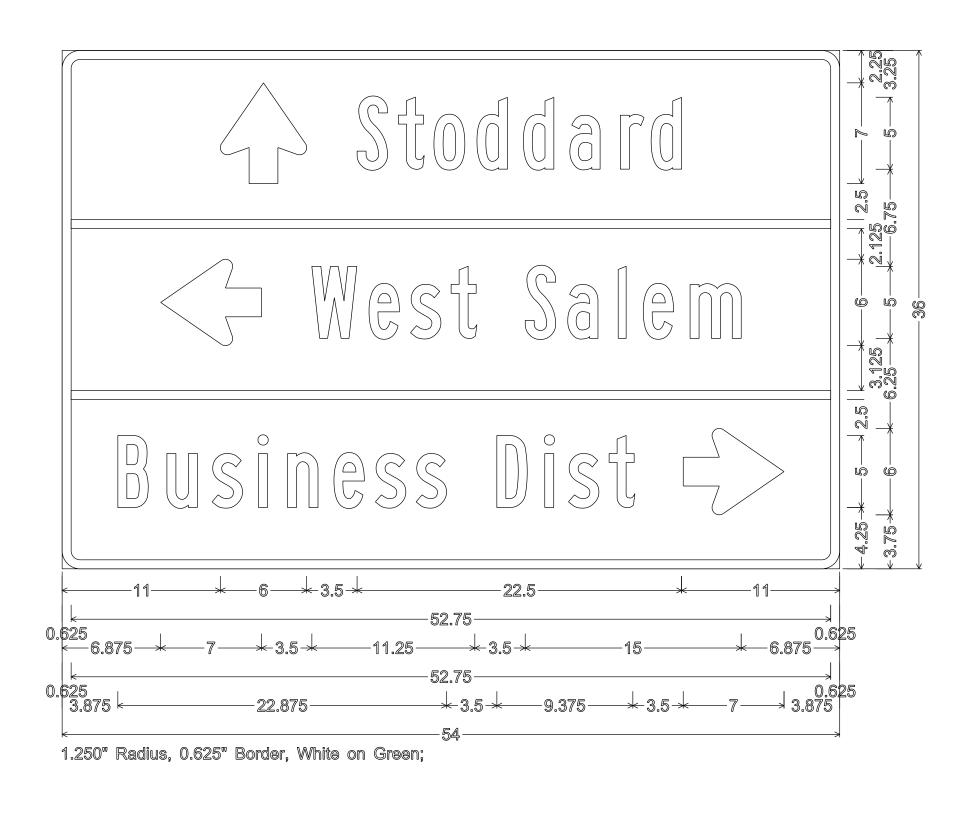

7

PROJECT NO: 5221-03-01 HWY: STH 35 COUNTY: LA CROSSE PERMANENT SIGNING SHEET NO: E

1. Signs are Type II - Type H Reflective - reference WIS DOT Standard

areater than 48 inches (both vertical and horizontal) shall have one horizontal splice between the arrows and route shields. Vertical splices shall not be used on route assemblies with a horizontal dimension of 144 inches or less. The contractor shall not use more than one vertical joint per sign and the joint shall be between route shields.



PROJECT NO:

J32-1

J22-1

J23-1

J33-1

PLOT BY: mscsja

PLATE NO. \_\_A2-15.8

DATE 2/06/14

SHEET NO:

### URBAN ARFA



RURAL AREA (See Note 2)



2' Min - 4' Max (See Note 6)



5'-3"(生)  $D^{-1}$ Outside Edae of Gravel

White Edgeline Location

\*\* The existence of curb and gutter does not in itself mandate the vertical clearance illustrated. That height is typically measured where

there is sidewalk adjacent to the roadway or parking is permitted. In the absence of sidewalk vertical clearance is measured from the top of the curb. Offset of signs is measured from the flow line.

HWY:

\* 6 feet from edge of a paved shoulder or 12 feet from the edge of pavement (edge line location) or 2 feet from outside edge of gravel, whichever is greater unless directed by project engineer.

PLOT BY : mscj9h

### GENERAL NOTES

- 1. Signs wider than 4 feet or 20 sq.ft or larger, shall be mounted on multiple posts. Refer to plate A4-4.
- 2. If signs are mounted on barrier wall, see A4-10 sign plate.
- 3. For expressways and freeways, mounting height is  $7'-3''(\pm)$  or 6'-3" (±) depending upon existence of a sub-sign.
- 4. Minimum mounting height for J assemblies (A2-1S) is  $7'-3''(\pm)$  or  $6'-3''(\pm)$ per urban or rural detail respectively.
- 5. Minimum mounting height for signs mounted on traffic signal poles is  $5' - 3'' (\pm)$ .
- 6. Offset distance shall be consistent with existing signs or consistent throughout length of project.
- 7. The (+) tolerance for mounting height is 3 inches.
- 8. Folding signs shall be mounted at a height of 5'-3'' ( $\pm$ ) or as directd by the Engineer.
- 9. The Double Arrow sign (W12-1) shall be mounted at a height of 2'-3"  $(\pm)$ . The Chevron sign (W1-8), Roundabout Chevron panel (R6-4B), Enhanced Reference Markers, Clearance Markers (W5-52), Mile Markers (D10 series), In Road Object Markers (W5-54) & End of Road Markers (W5-56) shall be mounted at a height of 4'-3'' ( $\pm$ ).

### POST EMBEDMENT DEPTH

Area of Sign	
Installation	D
( Sq. Ft.)	(Min)
20 or Less	4'
Greater than 20	5'

TYPICAL INSTALLATION OF PERMANENT TYPE II SIGNS ON SINGLE POSTS

WISCONSIN DEPT OF TRANSPORTATION

SHEET NO:

APPROVED

for State Traffic Engineer

DATE 7/23/15

PLATE NO. <u>A4-3.20</u>

FILE NAME : C:\CAEfiles\Projects\tr\_stdplate\A43.DGN

PROJECT NO:

PLOT DATE: 23-JUL-2015 15:21

COUNTY:

PLOT NAME :

PLOT SCALE: 99.237937:1.000000

WISDOT/CADDS SHEET 42



NOTES: 1. ALL MATERIAL TO BE APPROVED

BY ENGINEER PRIOR TO INSTALLATION

- 2. SEE SIGN PLATE A4-8 FOR SIGN HARDWARE REQUIREMENTS
- 3. 18 INCH X 18 INCH SQUARE BOX-OUTS MAY BE USED FOR INSTALLATIONS IN EXISTING CONCRETE OR ASPHALT LOCATIONS.



### ELEVATION VIEW

DETAIL OF STEEL 2 X 2 SIGN POST IN BOX-OUT



DETAIL OF WOOD 4 X 6 SIGN POST IN BOX-OUT

HWY:



### PLAN VIEW

COUNTY:

FOR NEW CONCRETE/ASPHALT INSTALLATIONS

SIGN POST BOX-OUTS A4-3B

WISCONSIN DEPT OF TRANSPORTATION

For State Traffic Engineer

DATE 1/27/14 PLATE NO. A4-3B.1

SHEET NO:

FILE NAME : C:\CAEFiles\Projects\tr\_stdplate\A43B.DGN

PROJECT NO:

PLOT DATE: 27-JAN-2014 09:48

PLOT NAME :

PLOT BY: mscsja

PLOT SCALE: 13.659812:1.000000

APPROVED

WISDOT/CADDS SHEET 42

### GENERAL NOTES

- 1. For 3 or 4 post installations, individual post spacing shall be greater than 3'-6".
- 2. See tables below for required number of posts.
- 3. For expressways and freeways, mounting height is 7'-3'' (±) or 6'-3'' (±) depending upon existence of sub-sign.
- 4. The (±) tolerance for mounting height is 3 inches.
- 5. Minimum mounting height for J assemblies (A2-1S) is 7'-3'' (±) or 6'-3'' (±) per urban or rural detail respectively.
- 6. Offset distance shall be consistent with existing signs or consistent throughout length of project.
- 7. Folding signs shall be mounted at a height of 5'-3" (±) or as directed by the engineer.
- 8. The Double Arrow sign (W12-1) shall be mounted at a height of 2'-3" (±). The Chevron sign (W1-8). Roundabout Chevron panel (R6-4B), Clearance Markers (W5-52), Mile Markers (D10 series), In Road Object Markers (W5-54) & End of Road Markers (W5-56) shall be mounted at a height of 4"-3" (±).
- \* 6 feet from edge of a paved shoulder or 12 feet from the edge of pavement (edge line location) or 2 feet from outside edge of gravel, whichever is greater unless directed by project engineer.
- \*\* The existence of curb and gutter does not in itself mandate the vertical clearance illustrated. That height is typically measured where there is sidewalk adjacent to the roadway or parking is permitted. In the absence of sidewalk vertical clearance is measured from the top of the curb. Offset of signs is measured from the flow line.
- \*\*\* See A4-3 sign plate for signs 4' or less in width and less than 20 S.F. in area.

### URBAN AREA RURAL AREA (See Note 3) 2'Min - 4'Max (See Note 6) ₩E# FF# 6'-3"(±) 6'-3"(±) 7'-3"(±) \*\* Curb \*\*\*\*\ Flowline D **7000** White Edgeline D 11 White Edgeline, Location Outside Edae Location

# 2' Min - 4' Max (See Note 6) 6'-3"(±) Curb Flowline. - 11

48" DIAMOND WARNING SIGN

HWY:

## \_ 26" 5 ' - 3 "(±) White Edgeline Location Outside Edge of Gravel 48" DIAMOND WARNING SIGN

COUNTY:

Outside Edge

of Gravel

	SIGN SHAPE OTHER THAN DIAMOND (TWO POSTS REQUIRED)		
	L	E	
<del>* * *</del>	Greater than 48" Less than 60"	12"	
	60" to 120"	L/5	l

SIGN SHAPE OTHER THAN DIAMOND (THREE POSTS REQUIRED)		
L	E	
Greater than 120" less than 168"	12"	

SIGN SHAPE OTHER THAN DIAMOND (FOUR POSTS REQUIRED)		
L	E	
168" and greater	12"	

### POST EMBEDMENT DEPTH

of Gravel

Area of Sign	
Installation	D
( Sq. Ft.)	(Min)
20 or Less	4'
Greater than 20	5'

TYPICAL INSTALLATION OF TYPE II SIGNS ON MULTIPLE POSTS

Matther

SHEET NO:

FILE NAME : C:\CAEfiles\Projects\tr\_stdplate\A44.DGN

PROJECT NO:

PLOT DATE: 23-JUL-2015 15:23

PLOT SCALE: 107.021305:1.000000

WISDOT/CADDS SHEET 42


PLOT NAME :


PLOT BY: mscj9h

WISCONSIN DEPT OF TRANSPORTATION APPROVED

For State Traffic Engineer

PLATE NO. 44-4.14 DATE 7/23/15

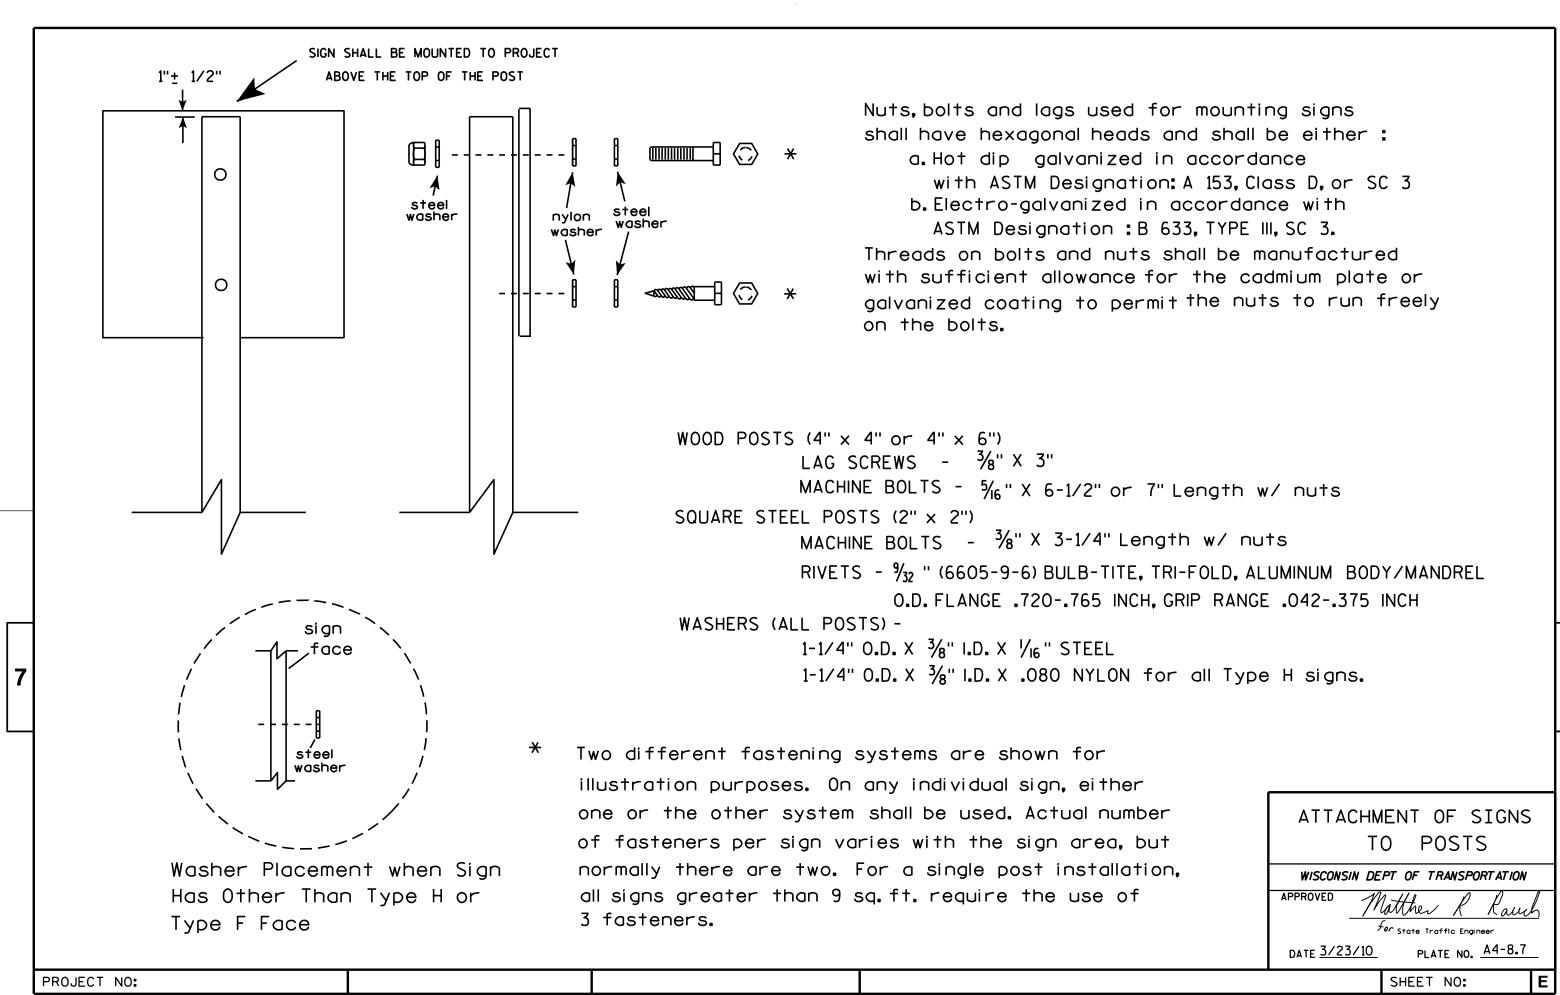

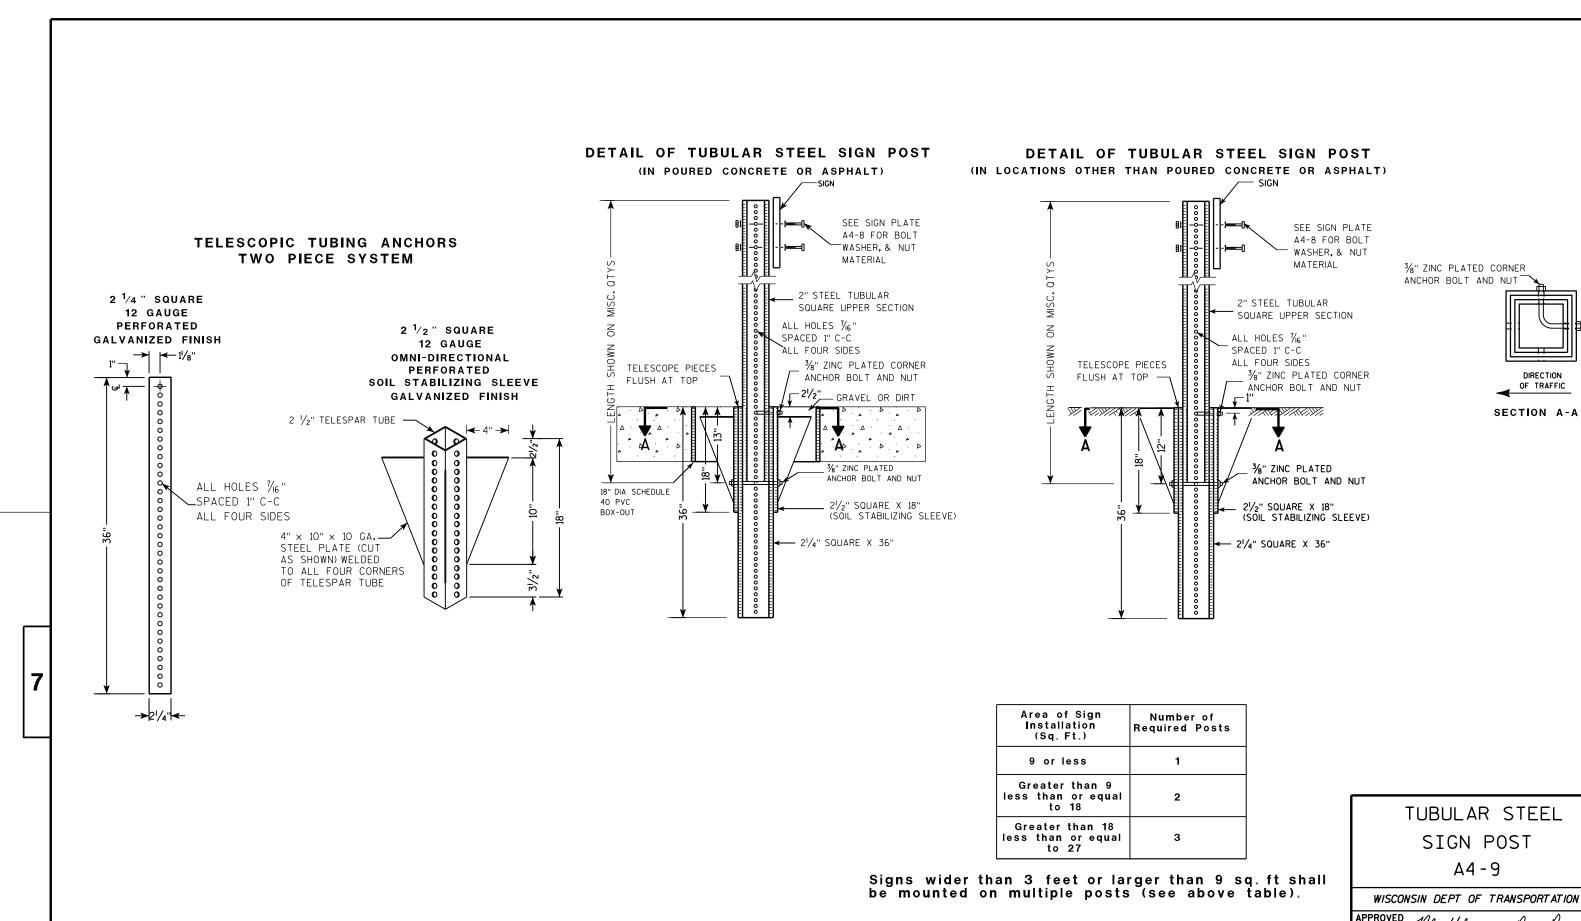

PROJECT NO: SHEET NO: E

FILE NAME: C:\CAEFiles\Projects\tr\_stdplate\A49.DGN

PLOT DATE: 05-FEB-2015 17:09

PLOT DATE: 05-FEB-2015 17:09

PLOT NAME: PLOT NAME: PLOT SCALE: 13.659812:1.000000


WISDOT/CADDS SHEET 42


For State Traffic Engineer

PLATE NO. <u>A4-9.9</u>

DATE 2/05/15



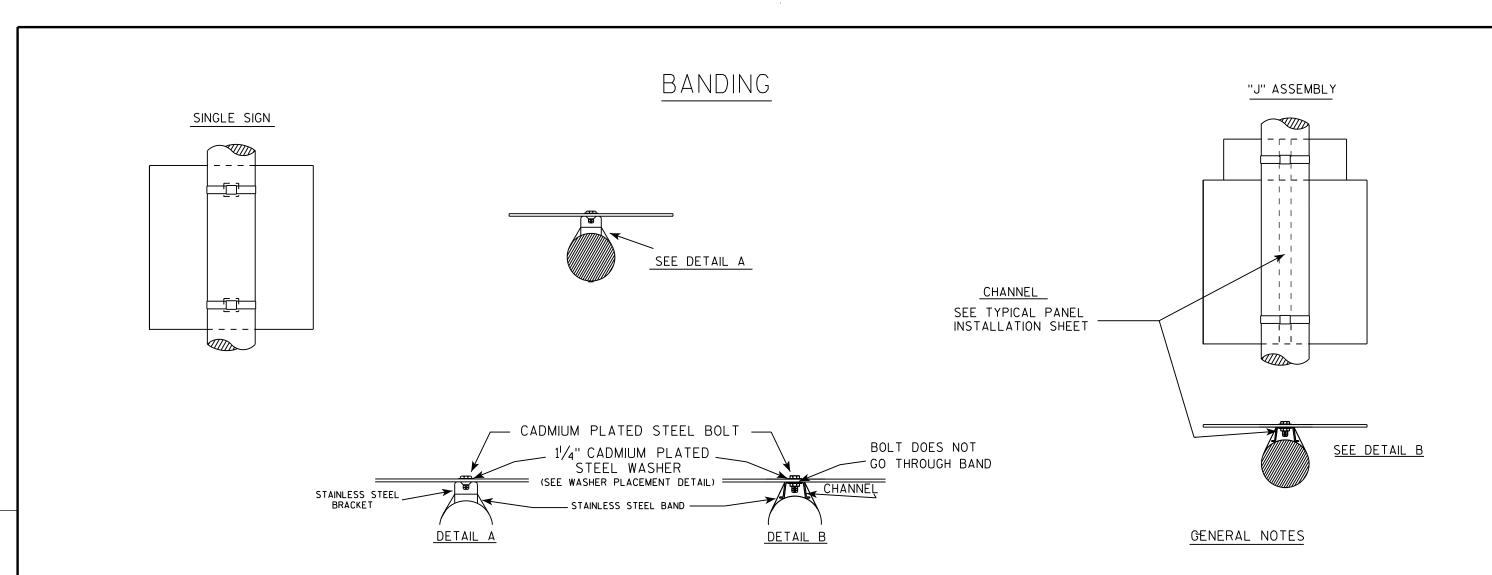

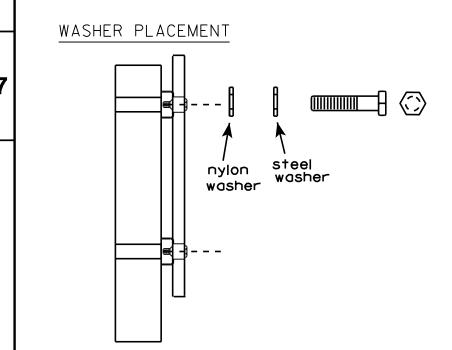

HWY:

WASHERS (ALL POSTS) -

COUNTY:

1-1/4" O.D.  $X\frac{3}{8}$ " I.D.  $X\frac{1}{16}$ " STEEL 1-1/4" O.D.  $X\frac{3}{8}$ " I.D. X .080 NYLON FOR ALL TYPE H SIGNS

PLOT BY: mscsja

- 1. Any sign over 3 feet in width shall use the V-Block banding method. See A5-10 standard plate.
- 2. Signs 3 feet or greater in height shall have three bracket bands installed. Signs less than 3 feet in height shall have two bracket bands installed.
- 3. Banding and assembly bracket shall be stainless steel. All bands shall be  $\frac{3}{4}$ " in width and 0.025" thickness.

STANDARD SIGN
SIGN BANDING DETAILS

WISCONSIN DEPT OF TRANSPORTATION

APPROVED 400 1100 400 400

For State Traffic Engineer

DATE 8/16/13

713 PLATE NO. A5-9.3

SHEET NO:


FILE NAME : C:\CAEFiles\Projects\tr\_stdplate\A59.DGN

PROJECT NO:

PLOT DATE: 16-AUG-2013 13:27

PLOT NAME :

PLOT SCALE: 33.740899:1.000000

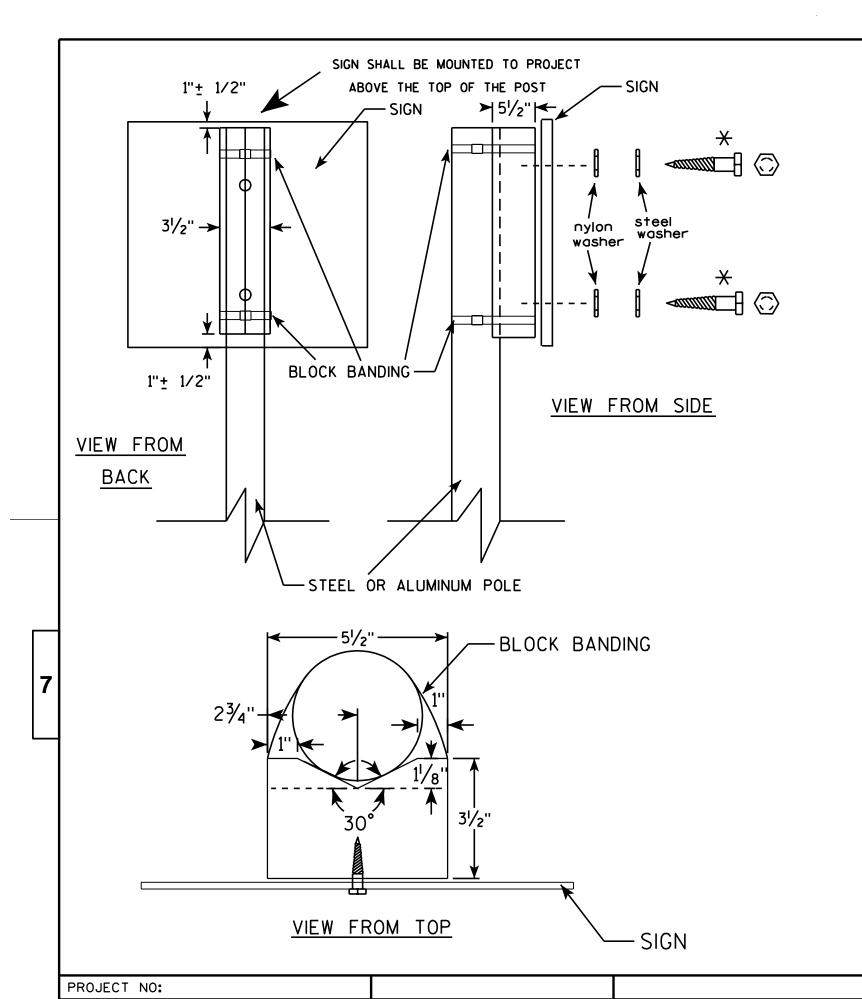

# GENERAL NOTES

- 1. WOOD 4"X6" POST MATERIAL SHALL CONFORM TO 507.2.2 OF THE WISDOT STANDARD SPECIFICATIONS
- 2. BLOCK BANDING AND CLIPS SHALL BE STAINLESS STEEL, 3/4" WIDTH AND 0.025" THICKNESS
- 3. SIGNS 3' OR GREATER IN HEIGHT SHALL UTILIZE 3 BLOCK BANDS.

  SIGNS UNDER 3' IN HEIGHT SHALL UTILIZE 2 BLOCK BANDS
- 4. ACTUAL NUMBER OF FASTENERS PER SIGN VARIES WITH THE SIGN AREA, BUT NORNALLY THERE ARE TWO. FOR SIGNS GREATER THAN 9 S.F. 3 FASTENERS SHALL BE USED.
- 5. ALL SIGN MOUNTING BOLTS AND WASHERS SHALL BE EITHER:
  - a. Hot dip or mechanically galvanized in accordance with ASTM Designation: A 153, Class D, or
  - b. Cadmium plated in accordance with ASTM Designation: B 766 TYPE 3, Class 12, or
  - c. Electro-galvanized in accordance with ASTM Designation: B 633, TYPE III, SC 3.
- 6. ALL BOLTS SHALL HAVE HEXAGONAL HEADS.
- 7. STEEL WASHERS SHALL BE 11/4" O.D. X 3/8" I.D. X 1/16"
- 8. NYLON WASHERS SHALL BE  $1^{1}/_{4}$ " O.D. X  $3/_{8}$ " I.D. X .080 FOR TYPE H OR TYPE F FACE SIGN

X LAG BOLTS SHALL BE 3/8" X 21/2"

BLOCK BANDING DETAIL
( V-BLOCK OPTION )

WISCONSIN DEPT OF TRANSPORTATION

APPROVED

APPROVED

For State Traffic Engineer

DATE 7/12/07

PLATE NO. A5-10.1


SHEET NO:

1. Sign is Type II - Type F Reflective - reference WIS DOT Standard Specification for HIGHWAY and STRUCTURE CONSTRUCTION latest edition.

2. Color:

Background - Orange Message - Black

- 3. Message Series C
- 4. Corners may be square or rounded when base material is plywood but borders shall be rounded as shown. When base material is metal, the corners and borders shall be rounded.

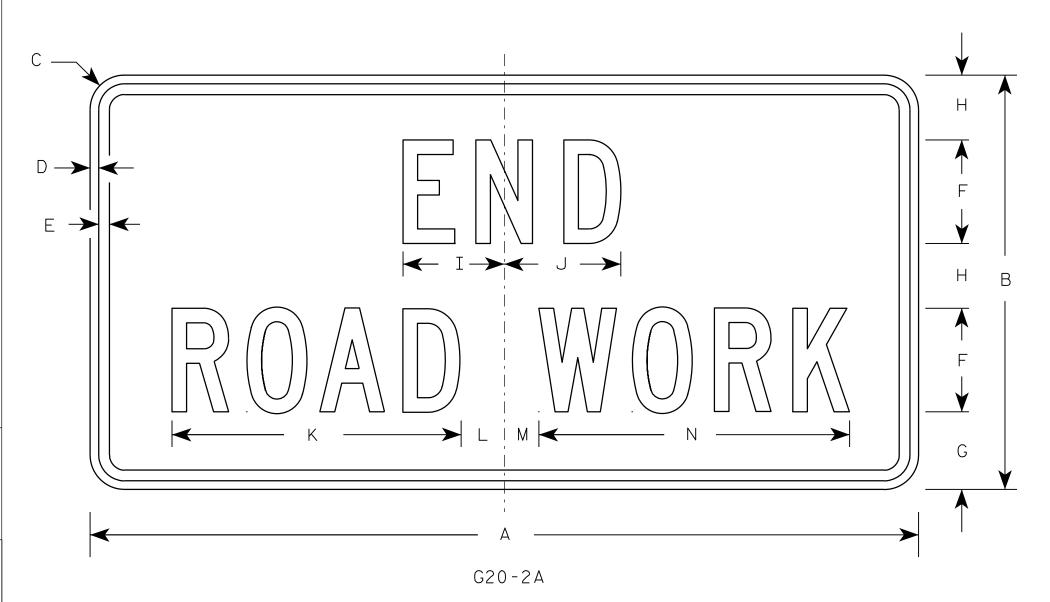

Metric equivalent for this sign is:

SIZE	Α	В	С	D	E	F	G	Н	I	J	К	L	М	N	0	Р	Q	R	S	T	U	٧	W	Х	Y	Z	Area sq. ft.	Area m2
1	36	18	1 1/8	3/8	1/2	4	3 3/4	2 1/2	4 1/8	4 1/8	11 1/8	2	1	12 1/8													4.5	0.41
2	48	24	1 1/2	1/2	5/8	6	4 1/2	3 3/4	5 %	6 3/4	16 ¾	2 1/2	1 3/4	18 ½													8.0	0.72
3	48	24	1 1/2	1/2	5/8	6	4 1/2	3 3/4	5 %	6 3/4	16 ¾	2 1/2	1 3/4	18 ½													8.0	0.72
4	48	24	1 1/2	1/2	5/8	6	4 1/2	3 3/4	5 %	6 3/4	16 ¾	2 1/2	1 3/4	18 ½													8.0	0.72
5	48	24	1 1/2	1/2	5/8	6	4 1/2	3 3/4	5 1/8	6 3/4	16 ¾	2 1/2	1 3/4	18 ½													8.0	0.72

COUNTY:

STANDARD SIGN G20-2A

WISCONSIN DEPT OF TRANSPORTATION

APPROVED 400 110 00 00 110

for State Traffic Engineer

DATE 9/30/09 PLATE NO. G20-2A.8

SHEET NO:

FILE NAME : C:\Users\PROJECTS\tr\_stdplate\G202A.DGN

HWY:

PROJECT NO:

PLOT DATE: 30-SEP-2009 09:31

PLOT BY : ditjph

PLOT NAME :

PLOT SCALE : 5.561773:1.000000

5.561773:1.000000 WISDOT/CADDS SHEET 42

# 

HWY:


Background Colors of Symbol\*

Z F Z

A F X A

**₽** 4

\* VARIES

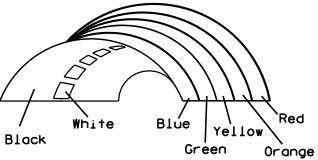

\*1/4" Black Border between each color of rainbow and border of rainbow

#### 

COUNTY:

NOTES

- 1. Sign is Type II Type H Reflective reference WIS DOT Standard Specification for HIGHWAY and STRUCTURE CONSTRUCTION latest edition.
- 2. Color:

Background - White Message - (See Note 5)

- 3. Message Series (See Note 6)
- 4. Corners may be square or rounded when base material is plywood but borders shall be rounded as shown. When base material is metal, the corners and borders shall be rounded.
- 5. Border Blue

Line 1 - Red

Line 2 - Black

Line 3-5 - Blue

6. Line 1 - Dutch 8011L

Line 2 - Series E

Line 3-5 - Series C

7. Contractor shall provide and install a new post bracket in accordance with the I55-56B sign detail.

STANDARD SIGN I55-56

For State Traffic Engineer

DATE 4/27/11 PLATE NO. 15!

ATE 4/27/11 PLATE NO. 155-56.3

SHEET NO:

FILE NAME : C:\Users\PROJECTS\tr\_stdplate\I5556.DGN

PROJECT NO:

PLOT DATE: 27-APR-2011 10:05


PLOT BY: mscj9h

PLOT NAME :

PLOT SCALE: 7.945391:1.000000


945391:1.000000 WISDOT/CADDS SHEET 42

# ISOMETRIC VIEW

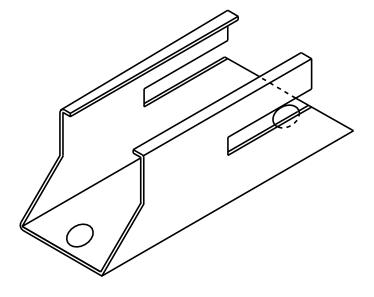


# TOP VIEW

HWY:

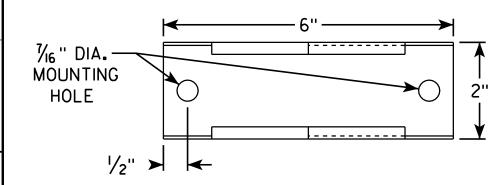

# SIDE VIEW

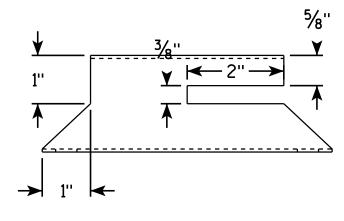


**←** 2" →

END VIEW

# NOTES

- 1. Must be capable of permanent attachment to a wood or steel channel sign post utilizing the fastening hardware specified on the A4-8 sign plate.
- 2. Shall be entirely primed and painted with two coats of a black powder coated enamel paint.
- 3. Shall be made with 12 gauge steel, and incorporate no welds, no hinged components, no threaded lock-type components, and no parts which are loose or can be separated from the main body.
- 4. Shall have rounded edges with at least  $\frac{1}{8}$ " radii.
- 5. Shall not have unrounded and uncoated metaledges which can contact the back surface of the roll-up sign.
- 6. Top of bracket shall be mounted 2' below the bottom of the 155-56 sign.
- 7. Cost of bracket and fastening hardware shall be incidental to the 155-56 sign.

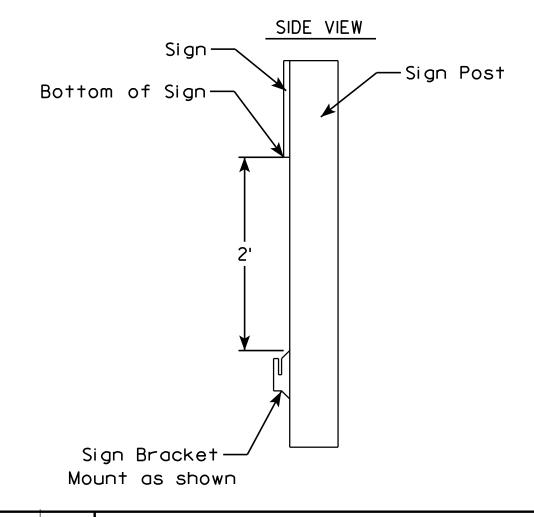

ROLLUP SIGN BRACKET I55-56B

WISCONSIN DEPT OF TRANSPORTATION APPROVED

for State Traffic Engineer DATE 2/5/10 PLATE NO. 155-56B.1

SHEET NO:

COUNTY:

PLOT BY : ditjph

PLOT NAME :

PLOT SCALE: 1.986348:1.000000

PROJECT NO:

- 1. Sign is Type II See Note 6 reference WIS DOT Standard Specification for HIGHWAY and STRUCTURE CONSTRUCTION latest edition.
- 2. Color:

Background - White & Black - See Note 6 Message - Black

- 3. Message Series See note 5
- 4. Corners may be square or rounded when base material is plywood but borders shall be rounded as shown. When base material is metal, the corners and borders shall be rounded.
- 5. Substitute appropriate Series numerals and adjust spacing as per plate A10-1.
- 6. Permanent Signs
  Background Type H Reflective
  Detour or temporary Signs
  Background Reflective

J M N BLACK N

		F A H H H
Metric equivalent for this sign is:	M1 - 6	

HWY:

PROJECT NO:

900 mm X 900 mm

SIZE	Α	В	С	D	E	F	G	Н	I	J	K	L	М	N	0	Р	0	R	S	Т	U	٧	W	Х	Υ	Z	Area sq. ft.	Area m2
1																												
2	24		1 1/2			12	5 1/2	6 ½	10 1/4	2 1/2	8 %	11 1/2	1	1 %	11 1/4	21 1/8											4.0	<b>.</b> 36
3	36		2 1/4			18	8 3/4	9 1/4	15 3/8	5 3/8	12 5/8	17 1/8	1 ½	2 1/8	16 1/8	33											9.0	.81
4	36		2 1/4			18	8 3/4	9 1/4	15 3/8	5 3/8	12 5/8	17 1/8	1 1/2	2 1/8	16 1/8	33											9.0	.81
5	36		2 1/4			18	8 3/4	9 1/4	15 3/8	5 3/8	12 5/8	17 1/8	1 ½	2 1/8	16 1/8	33											9.0	<b>.</b> 81

COUNTY:

STATE ROUTE MARKER M1-6 FOR ASSEMBLIES

WISCONSIN DEPT OF TRANSPORTATION

APPROVED

Cheste J Spang

For State Traffic Engineer

DATE 3/20/02 PLATE NO. M1-6.9

SHEET NO:

PLOT NAME :

- 1. Sign is Type II Type H
- 2. Color:

Background - See note 5 Message - See note 5

- 3. Message Series C
- 4. Corners may be square or rounded when base material is plywood but borders shall be rounded as shown. When base material is metal, the corners and borders shall be rounded.
- 5. M2-1 Background White

Message - Black

MB2-1 Background - Blue

Message - White

MK2-1 Background - Green

Message - White

MM2-1 Background - White

Message - Green

MN2-1 Background - Brown


Message - White

MP2-1 Background - White

Message - Blue

MR2-1 Background - Brown

Message - Yellow

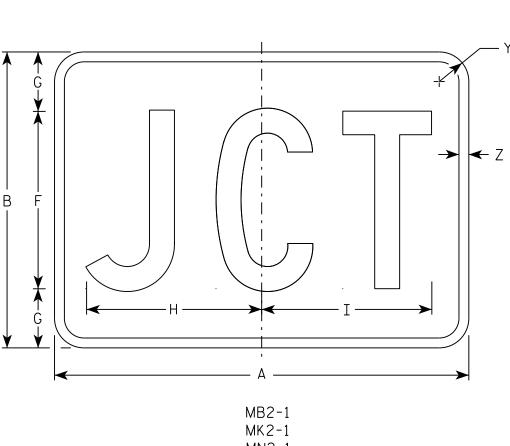

MN2-1

MR2-1

SIZE	Α	В	С	D	E	F	G	Н	I	J	K	L	М	N	0	Р	0	R	S	T	J	V	W	Х	Υ	Z	Area sq. ft.
1																											
2	21	15	1 1/8	3/8	3/8	9	3	8 1/8	8 %																1 1/2	1/2	2.20
3	30	21	1 1/8	3/8	3/8	13	4	12 1/8	12 3/8																1 1/2	1/2	4.40
4	30	21	1 1/8	3/8	3/8	13	4	12 1/8	12 3/8																1 1/2	1/2	4.40
5	30	21	1 1/8	3/8	3/8	13	4	12 1/8	12 3/8																1 1/2	1/2	4.40

COUNTY:

В

STANDARD SIGN

M2 - 1

WISCONSIN DEPT OF TRANSPORTATION

APPROVED

Matthew & Rauch  $f_{or}$  State Traffic Engineer

DATE 10/15/15

PLATE NO. M2-1.12 Ε

SHEET NO:

FILE NAME · C·\CAFfiles\Projects\tr stdplote\M21 DGN

PROJECT NO:

M2-1

HWY:


MM2-1


MP2-1


PLOT DATE . 01-DEC-2015 17:54

PLOT BY . \$\$ Diotuser \$\$ PLOT NAME :


PLOT SCALE • 4 864603•1 000000

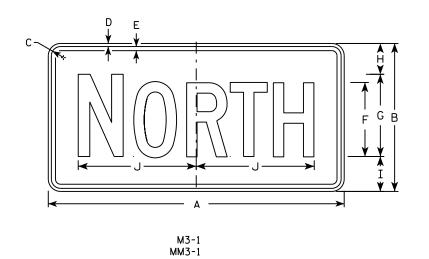


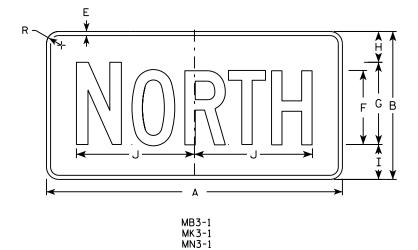


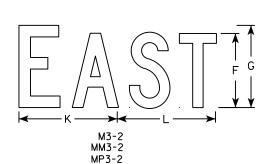


MP3-1

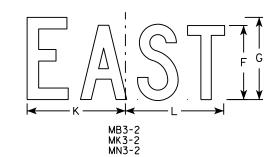


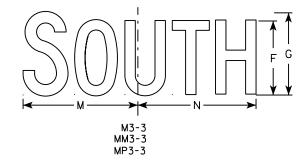

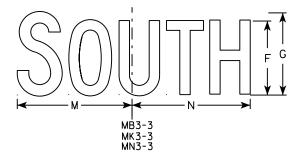

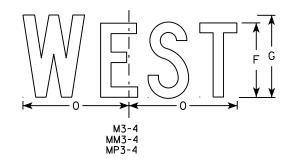

HWY:

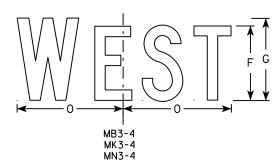

### NOTES

- 1. All Signs Type II Type H
- 2. Color:

Background - See note 5 Message - See note 5

- 3. Message Series C
- 4. Corners may be square or rounded when base material is plywood but borders shall be rounded as shown. When base material is metal, the corners and borders shall be rounded.

5. M3-1 thru M3-4 Background - White Message - Black

MB3-1 thru MB3-4 Background - Blue

Message - White

MK3-1 thru MK3-4 Background - Green

Message - White

MM3-1 thru MM3-4 Background - White

Message - Green

MN3-1 thru MN3-4 Background - Brown

Message - White

MP3-1 thru MP3-4 Background - White

Message - Blue

6. Note the first letter of each direction is larger than the remainder of the message.

SIZE	Α	В	С	D	E	F	G	Н	I	J	К	L	М	N	0	Р	0	R	S	Т	U	V	W	Х	Y	Z	Area sq. ft.
1																											
2	24	12	1 1/8	3/8	3/8	6	7	2 1/4	2 3/4	10 1/4	7 1/8	8 3/8	10 1/4	9 3/4	8 3/4			1 1/2									2.00
3	36	18	1 1/8	3/8	1/2	9	10	3 3/4	4 1/4	14 3/8	12	12 1/8	14	14 1/8	13			1 1/2									4.5
4	36	18	1 1/8	3/8	1/2	9	10	3 3/4	4 1/4	14 3/8	12	12 1/8	14	14 1/8	13			1 1/2									4.5
5	36	18	1 1/8	3/8	1/2	9	10	3 3/4	4 1/4	14 3/8	12	12 1/8	14	14 1/8	13			1 1/2									4.5

COUNTY:

STANDARD SIGNS M3-1 thur M3-4 **SERIES** 

WISCONSIN DEPT OF TRANSPORTATION

APPROVED

DATE 10/15/15 PLATE NO. M3-1.14

Ε

SHEET NO:

FILE NAME · C·\CAFfiles\Projects\tr stdolote\M31 DCN

PROJECT NO:

PLOT DATE . 01-DEC-2015 17:54

PLOT RY . \$\$ plotuser \$\$ PLOT NAME :

PLOT SCALE . 11 675051.1 000000

- 1. Sign is Type II Type F Reflective reference WIS DOT Standard Specification for HIGHWAY and STRUCTURE CONSTRUCTION latest edition.
- 2. Color:

Background - Orange Message - Black

- 3. Message Series B
- 4. Corners may be square or rounded when base material is plywood but borders shall be rounded as shown. When base material is metal, the corners and borders shall be rounded.

) A G	
	;         
<b>→</b> G <b>→</b>	
<b>Y</b>	

Α С E F G H I J S Х Z D 0 10 10 1/4 1 1/8 3/8 3/8 24 2.0 3 36 1 1/8 3/8 1/2 4 1/2 14 5/8 14 1/2 4.5 4 5

COUNTY:

STANDARD SIGN M4-8

WISCONSIN DEPT OF TRANSPORTATION

APPROVED

DATE 11/10/10 PLATE NO. M4-8.2

SHEET NO:

FILE NAME : C:\Users\PROJECTS\tr\_stdplate\M48.DGN

PROJECT NO:

HWY:


PLOT DATE: 10-NOV-2010 13:18

PLOT BY : ditjph

PLOT SCALE : 4.767

PLOT NAME :

PLOT SCALE: 4.767233:1.000000

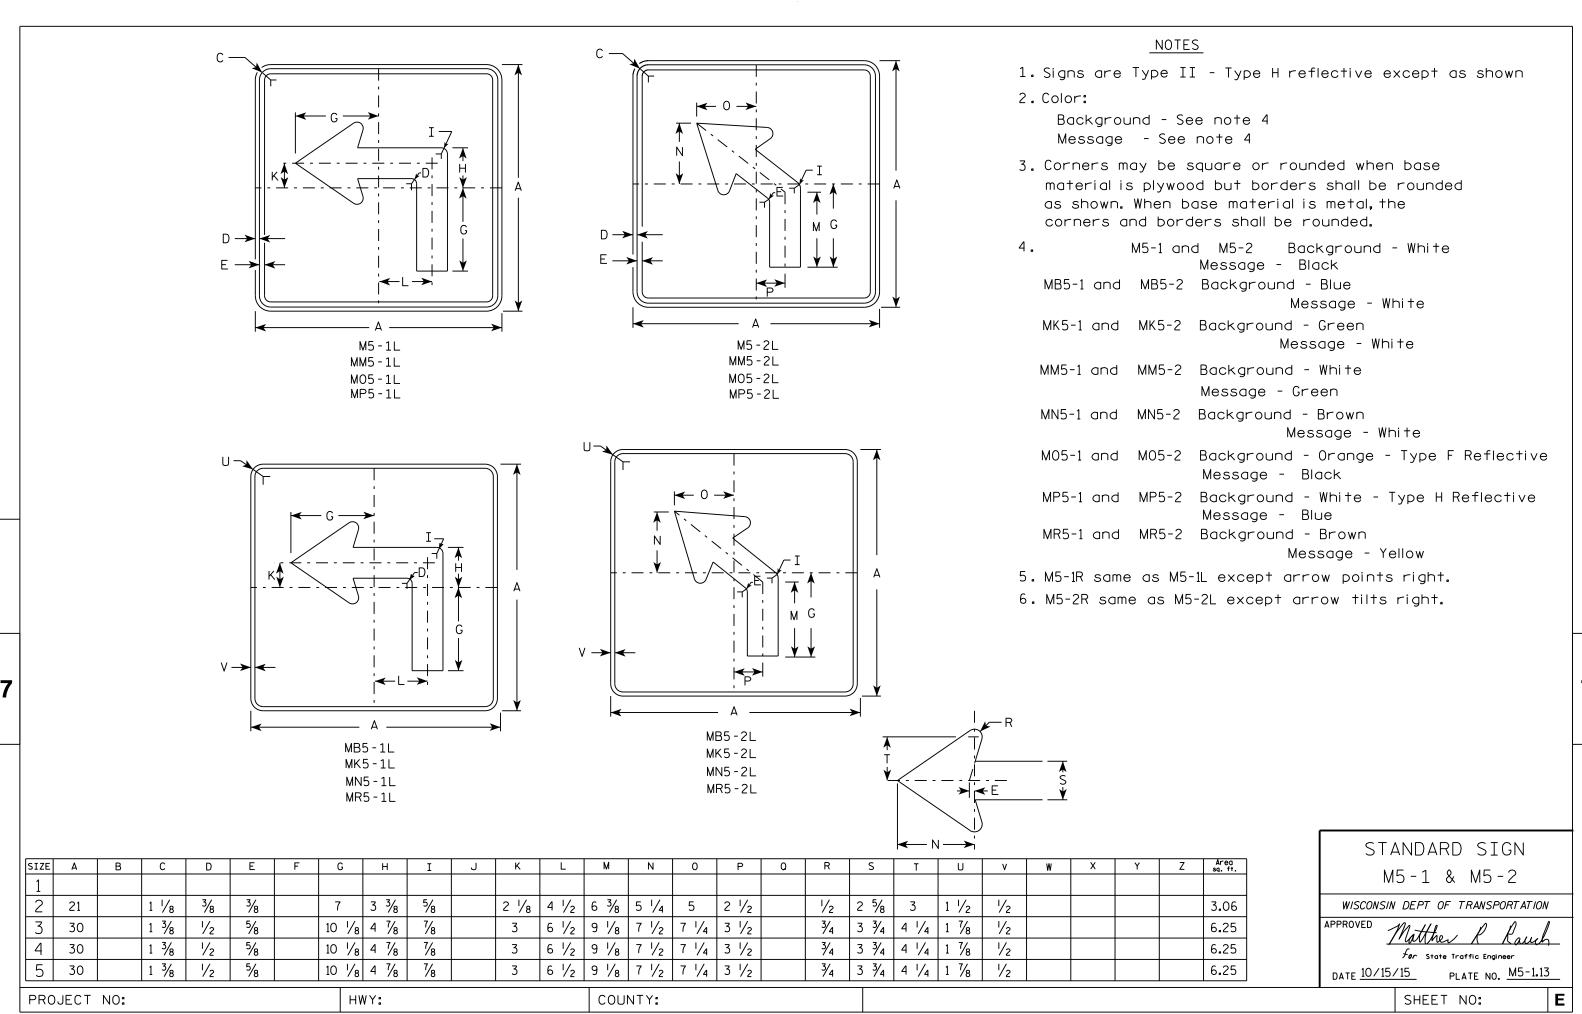



FILE NAME . C.\CAFfiles\Projects\tr stdolote\M51 DCN


PLOT DATE . 01-DEC-2015 18:07

PINT RY . \$\$ DIOTUSET \$\$ PINT NAMF :

PLOT SCALE . 11 675051.1 000000

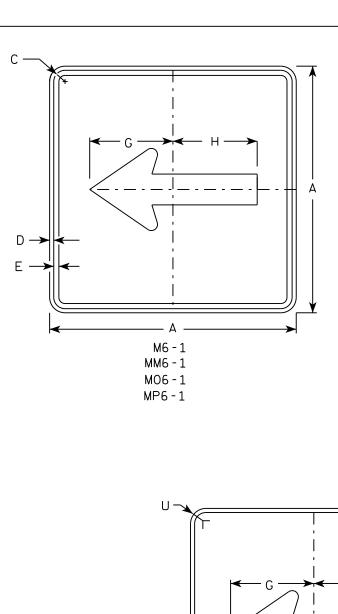


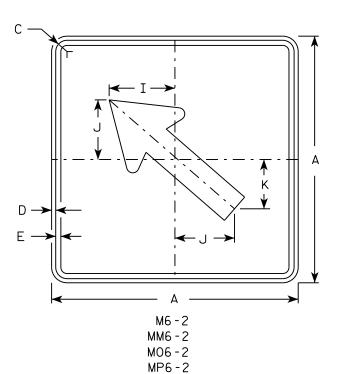

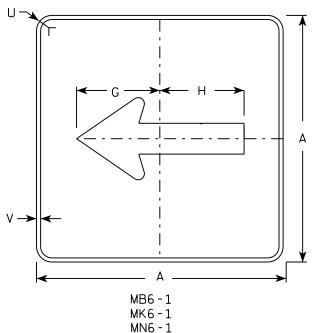

MR6-1

HWY:

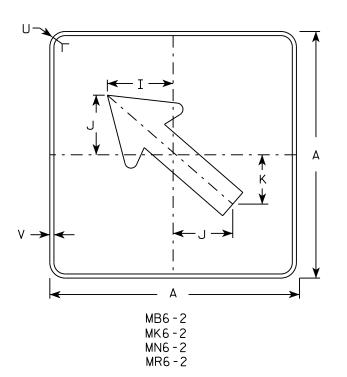

#### NOTES

- 1. Signs are Type II Type H except as Shown
- 2. Color:

Background - See note 4 Message - See note 4

- 3. Corners may be square or rounded when base material is plywood but borders shall be rounded as shown. When base material is metal, the corners and borders shall be rounded.
- 4. M6-1 and M6-2 Background White

Message - Black

MB6-1 and MB6-2 Background - Blue

Message - White

MK6-1 and MK6-2 Background - Green

Message - White

MM6-1 and MM6-2 Background - White

Message - Green

MN6-1 and MN6-2 Background - Brown

Message - White

M06-1 and M06-2 Background - Orange - Type F Reflective


Message - Black

MP6-1 and MP6-2 Background - White

Message - Blue

MR6-1 and MR6-2 Background - Brown

Message - Yellow

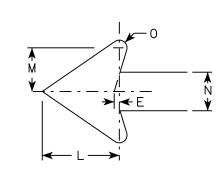

SIZE	Α	В	С	D	E	F	G	Н	I	J	K	L	М	N	0	Р	٥	R	S	T	U	٧	W	Х	Y	Z	Area sq. ft.
1 1																											
2	21		1 1/8	3/8	3/8		7 1/2	7 1/8	5 %	5	4 1/4	5 1/4	3	2 %	1/2						1 1/2	1/2					3.06
3	30		1 3/8	1/2	5/8		10 3/4	10 1/4	8	7 1/4	6	7 1/2	4 1/4	3 3/4	3/4						1 1/8	1/2					6.25
4	30		1 3/8	1/2	5/8		10 3/4	10 1/4	8	7 1/4	6	7 1/2	4 1/4	3 3/4	3/4						1 1/8	1/2					6.25
5	30		1 3/8	1/2	5/8		10 3/4	10 1/4	8	7 1/4	6	7 1/2	4 1/4	3 3/4	3/4						1 1/8	1/2					6.25

COUNTY:

STANDARD SIGN M6-1 & M6-2 SERIES

WISCONSIN DEPT OF TRANSPORTATION

APPROVED

Matthew & Rawl For State Traffic Engineer

Ε

DATE 10/15/15 PLATE NO. M6-1.15

SHEET NO:


FILE NAME · C·\CAFfiles\Projects\tr stdplote\M61 DCN

PROJECT NO:

PLOT DATE . 01-DEC-2015 17:57

PIOT RY . \$\$ plotuser \$\$ PIOT NAMF :

PLOT SCALE . 11 675051.1 000000

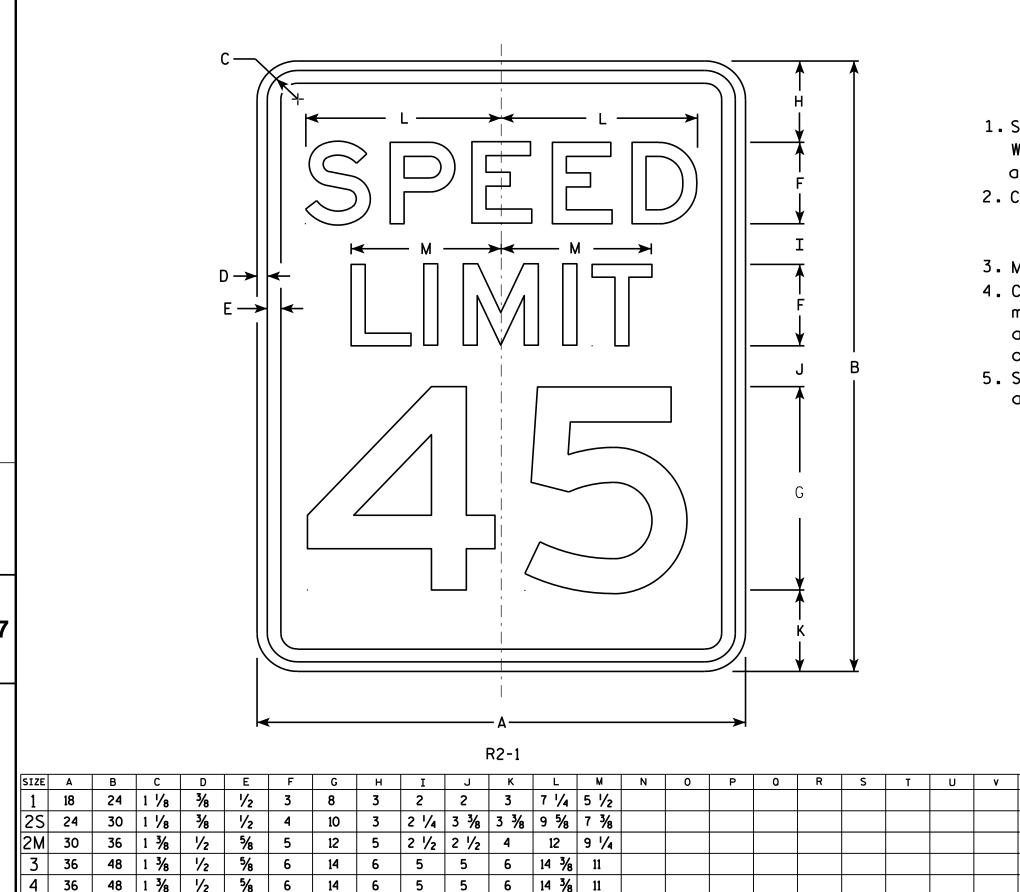

4 1/2 6 3/4 6 3/4 19 1/4 14 5/8

COUNTY:

20

HWY:

6

# NOTES

- 1. Sign is Type II Type H Reflective reference WIS DOT Standard Specification for HIGHWAY and STRUCTURE CONSTRUCTION latest edition.
- 2. Color:

Background - White Message - Black

- 3. Message Series E
- 4. Corners may be square or rounded when base material is plywood but borders shall be rounded as shown. When base material is metal. the corners and borders shall be rounded.
- 5. Substitute appropriate numerals and optically adjust spacing to achieve proper balance.

3.0

5.0

7.5

12.0

12.0

20.0

STANDARD SIGN R2-1

WISCONSIN DEPT OF TRANSPORTATION APPROVED

Matther R Raus For State Traffic Engineer PLATE NO. R2-1.13

DATE <u>5/26/1</u>0

SHEET NO:

2 1/4


60

5

48

PROJECT NO:


PLOT NAME :

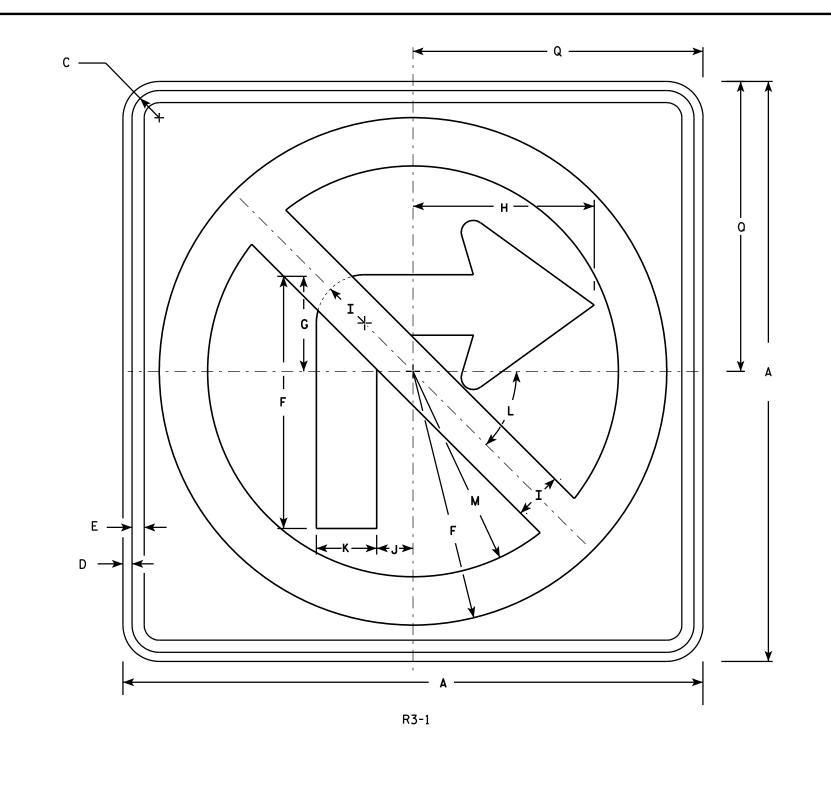

- 1. Sign is Type II Type H Reflective reference WIS DOT Standard Specification for HIGHWAY and STRUCTURE CONSTRUCTION latest edition.
- 2. Color:

Background - White Message - See note 4

- 3. Corners may be square or rounded when base material is plywood but borders shall be rounded as shown. When base material is metal, the corners and borders shall be rounded.
- 4. Border & Arrow are non reflective black, the circle with diagonal bar is reflective red.

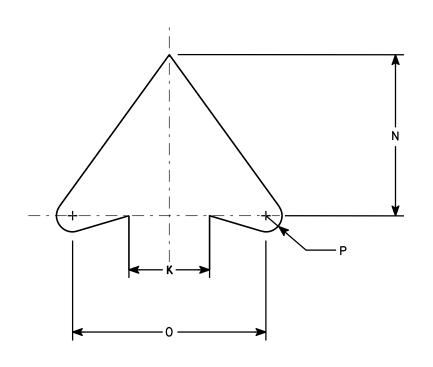

#### ARROW DETAIL

PLOT NAME :

SIZE	Α	В	С	D	E	F	G	Н	I	J	K	L	M	N	0	Р	0	R	S	T	U	V	W	Х	Y	Z	Area sq. ft.
1	24		1 1/8	3/8	1/2	10 1/2	4	7 1/2	2	1 1/2	2 1/2	45	8 1/2	5	6	1/2	12										4.0
2S	24		1 1/8	3/8	1/2	10 1/2	4	7 1/2	2	1 1/2	2 1/2	45 <b>°</b>	8 ½	5	6	1/2	12										4.0
2M	36		1 %	5/8	3/4	15 ¾	6	11 1/4	3	2 1/4	3 3/4	45	12 3/4	7 1/2	9	3/4	18										9.0
3	36		1 %	5/8	3/4	15 3/4	6	11 1/4	3	2 1/4	3 3/4	45	12 3/4	7 1/2	9	3/4	18										9.0
4	36		1 %	5/8	3/4	15 3/4	6	11 1/4	3	2 1/4	3 3/4	45°	12 3/4	7 1/2	9	3/4	18										9.0
5	48		2 1/4	3/4	1	21	8	15	4	3	5	45°	17	10	12	1	24										16.0
PRO	JECT	NO:			·		ŀ	HWY:	·			·	СО	UNTY:			·			·		·	·			·	

STANDARD SIGN R3-1


WISCONSIN DEPT OF TRANSPORTATION

APPROVED Matther

DATE12/08/10

PLATE NO. \_\_R3-1.5


SHEET NO:

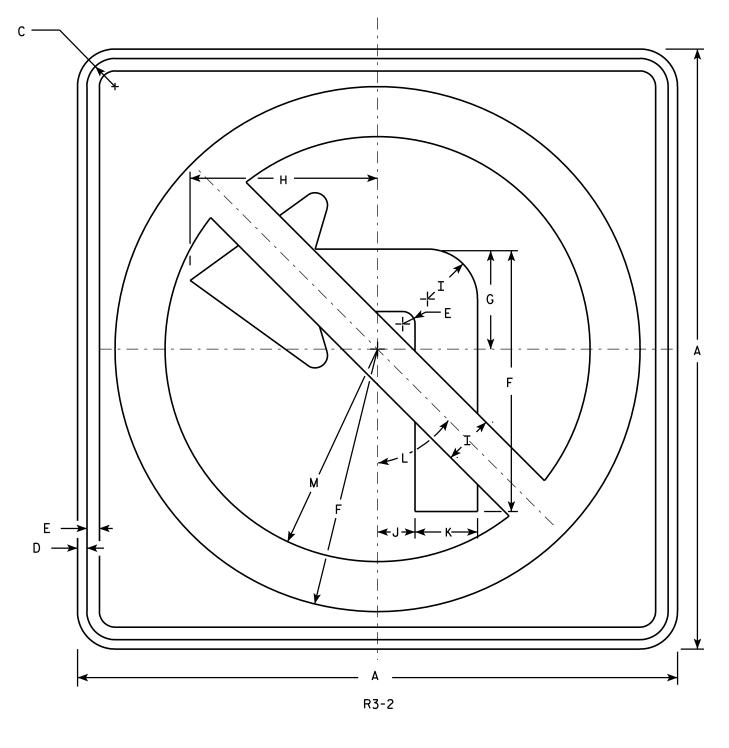

- 1. Sign is Type II Type H Reflective reference WIS DOT Standard Specification for HIGHWAY and STRUCTURE CONSTRUCTION latest edition.
- 2. Color:

Background - White Message - See note 4

- 3. Corners may be square or rounded when base material is plywood but borders shall be rounded as shown. When base material is metal, the corners and borders shall be rounded.
- 4. Border & Arrow are non reflective black, the circle with diagonal bar is reflective red.

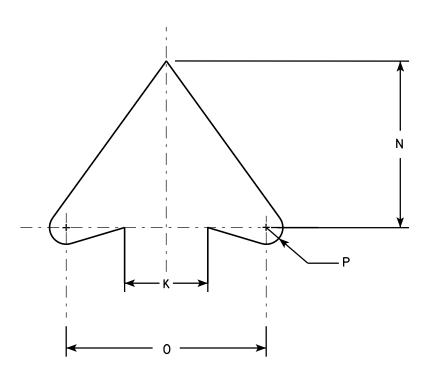

ARROW DETAIL

SIZE	Α	В	С	D	E	F	G	Н	I	J	K	L	M	N	0	Р	0	R	S	T	U	٧	₩	X	Y	Z	Area sq. ft.
1	24		1 1/8	3⁄8	1/2	10 1/2	4	7 1/2	2	1 1/2	2 1/2	45°	8 1/2	5	6	1/2											4.0
2S	24		1 1/8	3/8	1/2	10 1/2	4	7 1/2	2	1 1/2	2 1/2	45°	8 1/2	5	9	1/2											4.0
2M	36		1 1/8	5/8	3/4	15 3/4	6	11 1/4	3	2 1/4	3 3/4	45°	12 3/4	7 1/2	9	3/4											9.0
3	36		1 1/8	5/8	3/4	15 3/4	6	11 1/4	3	2 1/4	3 3/4	45°	12 3/4	7 1/2	9	3/4											9.0
4	36		1 1/8	5/8	3/4	15 3/4	6	11 1/4	3	2 1/4	3 3/4	45°	12 3/4	7 1/2	9	3/4											9.0
5	48		2 1/4	3/4	1	21	8	15	4	3	5	45°	17	10	12	1											16.0

COUNTY:

STANDARD SIGN R3-2

WISCONSIN DEPT OF TRANSPORTATION

APPROVED

 $f_{\it or}$  State Traffic Engineer

DATE 12/08/10

PLATE NO. R3-2.10

SHEET NO:

HWY:


PROJECT NO:

PLOT NAME :

- 1. Sign is Type II Type H Reflective reference WIS DOT Standard Specification for HIGHWAY and STRUCTURE CONSTRUCTION latest edition.
- 2. Color:

Background - White Message - Black

- 3. Message Series E
- 4. Corners may be square or rounded when base material is plywood but borders shall be rounded as shown. When base material is metal, the corners and borders shall be rounded.

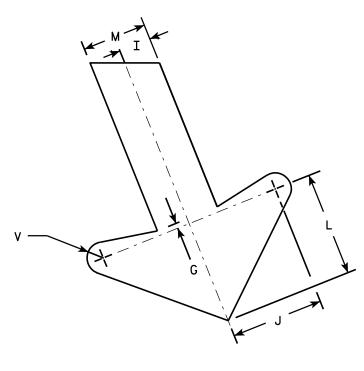

ARROW DETAIL
--------------

SIZE	Α	В	С	D	Ε	F	G	Н	I	J	K	L	М	N	0	Р	0	R	S	T	U	٧	W	Х	Y	Z	Areg sq. ft.
1																									1		
25	24	36	1 1/8	3/8	1/2	4	1/4	2 1/2	1	2 1/8	2 5/8	3 1/4	2	1 1/2	7 1/4	7 1/2		8 1/8	7 5/8	8	22°	1/2	9 1/2				6.0
2M	24	36	1 1/8	3/8	1/2	4	1/4	2 1/2	1	2 1/8	2 5/8	3 1/4	2	1 1/2	7 1/4	7 1/2		8 1/8	7	8	22°	1/2	9 1/2				6.0
3	36	54	1 3/4	1/2	5/8	6	3/8	3 3/4	1 1/2	4 1/4	4	4 %	3	2 1/4	10 %	11 1/4		12 1/4	11 1/2	12	22°	3/4	13 1/4				13.5
4																											
5																											

COUNTY:

R3-20L

HWY:

М

М

0

STANDARD SIGN R3-20L

WISCONSIN DEPT OF TRANSPORTATION

APPROVED For State Traffic Engineer

DATE 10/18/10 PLATE NO. R3-20L.7 SHEET NO:

PLOT BY: dotsja

PLOT NAME :

PLOT SCALE: 5.959043:1.000000

WISDOT/CADDS SHEET 42

FILE NAME : C:\Users\PROJECTS\tr\_stdplate\R320L.DGN


PROJECT NO:

PLOT DATE: 15-OCT-2010 14:45

- 1. Sign is Type II Type H Reflective reference WIS DOT Standard Specification for HIGHWAY and STRUCTURE CONSTRUCTION latest edition. material is plywood but borders shall be rounded
- 2. Color:

Background - White Message - Black

- 3. Corners may be square or rounded when base as shown. When base material is metal, the corners and borders shall be rounded.
- 4. R4-8 is the same as R4-7 except Legend is reversed.

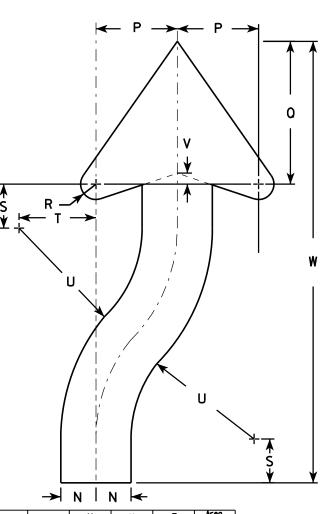

ARROW DETAIL

																							<b>→</b>	N I	N <del> </del>		
SIZE	Α	В	С	D	Ε	F	G	Н	I	J	K	L	M	N	0	Р	0	R	S	Т	U	٧	W	X	Y	Z	Arec sq. f
1	18	24	1 1/8	3∕8	1/2	3 %	4 3/4	5 1/2	1 3/8	2 1/4	6	3	9 3/8	1 1/2	22 1/2	3 1/2	6 1/8	5%	1 %	3 1/4	6 3/4	1/2	20 3/8				3.0
25	24	30	1 1/8	3/8	1/2	4 1/2	6 1/4	7 3/8	1 %	3	8	4	12 1/2	2	30	4 %	8 1/8	<b>7/8</b>	2 1/2	4 3/8	9	5/8	25 1/8				5.0
2N	24	30	1 1/8	3/8	1/2	4 1/2	6 1/4	7 3/8	1 1/8	3	8	4	12 1/2	2	30	4 %	8 1/8	<b>7</b> ⁄8	2 1/2	4 3/8	9	5/8	25 1/8				5.0
3	36	48	1 3/4	1/2	5/8	6 3/4	9 3/8	11 1/8	2 1/8	4 1/2	12	6	18 3/4	3	45	6 %	12 1/4	1 1/4	3 3/4	6 %	13 1/2	1	40 3/4				12.0
4	36	48	1 3/4	1/2	5/8	6 3/4	9 3/8	11 1/8	2 1/8	4 1/2	12	6	18 3/4	3	45	6 %	12 1/4	1 1/4	3 3/4	6 %	13 1/2	1	40 3/4				12.
5	48	60	2 1/4	3/4	1	9	12 1/2	14 3/4	3 3/4	6	16	8	25	4	60	9 1/4	16 1/4	1 %	5	8 ¾	18	1 1/4	50 1/4				20.

COUNTY:

R4-7

STANDARD SIGN R4-7 & R4-8

WISCONSIN DEPT OF TRANSPORTATION

APPROVED

State Traffic Engineer
3/25/2011 PLATE NO. R4-

DATE 3/25/2011 PLATE NO. R4-7.8


SHEET NO:

PROJECT NO:

D→

HWY:


PLOT BY: mscsja

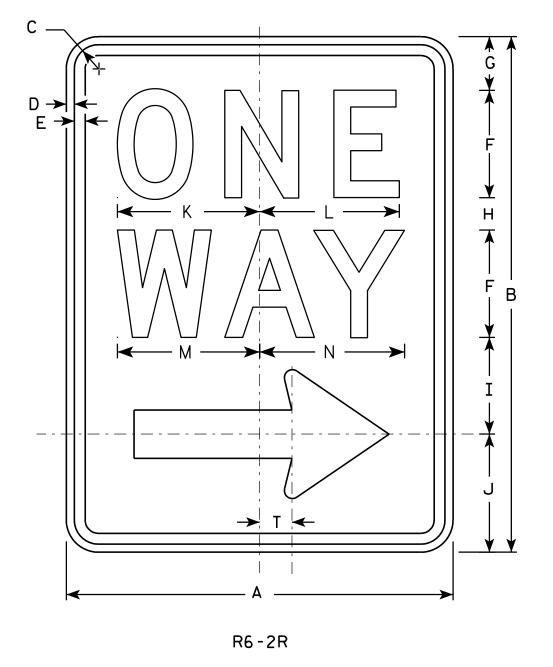

- 1. Sign is Type II Type H Reflective reference WIS DOT Standard Specification for HIGHWAY and STRUCTURE CONSTRUCTION latest edition.
- 2. Color:

Background - White Message - Black

- 3. Message Series D
- 4. Corners may be square or rounded when base material is plywood but borders shall be rounded as shown. When base material is metal, the corners and borders shall be rounded.
- 5. R6-2L same as R6-2R except arrow points to the left.

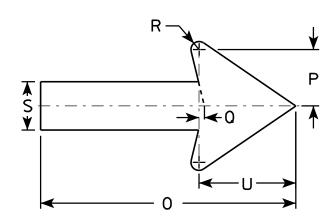

SIZE	A	В	С	D	E	F	G	Н	I	J	K	L	М	N	0	Р	0	R	S	T	U	٧	W	X	Y	Z
1	18	24	1 1/8	3/8	1/2	5	2 1/2	1 1/2	4 1/2	5 ½	6 %	6 1/2	6 %	6 3/4	11 1/8	2 %	1/4	3/8	2 1/4	1 1/2	4 1/2					
2S	24	30	1 1/8	3/8	1/2	6	3	2 1/2	5 1/2	7	8 1/8	8 1/8	8 1/2	8 %	16	3 1/2	3/8	1/2	3	2	6					
2M	30	36	1 3/8	1/2	5/8	8	2 1/2	2	6 %	8	10 1/2	10 1/2	11 1/4	11 1/4	20	4 3/8	1/2	5/8	3 3/4	2 1/2	7 1/2					
3	36	48	1 1/8	1/2	5/8	10	5 1/4	3 1/4	9	10 1/2	12 3/4	12 3/4	13 1/4	13 1/2	24	5 %	1/2	3/4	4 3/4	3	9					
4	36	48	1 1/8	1/2	5/8	10	5 1/4	3 1/4	9	10 1/2	12 3/4	12 3/4	13 1/4	13 1/2	24	5 %	1/2	3/4	4 3/4	3	9					
5																										

COUNTY:

STANDARD SIGN R6-2 R&L

WISCONSIN DEPT OF TRANSPORTATION

APPROVED

For State Traffic Engineer

DATE 11/2/10

PLATE NO. R6-2.8 SHEET NO:

FILE NAME : C:\Users\PROJECTS\tr\_stdplate\R62.DGN

HWY:

PROJECT NO:

PLOT DATE: 02-NOV-2010 15:25

PLOT BY: ditjph


PLOT NAME :

PLOT SCALE: 4.469282:1.000000

- 1. Sign is Type II Type H Reflective reference WIS DOT Standard Specification for HIGHWAY and STRUCTURE CONSTRUCTION latest edition.
- 2. Color:

Background - White Message - Black

- 3. Message Series C
- 4. Corners may be square or rounded when base material is plywood but borders shall be rounded as shown. When base material is metal, the corners and borders shall be rounded.

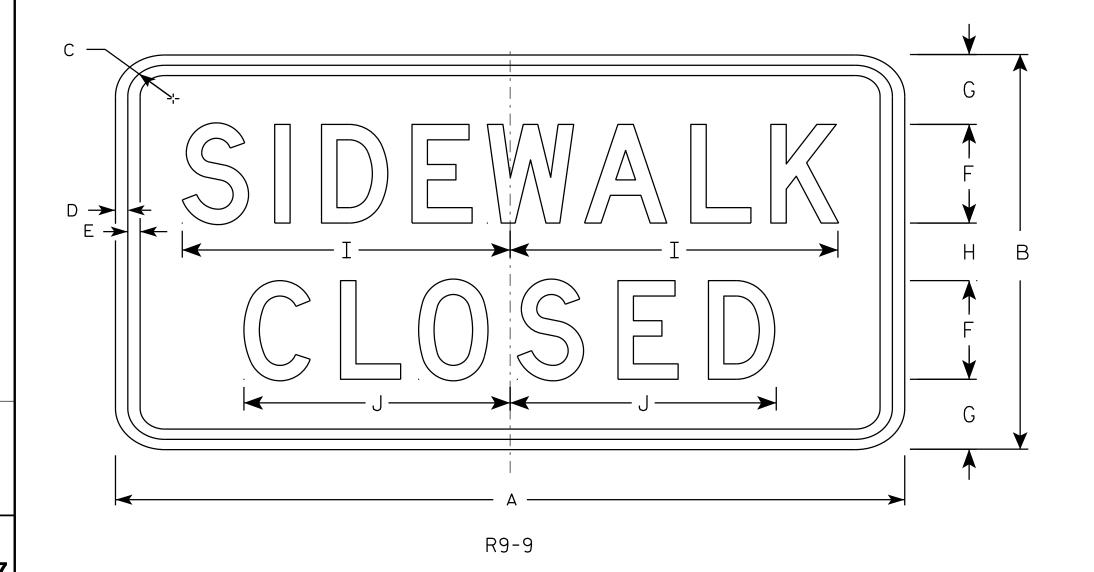

SIZE	Α	В	С	D	Е	F	G	H	I	J	K	L	М	N	0	Р	0	R	S	Т	J	٧	W	X	Y	Z	Area sq. ft.
1																											
2S	24	12	1 3/4	1/2	1/2	3	2 1/8	1 3/4	10	8 1/8																	2.0
2M	24	12	1 3/4	1/2	1/2	3	2 1/8	1 3/4	10	8 1/8																	2.0
3	30	18	1 3/4	1/2	1/2	4	3 1/2	3	12 1/2	10 1/4																	3.75
4																											
5																											

COUNTY:

STANDARD SIGN R9-9

WISCONSIN DEPT OF TRANSPORTATION

APPROVED

Matthew & Rain

DATE 3/10/16 PLATE NO. R9-9.6

SHEET NO:

FILE NAME : C:\CAEFiles\Projects\tr\_stdplate\R99.DGN

HWY:

PROJECT NO:

PLOT DATE: 10-MAR-2016 15:44

PLOT NAME :

PLOT BY: mscsja


WISDOT/CADDS SHEET 42

PLOT SCALE : 2.918761:1.000000

- 1. Sign is Type II Type H Reflective reference WIS DOT Standard Specification for HIGHWAY and STRUCTURE CONSTRUCTION latest edition.
- 2. Color:

Background - White Message - Black

- 3. Message Series C except Size 1 is Series D
- 4. Corners may be square or rounded when base material is plywood but borders shall be rounded as shown. When base material is metal, the corners and borders shall be rounded.

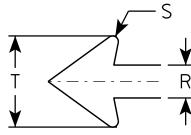

	y S	
<u></u>		
Ţ	R	

R	9	_	1	1	

[CTTE]	•		_	_					_		12		1.4	A :	_	_	_		_					v		7	Area
SIZE	Α	В	L	U	L	F	l G	Н	1	J	K	L	М	N	0	Р	0	R	>	l	U	V	W		Ť		Area sq. ft.
1																											
25	24	12	1 1/8	3⁄8	3/8	1 1/2	1 1/2	1 1/2	9 3/4	5/8	1 1/2	7	3 ½	9 1/4	6 <del>%</del>	5 /8		1	1/8	2 3/4							2.0
2M	24	12	1 1/8	3/8	3/8	1 1/2	1 1/2	1 1/2	9 3/4	5/8	1 1/2	7	3 ½	9 1/4	6 %	5 1/8		1	1/8	2 3/4							2.0
3	48	30	2 3/4	3/4	3/4	4	2 1/2	3 ½	20 ½	1 1/4	3	16 3/8	7 1/4	18 ½	14	11 1/8		2	3/8	5 ½							10.0
4																											
5																											

COUNTY:

STANDARD SIGN R9-11

WISCONSIN DEPT OF TRANSPORTATION

APPROVED

PLATE NO. R9-11.3

DATE 3/10/16

SHEET NO:

FILE NAME : C:\CAEFiles\Projects\tr\_stdplate\R911.DGN

PROJECT NO:

HWY:


 $D \rightarrow$ 

PLOT DATE: 10-MAR-2016 14:57

PLOT NAME :

PLOT BY: mscsja

PLOT SCALE: 5.837529:1.000000

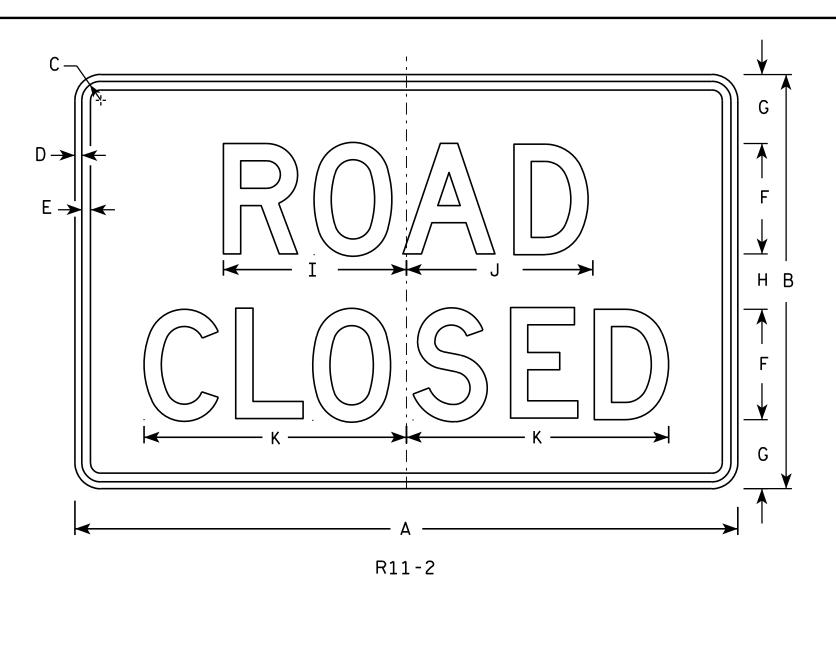



# <u>NOTES</u>

- 1. Sign is Type II Type H Reflective reference WIS DOT Standard Specification for HIGHWAY and STRUCTURE CONSTRUCTION latest edition.
- 2. Color:

Background - White Message - Black

- 3. Message Series D
- 4. Corners may be square or rounded when base material is plywood but borders shall be rounded as shown. When base material is metal, the corners and borders shall be rounded.
- 5. Modify the message as required.

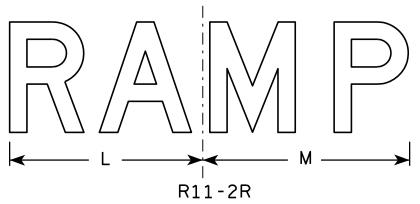

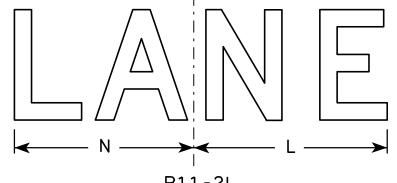

R	1	1	-	2	L

PLOT NAME :

SIZ	Έ	A	В	С	D	Ε	F	G	Н	I	J	K	L	M	N	0	Р	0	R	S	T	U	V	W	X	Y	Z	Area sq. ft.
1																												
2	S	48	30	1 3/8	1/2	5/8	8	5	4	13 1/4	13 1/2	19	14	15	13													10.0
21	<b>I</b>	48	30	1 3/8	1/2	5/8	8	5	4	13 1/4	13 ½	19	14	15	13													10.0
3		48	30	1 3/8	1/2	5/8	8	5	4	13 1/4	13 1/2	19	14	15	13													10.0
4		48	30	1 3/8	1/2	5/8	8	5	4	13 1/4	13 1/2	19	14	15	13													10.0
5		48	30	1 3/8	1/2	5/8	8	5	4	13 1/4	13 ½	19	14	15	13													10.0

COUNTY:

STANDARD SIGN R11-2


WISCONSIN DEPT OF TRANSPORTATION

DATE 4/1/11 PLATE NO. R11-2.10

SHEET NO:

HWY:


PROJECT NO:

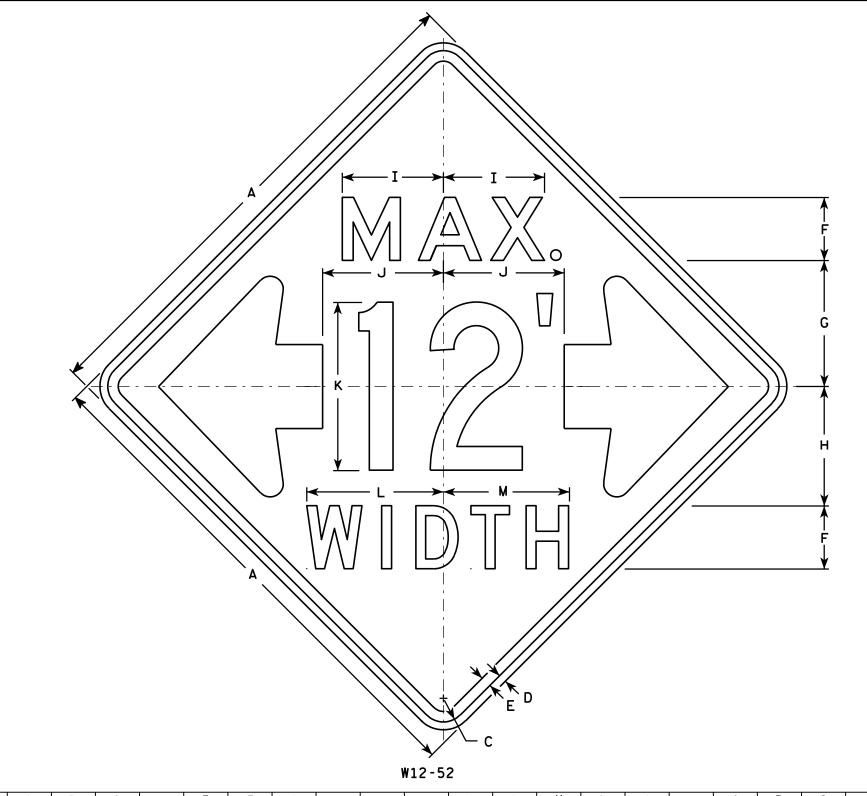

- 1. Sign is Type II Type F Reflective reference WIS DOT Standard Specification for HIGHWAY and STRUCTURE CONSTRUCTION latest edition.
- 2. Color:

Background - Orange Message - Black

- 3. Message Series See note 5
- 4. Corners may be square or rounded when base material is plywood but borders shall be rounded as shown. When base material is metal, the corners and borders shall be rounded.
- 5. The top line is series E, the numerals are series C, and the bottom line is series D.
- 6. Substitute appropriate numerals and adjust spacing as required.

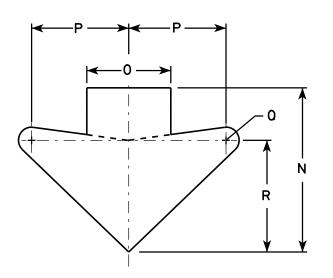

ARROW DETAIL

CT TE			T					ш			1/		1.4		_		_		_					· ·	·	7	Area
SIZE	Α	В	L	ט	-	-	G	Н	l I	J	K	L	M	N	U	P	U	R	>	1	U	V	W	X	T		Area sq. ft.
1																											
25	48		2 1/4	₹4	1	6	12	11 3/8	9 %	11 1/2	16	13	12	15 %	8	9 1/4	1 1/4	10 %									16.0
2M	48		2 1/4	₹4	1	6	12	11 3/8	9 %	11 1/2	16	13	12	15 5/8	8	9 1/4	1 1/4	10 %									16.0
3																											
4																											
5																											

COUNTY:

STANDARD SIGN W12-52

WISCONSIN DEPT OF TRANSPORTATION

APPROVED

For State Traffic Engineer


DATE 3/16/11 PLATE NO. W12-52.7

SHEET NO:

HWY:

PROJECT NO:


PLOT NAME :

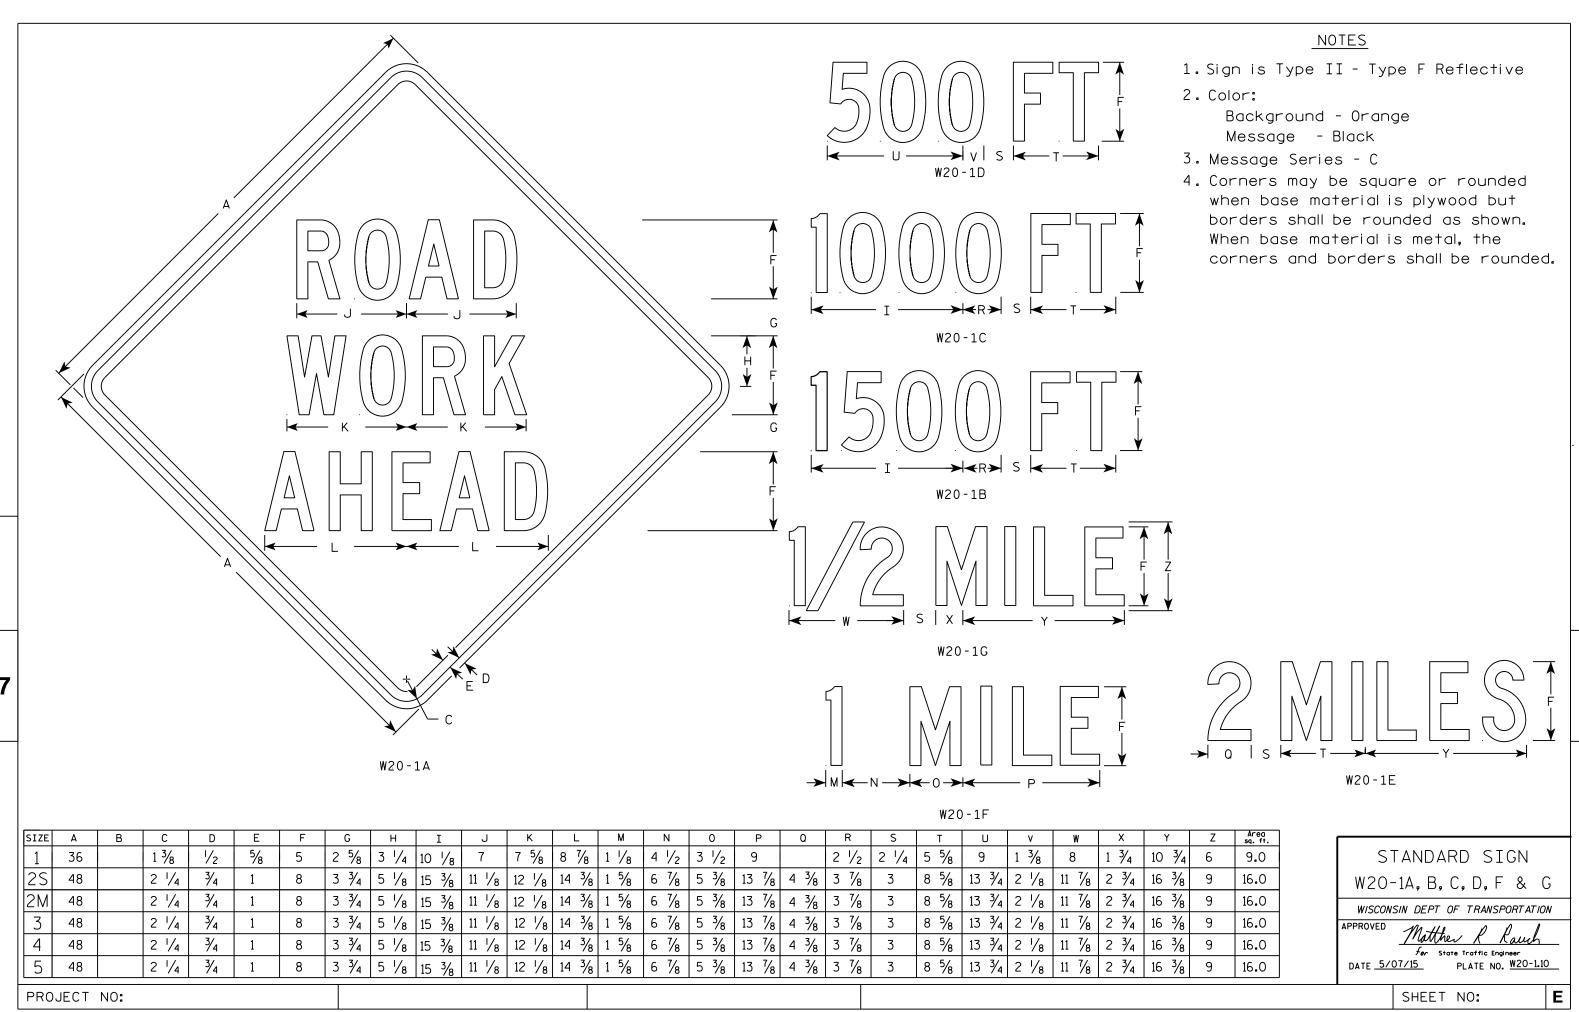


FILE NAME . C.\CAFfiles\Projects\tr stdolote\W201 DCN


PLOT DATE . 01-DEC-2015 18.24


PIOT RY \* \$\$ plotuser \$\$

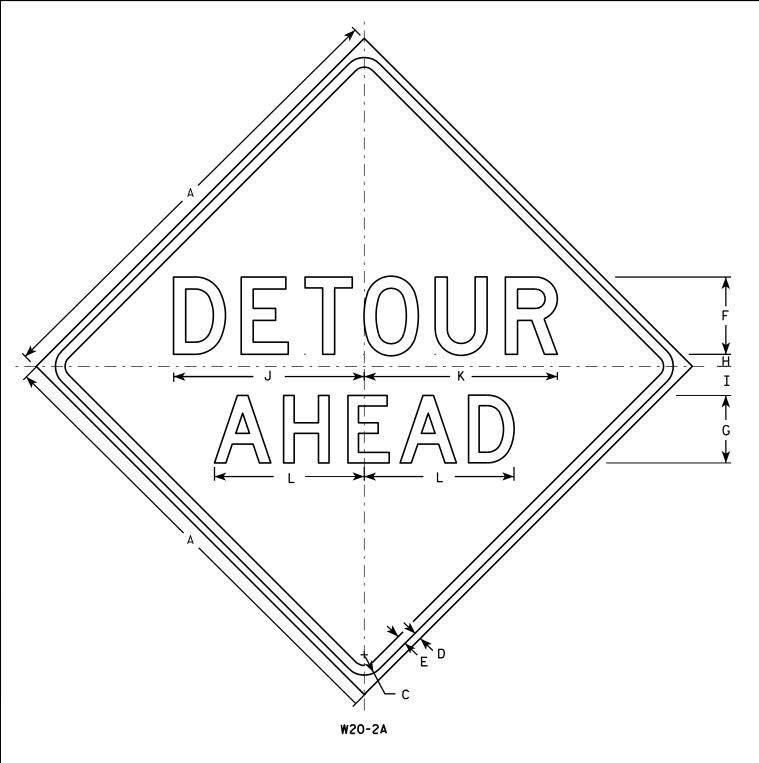



HWY:

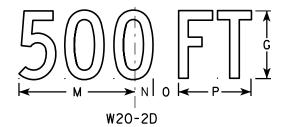

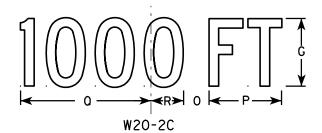

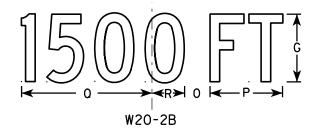

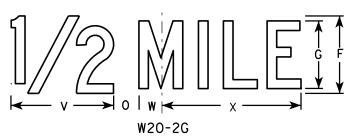

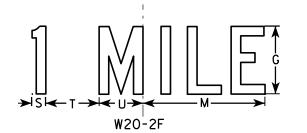

PLOT BY: mscj9h

# **NOTES**

- Sign is Type II Type F Reflective reference WIS DOT Standard Specification for HIGHWAY and STRUCTURE CONSTRUCTION latest edition.
- 2. Color:

Background - Orange Message - Black

- 3. Message Series See note 5
- 4. Corners may be square or rounded when base material is plywood but borders shall be rounded as shown. When base material is metal, the corners and borders shall be rounded.
- 5. Line 1 is Series D.
  Line 2 is Series D for AHEAD and
  Series C for all other distances.

SIZE	. Α	В	С	D	E	F	G	Н	I	J	K	L	М	N	0	Р	0	R	S	T	U	٧	W	X	Y	Z	Area sq. ft.
1	36		1 1/8	5/8	3/4	6	5	1	2 1/4	14 3/4	15	11 5/8	9	1 3/8	1 1/8	5 %	10 1/8	2 1/2	1 1/8	4 1/2	3 1/2	8	1 3/4	10 3/4			9.0
2S	48		2 1/4	3/4	1	8	7	1 1/4	3	19 ¾	20	15 1/2	12	1 1/8	2 %	7 1/2	13 1/2	3 3/8	1 1/2	6	4 %	10 %	2 3/8	14 3/8			16.0
2M	48		2 1/4	3/4	1	8	7	1 1/4	3	19 3/4	20	15 1/2	12	1 1/8	2 %	7 1/2	13 1/2	3 3/8	1 1/2	6	4 %	10 %	2 3/8	14 3/8			16.0
3	48		2 1/4	₹4	1	8	7	1 1/4	3	19 ¾	20	15 1/2	12	1 1/8	2 %	7 1/2	13 1/2	3 %	1 1/2	6	4 %	10 %	2 3/8	14 3/8			16.0
4	48		2 1/4	₹4	1	8	7	1 1/4	3	19 ¾	20	15 1/2	12	1 1/8	2 %	7 1/2	13 1/2	3 %	1 1/2	6	4 %	10 %	2 3/8	14 3/8			16.0
5	48		2 1/4	3/4	1	8	7	1 1/4	3	19 ¾	20	15 1/2	12	1 1/8	2 5/8	7 1/2	13 1/2	3 3/8	1 1/2	6	4 5/8	10 %	2 3/8	14 3/8	·		16.0

COUNTY:


STANDARD SIGN W20-2A,B,C,D,F & G

WISCONSIN DEPT OF TRANSPORTATION

DATE 3/18/11 PLATE NO. W20-2.6

SHEET NO:

PROJECT NO:

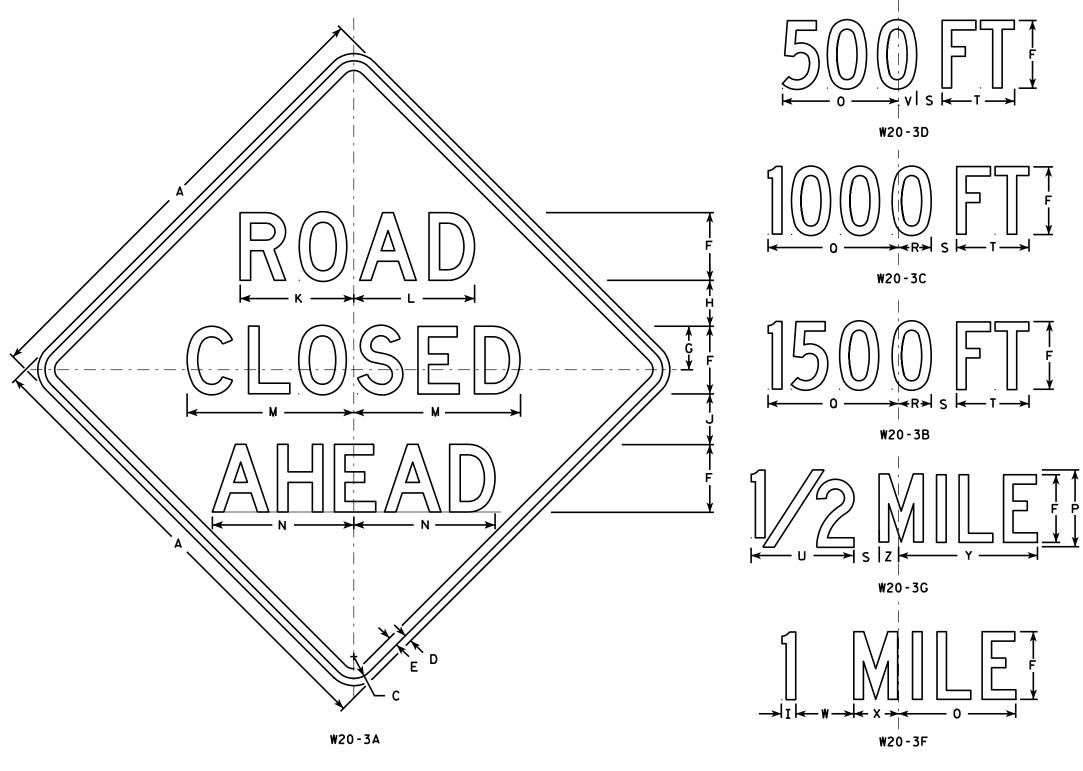

- 1. Sign is Type II Type F Reflective reference WIS DOT Standard Specification for HIGHWAY and STRUCTURE CONSTRUCTION latest edition.
- 2. Color:

Background - Orange Message - Black

- 3. Message Series see note 5
- 4. Corners may be square or rounded when base material is plywood but borders shall be rounded as shown. When base material is metal, the corners and borders shall be rounded.
- 5. Lines 1 and 2 are Series D. Line 3 is Series D for AHEAD and Series C for all other distances.

1 % 5/8 ¾ 8 3/8 8 7/8 12 1/2 5 % 1 3/8 4 1/2 36 3 1/2 10 3/4 1 3/4 8 4 \( \frac{5}{8} \) 14 \( \frac{3}{8} \) 2 \( \frac{3}{8} \) 16.0 3/4 1 1/2 | 5 1/4 | 11 3/4 | 12 1/2 | 17 1/4 | 14 5/8 | 7 1/2 10 5/8 1 7/8 2M 3/4 4 \\ 14 \\ 38 \ 2 \\ 38 \ 16.0 48 | 5 1/4 | 11 3/4 | 12 1/2 | 17 1/4 | 14 5/8 | 7 1/2 10 % 1 % 4 1/2 4 3/4 1 1/2 5 1/4 11 3/4 12 1/2 17 1/4 14 5/8 3/4 13 1/2 3 3/8 2 5/8 7 1/2 10 5/8 1 3/8 4 % | 14 % | 2 % | 16.0 48 3/4 4 1/2 4 3/4 1 1/2 5 1/4 11 3/4 12 1/2 17 1/4 14 5/8 13 1/2 3 3/8 2 5/8 4 \\ 14 \\ 38 \ 2 \\ 38 \ 16.0 7 1/2 10 5/8 1 7/8 48 5 4 5/8 14 3/8 2 3/8 16.0 3/4 2 1/4 4 1/2 | 4 3/4 | 1 1/2 | 5 1/4 | 11 3/4 | 12 1/2 | 17 1/4 | 14 5/8 | 13 1/2 3 3/8 2 5/8 7 1/2 10 5/8 1 3/8 48

COUNTY:

STANDARD SIGN W20-3A, B, C, D, F & G

WISCONSIN DEPT OF TRANSPORTATION

For State Traffic Engineer DATE 3/18/11

PLATE NO. W20-3.7

SHEET NO:

PROJECT NO: FILE NAME : C:\Users\PROJECTS\tr\_stdplate\W203.DGN HWY:

PLOT DATE: 18-MAR-2011 12:08

PLOT BY: mscj9h

PLOT NAME :

PLOT SCALE: 9.931739:1.000000

- 1. Sign is Type II Type F Reflective reference WIS DOT Standard Specification for HIGHWAY and STRUCTURE CONSTRUCTION latest edition.
- 2. Color:

Background - Orange Message - Black

- 3. Message Series See Note 5
- 4. Corners may be square or rounded when base material is plywood but borders shall be rounded as shown. When base material is metal, the corners and borders shall be rounded.
- 5. " \_\_\_\_\_ LANE" is Series B. All other copy is Series C.

W20-5D

W20-5B

W20-5G

PLOT BY: mscj9h

->IOI← R-		
	W20-5F	

								W20-	5 A																	11 2	20-56
SIZE	Α	В	С	D	E	F	G	Н	I	J	K	L	M	N	0	Р	0	R	S	Т	U	v	W	X	Y	Z	Area sq. ft.
1	36	6	1 5/8	5/8	3/4	5	<b>7/8</b>	2 1/2	13 1/8	10 ¾	9 1/2	14 1/4	13 %	12	12	1 3/8	1 1/8	4 1/2	3 1/2	9	1 1/8	5 %	10 1/8	2 1/2	1 3/4	8	9.0
2S	48	8	2 1/4	3/4	1	7	1 1/4	3 1/4	17 1/2	14 3/8	12 5/8	19	18 3/8	16	14 1/4	1 1/8	1 1/2	6	4 %	12	2 1/8	7 1/2	13 1/2	3 3/8	2 3/8	10 %	16.0
2M	48	8	2 1/4	3/4	1	7	1 1/4	3 1/4	17 1/2	14 3/8	12 5/8	19	18 3/8	16	14 1/4	1 1/8	1 1/2	6	4 %	12	2 5/8	7 1/2	13 1/2	3 %	2 3/8	10 %	16.0
3	48	8	2 1/4	3/4	1	7	1 1/4	3 1/4	17 1/2	14 3/8	12 %	19	18 3/8	16	14 1/4	1 %	1 1/2	6	4 %	12	2 5/8	7 1/2	13 1/2	3 3/8	2 3/8	10 %	16.0
4	48	8	2 1/4	3/4	1	7	1 1/4	3 1/4	17 1/2	14 3/8	12 %	19	18 3/8	16	14 1/4	1 %	1 1/2	6	4 5/8	12	2 %	7 1/2	13 1/2	3 ¾	2 3/8	10 %	16.0
5	48	8	2 1/4	3/4	1	7	1 1/4	3 1/4	17 1/2	14 3/8	12 %	19	18 3/8	16	14 1/4	1 1/8	1 1/2	6	4 %	12	2 %	7 1/2	13 1/2	3 <del>%</del>	2 3/8	10 %	16.0

COUNTY:

STANDARD SIGN W20-5A, B, C, D, F & G

WISCONSIN DEPT OF TRANSPORTATION

APPROVED Matthew R Kauch Fer State Traffic Engineer DATE 3/18/11 PLATE NO. W20-5.11

SHEET NO:

FILE NAME : C:\Users\PROJECTS\tr\_stdplate\W205.DGN

PROJECT NO:

HWY:


W20-56A

W20-55A

PLOT DATE: 18-MAR-2011 12:15

PLOT NAME :

PLOT SCALE: 11.918087:1.000000

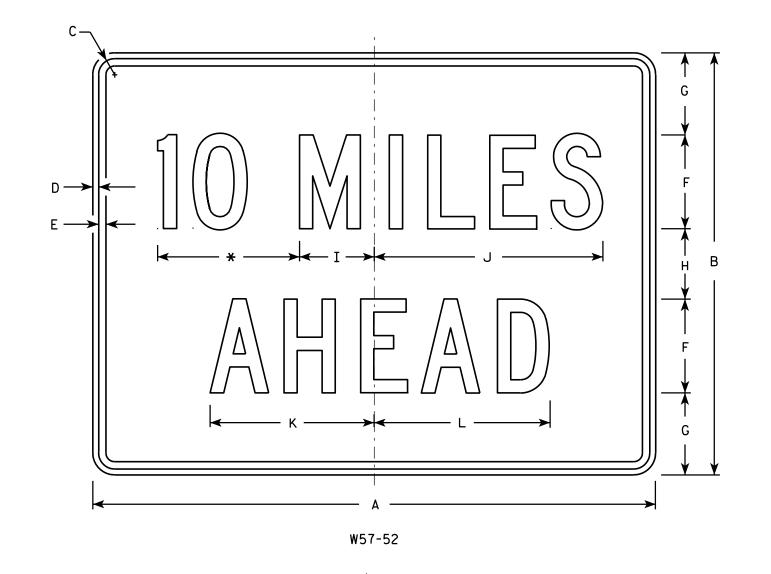

- 1. Sign is Type II Type F Reflective reference WIS DOT Standard Specification for HIGHWAY and STRUCTURE CONSTRUCTION latest edition.
- 2. Color:

Background - Yellow Message - Black

- 3. Message Series C
- 4. Corners may be square or rounded when base material is plywood but borders shall be rounded as shown. When base material is metal, the corners and borders shall be rounded.
- 5. Substitute appropriate numerals and optically adjust spacing to achieve proper balance.

\* See note 5

SIZE	Α	В	С	D	E	F	G	Н	I	J	K	L	M	N	0	Р	0	R	S	Т	U	٧	₩	Х	Y	Z	Area sq. ft.
1	24	18	1 1/8	3⁄8	1/2	4	3 1/2	3	3 1/8	9 3/4	7	7 1/2	1 3/8	8 3/4													3.0
2S	36	24	1 1/8	3/8	1/2	6	4 1/2	3	4 3/4	14 %	10 %	11 3/8	2	13													6.0
2M	36	24	1 1/8	3/8	1/2	6	4 1/2	3	4 3/4	14 %	10 %	11 3/8	2	13													6.0
3	36	24	1 1/8	3/8	1/2	6	4 1/2	3	4 3/4	14 %	10 %	11 3/8	2	13													6.0
4	48	36	1 3/8	1/2	5/8	8	7	6	6 3/8	19 1/2	14	15	2 3/4	17 3/8													12.0
5	48	36	1 3/8	1/2	5/8	8	7	6	6 3/8	19 1/2	14	15	2 3/4	17 3/8												·	12.0

STANDARD SIGN W57-52

WISCONSIN DEPT OF TRANSPORTATION

DATE 3/13/13 PLATE NO. W57-52.7

SHEET NO:

PROJECT NO:

HWY:

COUNTY:

PLOT DATE: 13-MAR-2013 14:11

PLOT BY: mscj9h

PLOT NAME :

PLOT SCALE: 8.187131:1.000000

- 1. Sign is Type II Type F Reflective reference WIS DOT Standard Specification for HIGHWAY and STRUCTURE CONSTRUCTION latest edition.
- 2. Color:

Background - Orange Message - Black

3. Corners may be square or rounded when base material is plywood but borders shall be rounded as shown. When base material is metal, the corners and borders shall be rounded.

	G
	_ <b>¥</b> B
W01-6	₩

SIZE	Α	В	С	D	E	F	G	Н	I	J	К	L	M	N	0	Р	0	R	S	Т	U	٧	W	Х	Y	Z	Area sq. ft.
1																											
2S	48	24	1 3/8	1/2	5/8		12	13 1/4	1	7 1/2	6 1/2	3 1/4	19 1/2	39													8.0
2M	48	24	1 3/8	1/2	5/8		12	13 1/4	1	7 1/2	6 1/2	3 1/4	19 1/2	39													8.0
3	60	30	1 3/8	1/2	5/8		15	16 1/4	1 1/4	9 1/4	8	4	24 3/8	48 3/4													12.5
4	60	30	1 3/8	1/2	5/8		15	16 1/4	1 1/4	9 1/4	8	4	24 3/8	48 ¾													12.5
5	60	30	1 3/8	1/2	5/8		15	16 1/4	1 1/4	9 1/4	8	4	24 3/8	48 ¾													12.5

COUNTY:

STANDARD SIGN WO1-6

WISCONSIN DEPT OF TRANSPORTATION

APPROVED

Matther R Rauch
For State Traffic Engineer

For State Traffic Engineer

13 PLATE NO. <u>W01-6.1</u>

DATE <u>11/18/13</u>

SHEET NO:

FILE NAME : C:\CAEfiles\Projects\tr\_stdplate\W016.DGN

HWY:

PROJECT NO:

PLOT DATE : 28-FEB-2014 11:37

PLOT NAME :


PLOT BY: mscj9h

PLOT SCALE: 5.837526:1.000000

- 1. Sign is Type II Type F Reflective reference WIS DOT Standard Specification for HIGHWAY and STRUCTURE CONSTRUCTION latest edition.
- 2. Color:

Background - Orange Message - Black

- 3. Corners may be square or rounded when base material is plywood but borders shall be rounded as shown. When base material is metal, the corners and borders shall be rounded.
- 4. W04-2L is the same as W04-2R except the symbolis reversed along the vertical centerline.

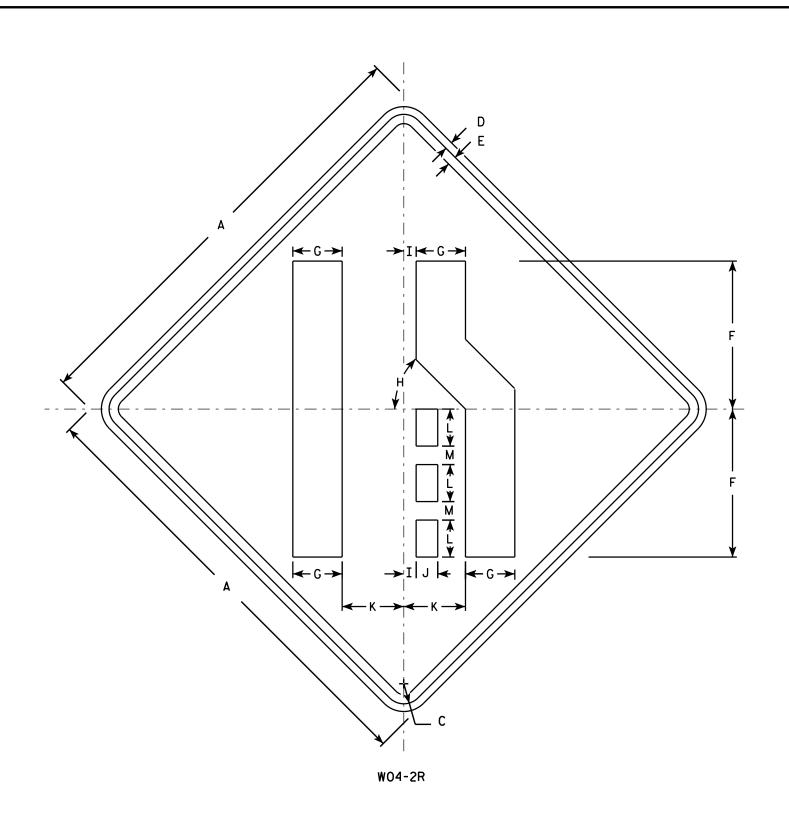

SIZE 1 % 5/8 3/4 12 45° 1 3/4 5 1 1/2 4 36 3 9.0 2S 2 1/4 5 3/8 45° 1 ¼ 2 ¾ 6 ¾ 3/4 48 16.0 45° 1 ¼ 2 ¾ 6 ¾ 3/4 5 3/8 48 2 1/4 2 16.0 2 1/4 3 48 3/4 5 % 45° | 1 1/4 | 2 3/8 | 6 3/4 2 16.0 2 1/4 3/4 5 3/8 45° | 1 1/4 | 2 3/8 | 6 3/4 48 2 16.0 5 2 1/4 3/4 5 3/8 45° | 1 1/4 | 2 3/8 | 6 3/4 48 2 16.0

STANDARD SIGN W04 - 2

WISCONSIN DEPT OF TRANSPORTATION

APPROVED

ForState Traffic Engineer

DATE 11/20/13 PLATE NO. <u>WO4-2.1</u>

SHEET NO:

FILE NAME : C:\CAEFiles\Projects\tr\_stdplate\W042.DGN

PROJECT NO:

PLOT DATE: 20-NOV-2013 11:43

Notes



# Wisconsin Department of Transportation

Dedicated people creating transportation solutions through innovation and exceptional service.

http://www.dot.wisconsin.gov