**DEC 2015** ORDER OF SHEETS PROJE Title Section No. 1 Section No. 2 Typical Sections and Details Estimate of Quantities Section No. 3 Miscellaneous Quantities Section No. 3 Right of Way Plat Section No. 4 Plan and Profile Section No. 5 (Includes Eroslon Control) Standard Detail Drawings Section No. 6 0 Sign Plates Section No. 7 0 Structure Plans Section No. 8 Computer Earthwork Data Section No. 9 Section No. 9 Cross Sections TOTAL SHEETS = 96 DESIGN DESIGNATION A.A.D.T. 2016 = 830 A.A.D.T. 2036 = 930 D.H.V. = 149 D.D. = 60/40 = 7% DESIGN SPEED = 55 MPH **ESALS** CONVENTIONAL SYMBOLS 又 分 PROFILE PLAN CORPORATE LIMITS GRADE LINE ORIGINAL GROUND PROPERTY LINE MARSH OR ROCK PROFILE LOT LINE SPECIAL DITCH LIMITED HIGHWAY EASEMENT EXISTING RIGHT OF WAY GRADE ELEVATION PROPOSED OR NEW R/W LINE 刀 CULVERT (Profile View) SLOPE INTERCEPT UTILITIES REFERENCE LINE **ELECTRIC** EXISTING CULVERT FIBER OPTIC PROPOSED CULVERT GAS (Box or Pipe) SANITARY SEWER COMBUSTIBLE FLUIDS STORM SEWER TELEPHONE WATER MARSH AREA UTILITY PEDESTAL POWER POLE Ġ WOODED OR SHRUB AREA TELEPHONE POLE ø

## STATE OF WISCONSIN DEPARTMENT OF TRANSPORTATION


PLAN OF PROPOSED IMPROVEMENT

## STEUBEN - BOSCOBEL

PLEASANT MOUND ROAD TO STH 60

CTH E

CRAWFORD COUNTY

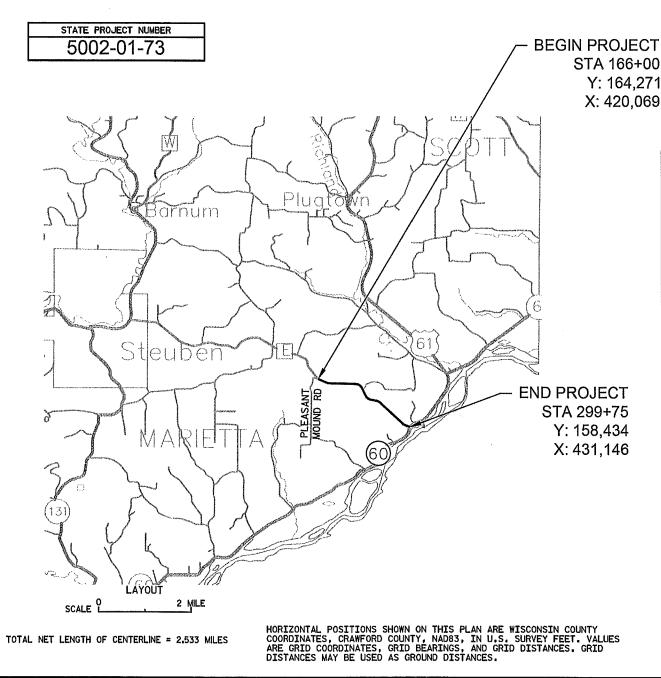

FEDERAL PROJECT STATE PROJECT PROJECT CONTRACT 5002-01-73 WISC 2015634

> ACCEPTED FOR CRAWFORD COUNTY

COMMINISSIONS ER. (Title of Official)

ORIGINAL PLANS PREPARED BY

MOYER E-39623 SHEBOYGAN:

STATE OF WISCONSIN DEPARTMENT OF TRANSPORTATION

REPARED BY

RIVER VALLEY LAND SURVEYING Surveyor DONOHUE & ASSOCIATES, INC.

Consultant

FILE NAME : L:\PROJECTS\12737\D\WG\50020103\SHEETSOTHER\010101\_TI.D\WG

PLOT DATE : 7/15/2015 7:31 AM

PLOT BY : MOYER, TIM

PLOT NAME :

WISDOT/CADDS SHEET 10

FACILITY TYPE: ELECTRIC CITY OF BOSCOBEL DEPARTMENT OF PUBLIC WORKS MICHAEL B. REYNOLDS CITY ENGINEER / DIRECTOR OF PUBLIC WORKS 1006 WISCONSIN AVENUE

BOSCOBEL, WI 53805 PHONE: 608-375-5030

EMAIL: MREYNOLDS@WPPIENERGY.ORG

FACILITY TYPE: COMMUNICATIONS CENTURYLINK STEVE NELSON 333 N FRONT STREET PO BOX 4800 LACROSSE, WI 54602 PHONE: 608-796-7033

EMAIL: STEVE.NELSON@CENTURYLINK.COM

FACILITY TYPE: ELECTIRC SCENIC RIVERS ENERGY COOPERATIVE ANDY KILCOYNE 231 N SHERIDAN STREET LANCASTER, WI 53813-1342 PHONE: 608-723-2121 EXT. 568 EMAIL: AKILCOYNE@SREC.NET

\*\*\* DENOTES UTILITIES THAT ARE NOT DIGGER'S HOTLINE MEMBERS.

#### **GENERAL NOTES:**

THE LOCATIONS OF EXISTING UTILITY INSTALLATIONS AS SHOWN ON THE PLANS ARE APPROXIMATE. THERE MAY BE OTHER UTILITY INSTALLATIONS WITHIN THE PROJECT AREA THAT ARE NOT SHOWN. CONTACT DIGGERS HOTLINE PRIOR TO THE START OF CONSTRUCTION ACTIVITIES. THE CONTRACTOR IS RESPONSIBLE FOR CONTACTING ANY OTHER UTILITIES.

NO TREES OR SHRUBS ARE TO BE REMOVED WITHOUT APPROVAL OF THE ENGINEER.

THE ENGINEER WILL DETERMINE ANY DETAILS OF CONSTRUCTION NOT SHOWN ON THE PLAN.

EROSION CONTROL IS SHOWN ON THE PLAN SHEETS AND IN THE SUMMARY OF MISCELLANEOUS QUANTITIES.

RESTORE ALL DISTURBED AREAS WITH TOPSOIL, SEED, FERTILIZER AND MULCH.

ALL POSTS FOR MGS GUARDRAIL SHALL BE STEEL EXCEPT FOR WITHIN THE LIMITS OF THE ENERGY ABSORBING TERMINAL.

DO NOT PLACE PERMANENT PAVEMENT MARKINGS FOR A MINIMUM OF 5 WORKING DAYS AFTER SEAL COAT HAS BEEN PLACED.

PLACE 3 1/2-INCH ASPHALTIC SURFACE FOR PAVED SHOULDERS IN TWO LIFTS WITH TACK COAT BETWEEN. EACH LIFT SHALL BE 1 3/4-INCH.

#### PROJECT CONTACT INFORMATION:

#### DNR CONTACT

KAREN KALVELAGE LACROSSE SERVICE CENTER 3550 MORMON COULEE ROAD LACROSEE. WI 54601 (608) 785-9115 KAREN.KALVELAGE@WISCONSIN.GOV

#### CRAWFORD COUNTY CONTACT

DENNIS PELOCK CRAWFORD COUNTY HIGHWAY COMMISSIONER 21515 STATE HIGHWAY 27, PO BOX 39 SENECA, WI 54654 (608) 734-9500 CCOMMISH@CENTURYTEL.NET

#### DESIGNER CONTACT

TIMOTHY MOYER, PE DONOHUE & ASSOCIATES, INC 3311 WEEDEN CREEK ROAD SHEBOYGAN. WI 53081 (920) 803-7380 TMOYER@DONOHUE-ASSOCIATES.COM



PROJECT NO: 5002-01-73

HWY: CTH E

COUNTY: CRAWFORD


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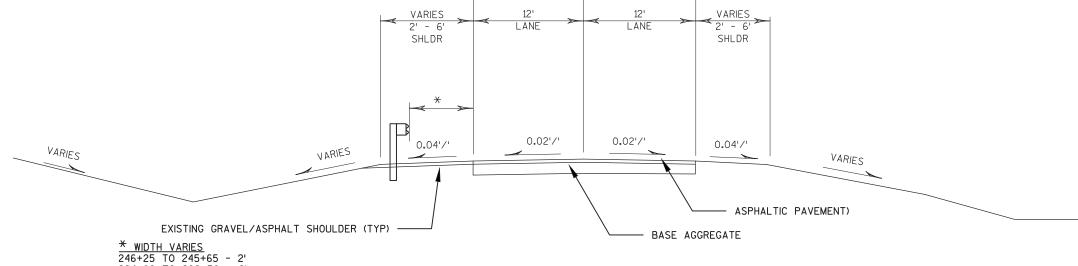
SHEET

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FILE NAME : L:\PROJECTS\12737\DWG\50020103\SHEETSOTHER\020101\_GN.DWG

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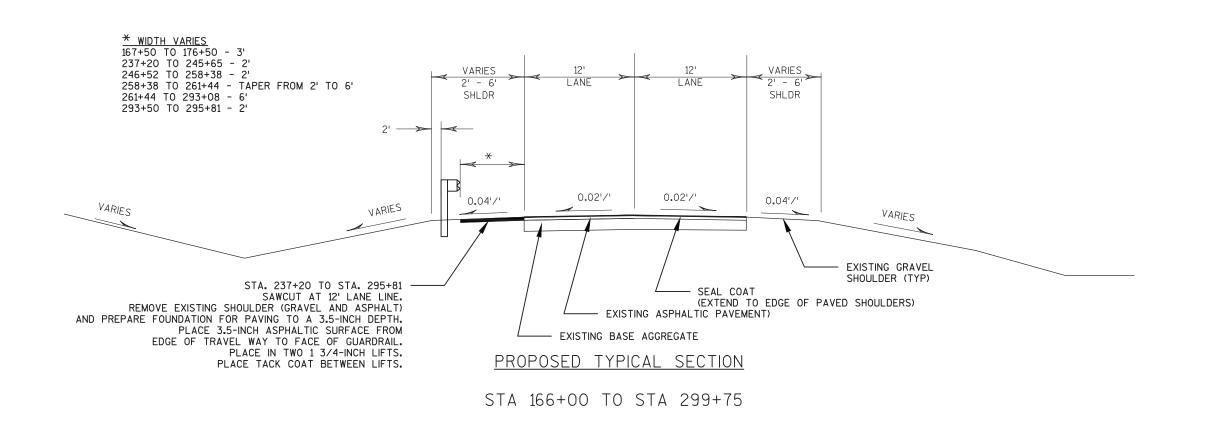





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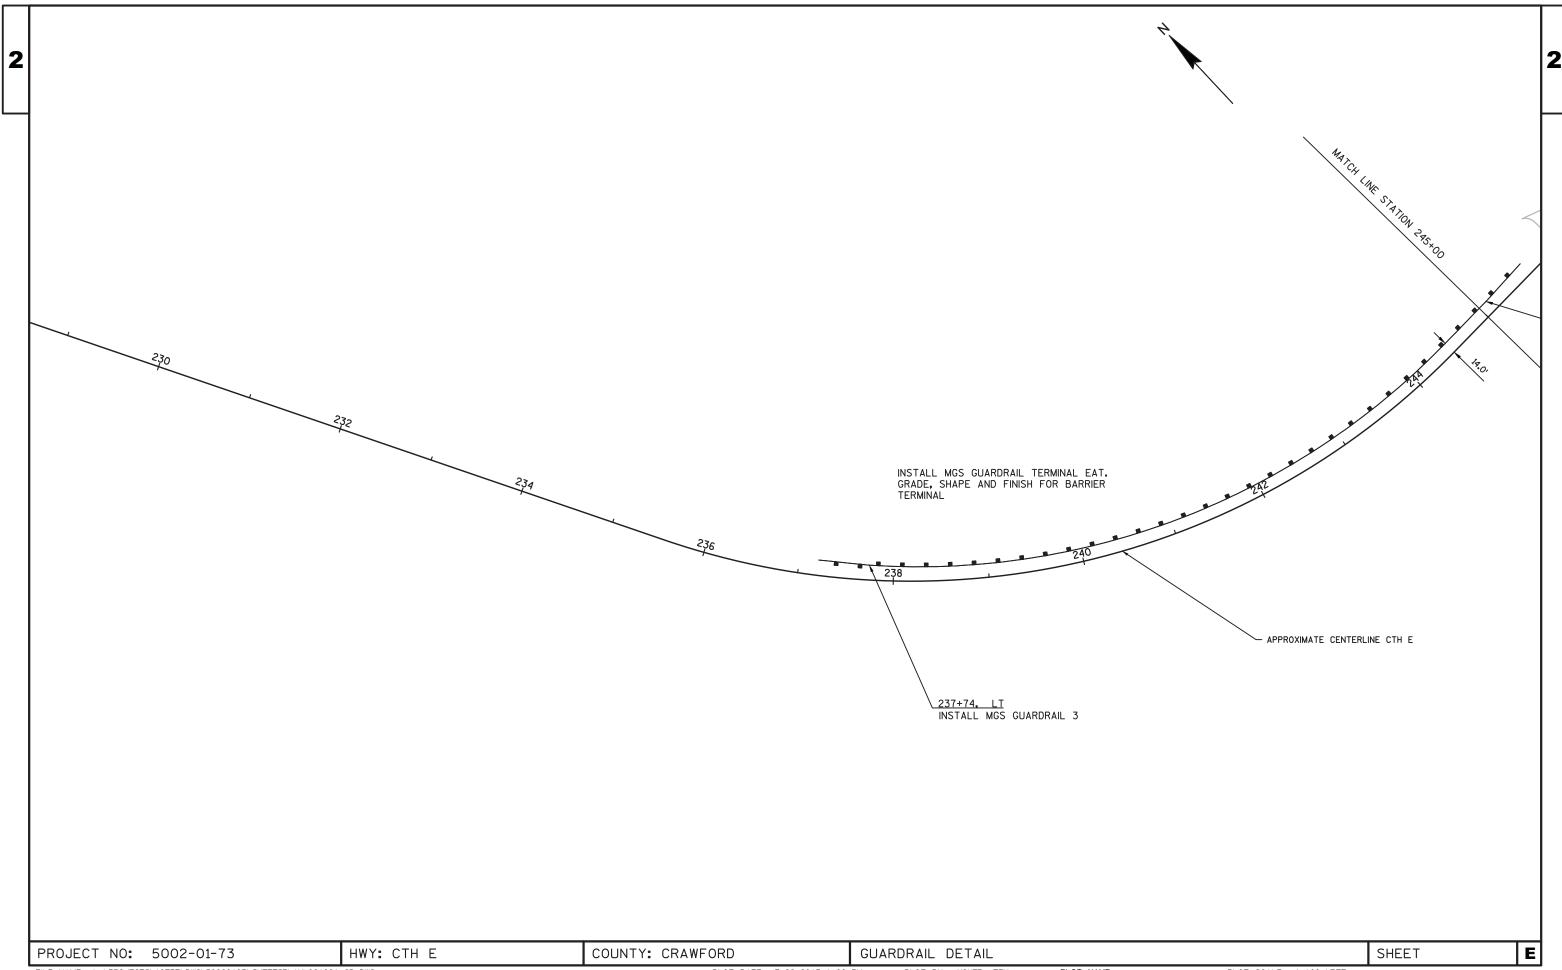
264+80 TO 292+50 - 6'

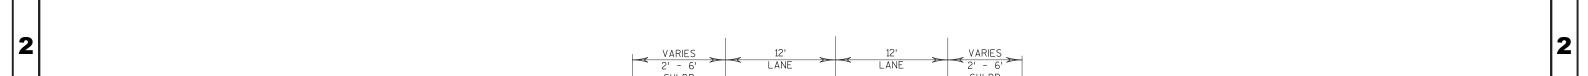
STA 166+00 TO STA 299+75





HWY: CTH E COUNTY: CRAWFORD TYPICAL SECTIONS Ε PROJECT NO:5002-01-73 SHEET FILE NAME : L:\PROJECTS\12737\DWG\50020103\SHEETSOTHER\020301\_TS.DWG PLOT DATE : 7/24/2015 7:10 AM PLOT BY : MOYER, TIM PLOT NAME : PLOT SCALE : 1 IN:10 FT




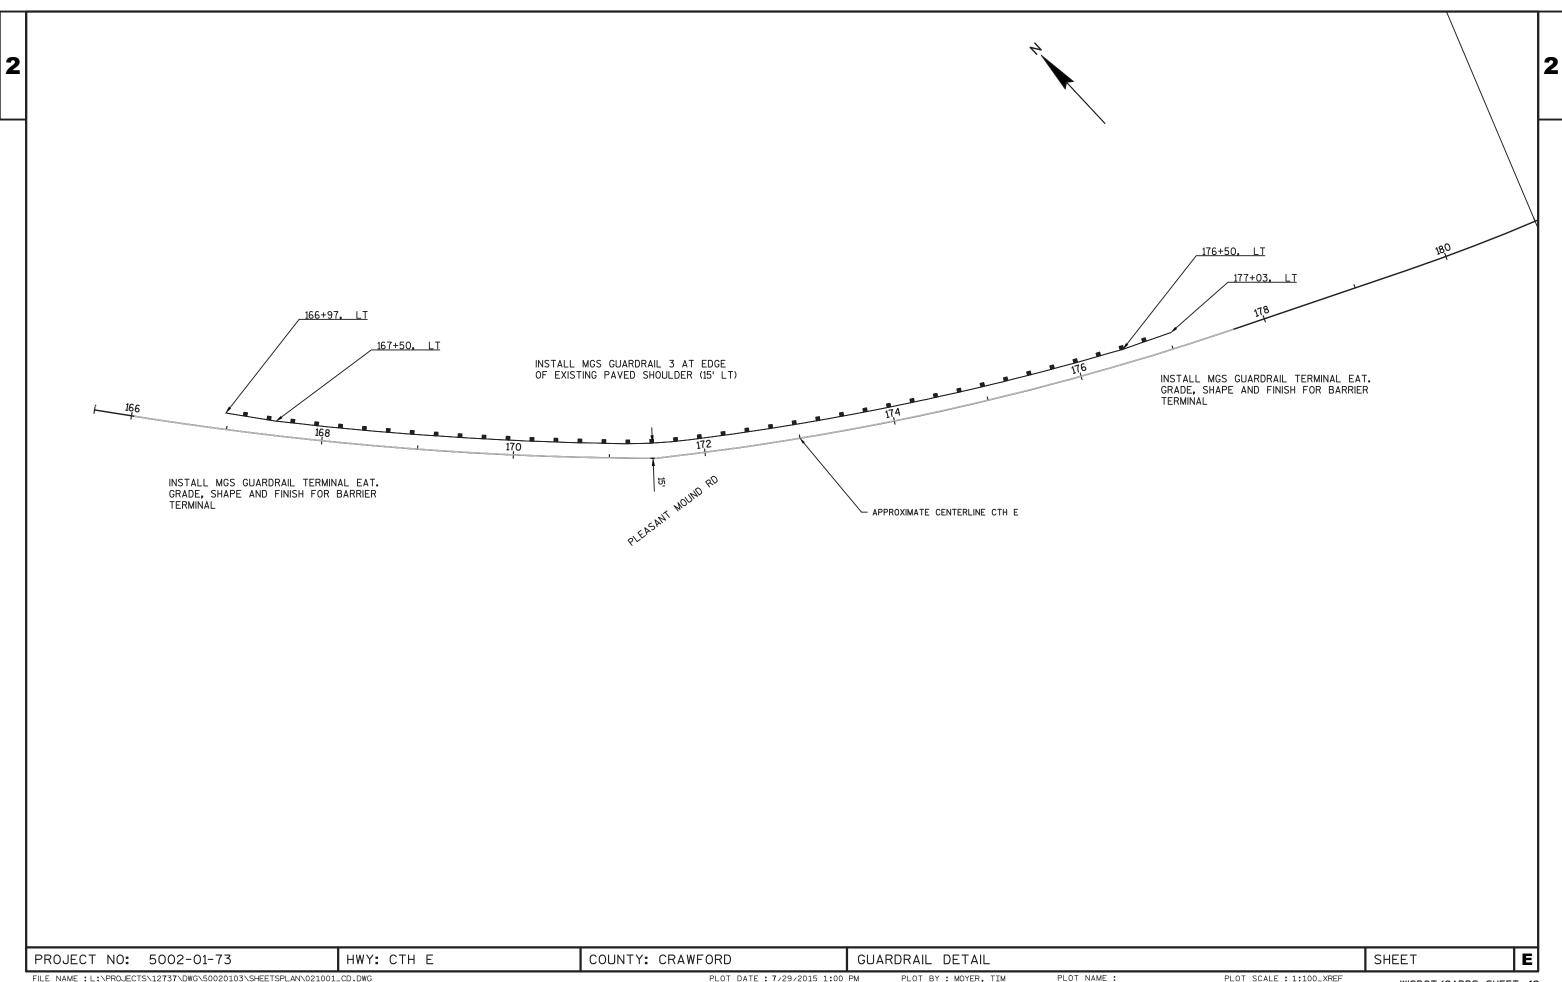

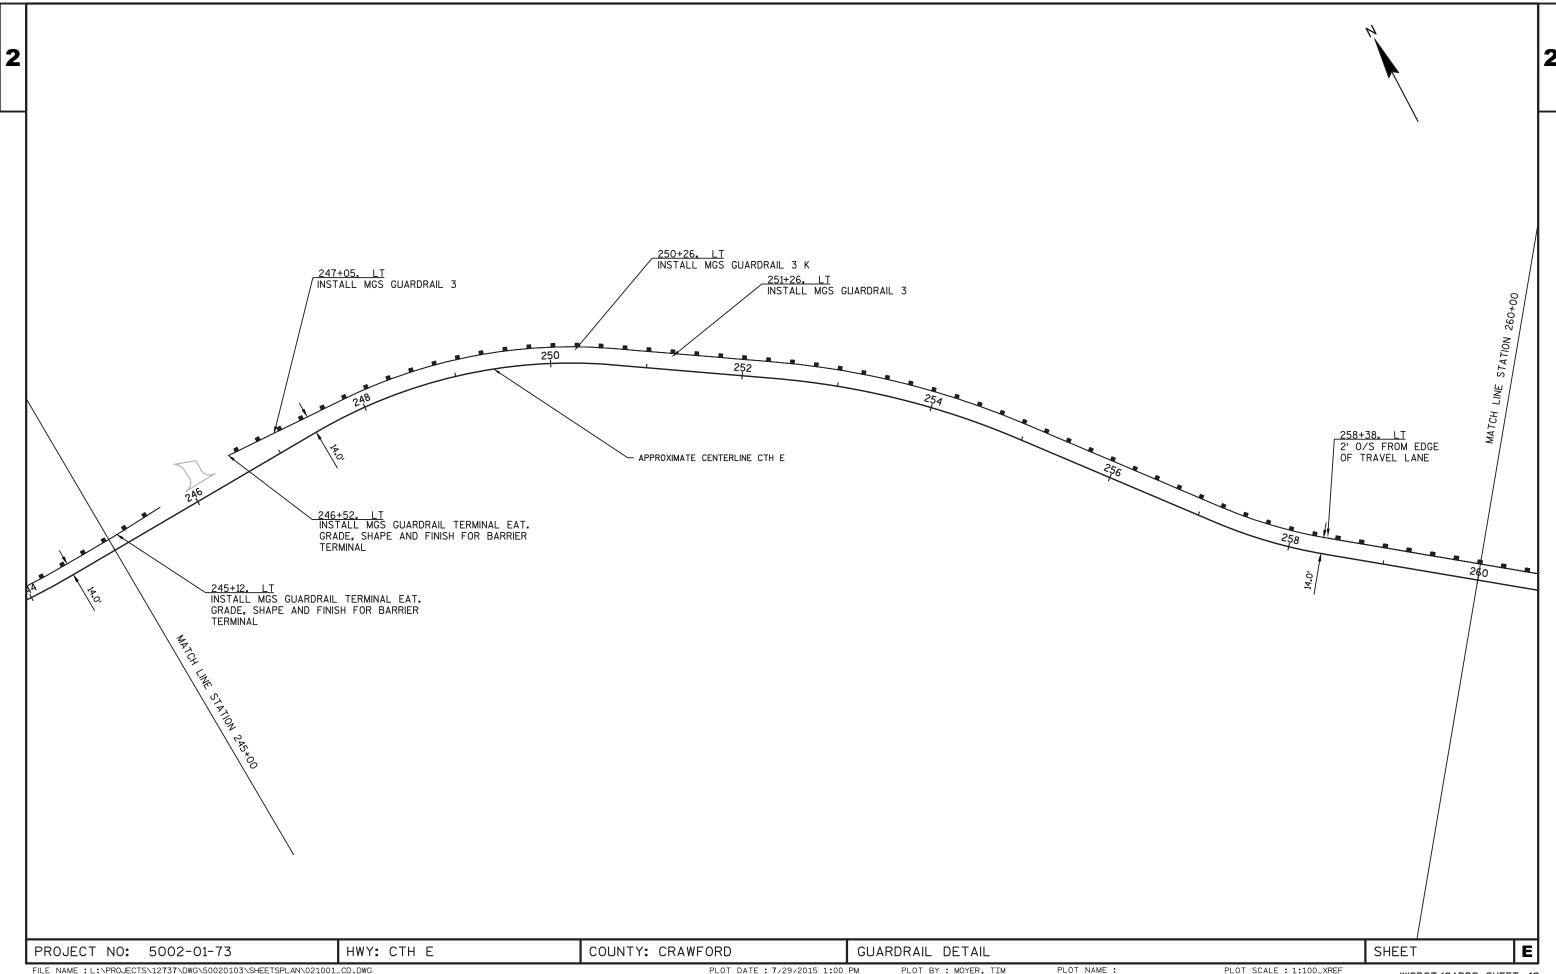

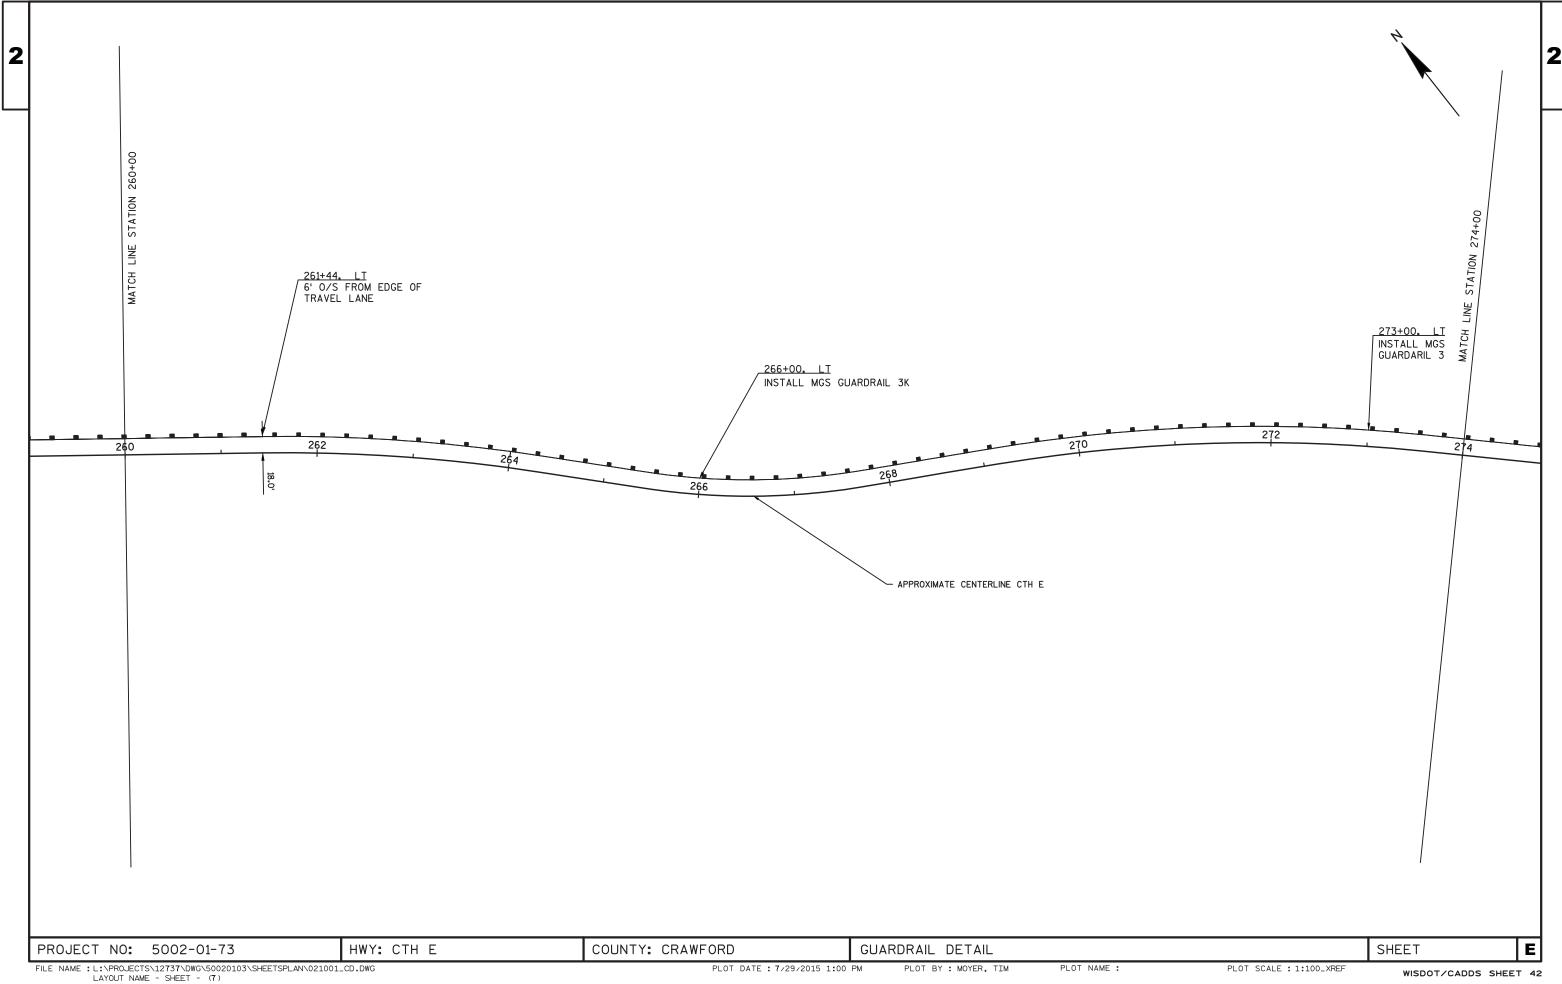

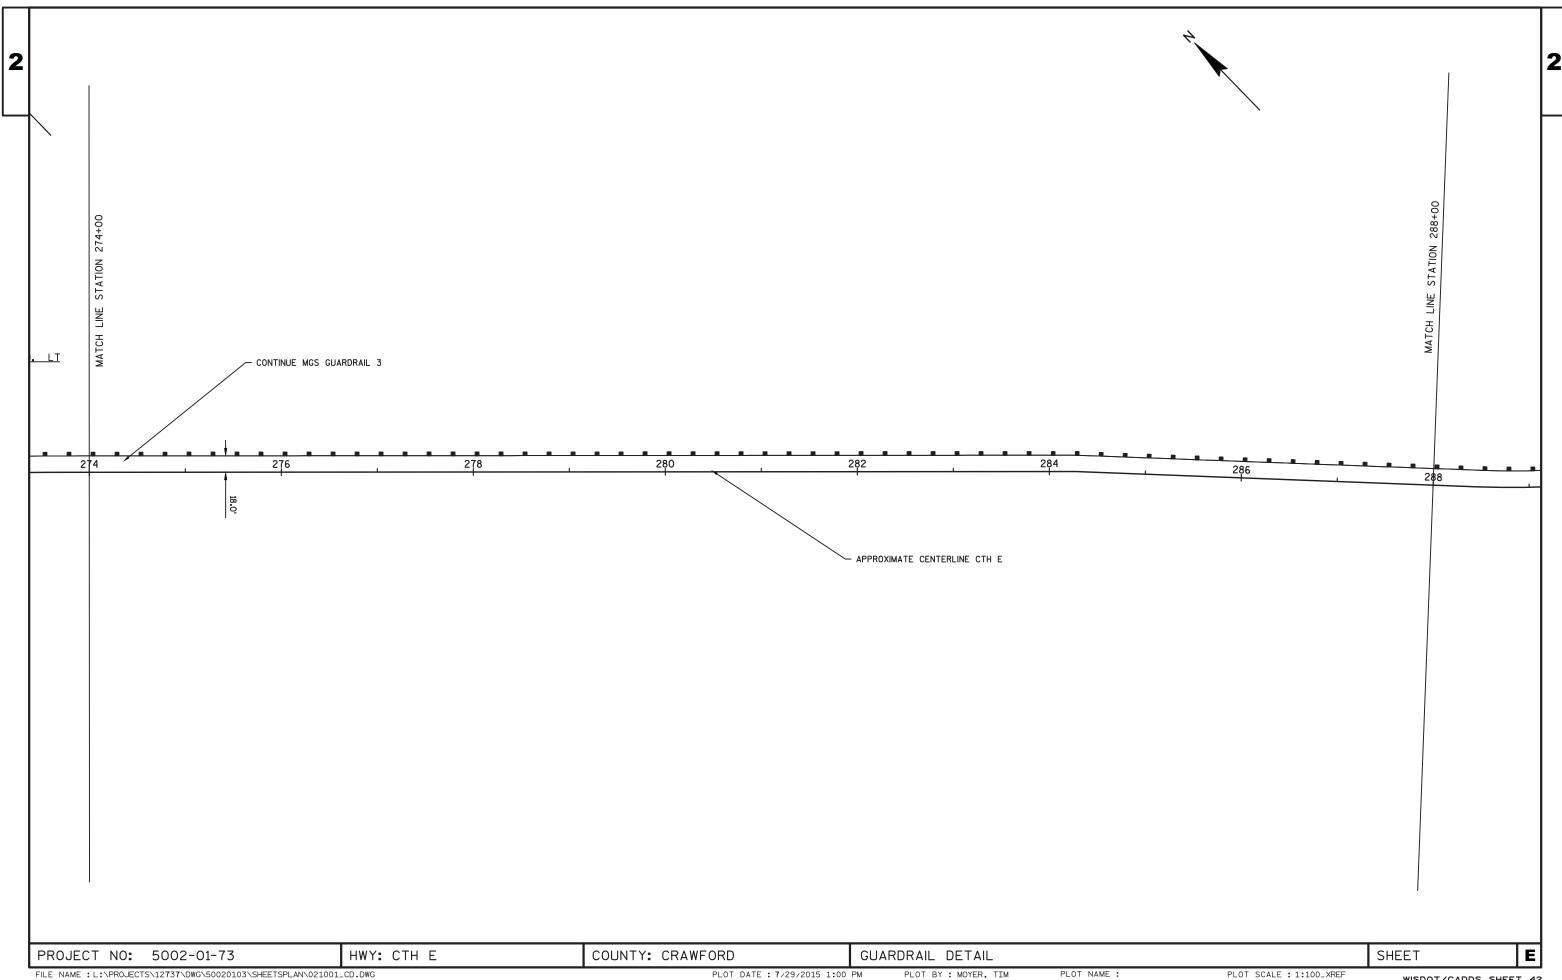

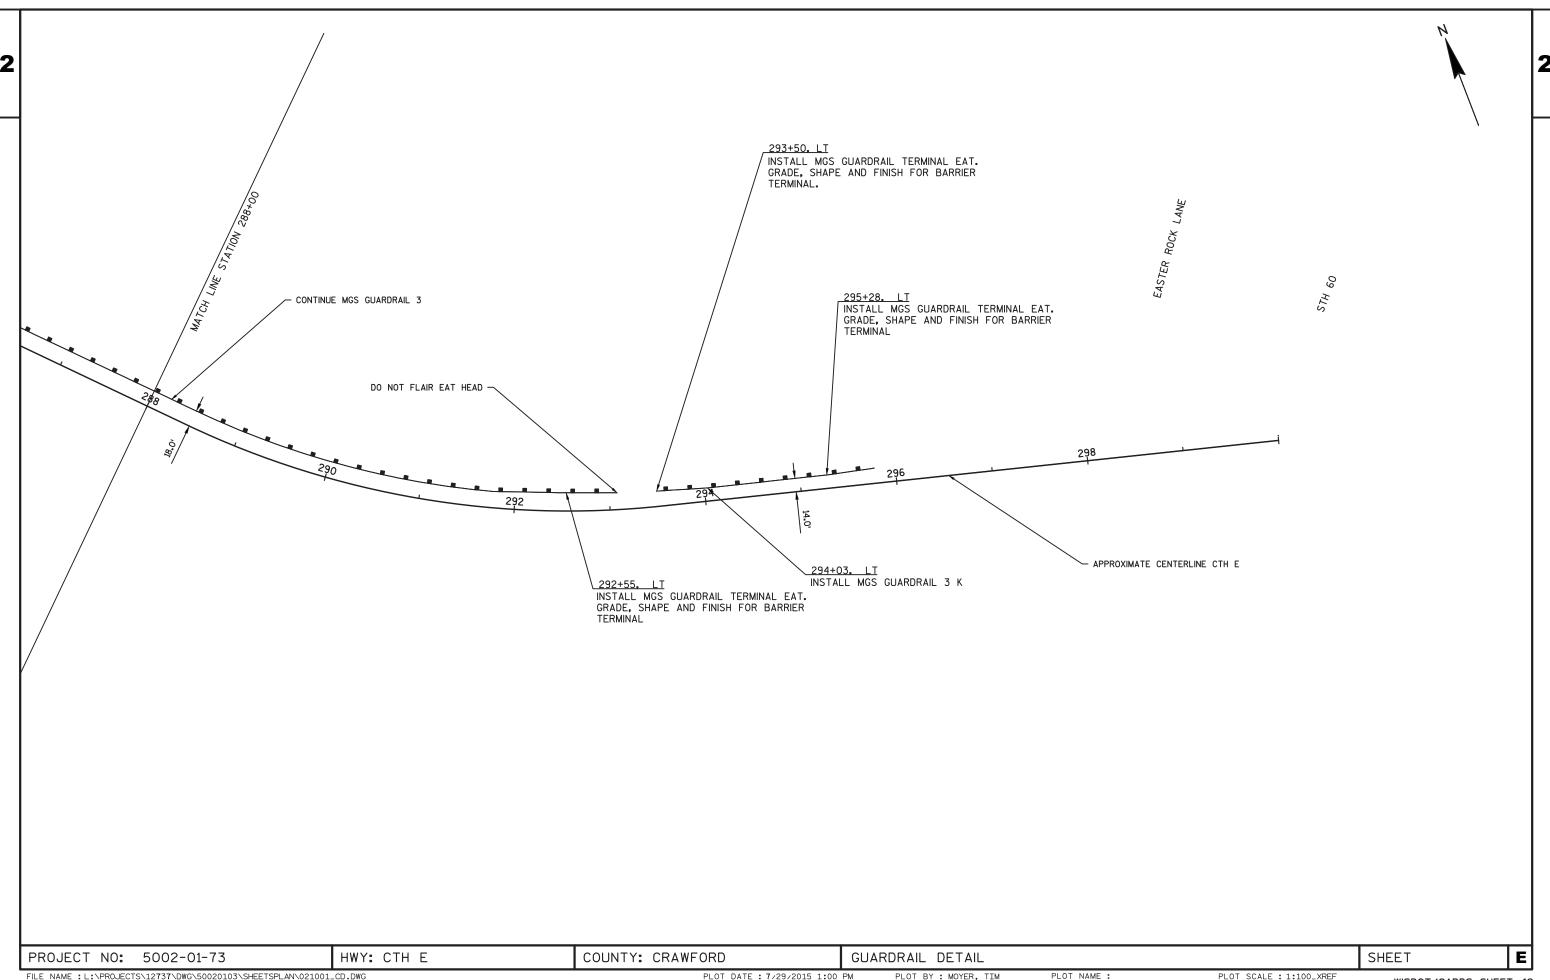

From/To Station	Location	Common Excavation (1)	* (item # 205.0100)  EBS Excavation (3)	Salvaged/Un usable Pavement Material (4)	Available		Expanded Fill (13) Factor 1.25	Mass Ordinate +/- (14)	Waste	<b>Borrow</b> (item #208.0100)	Comment:
246+12	Driveway	21	0	5	16	4	6	11	10	0	
		21	0	5	16	4	6	11	10	0	

1) Common Excavation is the sum of the Cut and EBS Excavation columns. Item number 205.0100

2) Salvaged/Unsuable Pavement Material is included in Cut.

3) EBS Excavation to be backfilled with Select Borrow material. Note: this is designers choice, can be backfilled with Borrow, or Cut as well.

4) Salvaged/Unusable Pavement Material

5) Available Material = Cut - Salvaged/Unusuable Pavement Material

13) Expanded Fill. Factor = 1.25

Depending on selections:

Expanded Fill = (Unexpanded Fill - Rock\* Rock Factor - Reduced Marsh - Reduced EBS) \* Fill Factor

Or Expanded Fill = (Unexpanded Fill - Rock\* Rock Factor - Reduced EBS) \* Fill Factor
Or Expanded Fill = (Unexpanded Fill - Rock\* Rock Factor - Reduced Marsh) \* Fill Factor

Or Expanded Fill = (Unexpanded Fill - Rock\* Rock Factor) \* Fill Factor

14) The Mass Ordinate + or - Qty calculated for the Division. Plus quantity indicates an excess of material within the Division. Minus indicates a shortage of material within the Division.

#### BASE AGGREGATE, SHAPING SHOULDERS, PREPARATION OF FOUNDATION FOR ASPHALTIC SHOULDER AND ASPHALTIC SURFACE

	211.0400 PREPARE FOUNDATION FOR ASPHALTIC SHOULDERS	305.0120 BASE AGGREGATE DENSE 1 1/4-INCH	305.0500 SHAPING SHOULDERS	455.0605 TACK COAT	465.0105 ASPHALTIC SURFACE	624.0100 WA TER	
STATION	STA	TONS	STA	GAL	TONS	MGAL	REMARKS
237+20 - 260+00	23		23	18	100	20	SHOULDER
260+00 - 293+00	33		33	78	424	30	SHOULDER
293+00 - 296+00	3		3	4	20	2	SHOULDER
246+12		20			11	3	DRIVEWAY
TOTALS	59	20	59	100	555	55	

SEAL COA	TS	<u>JMMARY</u>				455.0505 ASPHALTIC MATERIAL	475.0105	
						SEAL COAT	SEAL COAT	
STATION	5	TA TION	LOCATION	WIDTH	LENGTH	GAL	TONS	REMARKS
400.00		007.70	A 4 A 10 LL 10 LE	00	40470	40000	505	OTILE
166+00	-	297+70	MAINLINE	22	13170	12233	595	CTH E
237+20	-	296+00	SHOULDER	VARIES	5880	1373	74	
297+70	-	299+75	WIDENENING	VARIES	205	348	16	CTH E
172+00		SIDE ROAD	INTERSECTION			178	9	PLEASANT MOUNT ROAD
298+60		SIDE ROAD	INTERSECTION			138	6	EAST ROCK LANE
TOTALS						14270	700	_

#### BARRIER SYSTEM GRADING, SHAPING & FINISHING

		614.0010 BARRIER SYSTEM GRADING,	**	**	**	**	** SEEDING NO
		SHAPING &	BORROW	TOPSOIL	MULCHING	TYPEB	20
STATION	LOCATION	EACH	CY	SY	SY	CWT	LB
167+50	LT	1	10	80	80	0.009	0.37
176+50	LT	1	10	80	80	0.009	0.37
237+20	LT	1	10	125	125	0.009	0.37
245+12	LT	1	10	160	160	0.012	0.48
246+52	LT	1	10	80	80	0.006	0.24
292+55	LT	1	10	40	40	0.003	0.12
293+50	LT	1	10	40	40	0.003	0.11
294+03	LT	1	10	35	35	0.002	0.11
TOTALS		8	80	640	640	0.053	2.17

\*\* FOR INFORMATION ONLY

#### SALVAGED BEAM GUARD ITEMS

			614.0920	614.0925
				SALVAGED
				GUARDRAIL
			SALVAGED	END
			RAIL	TREATMENTS
STATION		LOCATION	LF	LF
STATION		LOCATION	LF	LF
240+21	243+45	LOCATION	<b>LF</b> 325	2 2
	243+45 292+82			

#### BEAM GUARD ITEMS

			614.2300	614.2330	614.2610 MGS
			MGS GUARDRAIL	MGS GUARDRAIL	GUARDRAIL TERMINAL
			3	3K	EAT
STATION		LOCATION	LF	LF	EACH
166+97	167+50	LT			1
167+50	176+50	LT	900		
176+50	177+03	LT			1
237+20	237+74	LT			1
237+74	245+12	LT	738		
245+12	245+65	LT			1
246+52	247+05	LT			1
247+05	250+26	LT	325		222
250+26	251+26	LT		100	
251+26	266+00	LT	1475		
266+00	273+00	LT		700	
273+00	293+08	LT	1950		1
293+50	294+03	LT			1
294+03	295+28	LT		125	
295+28	295+81	LT			1
TOTALS			5388	925	8

\* = PAY PLAN QUANTITY ITEM.

PROJECT NO: 5002-01-73 HWY: CTH E COUNTY: CRAWFORD MISCELLANEOUS QUANTITIES SHEET **E** 

RESTORA	625.0100	627.0200	629.0210	630.0120		
	TOPSOILS	MULCH	FERTILIZER TYPE B	SEED MIXTURE NO. 20		
STATION	SY	SY	CWT	LBS	REMARKS	
246+12	45	45	0.1	2	DRIVEWAY	
TOTALS	45 <del>X</del>	45 <del>X</del>	0.1 <del>X</del>	2 *		

#### EROSION CONTROL ITEMS

628.1520 SILT FENCE SILT FENCE MAINTENANCE

STATION	LOCATION	LF	LF	REMARKS
166+50	LT	150	150	BARRIER SYSTEM GRADING, SHAPING & FINISHING
179+50	LT	150	150	BARRIER SYSTEM GRADING, SHAPING & FINISHING
237+20	LT	150	150	BARRIER SYSTEM GRADING, SHAPING & FINISHING
245+12	LT	150	150	BARRIER SYSTEM GRADING, SHAPING & FINISHING
246+52	LT	150	150	BARRIER SYSTEM GRADING, SHAPING & FINISHING
292+55	LT	150	150	BARRIER SYSTEM GRADING, SHAPING & FINISHING
293+50	LT	150	150	BARRIER SYSTEM GRADING, SHAPING & FINISHING
295+28	LT	150	150	BARRIER SYSTEM GRADING, SHAPING & FINISHING
TOTALS		1200	1200	

				ITEM NO. 638.2602 REMOVING SIGNS TYPE II	ITEM NO. 638.3000 REMOVING SMALL SIGN SUPPORTS		SIZE		ITEM NO. 637.2230 SIGNS TYPE II	ITEM NO. 634.0616 WOOD POSTS 4X6-INCH	
				ITPEII	SUPPORTS	WIDTH			REFLECTIVE F	4X0-INCH 16-FT	
STATION	LT/RT	CODE	DESCRIPTION	EACH	EACH	IN	х	IN	S.F.	EACH	REMARKS
STATION	LI/KI	CODE	DESCRIPTION	EACH	EACH	IIV	^	IIV	э.г.	EACH	KEWAKNS
166+00	RT	W1-2L		2	1	30	X	30	6.25	1	
100+00	KI	W13-1	45 MPH	2	Į.	18	x	18	2.25		MOUNT MUNDER W1-2L
192+25	LT	W1-2R	43 WII 11	2	1	30	X	30	6.25	1	WOONT WONDER WI-ZE
102120		W13-1	45 MPH	2		18	X	18	2.25		MOUNT MUNDER W1-2F
208+00	RT	W1-2R	10 1111 11			30	X	30	6.25	1	MOONT MONDER TO LE
	10.00	W13-1	40 MPH			18	X	18	2.25		MOUNT UNDER W1-2R
228+50	LT	W1-2L		2	1	30	X	30	6.25	1	
		W13-1	40 MPH			18	X	18	2.25		MOUNT UNDER W1-2L
231+50	RT			2	1						
244+00	RT	W1-5L				30	X	30	6.25	1	
		W13-1	35 MPH			18	X	18	2.25		MOUNT UNDER W1-5L
259+75	RT	W1-2L		2	1	30	X	30	6.25	1	
		W13-1	25 MPH			18	X	18	2.25		MOUNT UNDER W1-2L
261+00	LT	W1-5R				30	X	30	6.25	1	
AND DESCRIPTION OF THE PARTY	200	W13-1	35			18	X	18	2.25		MOUNT UNDER W1-5R
270+00	LT	W1-2R	12000			30	X	30	6.25	1	
		W13-1	25			18	X	18	2.25		MOUNT UNDER W1-5R
275+00	LT			2	1				0.00	0	
											MOUNT UNDER W1-5R
				12	6				68.00	8.00	

PAVEMENT	MARKING ITEMS						
		646.	646.0106 PAVEMENT MARKING EPOXY 4-INCH		649.0110	649.2100	
		PAVEMEN 1			<b>TEMPORARY</b>	TEMPORARY	
		EPOXY			PAVEMENT	RAISED	
				STOP LINE	MARKING	PAVEMENT	
				EPOXY	4-INCH PAINT	MARKERS	
				12-INCH			
		YELLOW	WHITE				
STATION		LF		LF	LF	EACH	REMARKS
166+00	299+50	26700	26700		2136	132	CTH E
299+50				110			CTH E @ STH 60
298+60		150					EAST ROCK LANE
TOTALS		26850	26700	110	2136	132	

#### CONSTRUCTION STAKING

53550

ITEM NO.	ITEM NAME	QUANTITY	
650.8000	CONSTRUCTION STAKING RESURFACING REFERENCE	13,375 LF	
650.9910	CONSTRUCTION STAKING SUPPLEMENTAL CONTROL PROJECT ID 5002-01-73	1 EACH	


#### SAWING ASPHALT - 690.0150

STATION	ĹF	REMARKS	
237+20 - 296+00	5880	LANE EDGE	
246+12	23	DRIVEWAY	
TOTALS	5903		

PREPARE EXISTING PAVEMENT FOR ASPHALTIC SEAL COAT WITH CRACK FILLING, ITEM SPV.0125.01 AND PREPARE EXISTING PAVEMENT FOR ASPHALTIC SEAL COAT WITH ROUT AND SEAL, ITEM SPV.01250.02						
ITEM NO.	ITEM NAME	LOCATION	MILES			
SPV.0125.01	PREPARE EXISTING PAVEMENT FOR ASPHALTIC SEAL COAT WITH CRACK FILLING	CTH E MAINLINE	2.42			
SPV.0125.02	PREPARE EXISTING PAVEMENT FOR ASPHALTIC SEAL COAT WITH ROUT AND SEAL	CTH E MAINLINE	2.42			

\* = PAY PLAN QUANTITY ITEM.


HWY: CTH E COUNTY: CRAWFORD PROJECT NO: 5002-01-73 MISCELLANEOUS QUANTITIES SHEET Ε PLOT NAME :

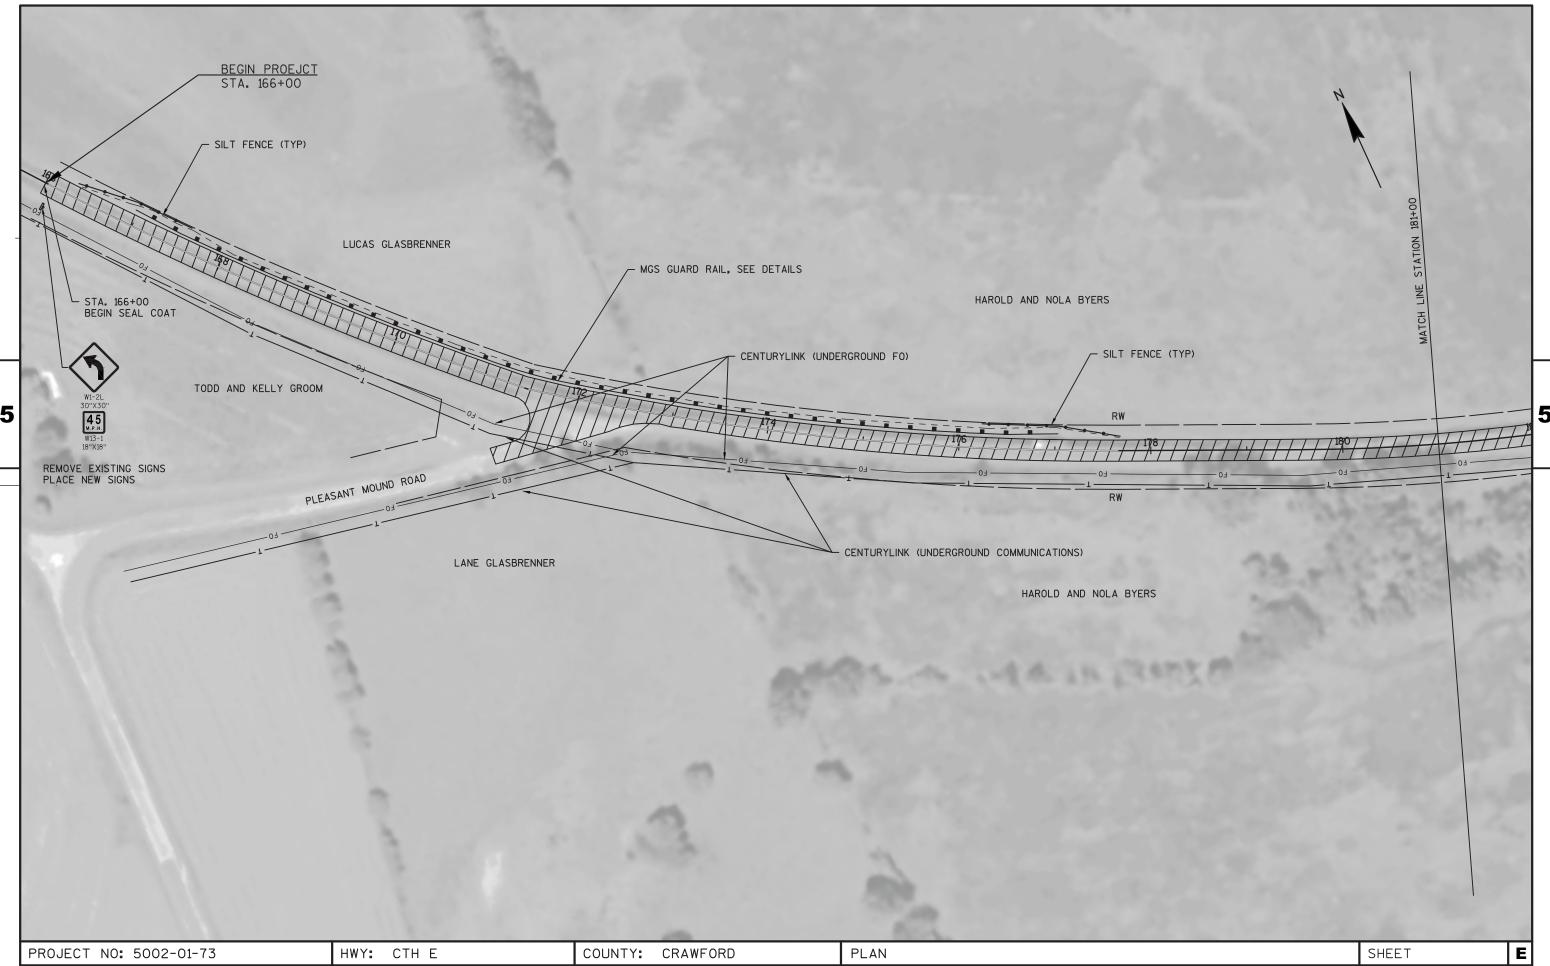

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PLOT DATE: 7/29/2015 1:39 PM
PLOT BY: MOYER, TIM
PLOT NAME: PLOT NAME: PLOT NAME: 1:100\_XREF
WISDOT/CADDS SHEET 44



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PLOT BY: MOYER, TIM
PLOT NAME: PLOT NAME: PLOT NAME: 1:100\_XREF
WISDOT/CADDS SHEET 44

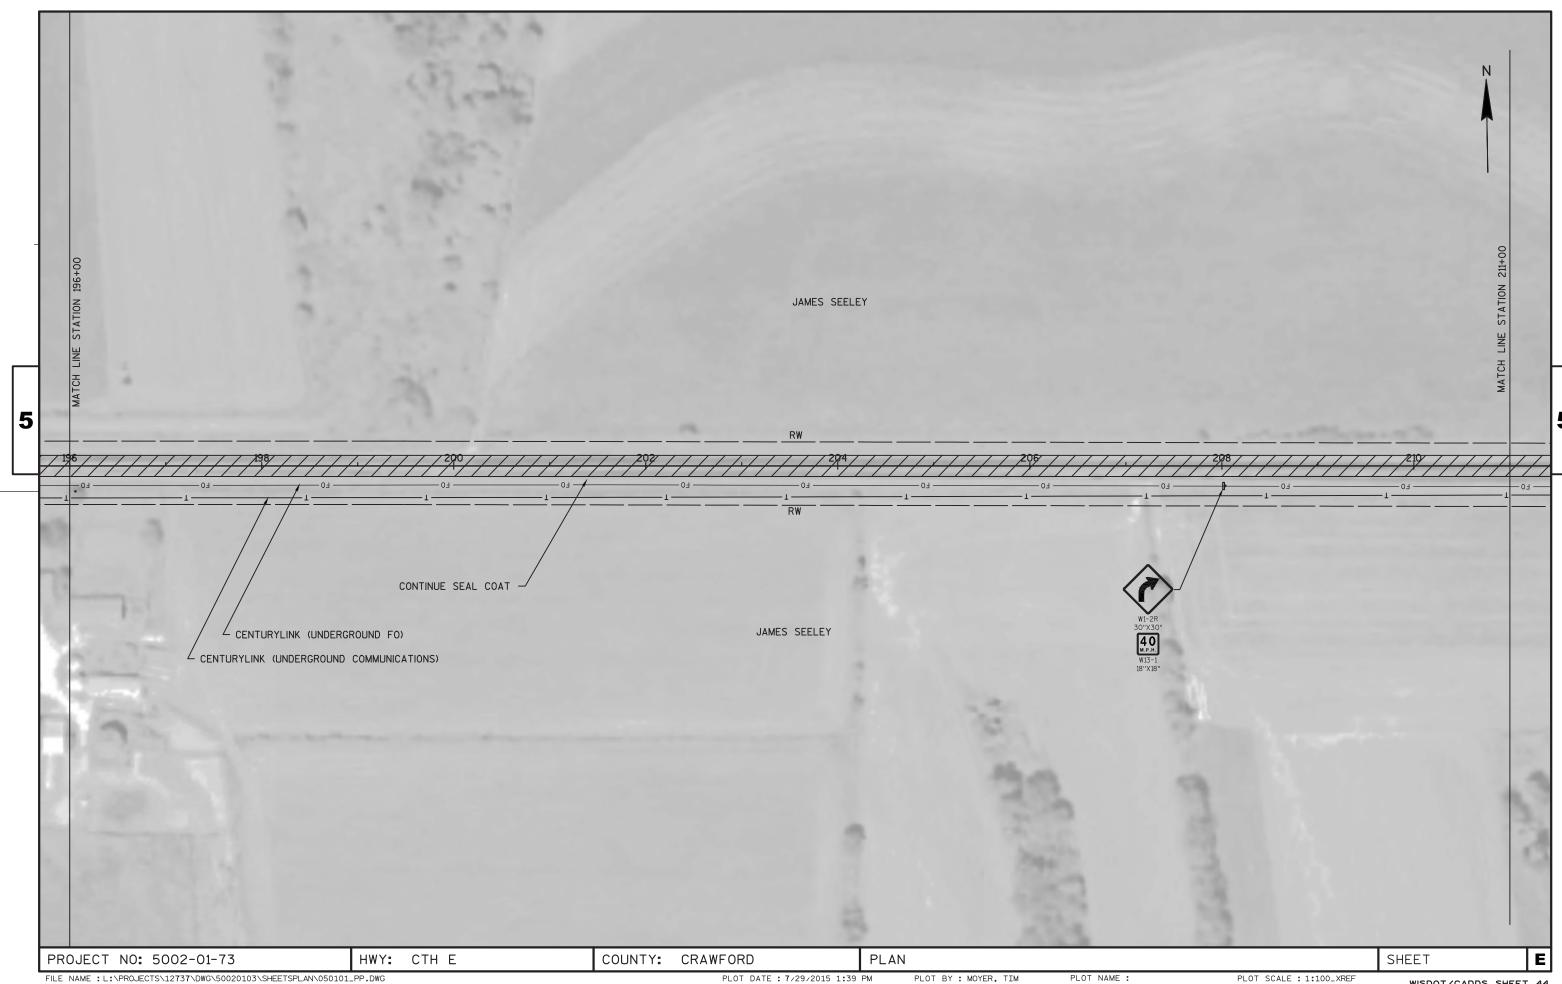


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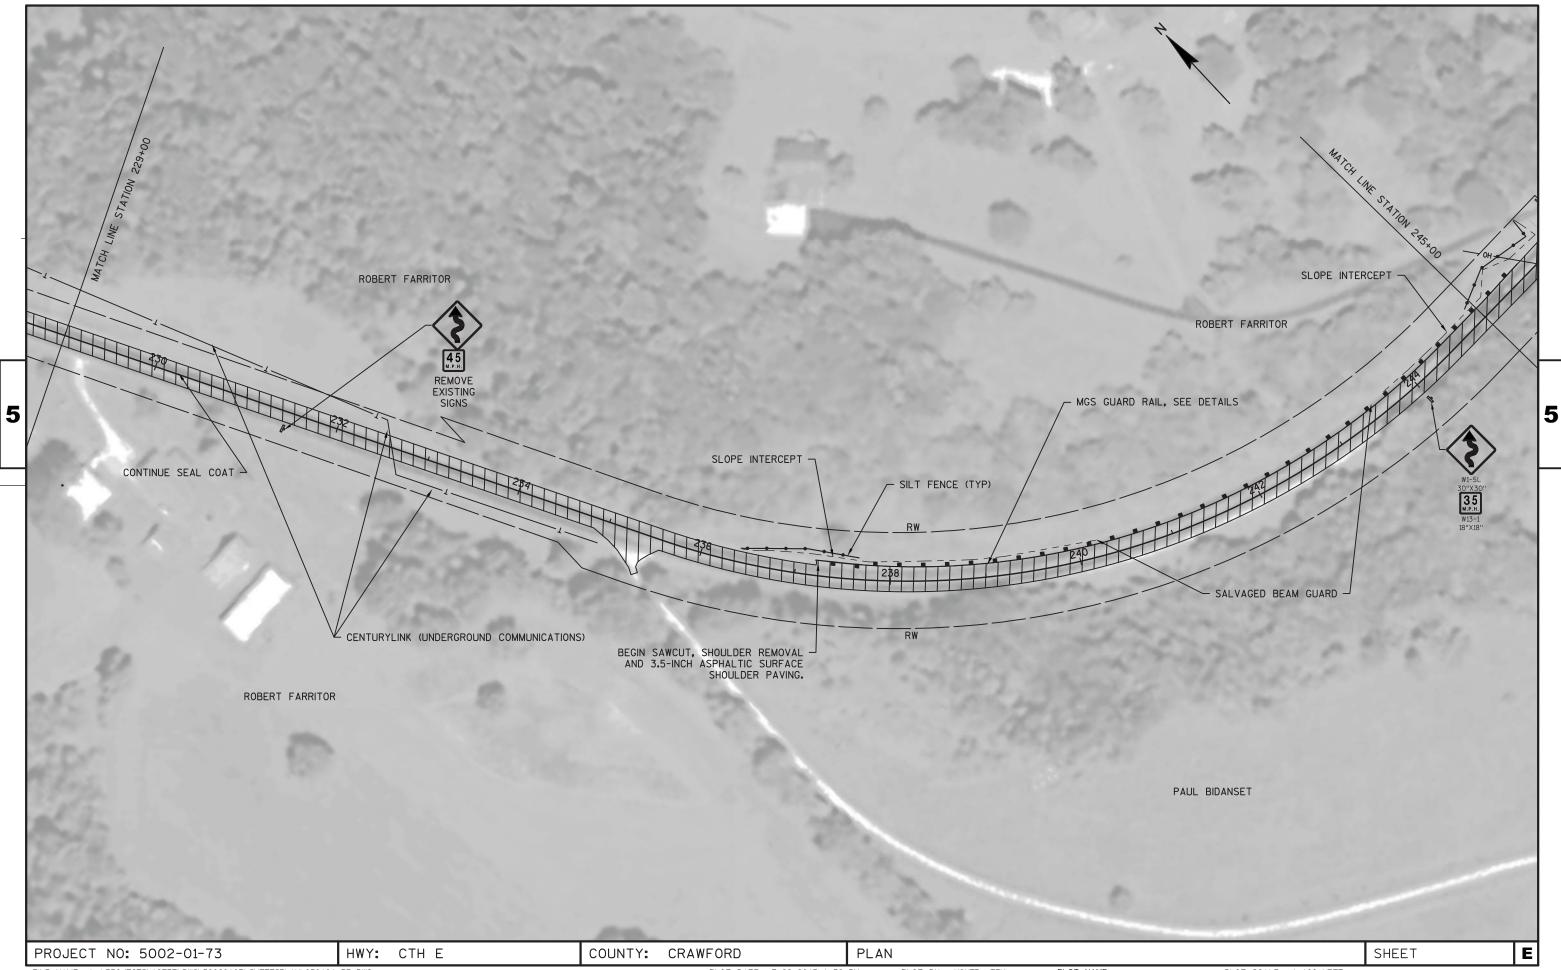
PLOT SCALE : 1:100\_XREF

WISDOT/CADDS SHEET 44



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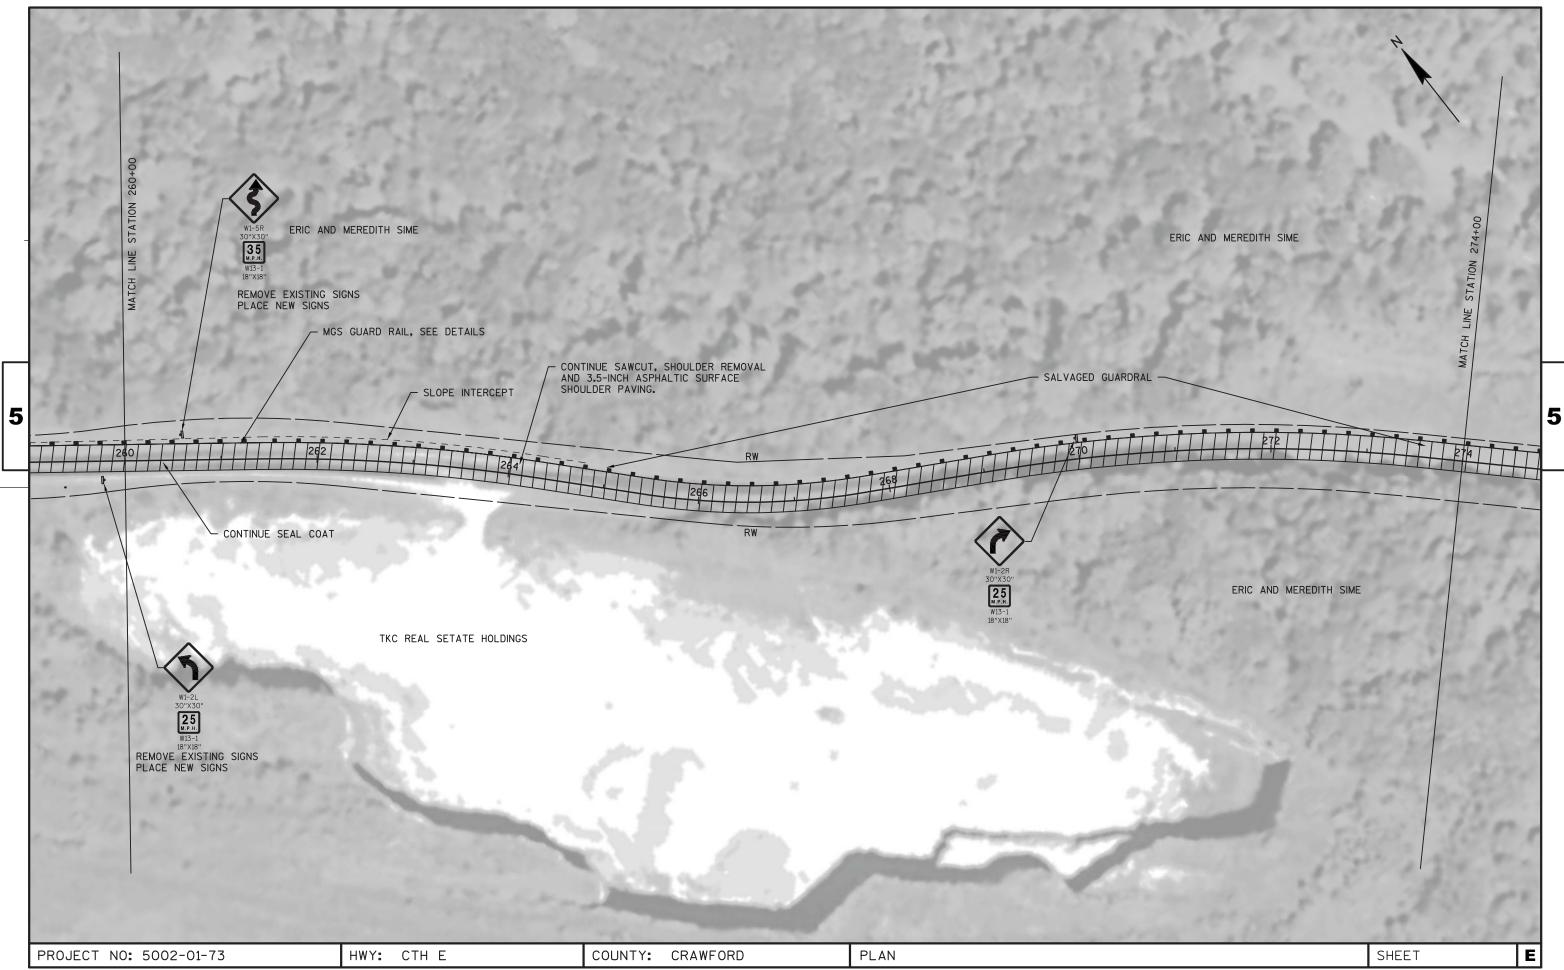
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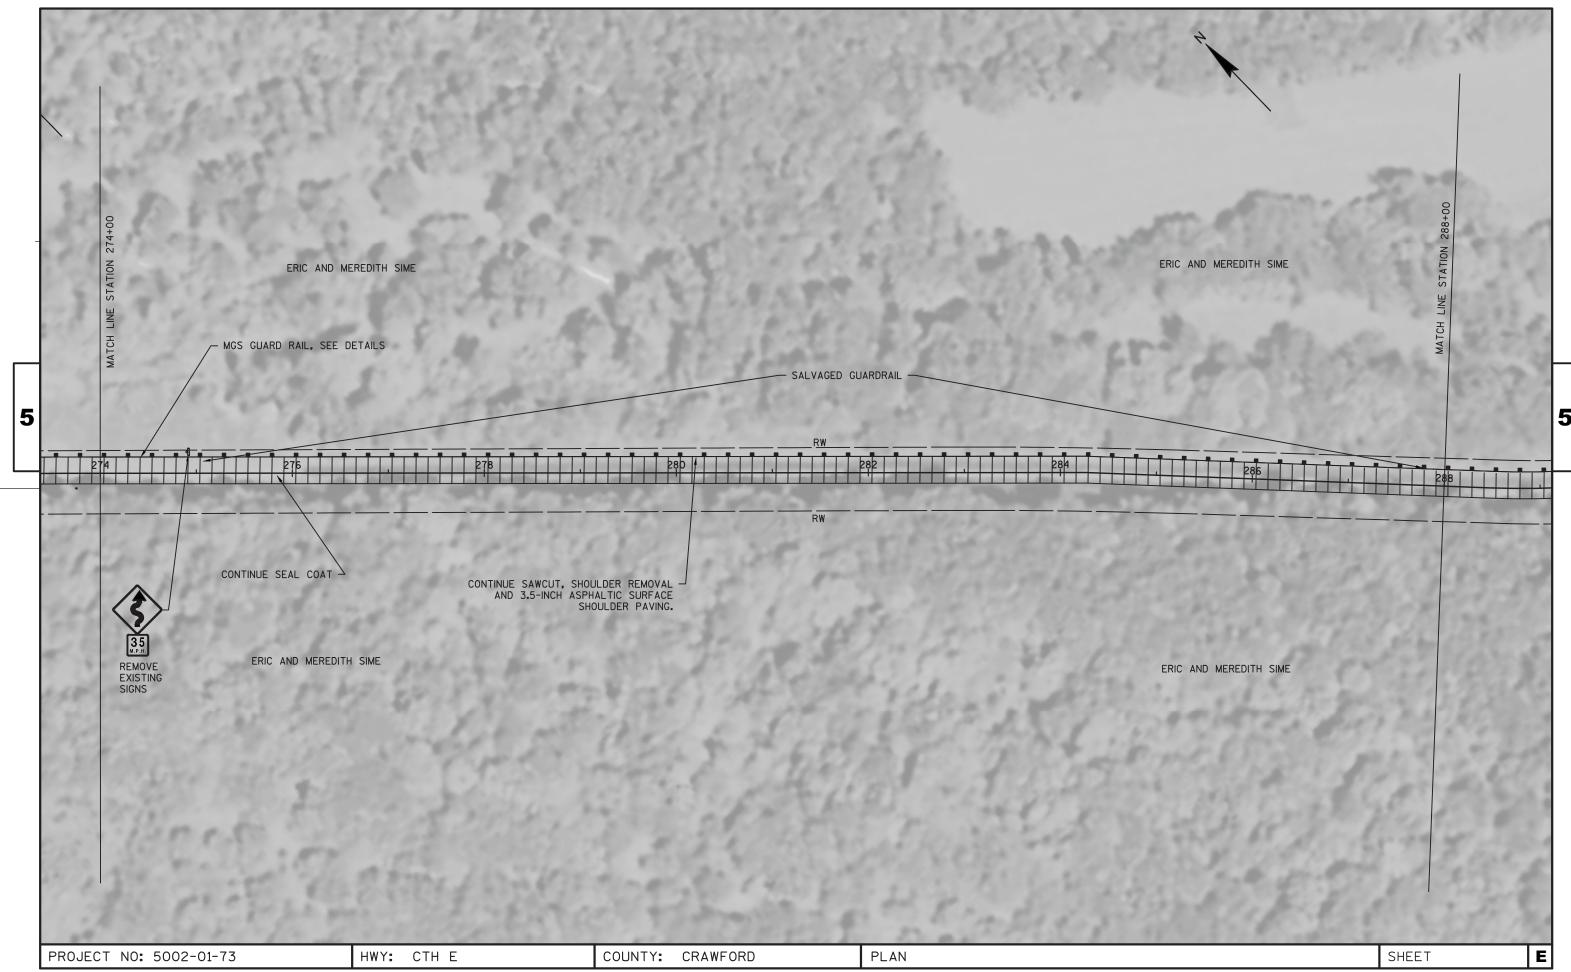
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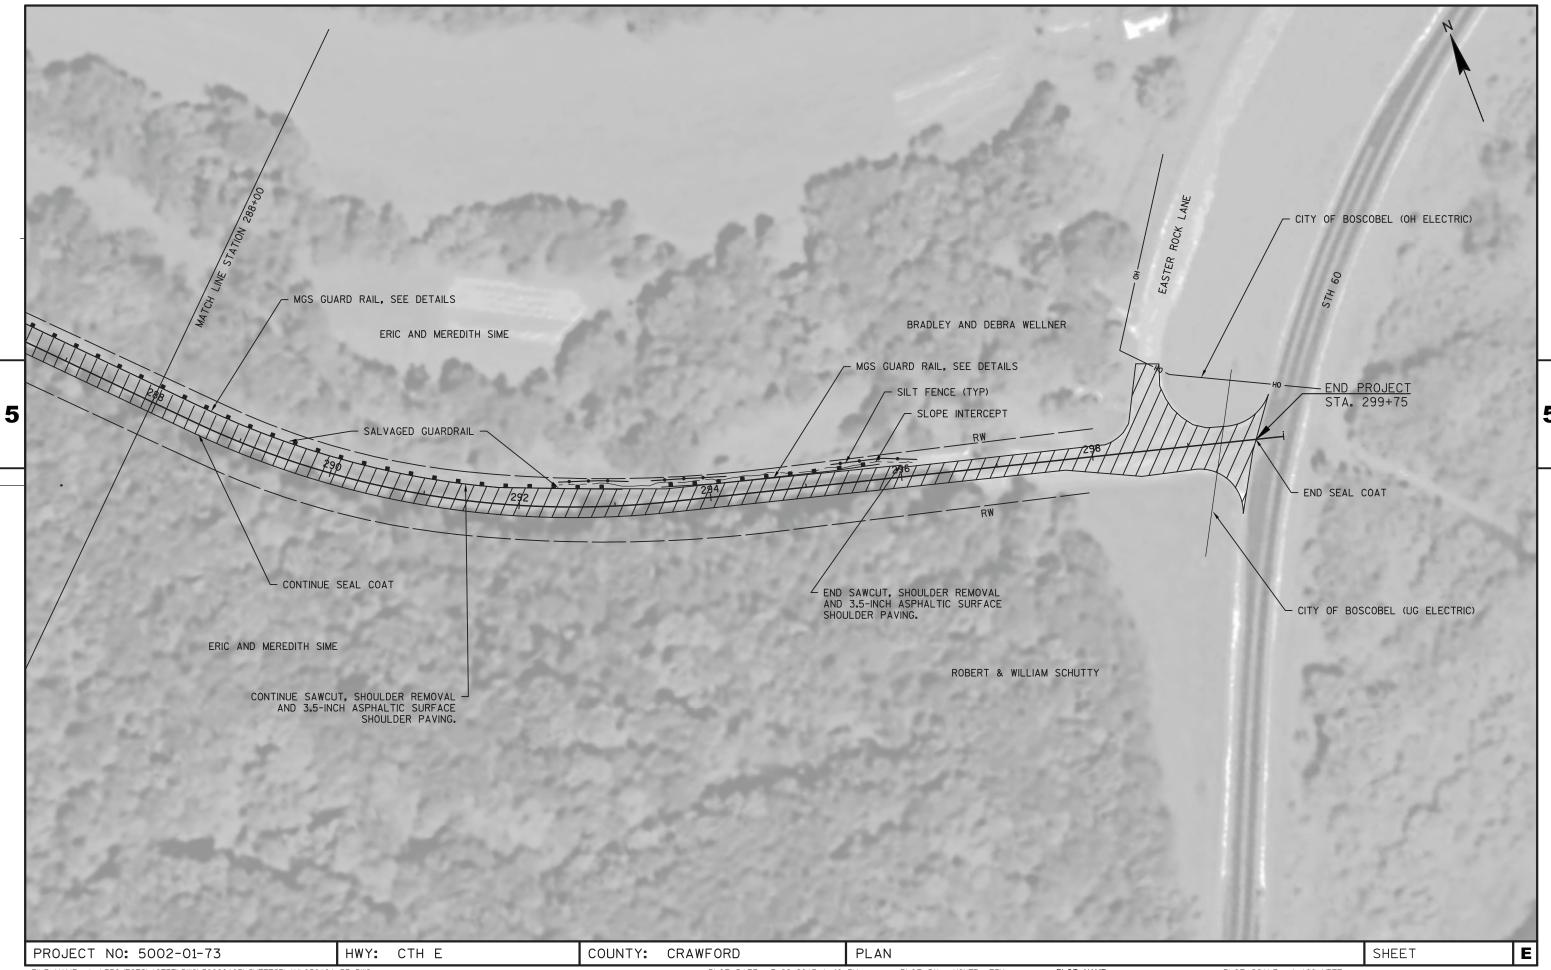
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PLOT DATE: 7/29/2015 1:39 PM PLOT BY: MOYER, TIM PLOT NAME: PLOT NAME: 1:100\_XREF
LAYOUT NAME - SHEET - (6)
WISDOT/CADDS SHEET 44

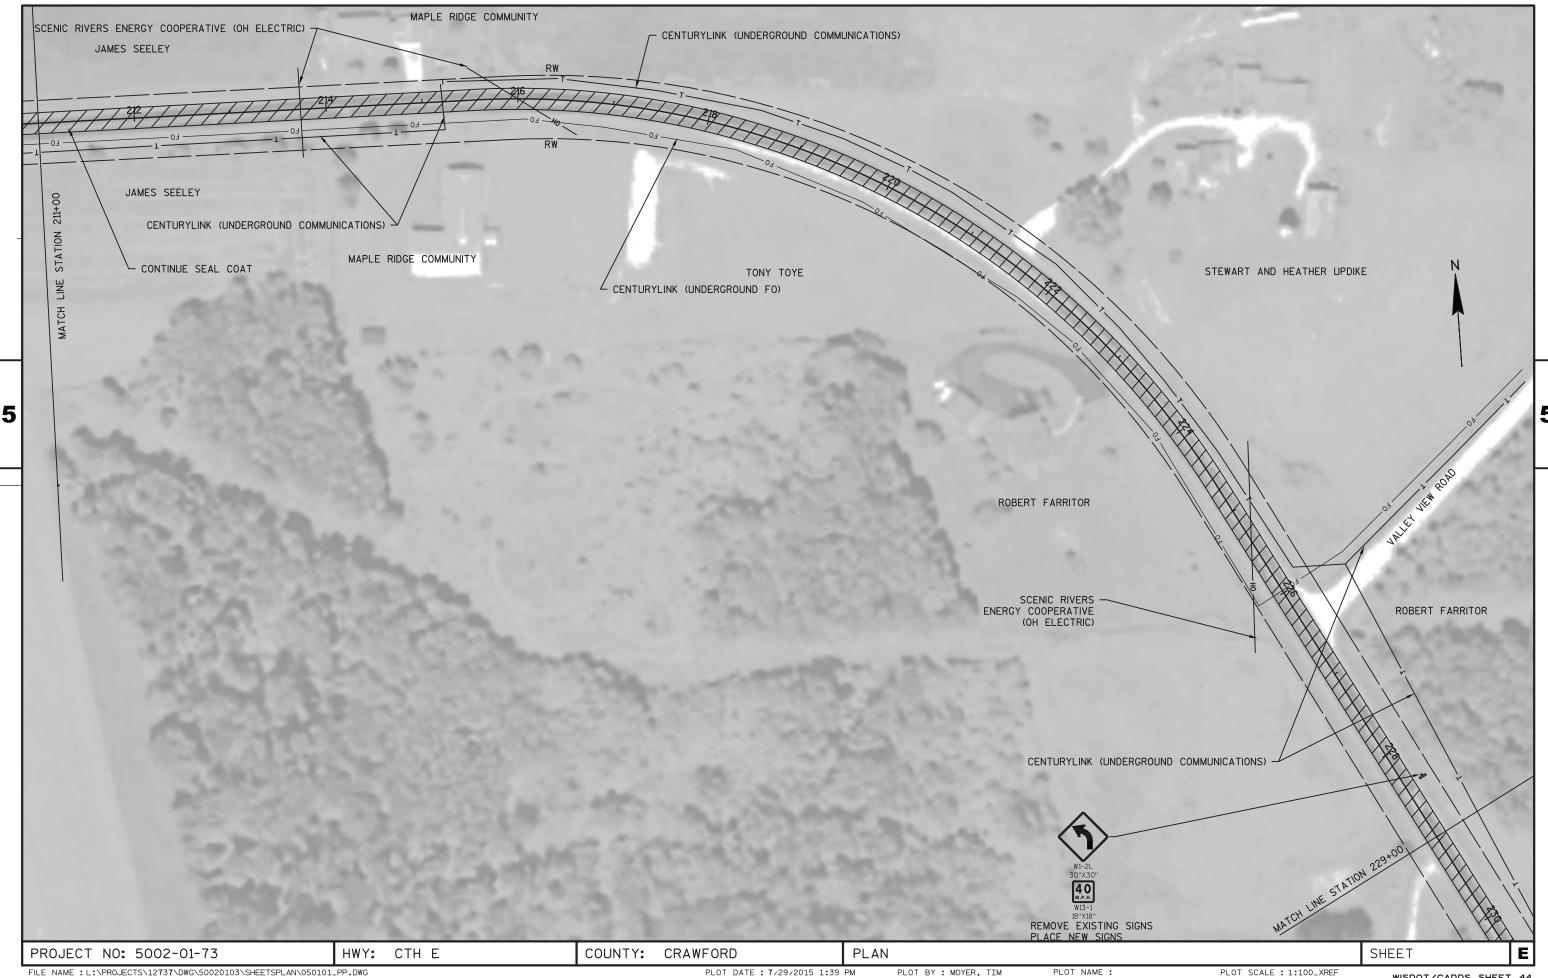

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PLOT BY: MOYER, TIM
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WISDOT/CADDS SHEET 44



FILE NAME : L:\PROJECTS\12737\DWG\50020103\SHEETSPLAN\050101\_PP.DWG LAYOUT NAME - SHEET - (8) PLOT DATE : 7/29/2015 1:40 PM PLOT BY : MOYER, TIM PLOT NAME : PLOT SCALE : 1:100\_XREF WISDOT/CADDS SHEET 44



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PLOT DATE: 7/29/2015 1:40 PM
PLOT BY: MOYER, TIM
PLOT NAME: PLOT NAME: PLOT NAME: 1:100\_XREF
WISDOT/CADDS SHEET 44

## Standard Detail Drawing List

08E09-06	SILT FENCE
14B42-03A	MIDWEST GUARDRAIL SYSTEM (MGS) GUARDRAIL
14B42-03B	MIDWEST GUARDRAIL SYSTEM (MGS) GUARDRAIL
14B42-03C	MIDWEST GUARDRAIL SYSTEM (MGS) GUARDRAIL
14B44-02A	MIDWEST GUARDRAIL SYSTEM ENERGY ABSORBING TERMINAL (MGS)
14B44-02B	MIDWEST GUARDRAIL SYSTEM ENERGY ABSORBING TERMINAL (MGS)
14B44-02C	MIDWEST GUARDRAIL SYSTEM ENERGY ABSORBING TERMINAL (MGS)
15C04-02	TRAFFIC CONTROL, ADVANCE WARNING SIGNS 45 M.P.H. OR GREATER TWO-WAY UNDIVIDED ROAD OPEN TO TRAFFIC
15C08-16B	PAVEMENT MARKING (INTERSECTIONS)
15C12-04	TRAFFIC CONTROL FOR LANE CLOSURE (SUITABLE FOR MOVING OPERATIONS)
15C19-02A	MOVING PAVEMENT MARKING OPERATION TWO-LANE TWO-WAY ROADWAY
15C33-01	STOP LINE AND CROSSWALK PAVEMENT MARKING

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## TYPICAL APPLICATION OF SILT FENCE

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## PLAN VIEW SILT FENCE AT MEDIAN SURFACE DRAINS



#### **GENERAL NOTES**

DETAILS OF CONSTRUCTION NOT SHOWN ON THIS DRAWING SHALL CONFORM TO THE PERTINENT REQUIREMENTS OF THE STANDARD SPECIFICATIONS AND APPLICABLE SPECIAL PROVISIONS.

- $\bigcirc$  HORIZONTAL BRACE REQUIRED WITH 2" X 4" WOODEN FRAME OR EQUIVALENT AT TOP OF POSTS.
- ② FOR MANUAL INSTALLATIONS THE TRENCH SHALL BE A MINIMUM OF 4" WIDE & 6" DEEP TO BURY AND ANCHOR THE GEOTEXTILE FABRIC. FOLD MATERIAL TO FIT TRENCH AND BACKFILL & COMPACT TRENCH WITH EXCAVATED SOIL.
- 3 WOOD POSTS SHALL BE A MINIMUM SIZE OF 11/8" X 11/8" OF OAK OR HICKORY.
- 4) SILT FENCE TO EXTEND ACROSS THE TOP OF THE PIPE.
- (5) CONSTRUCT SILT FENCE FROM A CONTINUOUS ROLL IF POSSIBLE BY CUTTING LENGTHS TO AVOID JOINTS. IF A JOINT IS NECESSARY USE ONE OF THE FOLLOWING TWO METHODS; A) OVERLAP THE END POSTS AND TWIST, OR ROTATE, AT LEAST 180 DEGREES, B) HOOK THE END OF EACH SILT FENCE LENGTH.



TRENCH DETAIL



SILT FENCE TIE BACK
(WHEN REQUIRED BY THE ENGINEER)

STATE OF WISCONSIN
DEPARTMENT OF TRANSPORTATION

APPROVED
4-29-05 /S/ Beth Cannestra

29-05 /S/ Beth Cannestra
DATE CHIEF ROADWAY DEVELOPMENT ENGINEER


6

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D.D. 8 E 9


#### **GENERAL NOTES**

- (1) WOOD OR STEEL POSTS (W6X9 OR W6X8.5) MAY BE USED. DO NOT INTERMIX WOOD AND STEEL POSTS. INSTALL STEEL POSTS WITH HOLES ON APPROACHING TRAFFIC SIDE.
- 2 USE WOOD OR APPROVED PLASTIC BLOCKOUTS. WOOD BLOCKOUTS MAY BE CONSTRUCTED OUT OF TWO OR MORE WOOD BLOCKOUTS. SEE ALTERNATE WOOD BLOCKOUT DETAIL. DIMENSIONS OF APPROVED PLASTIC BLOCKOUTS MAY VARY.
- (3) IF ROCK IS ENCOUNTERED DURING EXCAVATION, PROVIDE A HOLE 12 INCHES IN DIAMETER EXTENDING 20 INCHES DEEP INTO THE ROCK. PLACE APPROXIMATELY 21/2 INCHES OF GRANULAR MATERIAL IN THE BOTTOM OF THE HOLE. CUT THE POSTS THE TO LENGTH AMD INSTALL. BACKFILL WITH EXCAVATED MATERIAL AND COMPACT. BACKFILL IS TO BE FREE OF LARGE ROCKS.
- (4) WHEN THE DISTANCE FROM BACK OF POST TO SHOULDER HINGE POINT IS LESS THAN 2 FEET INSTALL LONGER POST AT HALF POST SPACING (K).
- (5) FOR NEW MGS INSTALLATION TOP OF W-BEAM RAIL TOLERANCE IS ± 1". FOR EXISTING MGS INSTALLATION TOP OF W-BEAM IS BETWEEN 273/4" TO 32".
- (6) WHEN USING STEEL POST AND WOOD BLOCKOUTS INSTALL FOUR 16D GALVANIZED NAILS. INSTALL NAILS AT THE BACK CORNERS OF THE BLOCK AND BEND THE NAILS OVER THE FLANGE OF THE STEEL POST.

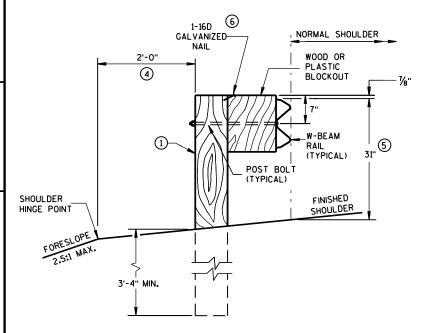

**END VIEW** 


LOCATED ALONG A ROADWAY SHOULDER STANDARD INSTALLATION

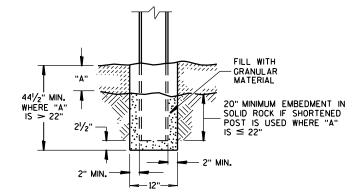


SETTING STEEL OR WOOD POST IN ROCK  $^{\scriptsize{\textcircled{3}}}$ 




END VIEW
LOCATED ALONG A CURBED ROADWAY

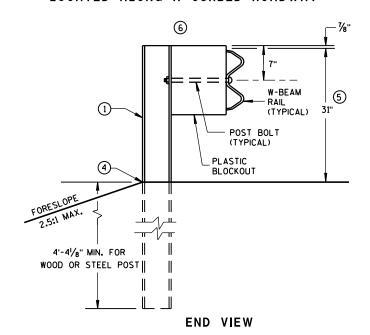


MGS LONGER POST AT HALFPOST SPACING W BEAM (K)

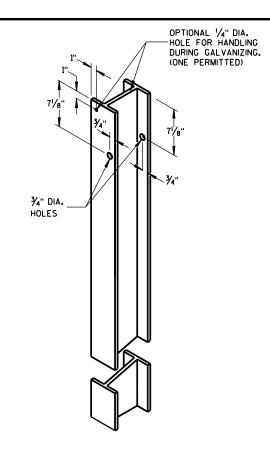


STEEL POST & HOLE PUNCHING DETAIL (w6X9)

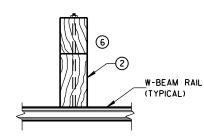

PLAN VIEW
WOOD POST,
BLOCKOUT & BEAM

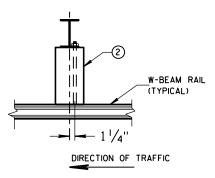

PLAN VIEW
STEEL POST,
PLASTIC BLOCKOUT & BEAM

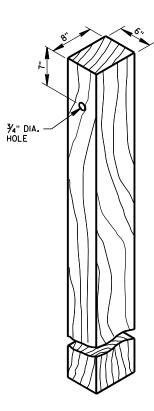

WOOD POST (6" X 8") NOMINAL  $^{\scriptsize \textcircled{1}}$ 



WOOD OR PLASTIC BLOCKOUT

MIDWEST GUARDRAIL SYSTEM (MGS) GUARDRAIL

STATE OF WISCONSIN
DEPARTMENT OF TRANSPORTATION

S.D.D. 14 B 4


6


.D.D. 14 B

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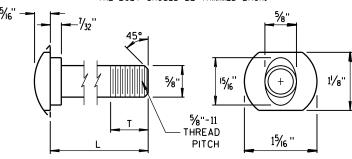


#### DETAIL FOR 36" BLOCKOUT DEPTH

NOTES: UNDER SPECIAL CIRCUMSTANCES, SUCH AS AVOIDING OBSTACLES THAT ARE NOT RELOCATED, IT IS ACCEPTABLE TO INSTALL ADDITIONAL BLOCKOUTS TO OBTAIN UP TO 36" DEPTH FOR ONE OR TWO POSTS IN A SECTION OF GUARDRAIL.

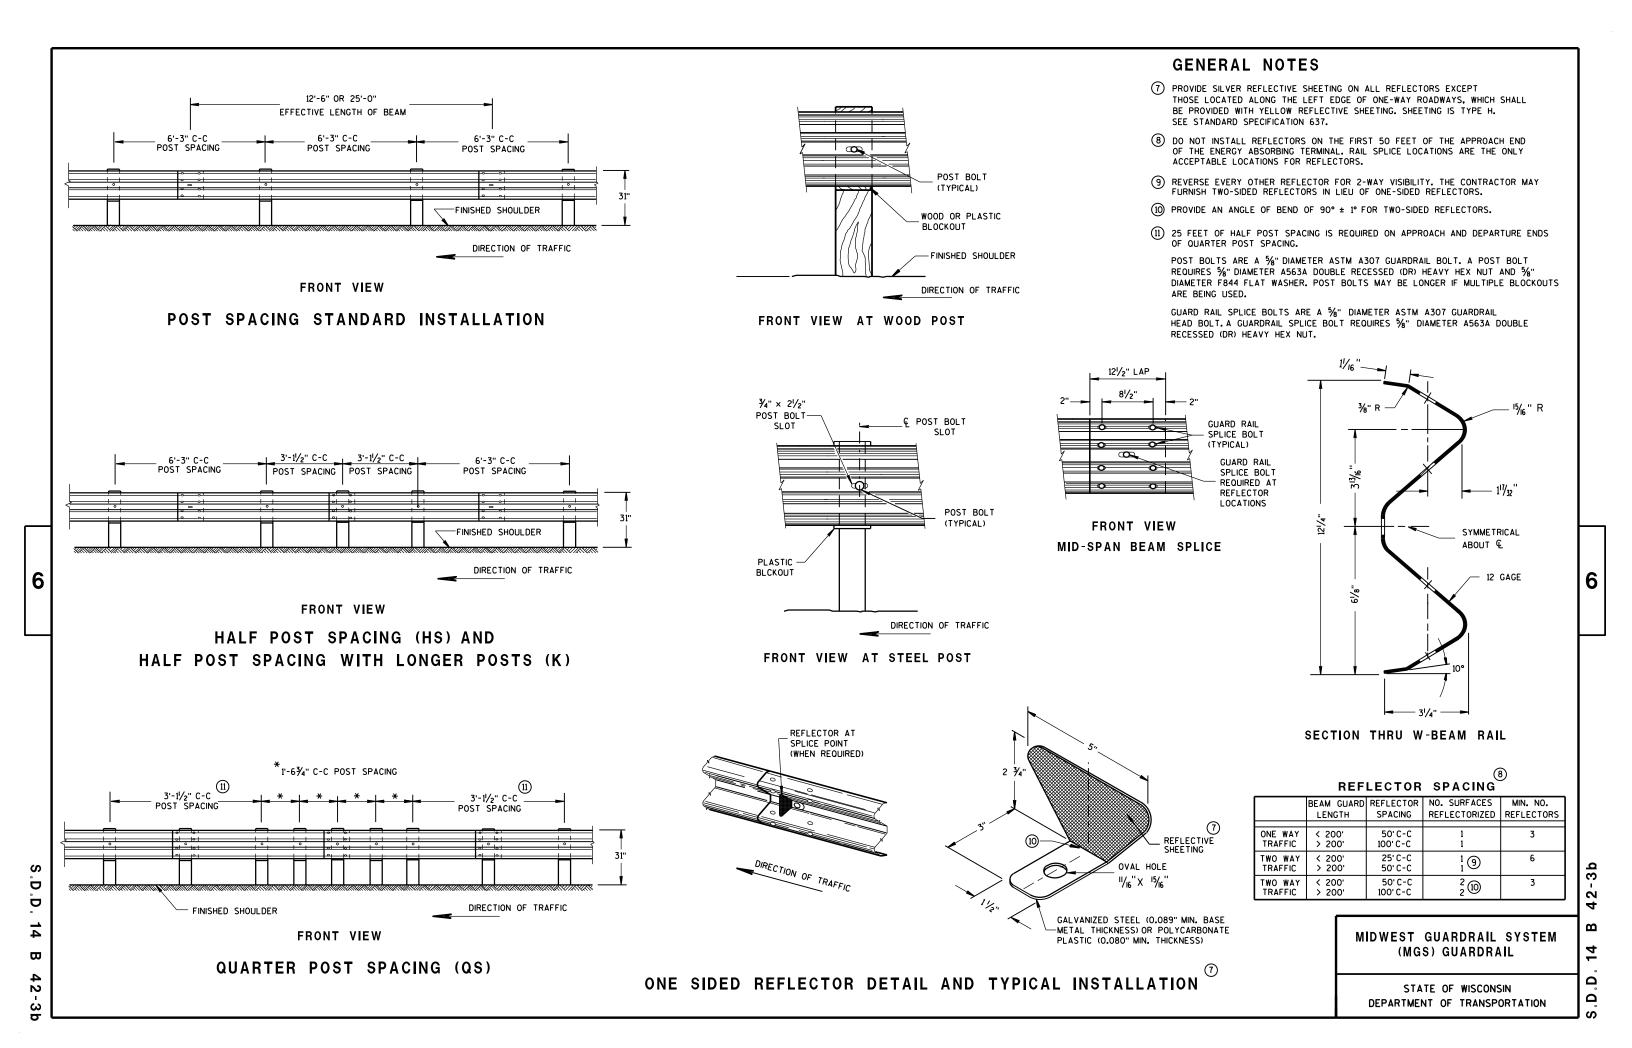
> DO NOT USE 16" OR 36" BLOCKOUTS IF IT CAUSES THE POST TO BE DRIVEN BEYOND SHOULDER HINGE POINT OR CAUSES A FIXED OBJECT TO BE WITHIN THE DEFLECTION DISTANCE OF THE BARRIER.

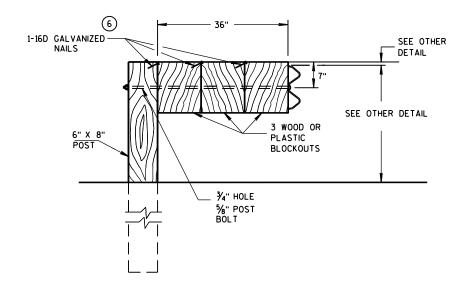NOTE: 1. ALL FILLETS SHALL HAVE A MINIMUM RADIUS OF  $\frac{1}{16}$ ". 2. IF THE BOLT EXTENDS MORE THAN 1/4" FROM THE NUT THE BOLT SHOULD BE TRIMMED BACK.




#### POST BOLT TABLE


11/8"
437
13/4"
4"
41/16"
4"
41/16"
4"

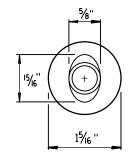

ALTERNATE BOLT HEAD

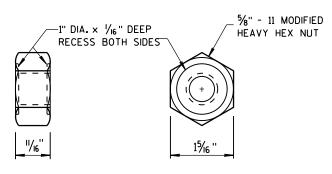


POST BOLT AND RECESS NUT

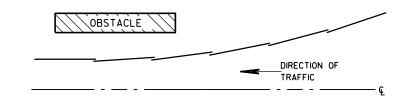


#### **PLAN VIEW**

#### **BEAM LAPPING DETAIL**

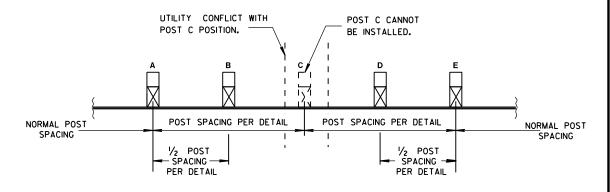

#### POST DRIVING FOR CONTINUOUS UNDERGROUND OBSTRUCTION



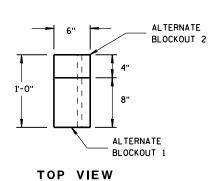

SIDE VIEW

#### ALTERNATE WOOD **BLOCKOUT DETAIL**

MIDWEST GUARDRAIL SYSTEM (MGS) GUARDRAIL

STATE OF WISCONSIN DEPARTMENT OF TRANSPORTATION

APPROVED

June 2014 /S/ Jerry H. Zogg ROADWAY STANDARDS DEVELOPMENT ENGINEER FHWA

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# SECTION A-A SECTION B-B

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PLAN VIEW

#### BILL OF MATERIALS

PART NO.	DESCRIPTION  MATERIALS PROVIDED BY MGS EAT MANUFACTURER. SEE MANUFACTURER'S DETAILS FOR MORE INFORMATION.	
1	WOOD BREAKAWAY POST	
2	6" X 8" X 0.188", 6'-0" LONG FOUNDATION TUBE AT POSTS 1AND 2	
3	WOOD CRT	
4	WOOD BLOCKOUT	
(5)	PIPE SLEEVE	
6	BEARING PLATE	
7	BCT CABLE ASSEMBLY	
8	ANCHOR CABLE BOX	
9	GROUND STRUT	
10	PERFORATED W-BEAM RAIL END PANEL, 12'-6" LONG.	
(11)	STANDARD W-BEAM RAIL.MULTIPLE SECTIONS REQUIRED. SECTIONS VARY IN LENGTH.	
12	END SECTION EAT	
(3)	0.040" ALUMINUM SHEET WITH REFLECTIVE SHEETING TYPE F PER SECTION 637 OF THE STANDARD SPECIFICATIONS	
14)	EAT MARKER POST - YELLOW (SEE APPROVED PRODUCTS LIST)	



MIDWEST GUARDRAIL SYSTEM ENERGY ABSORBING TERMINAL (MGS)

STATE OF WISCONSIN DEPARTMENT OF TRANSPORTATION

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#### TYPICAL SIDEROAD APPROACH WARNING SIGN DETAIL

#### GENERAL NOTES

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THE EXACT NUMBER, LOCATION, AND SPACING OF ALL SIGNS AND DEVICES SHALL BE ADJUSTED TO FIT FIELD CONDITIONS.


THE SPACING BETWEEN TRAFFIC CONTROL SIGNS SHOULD BE ADJUSTED TO NOT CONFLICT WITH AND SHOULD PROVIDE A MINIMUM OF 200 FEET (500 FEET DESIRABLE) CLEARANCE TO EXISTING SIGNS THAT WILL REMAIN IN PLACE.

ALL SIGNS ARE 48"×48" UNLESS OTHERWISE NOTED.


SIGNS THAT WILL BE IN PLACE LESS THAN 7 CONTINUOUS DAYS AND NIGHTS MAY BE MOUNTED ON PORTABLE SUPPORTS.

IF A "STOP" SIGN MUST BE REMOVED FOR A WORK OPERATION, A TEMPORARY "STOP" SIGN SHALL BE PLACED PRIOR TO THE SIGN REMOVAL, OR A FLAGGER SHALL BE PROVIDED UNTIL THE SIGN IS RE-ESTABLISHED.


- \* OMIT G20-1 SIGNS IF LENGTH OF WORK AREA IS 2 MILES OR LESS.
- \* PLACE ADDITIONAL W20-1 "ROAD WORK AHEAD" SIGN IF WORK AREA WITHIN THE PROJECT IS SEPARATED BY MORE THAN 2 MILES FROM PREVIOUS WORK AREA.

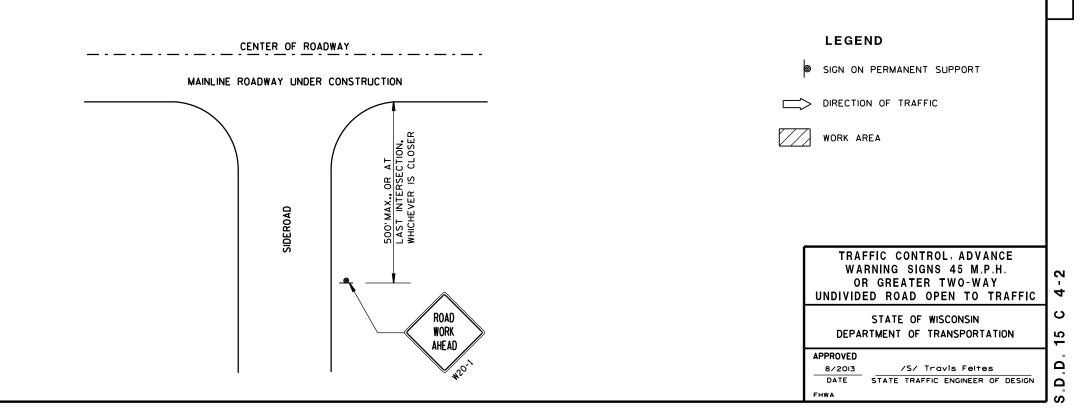



6

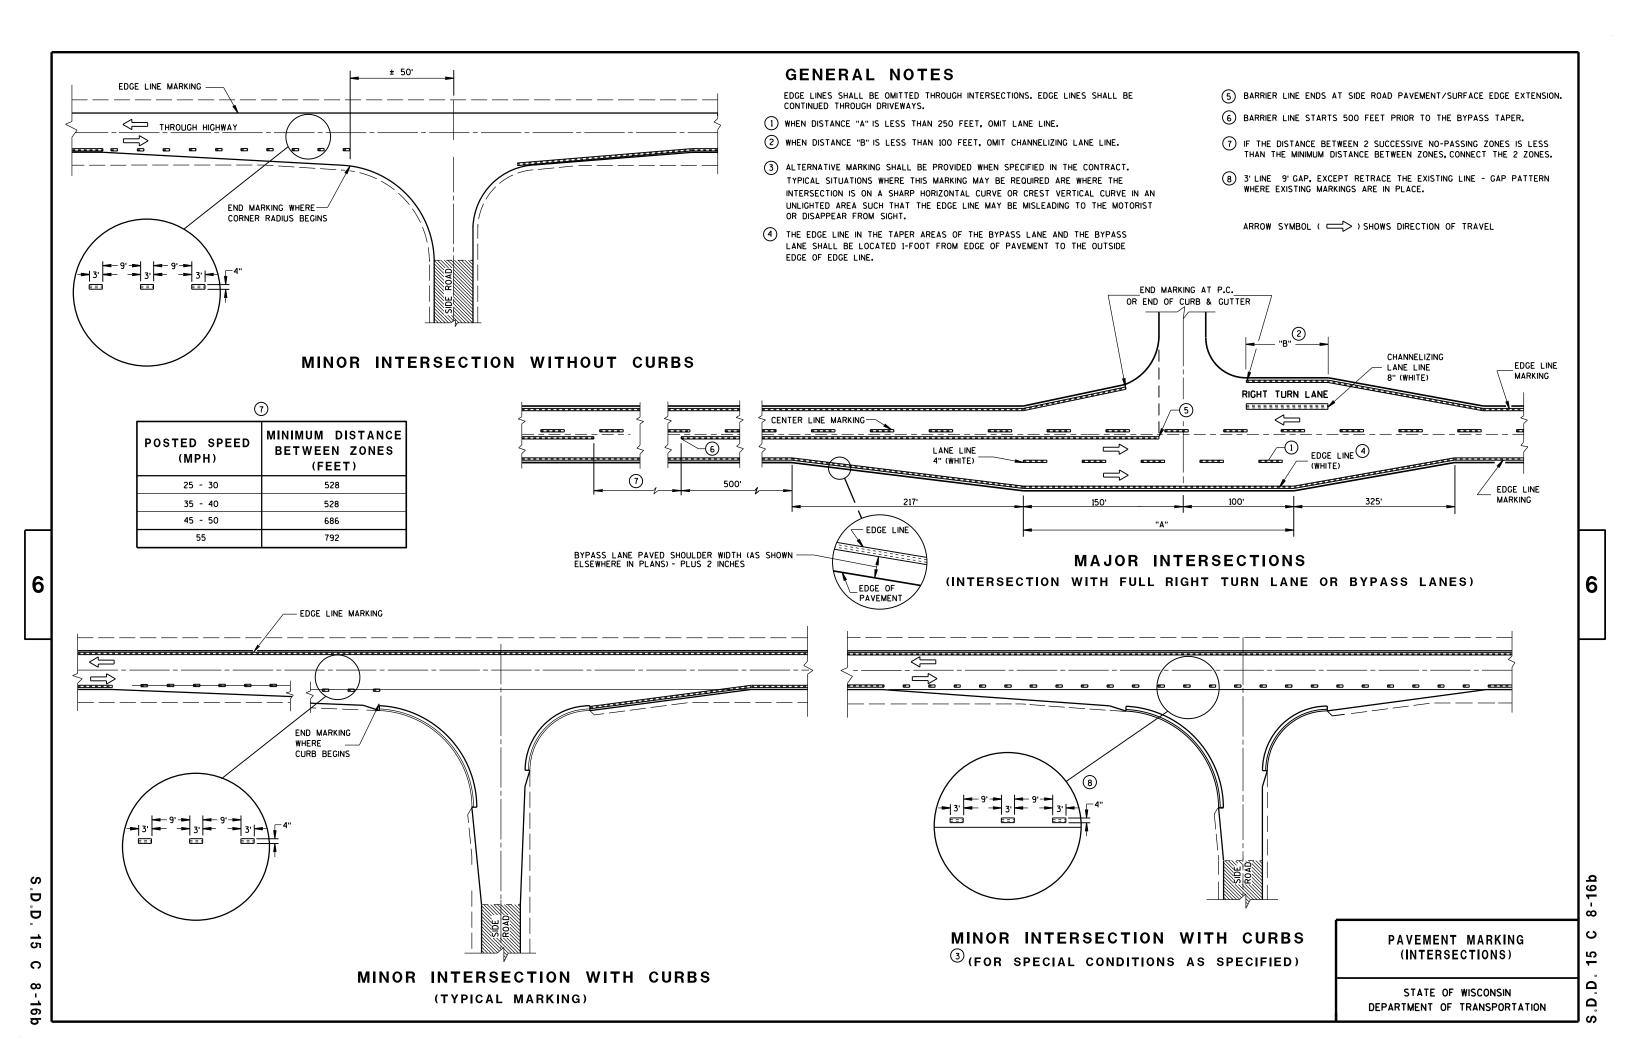




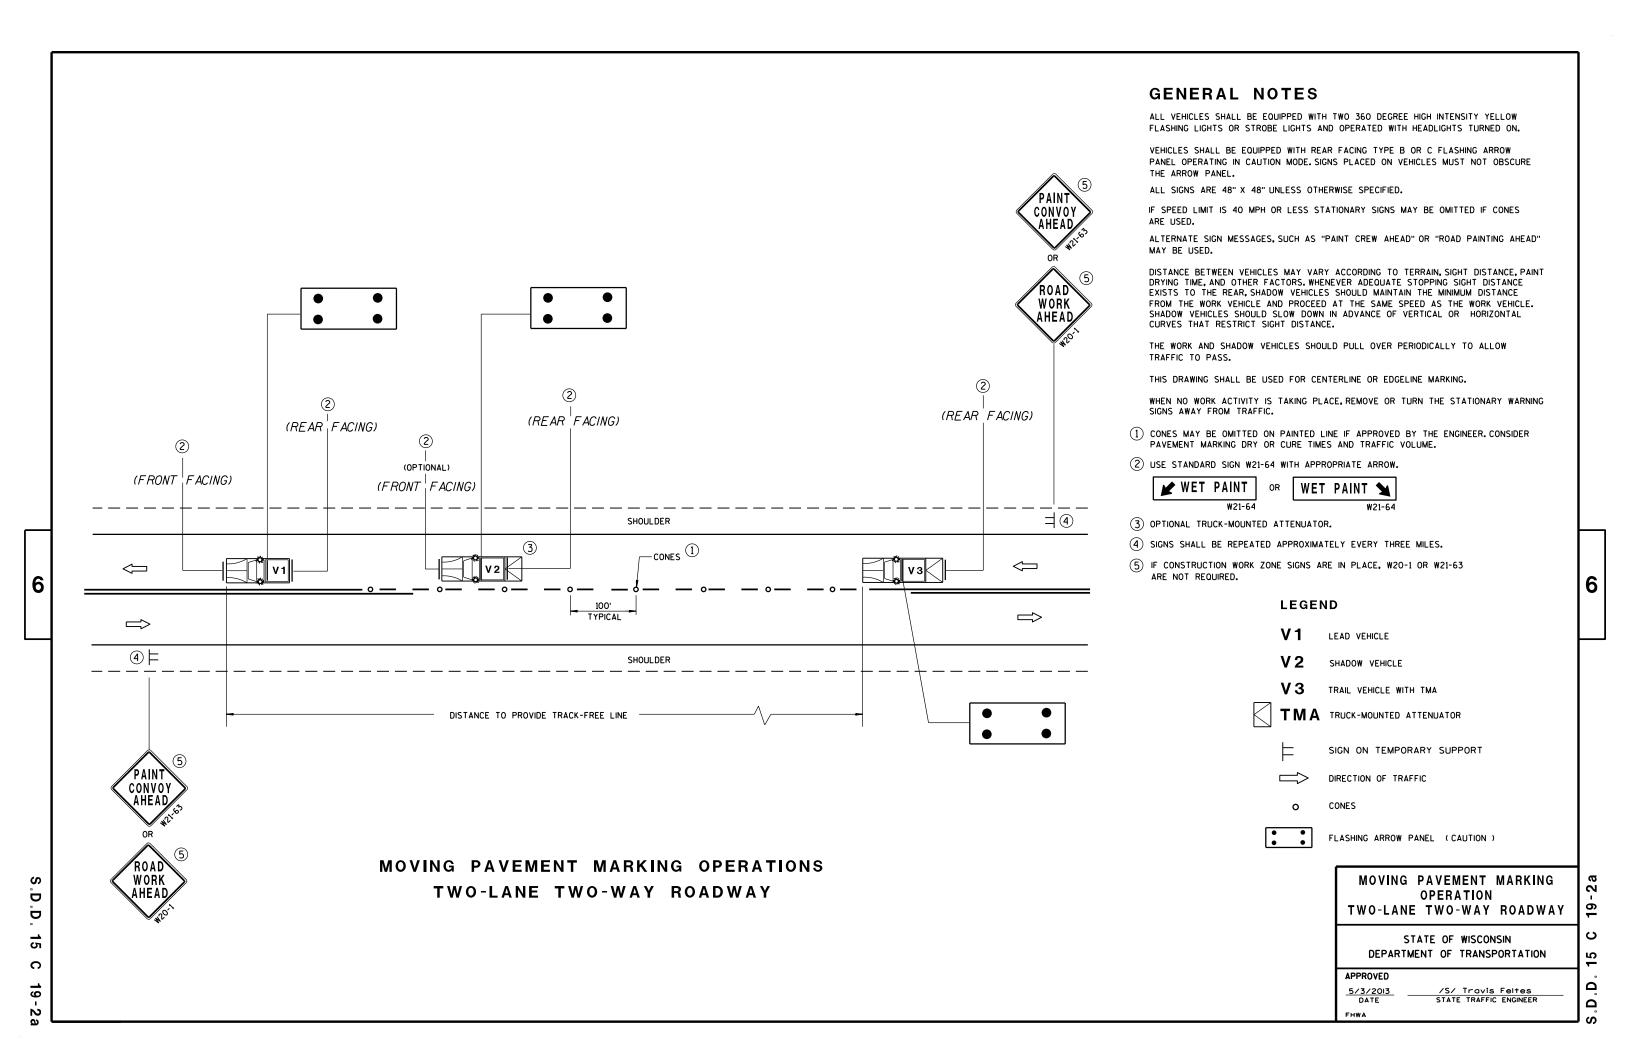

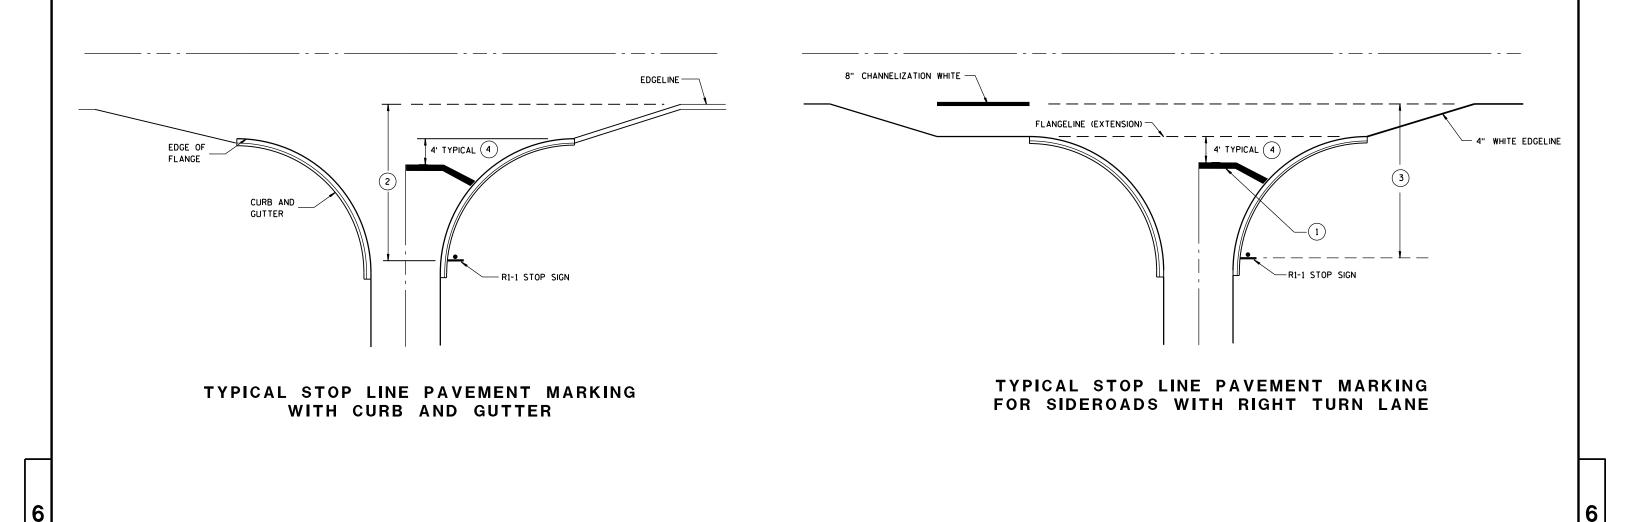

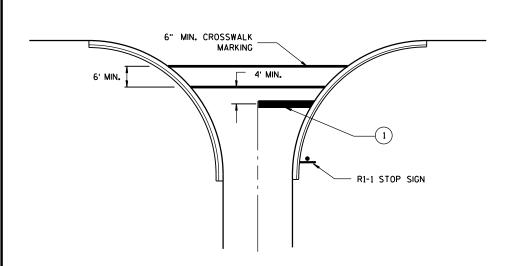

TYPICAL STOP LINE PAVEMENT MARKING FOR SIDEROADS WITH CROSSWALK MARKING

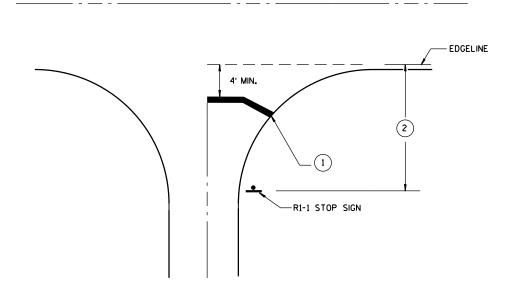

TYPICAL STOP LINE PAVEMENT MARKING WITHOUT CURB AND GUTTER

#### GENERAL NOTES

- 1 18-INCH STOP LINES MAY BE DELETED OR ADDED BY THE PROJECT ENGINEER BASED ON VISIBILITY AND SIGHT LINES.
- 2 IF STOP SIGN IS LESS THAN OR EQUAL TO 40 FEET FROM THE EDGELINE THAN NO STOP LINE IS REQUIRED.
- (3) IF STOP SIGN IS LESS THAN OR EQUAL TO 30 FEET FROM THE FLANGELINE EXTENSION THAN NO STOP LINE IS REQUIRED.
- MOVE CLOSER TO EDGE OF TRAVEL LANE AS NEEDED FOR VISIBILITY AND SIGHT LINES.

## STOP LINE AND CROSSWALK PAVEMENT MARKING

STATE OF WISCONSIN
DEPARTMENT OF TRANSPORTATION


APPROVED	
4/30/2013	/S/ Travis Feltes
DATE	STATE TRAFFIC ENGINEER
FHWA	

.D.D. 15 C 33-1


S.D.D.


33

### URBAN ARFA

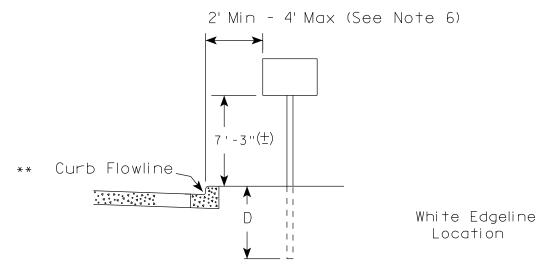

RURAL AREA (See Note 2)

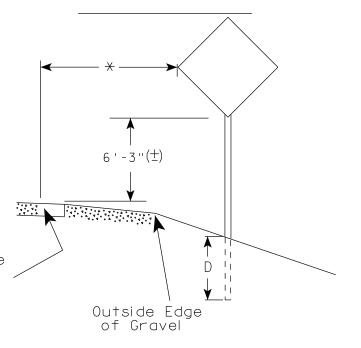

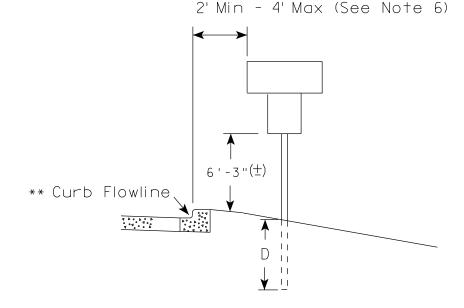

5'-3"(生) White Edgeline  $D^{-1}$ Location Outside Edae of Gravel

\*\* The existence of curb and gutter does not in itself mandate the vertical clearance illustrated. That height is typically measured where

there is sidewalk adjacent to the roadway or parking is permitted. In the absence of sidewalk vertical clearance is measured from the top of the curb. Offset of signs is measured from the flow line.

HWY:

\* 6 feet from edge of a paved shoulder or 12 feet from the edge of pavement (edge line location) or 2 feet from outside edge of gravel, whichever is greater unless directed by project engineer.

PLOT BY: mscsja

GENERAL NOTES

- 1. Signs wider than 4 feet, 20 sq.ft or larger, shall be mounted on multiple posts. Refer to plate A4-4.
- 2. If signs are mounted on barrier wall, see A4-10 sign plate.
- 3. For expressways and freeways, mounting height is  $7'-3''(\pm)$  or 6'-3" (±) depending upon existence of a sub-sign.
- 4. Minimum mounting height for J assemblies (A2-1S) is  $7'-3''(\pm)$  or  $6'-3''(\pm)$ per urban or rural detail respectively.
- 5. Minimum mounting height for signs mounted on traffic signal poles is  $5' - 3'' (\pm)$ .
- 6. Offset distance shall be consistent with existing signs or consistent throughout length of project.
- 7. The (+) tolerance for mounting height is 3 inches.
- 8. Folding signs shall be mounted at a height of 5'-3'' ( $\pm$ ) or as directd by the Engineer.
- 9. The Double Arrow sign (W12-1) shall be mounted at a height of 2'-3"  $(\pm)$ . The Chevron sign (W1-8), Roundabout Chevron panel (R6-4B), Enhanced Reference Markers, Clearance Markers (W5-52), Mile Markers (D10 series), In Road Object Markers (W5-54) & End of Road Markers (W5-56) shall be mounted at a height of 4'-3'' ( $\pm$ ).

#### POST EMBEDMENT DEPTH

Area of Sign	
Installation	D
( Sq.Ft.)	(Min)
20 or Less	4'
Greater than 20	5'

TYPICAL INSTALLATION OF PERMANENT TYPE II SIGNS ON SINGLE POSTS

WISCONSIN DEPT OF TRANSPORTATION

SHEET NO:

APPROVED

for State Traffic Engineer

DATE 11/12/14


PROJECT NO: FILE NAME : C:\CAEFiles\Projects\tr\_stdplate\A43.DGN COUNTY:

PLOT DATE: 12-NOV-2014 14:03

PLOT NAME :

PLOT SCALE: 99.237937:1.000000

WISDOT/CADDS SHEET 42

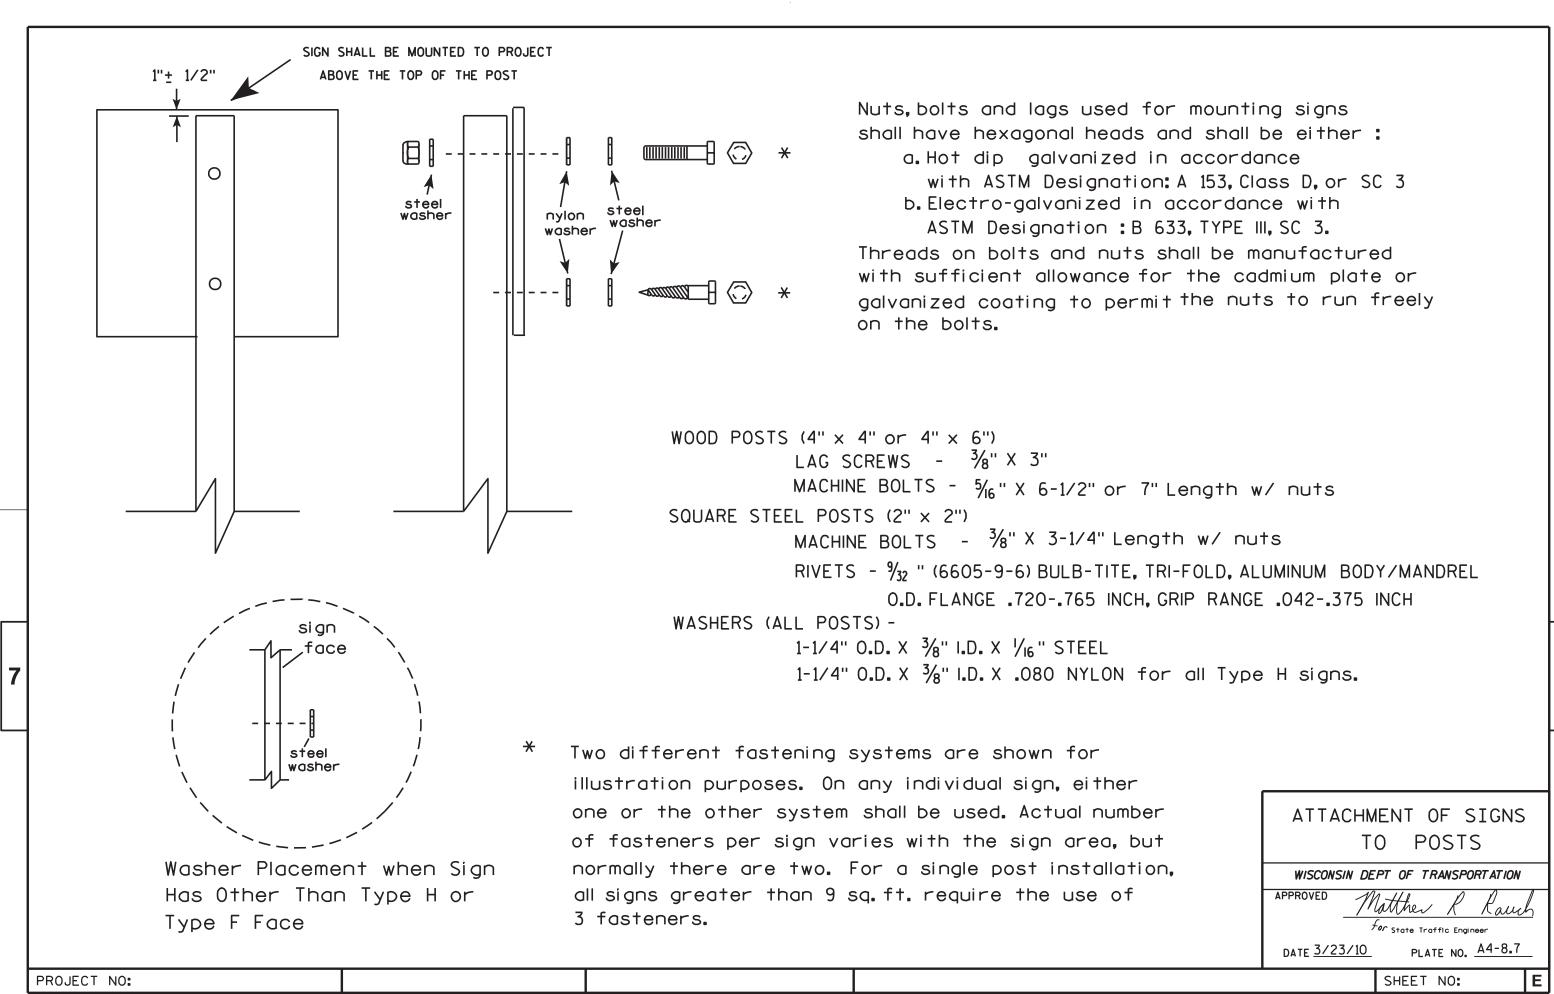


## NOTES

- 1. Sign is Type II Type F Reflective reference WIS DOT Standard Specification for HIGHWAY and STRUCTURE CONSTRUCTION latest edition.
- 2. Color:

Background - Yellow Message - Black

- 3. Corners may be square or rounded when base material is plywood but borders shall be rounded as shown. When base material is metal, the corners and borders shall be rounded.
- 4. W1-2L is the same as W1-2R except the arrow is reversed along the vertical centerline.

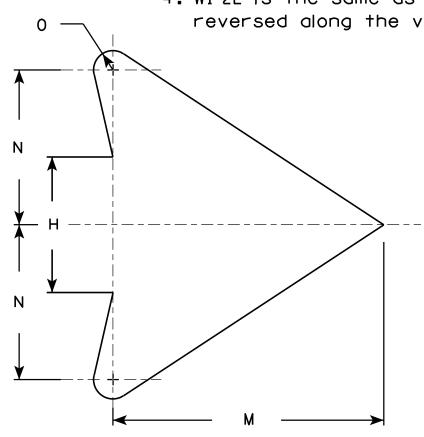

ARROW DE	TAIL
----------	------

	W1-2R															ANNOW DETAIL											
SIZE	Α	В	С	D	E	F	G	Н	I	J	K	L	M	N	0	Р	0	R	S	Т	U	v	W	×	Y	Z	Area sq. ft.
1	24		1 1/8	3/8	1/2		8 1/4	3 1/2	4 1/2	1 3/4	2 3/8	7 1/4	7	4	1/2												4.0
25	30		1 3/8	1/2	5/8		10 1/4	4 3/8	5 %	2 1/4	3	9 1/8	8 3/4	5	5/8												6.25
2M	36		1 5/8	5/8	3/4		12 3/8	5 1/4	6 3/4	2 %	3 1/2	10 1/8	10 1/2	6	3/4												9.0
3	36		1 5/8	5/8	3/4		12 3/8	5 1/4	6 3/4	2 %	3 1/2	10 1/8	10 1/2	6	3/4												9.0
4	36		1 1/8	5/8	3/4		12 3/8	5 1/4	6 3/4	2 5/8	3 1/2	10 1/8	10 1/2	6	3/4												9.0
5	48		2 1/4	3/4	1		16 1/2	7	9	3 1/2	4 %	14 1/2	14	8	1												16.0
•					•	•	•	•	•	•		•		•	•	•	•	•		•	•	•	•		•	•	

COUNTY:

STANDARD SIGN W1-2

WISCONSIN DEPT OF TRANSPORTATION

APPROVED

Matthew R Rauch

For State Traffic Engineer

DATE <u>5/15/12</u>


/15/12 PLATE NO. W1-2.10

SHEET NO:

PROJECT NO:

**←** H →

HWY:

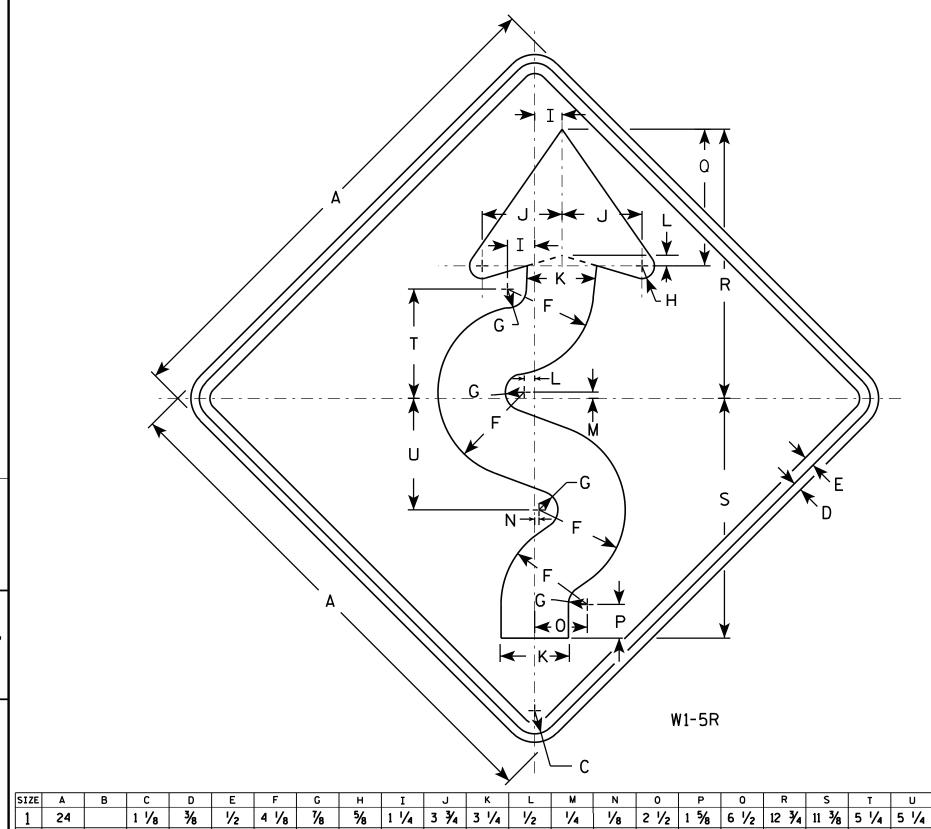

## NOTES

- 1. Sign is Type II Type F Reflective reference WIS DOT Standard Specification for HIGHWAY and STRUCTURE CONSTRUCTION latest edition.
- 2. Color:

Background - Yellow Message - Black

- 3. Corners may be square or rounded when base material is plywood but borders shall be rounded as shown. When base material is metal, the corners and borders shall be rounded.
- 4. W1-5L is the same as W1-5R except the arrow is reversed along the vertical centerline.

4.0 1 3/8 3/<sub>4</sub> | 1 5/<sub>8</sub> | 4 3/<sub>4</sub> | 4 1/<sub>8</sub> | 5/<sub>8</sub> 3 1/8 30 % | 5 ½ | 1 ½ | 2 8 1/8 16 | 14 1/4 | 6 1/2 | 6 5/8 6.25 1 1/8 5 5/8 4 1/8 3/4 2M 36 1 % 3/<sub>4</sub> | 6 |/<sub>4</sub> | 1 3/<sub>8</sub> 3 3/4 2 1/8 9 3/4 19 1/8 17 1/8 7 3/4 7 1/8 9.0 3 1 % 5 % 4 % 3 3/4 2 1/8 9 3/4 19 1/8 17 1/8 7 3/4 7 1/8 1 % 5/8 3/4 6 1/4 1 3/8 9.0 36 1 % 1 1/8 | 5 5/8 | 4 1/8 | 3/4 3 3/4 2 1/8 9 3/4 19 1/8 17 1/8 7 3/4 7 1/8 4 36 5/8 6 1/4 1 3/8 9.0 5 8 1/4 1 3/4 1 1/4 2 1/2 7 1/2 6 1/2 1 3/8 48 2 1/4 1/2 | 25 1/2 | 22 3/4 | 10 3/8 | 10 1/2 | 16.0

COUNTY:

STANDARD SIGN W1 - 5

WISCONSIN DEPT OF TRANSPORTATION

APPROVED

PLATE NO. W1-5.8

DATE 5/18/12

SHEET NO:

FILE NAME : C:\CAEFiles\Projects\tr\_stdplate\W15.DGN

PROJECT NO:


HWY:

PLOT DATE: 18-MAY-2012 13:08

PLOT BY: mscsja

PLOT SCALE: 5.706180:1.000000

WISDOT/CADDS SHEET 42

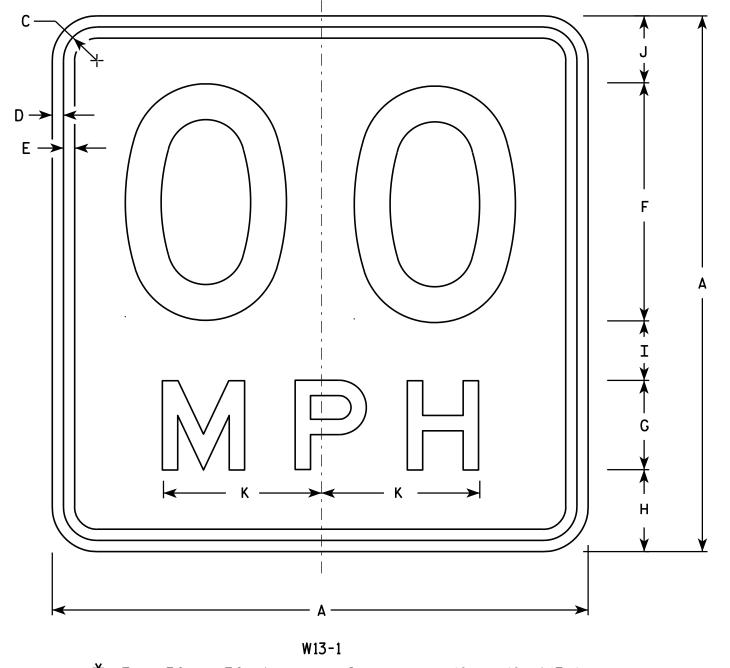

 $\star$  For 30" x 30" Warning Signs, use 18" x 18" W13-1 signs. For 36" x 36" Warning Signs, use 24" x 24" W13-1 signs.

## **NOTES**

- 1. Sign is Type II Type F Reflective reference WIS DOT Standard Specification for HIGHWAY and STRUCTURE CONSTRUCTION latest edition.
- 2. Color:

Background - Yellow Message - Black

PLOT NAME :

- 3. Message Series See Note 6
- 4. Corners may be square or rounded when base material is plywood but borders shall be rounded as shown. When base material is metal, the corners and borders shall be rounded.
- 5. Substitute appropriate numerals and optically space about centerline to achieve proper balance.
- 6. Line 1 is Series D Line 2 is Series E

	SIZE	Α	В	С	D	E	F	G	Н	I	J	K	L	М	N	0	Р	0	R	S	T	U	v	₩	x	Y	Z	Area sq. ft.
	1	18		1 1/8	3/8	3/8	8	3	2 3/4	2	2 1/4	5 3/8																2.25
<b>*</b>	2S	18		1 1/8	3/8	3%	8	3	2 3/4	2	2 1/4	5 3/8																2.25
<b>+</b>	2M	18		1 1/8	3/8	3/8	8	3	2 3/4	2	2 1/4	5 %																2.25
	3	24		1 1/8	3/8	1/2	10	4	4	2 3/4	3 1/4	6 %																4.00
	4	36		1 1/8	5/8	3/4	16	6	5 1/2	4	4 1/2	10 %																9.00
	5	36		1 %	5/8	3/4	16	6	5 1/2	4	4 1/2	10 %																9.00

COUNTY:

STANDARD SIGN W13-1

WISCONSIN DEPT OF TRANSPORTATION

APPROVED

Matther & Kaur For State Traffic Engineer


DATE 5/31/12


PLATE NO. W13-1.16


SHEET NO:


HWY:


PROJECT NO:

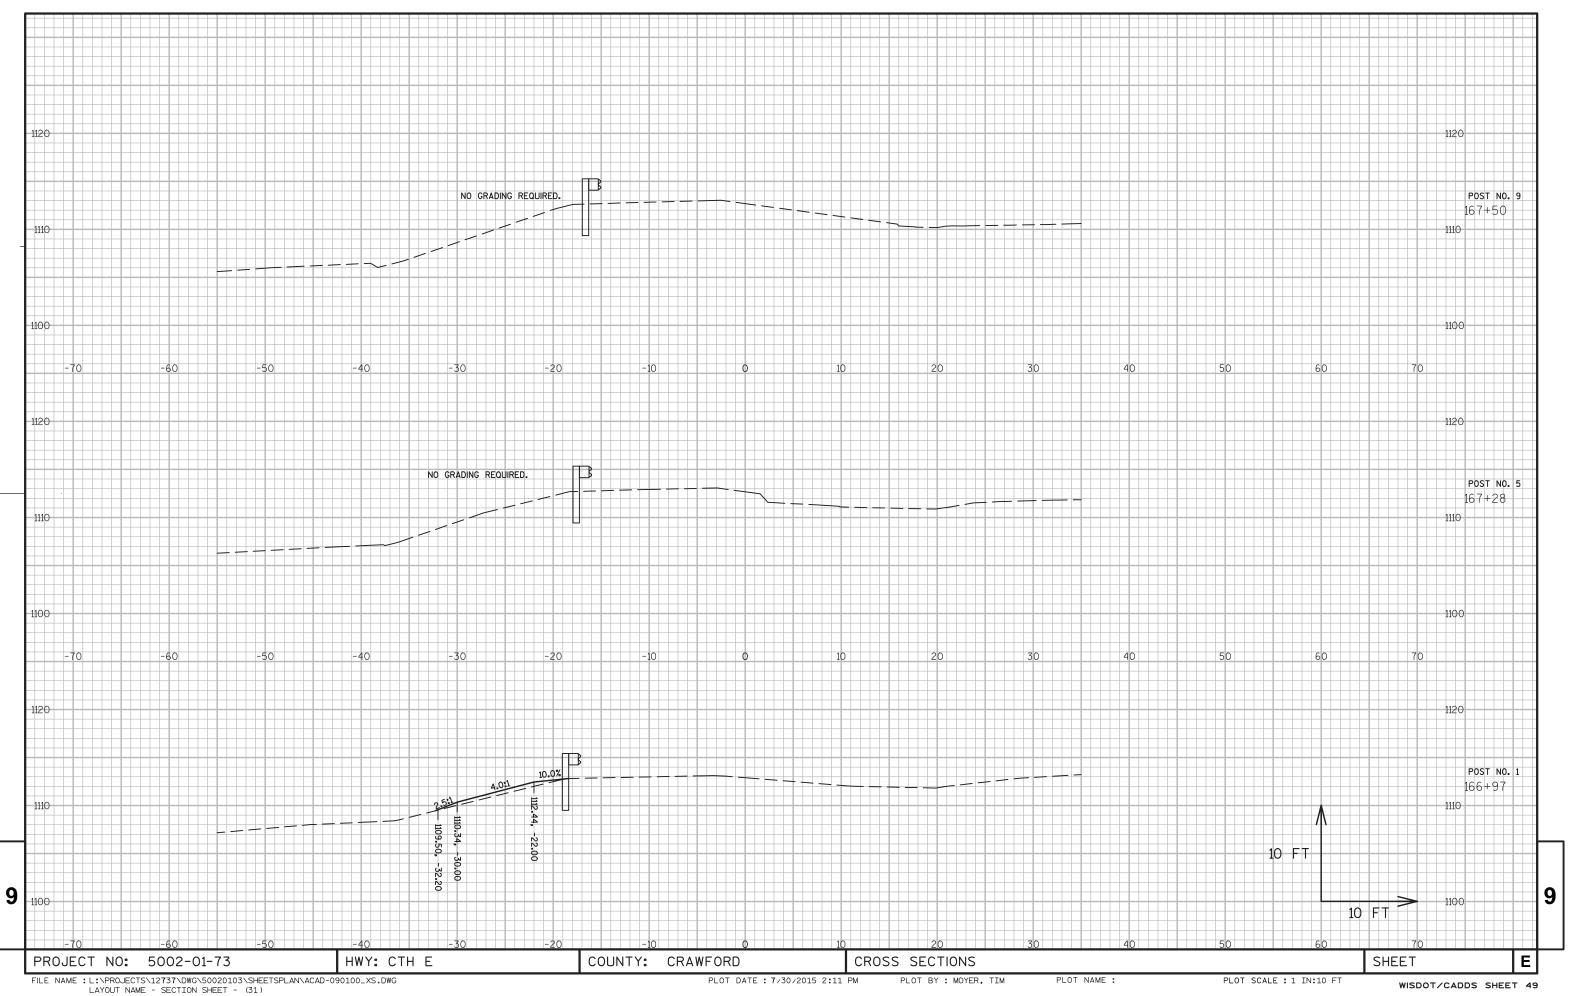

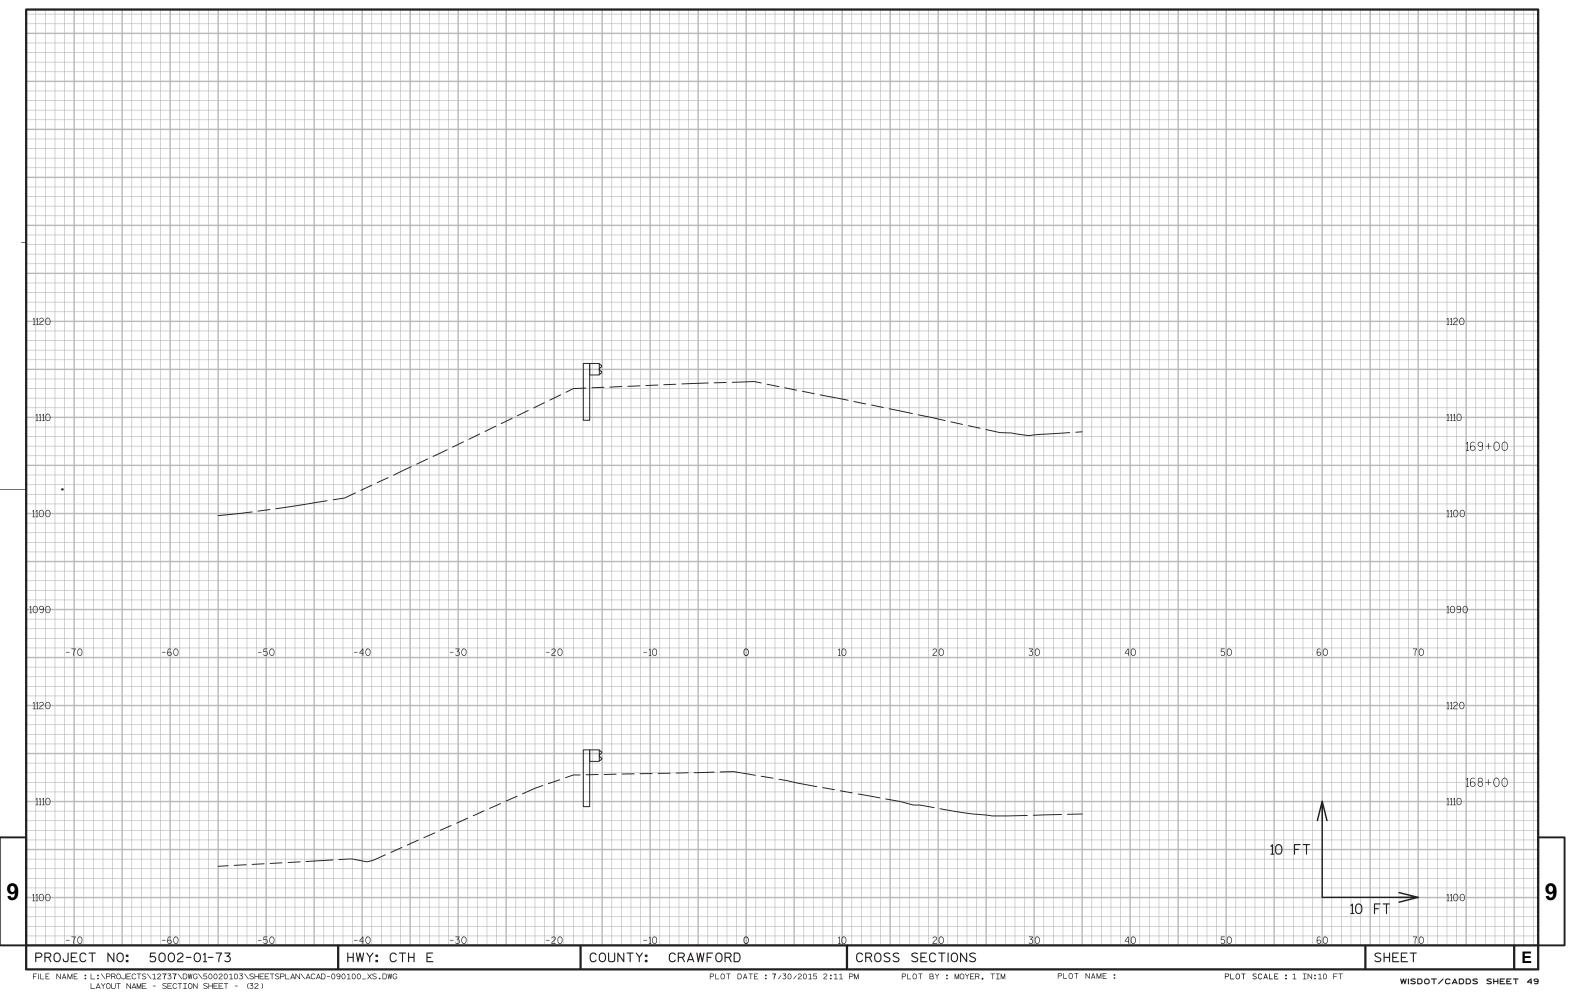


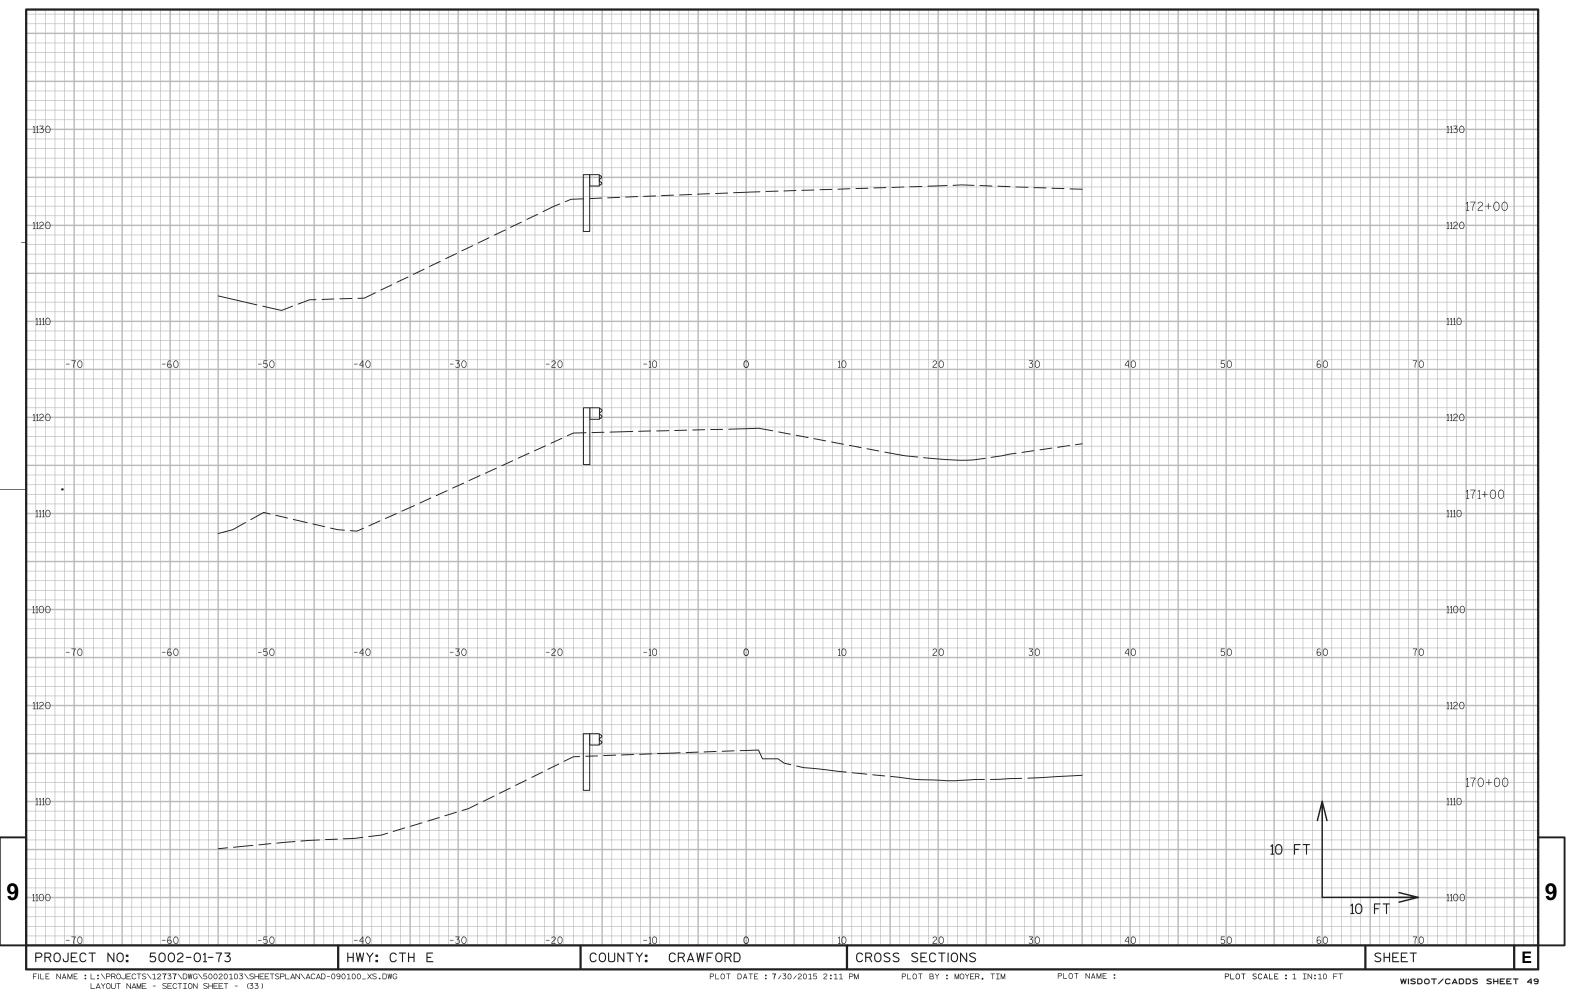


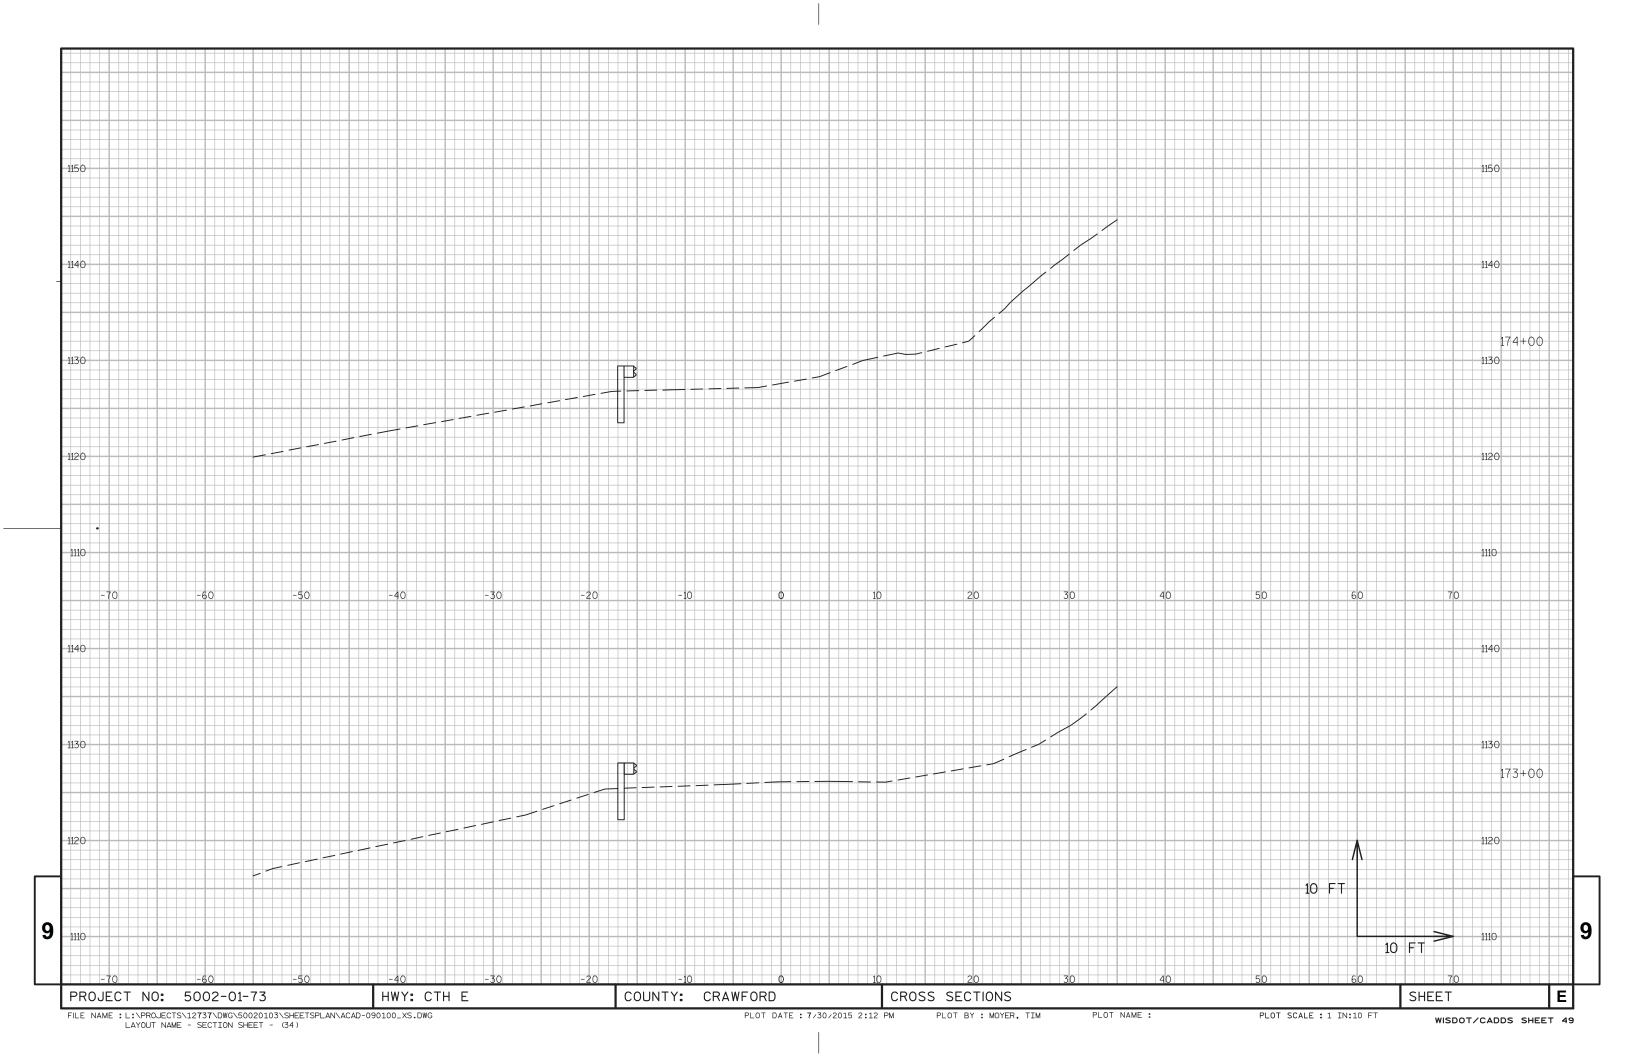


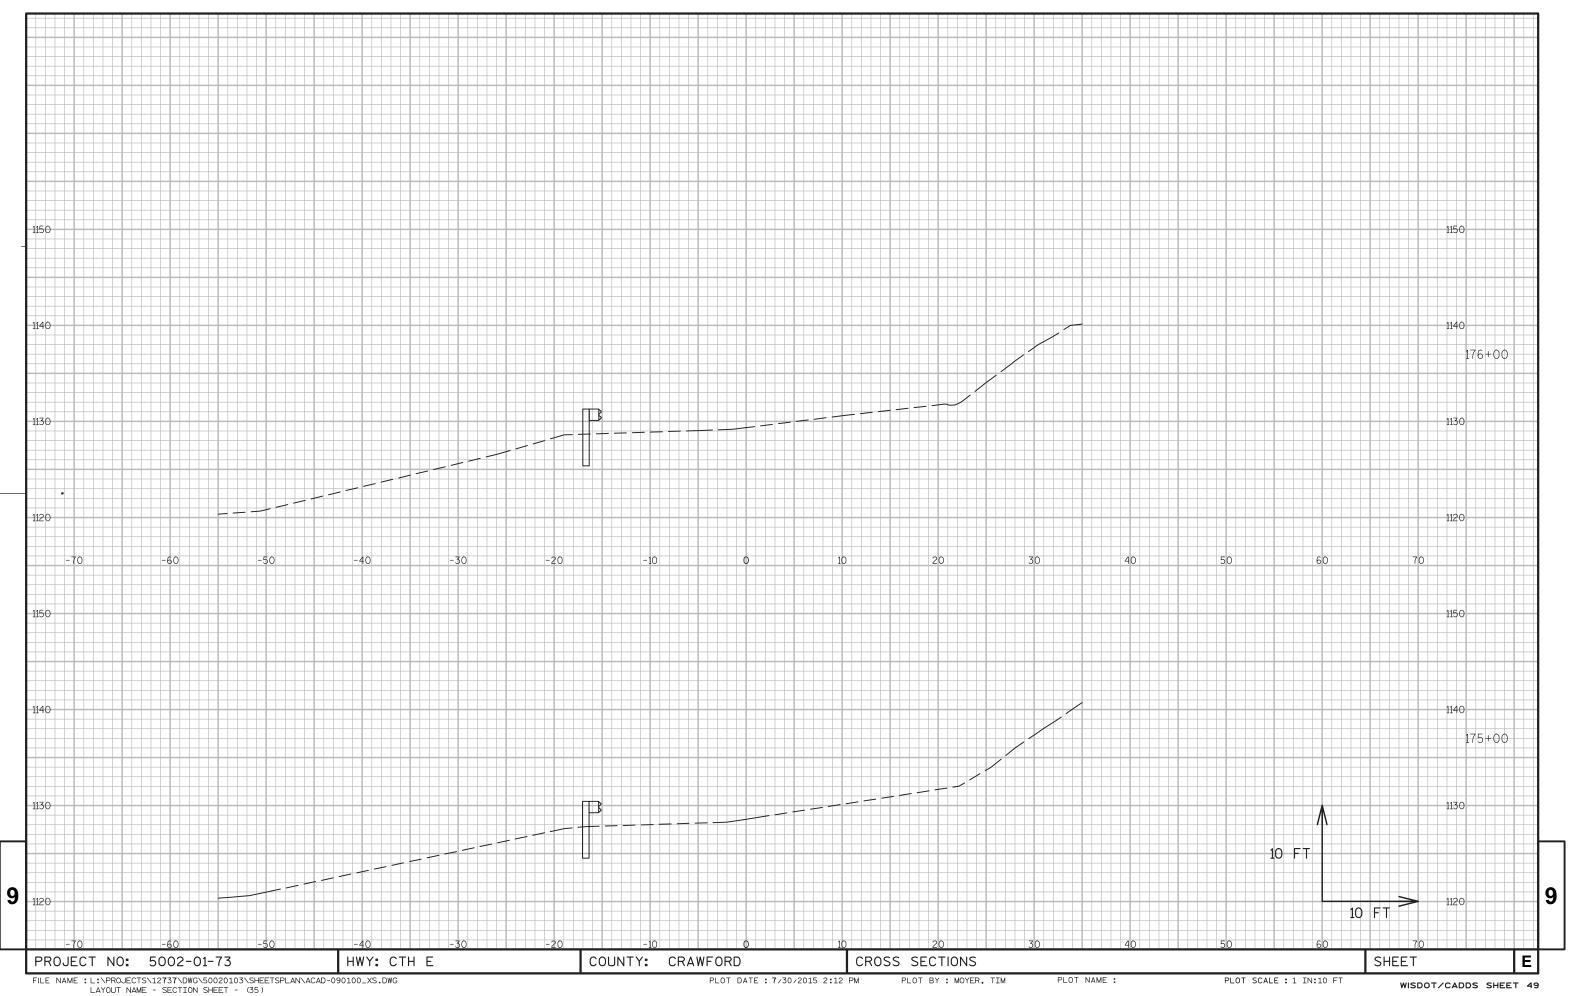



WISDOT/CADDS SHEET 49

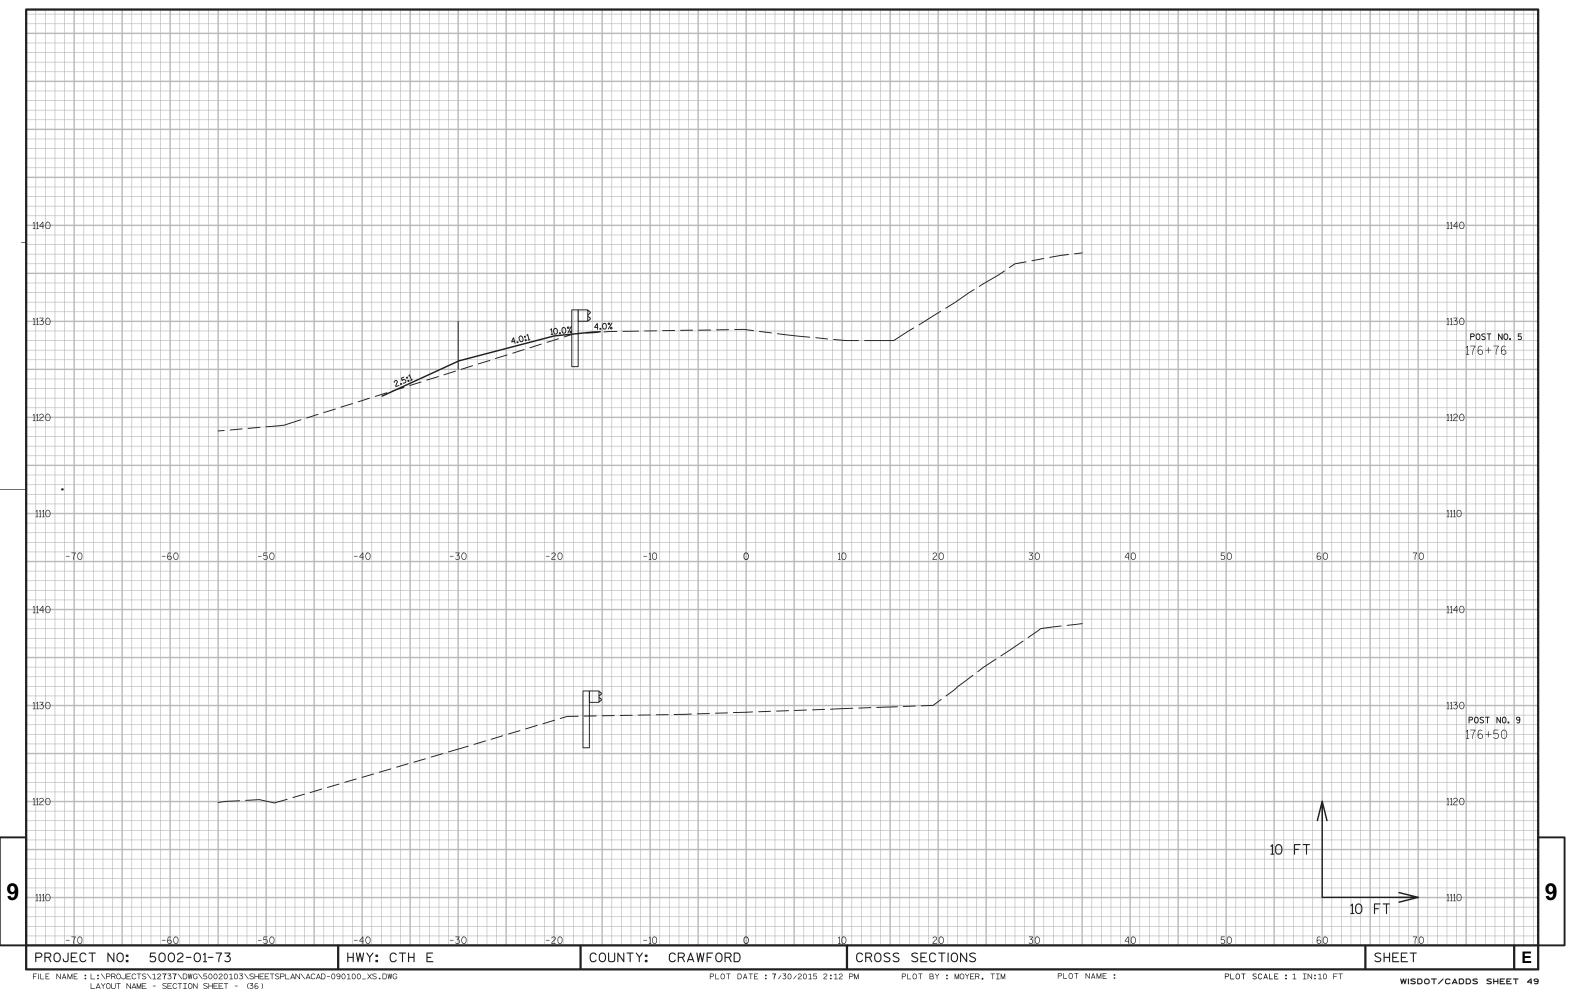


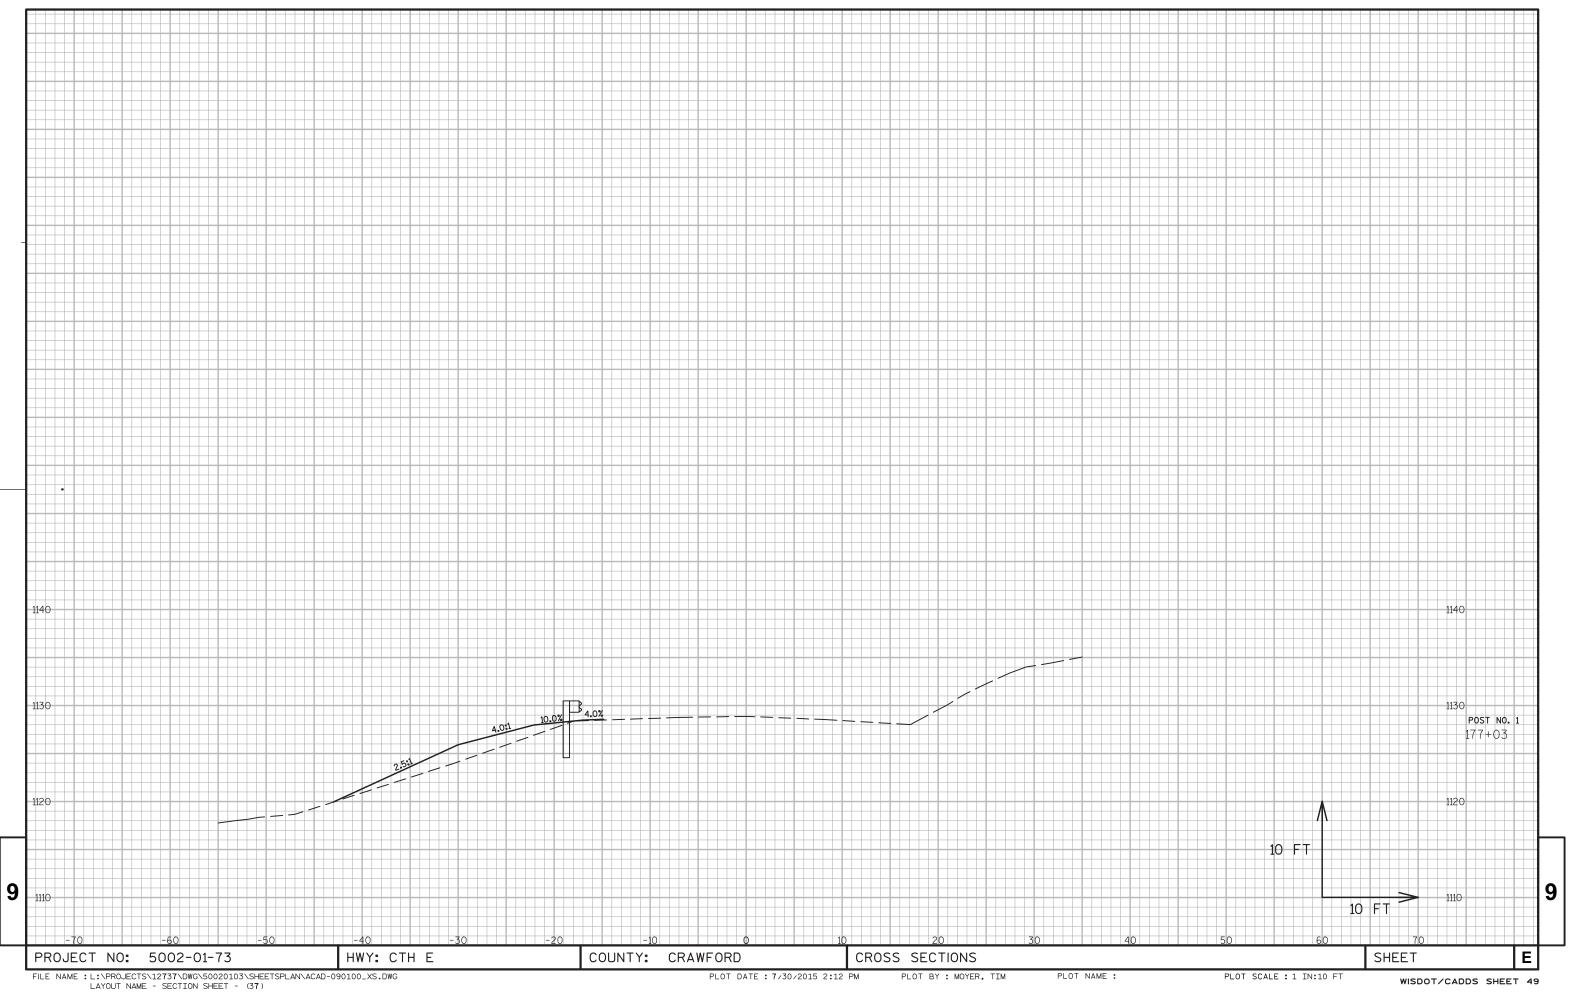


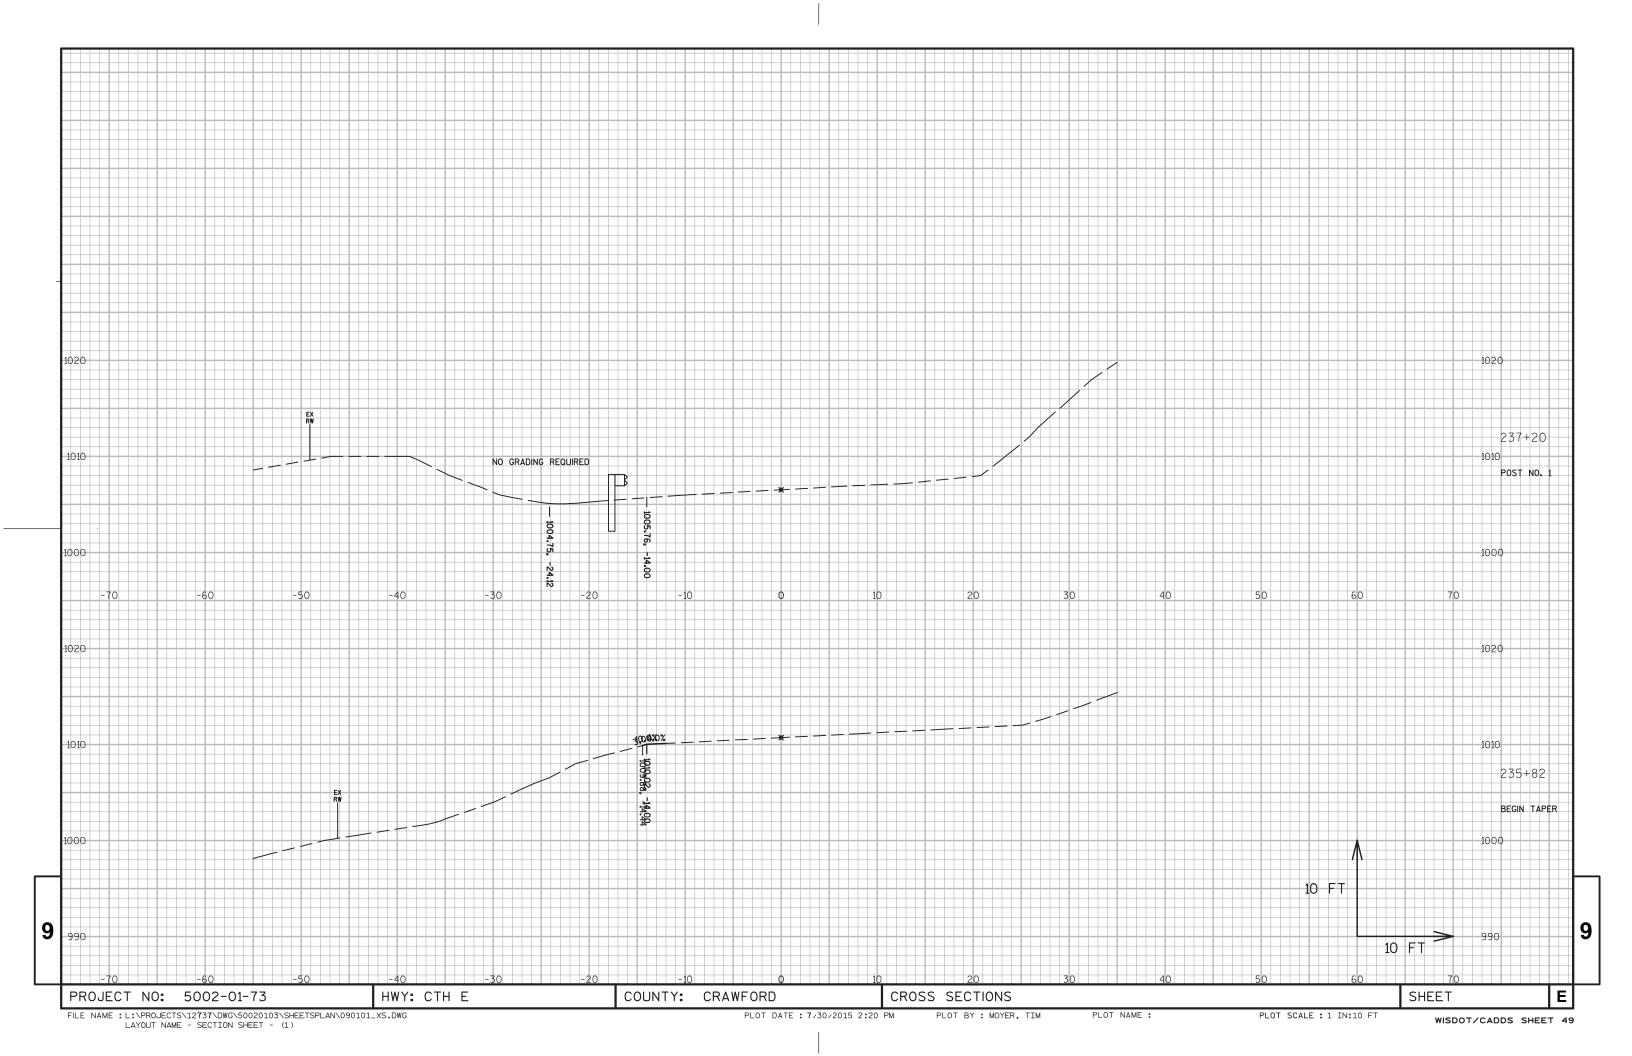


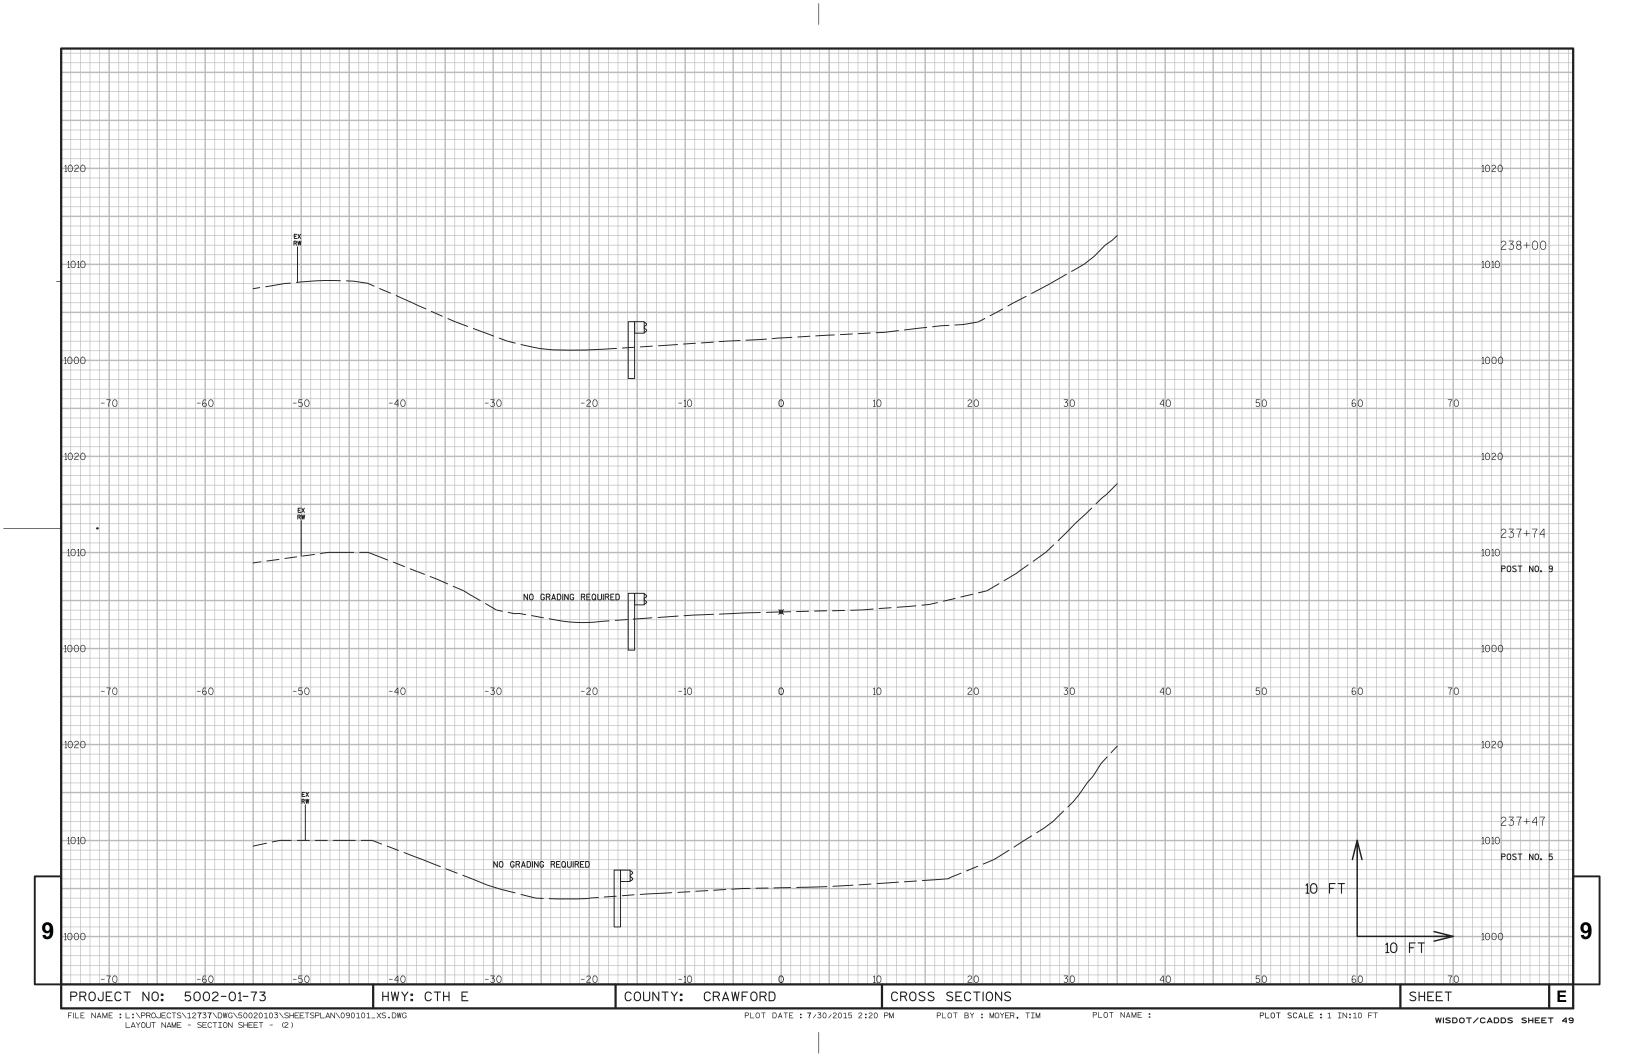


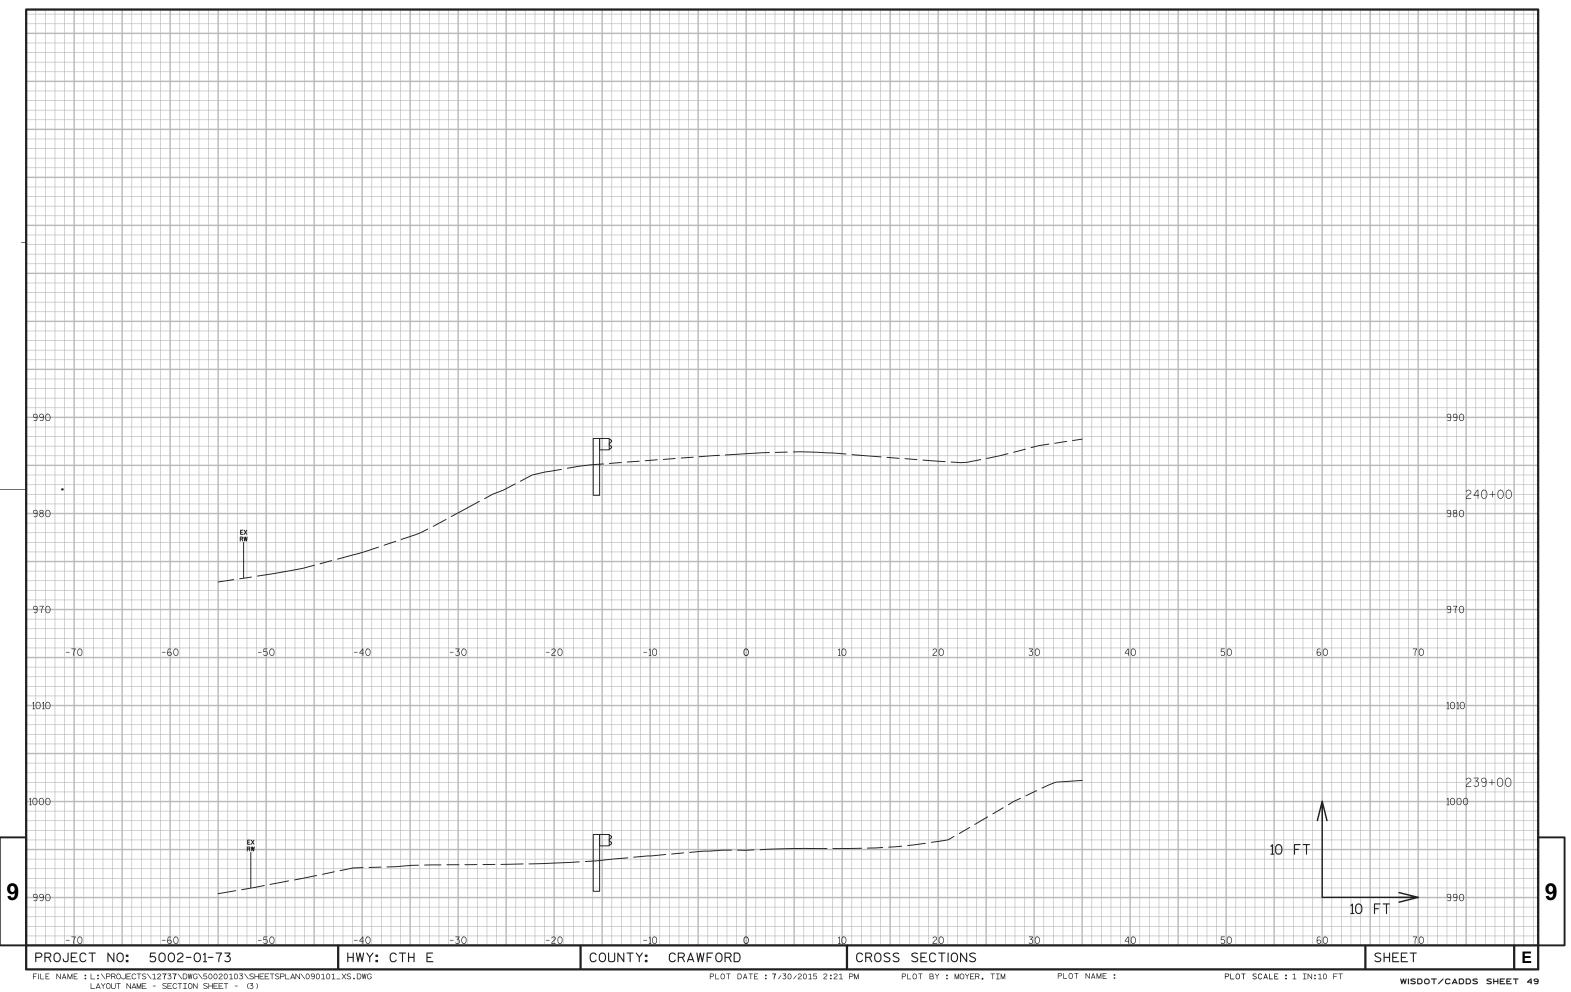


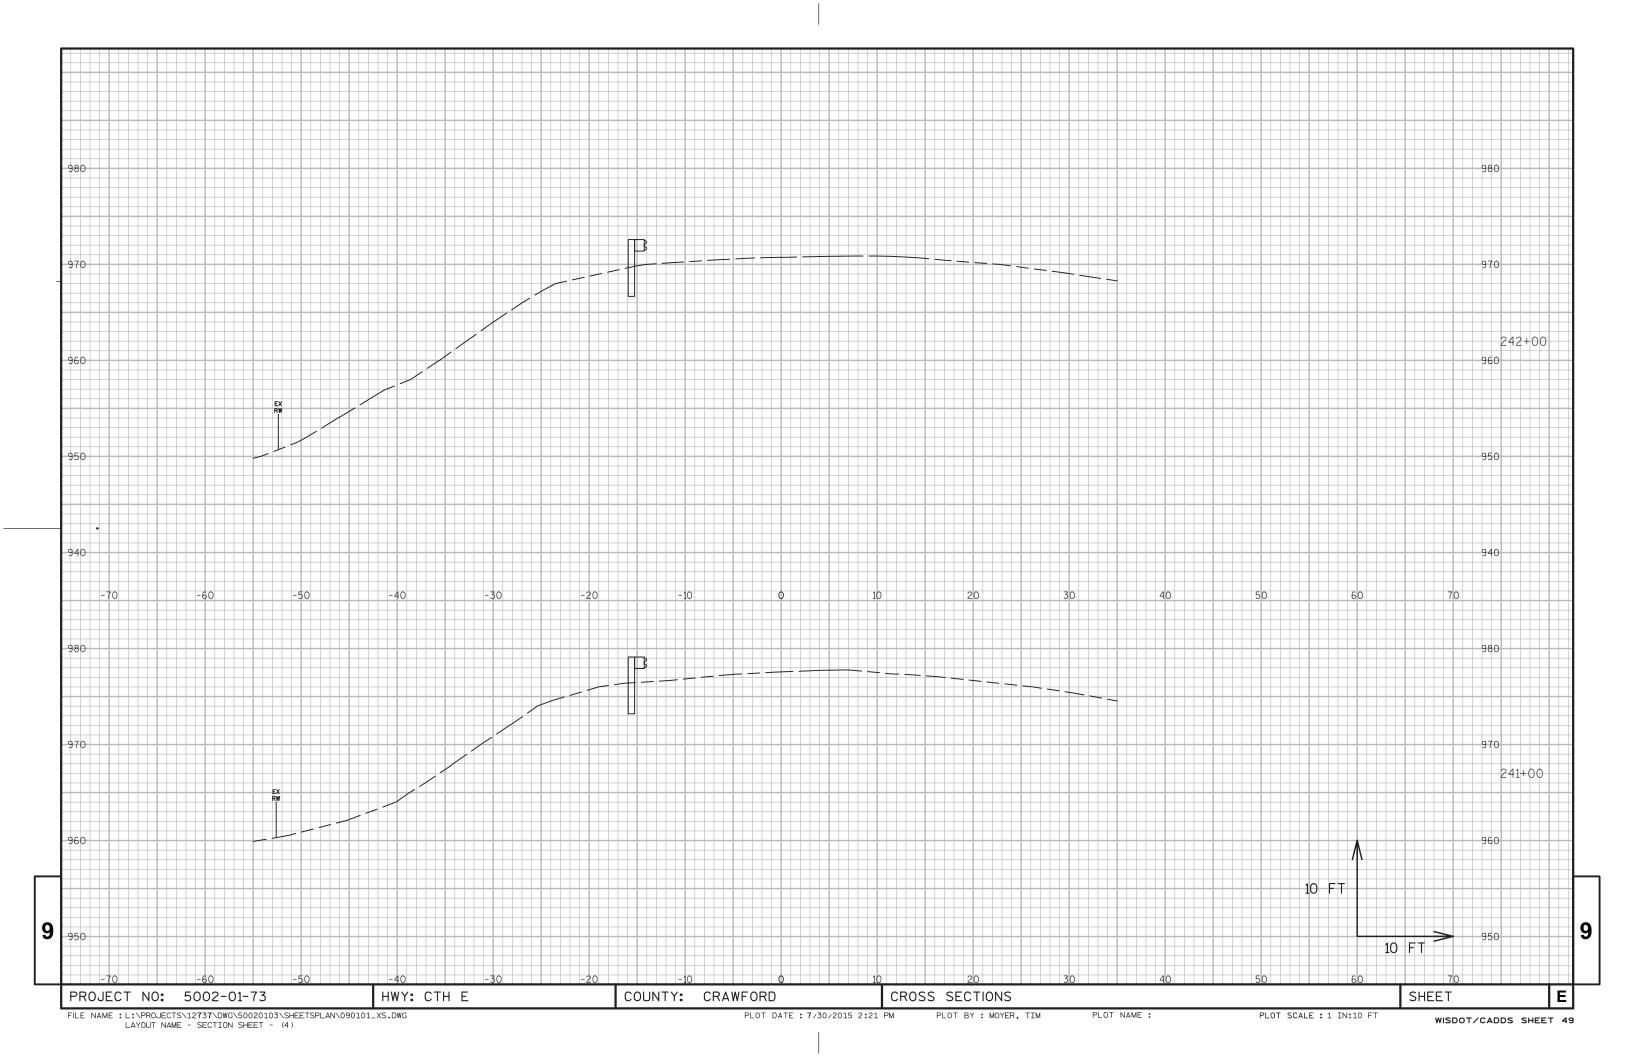


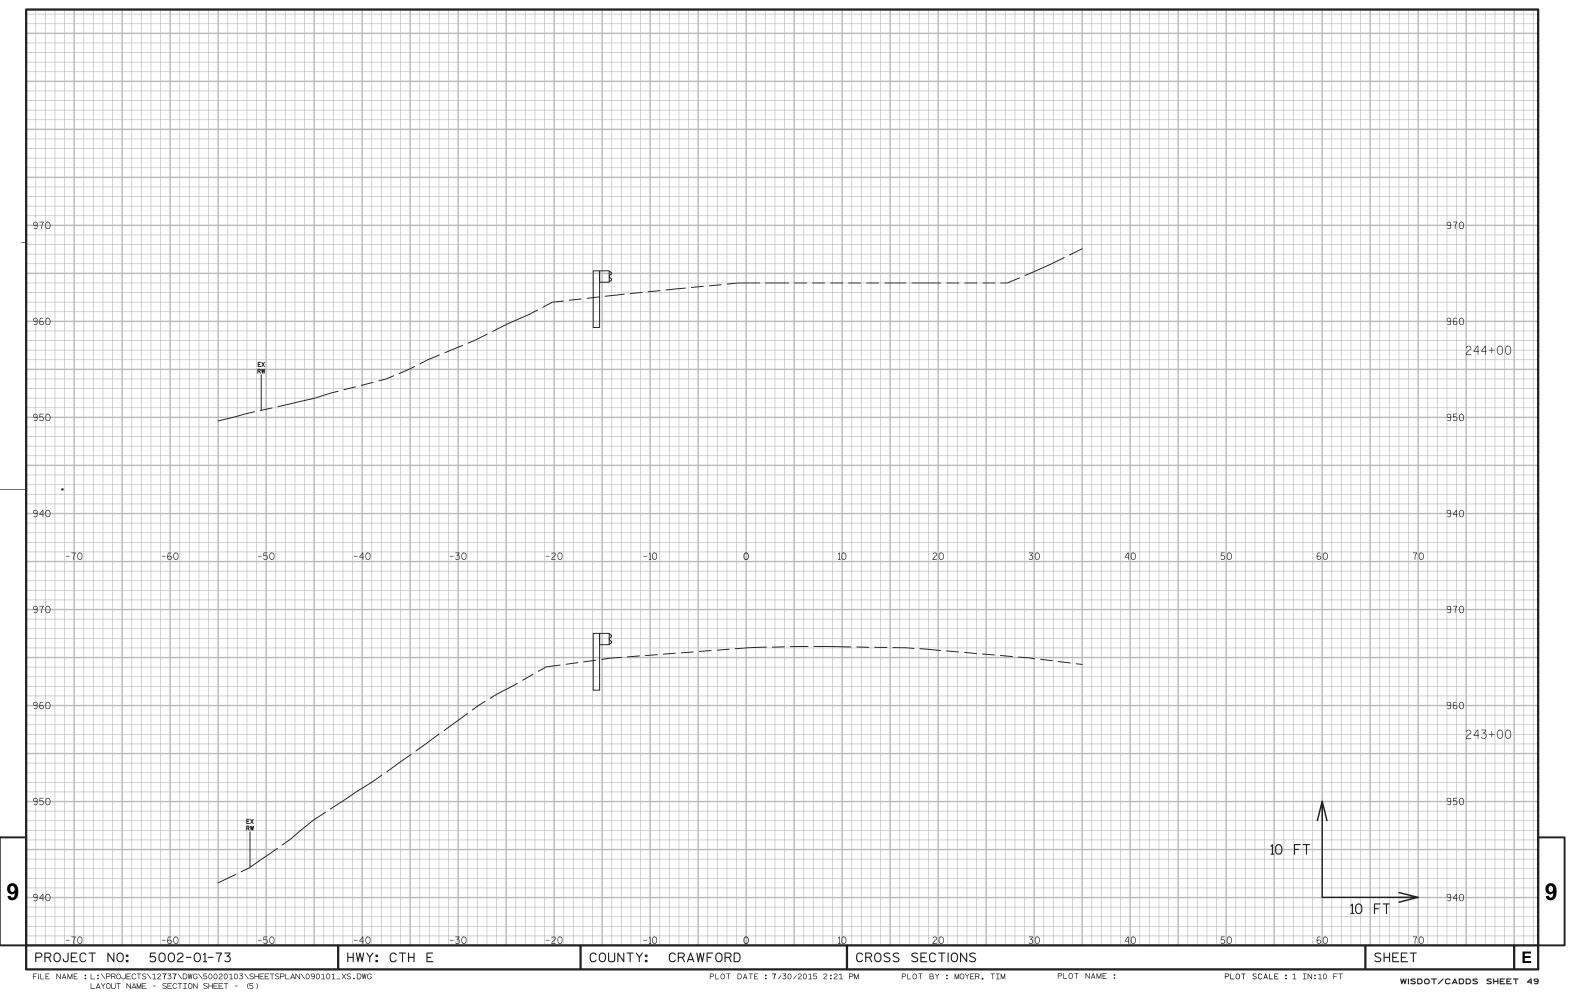


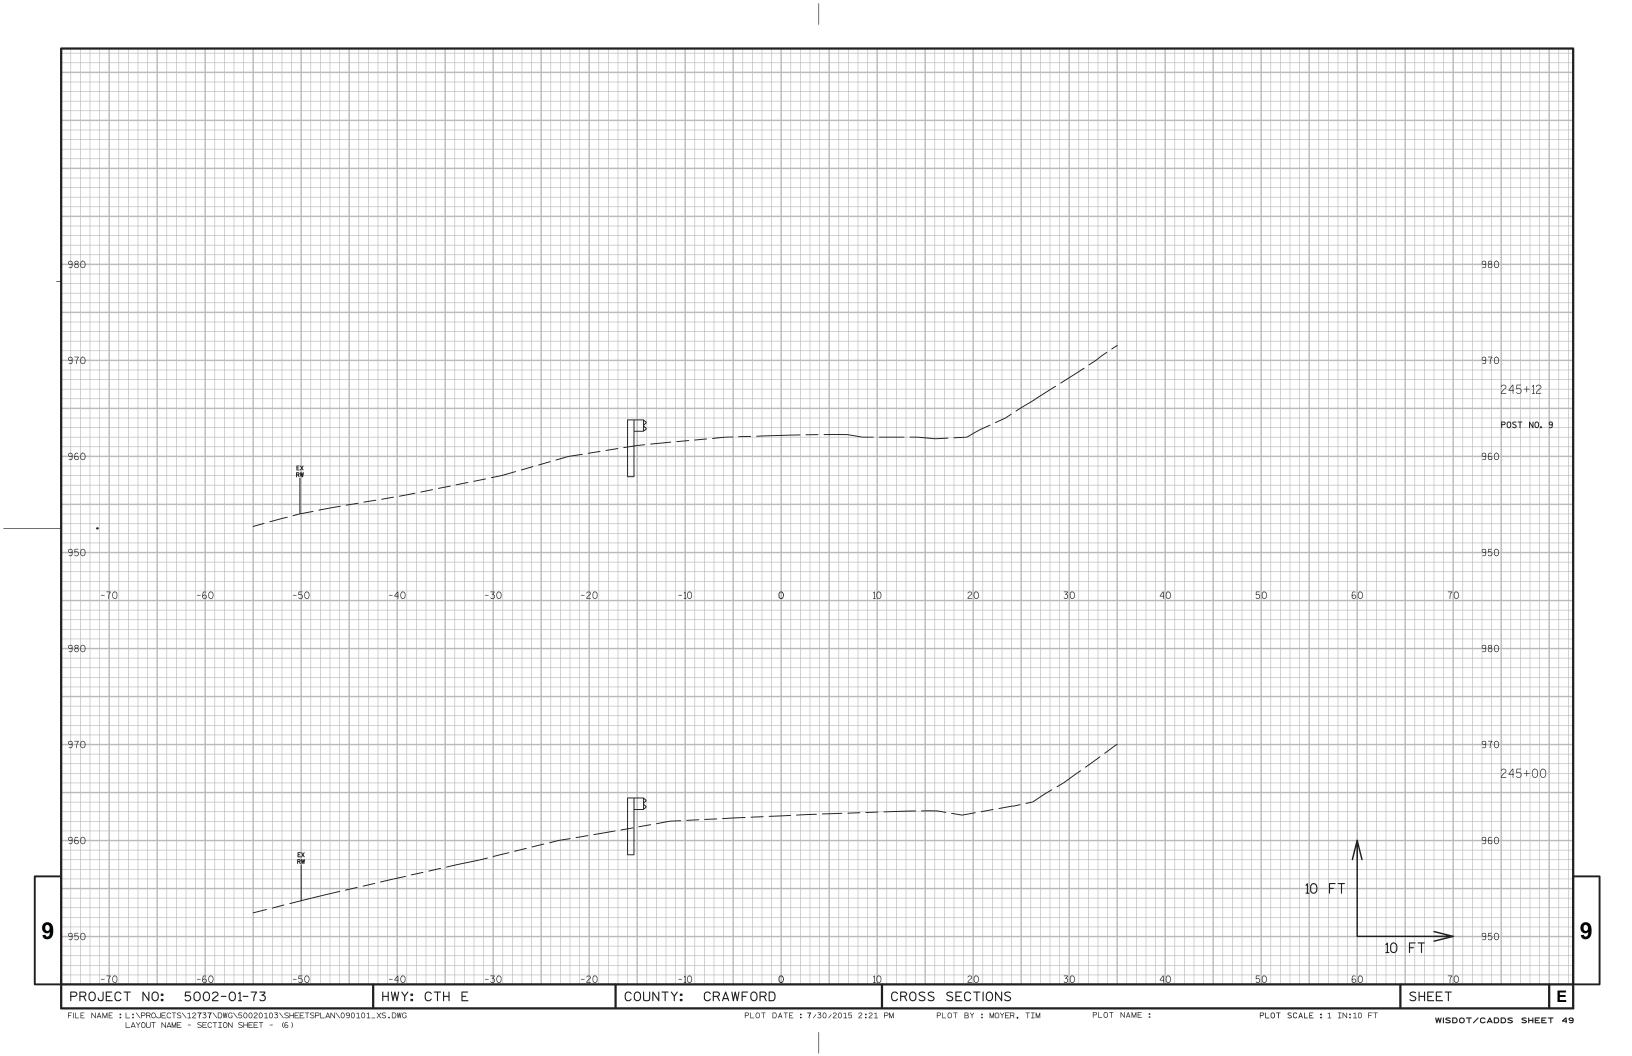


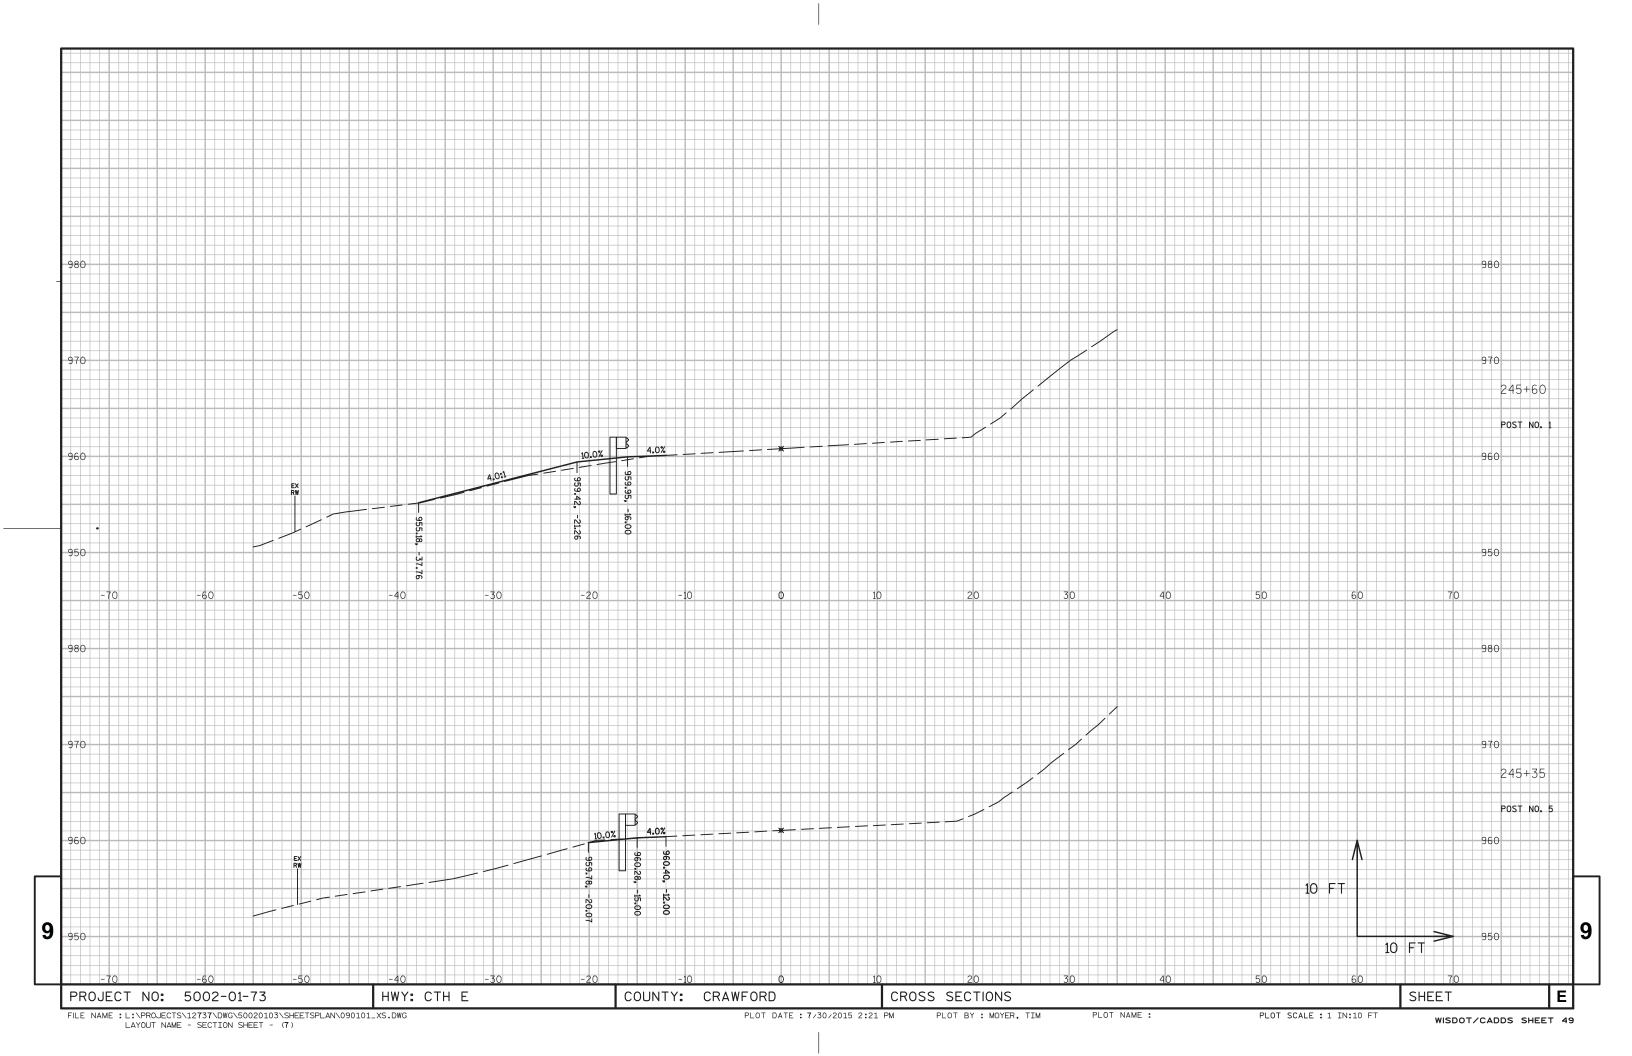


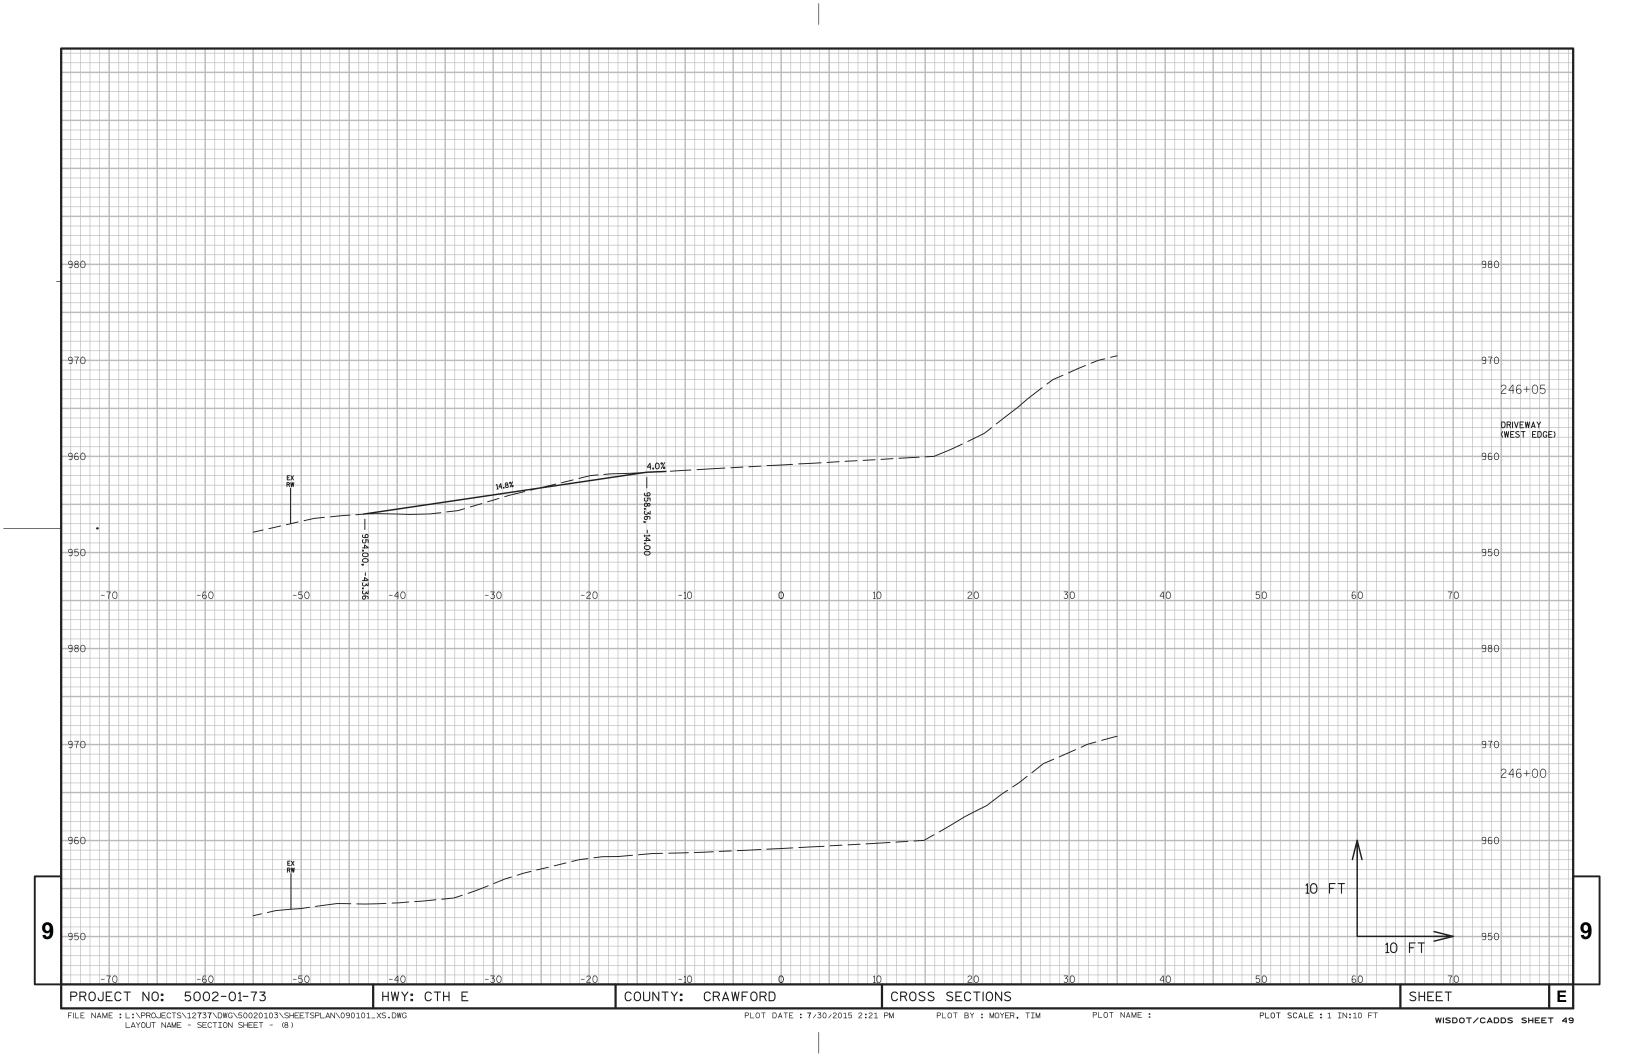


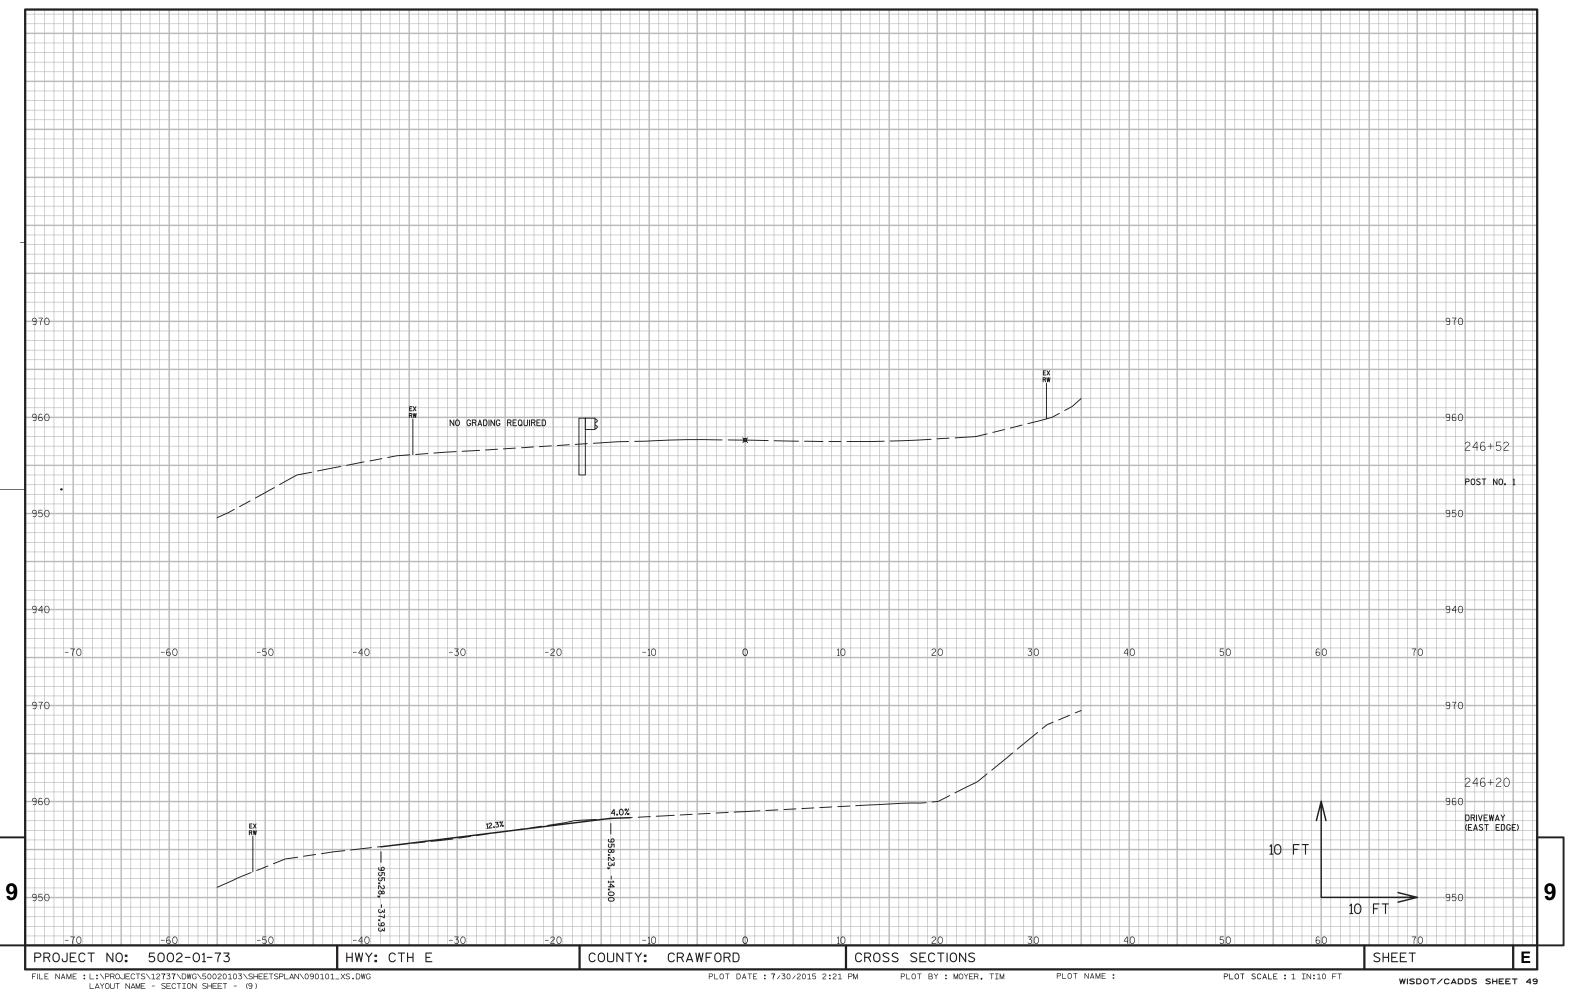


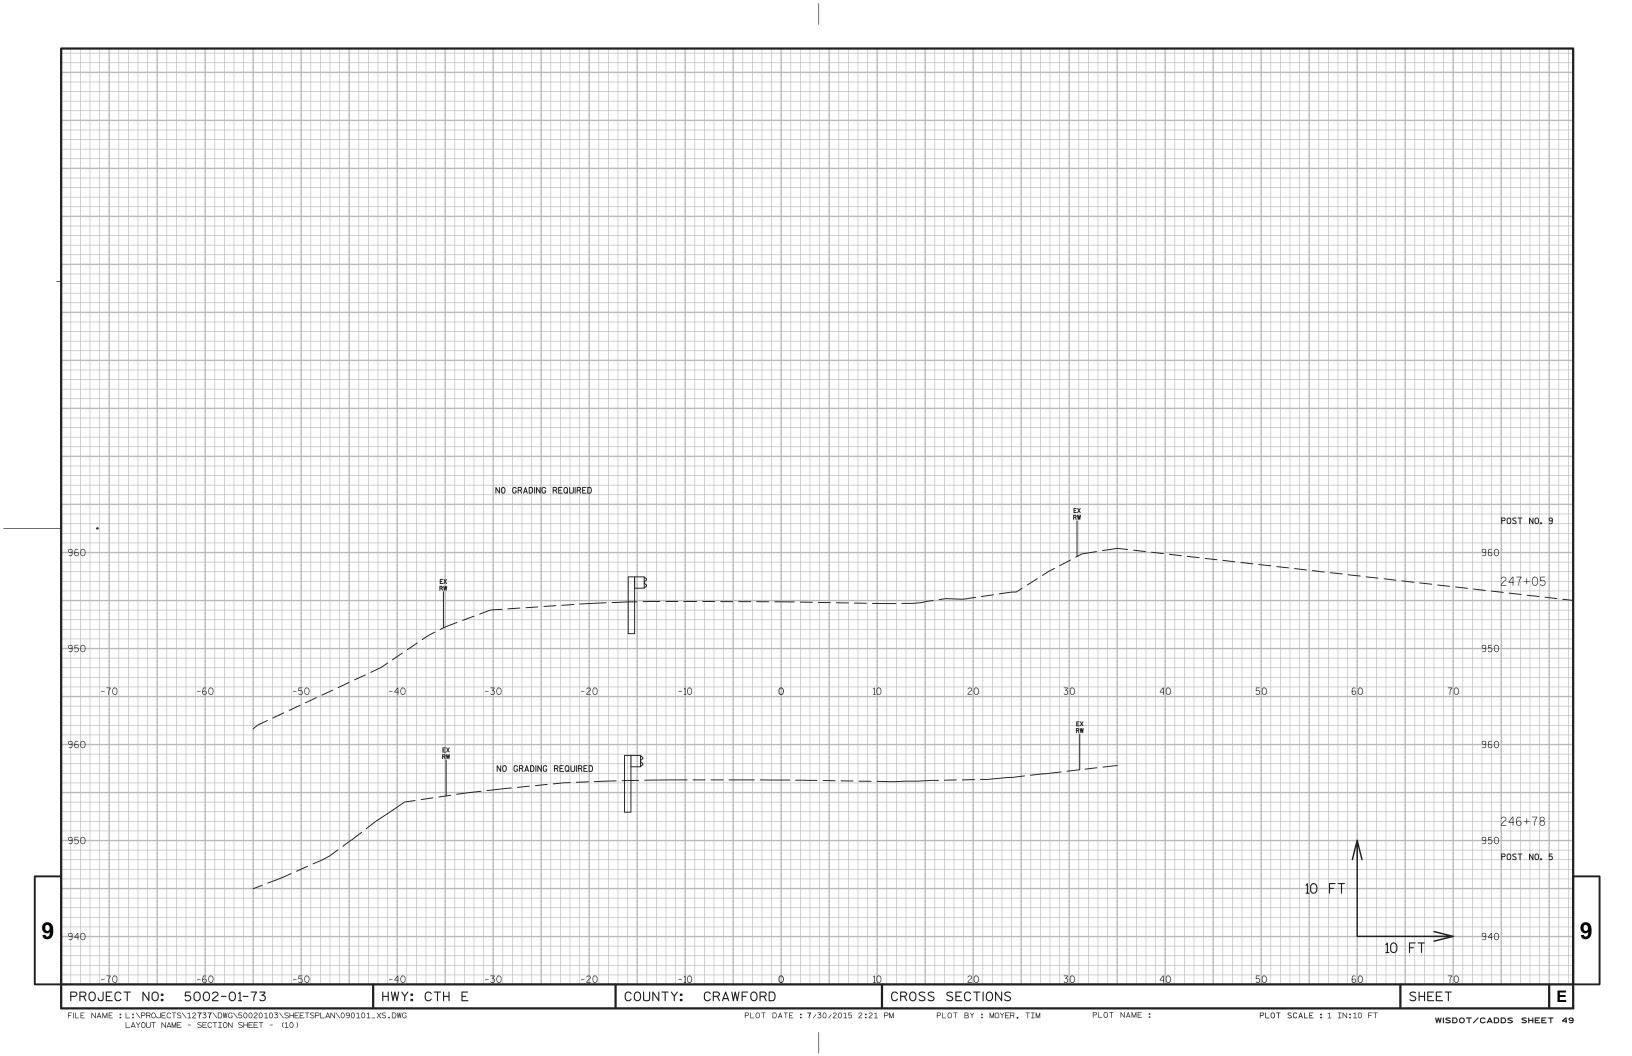

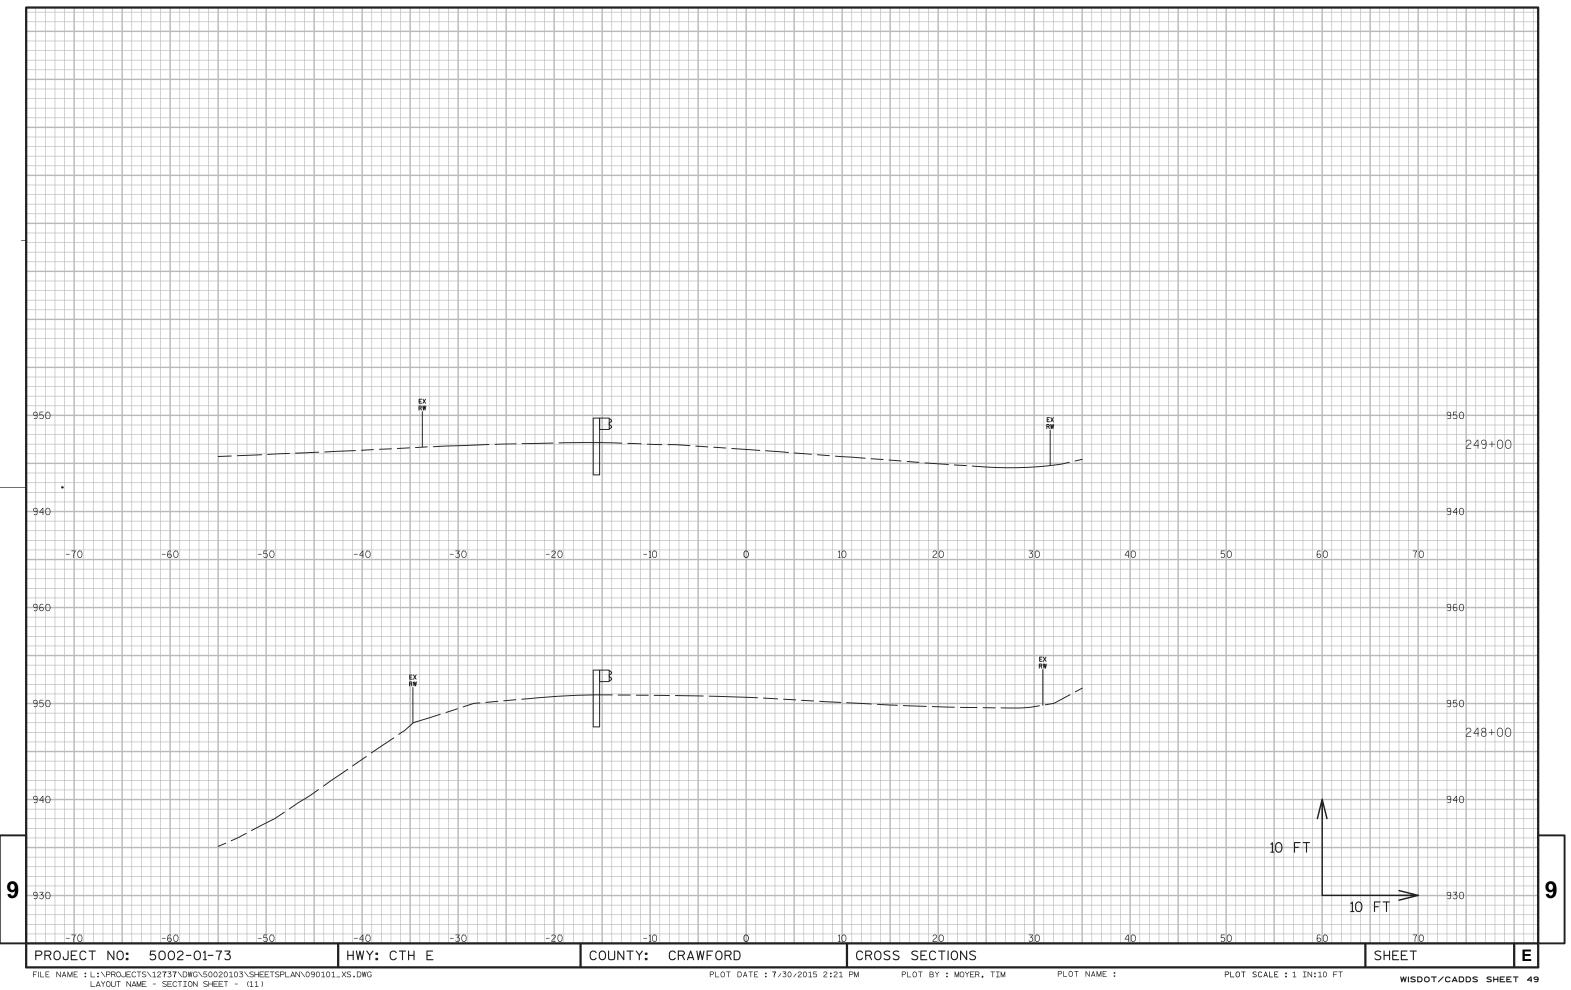


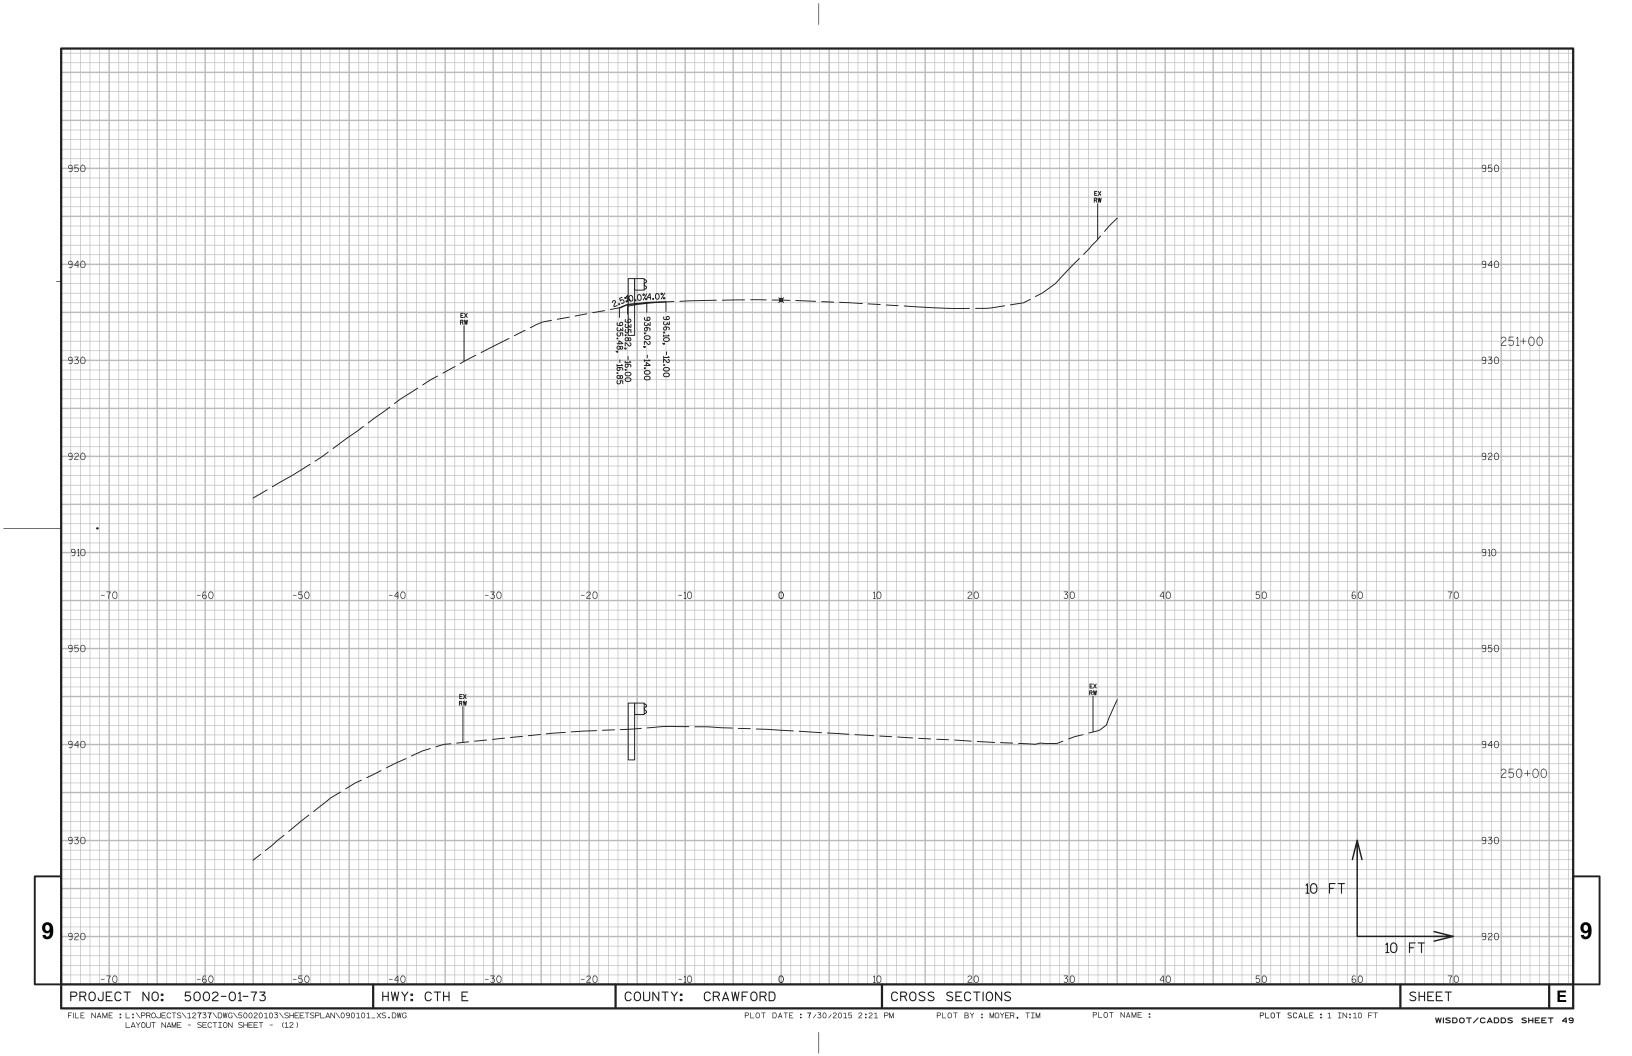


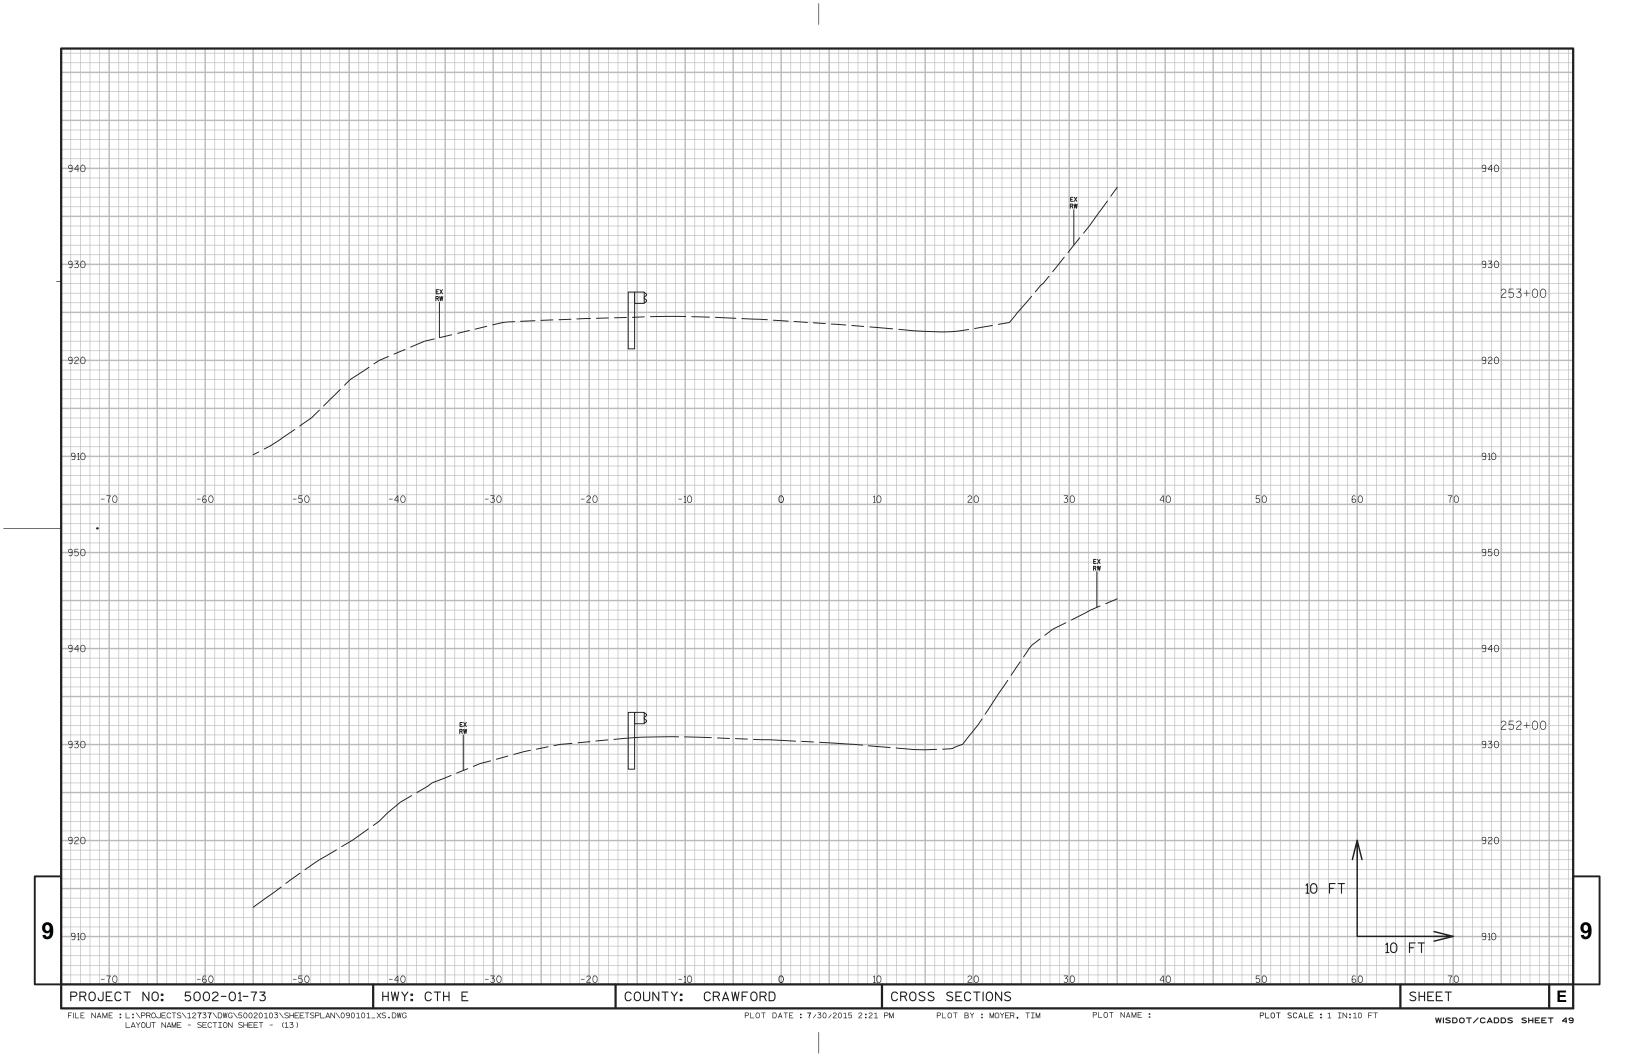


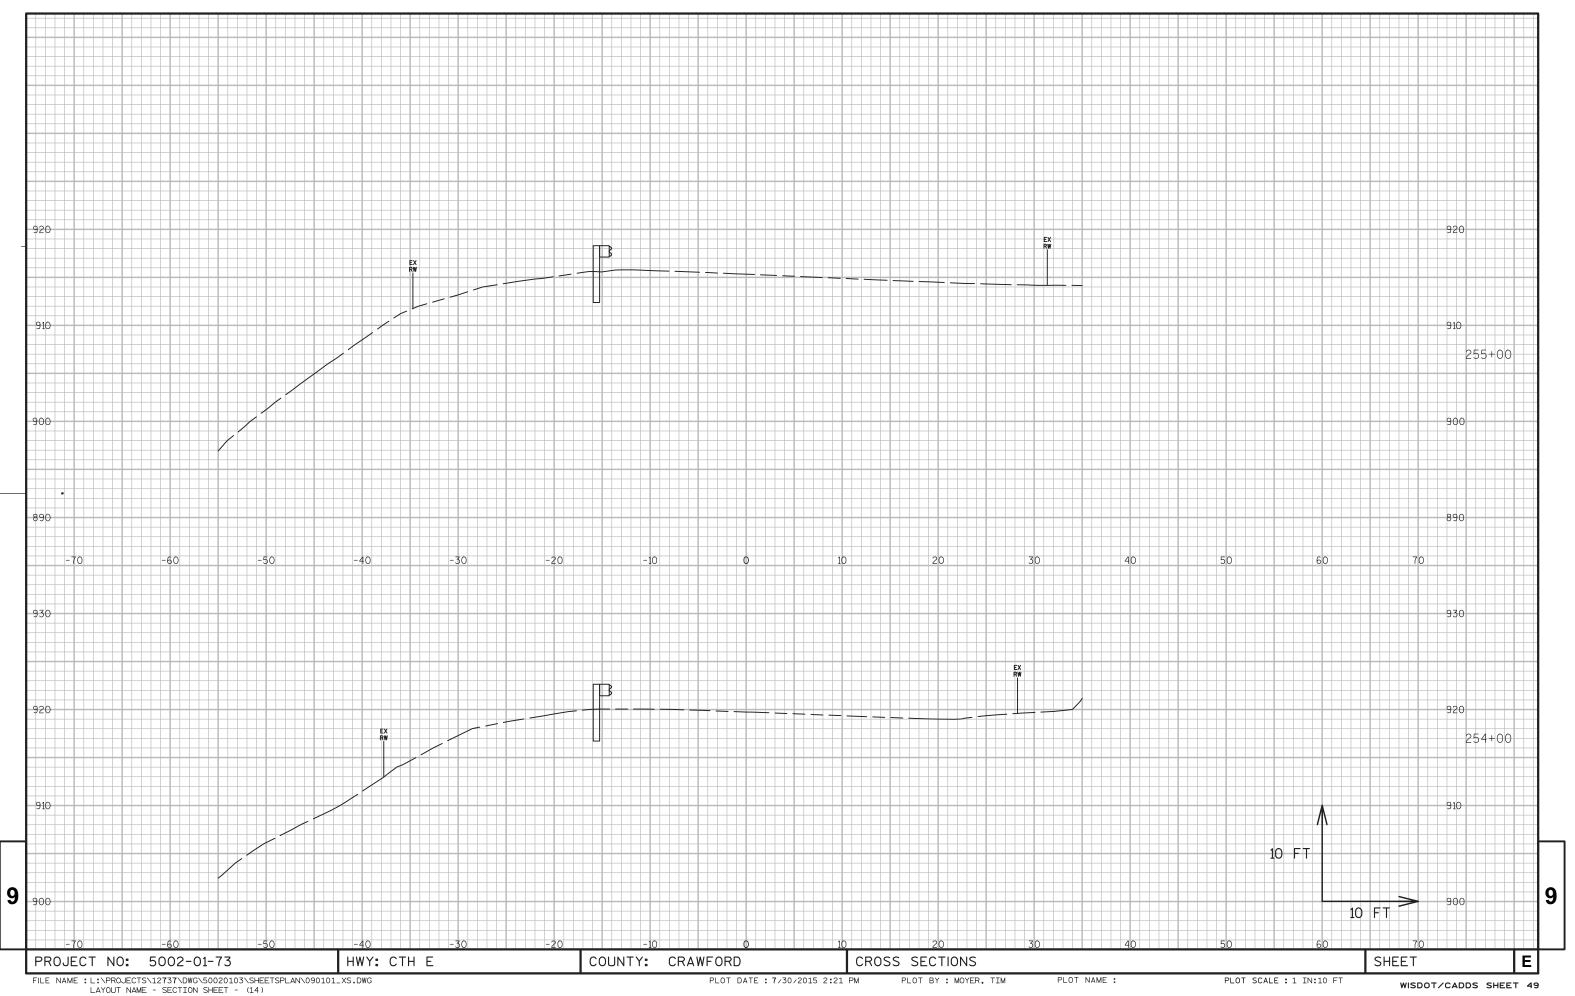



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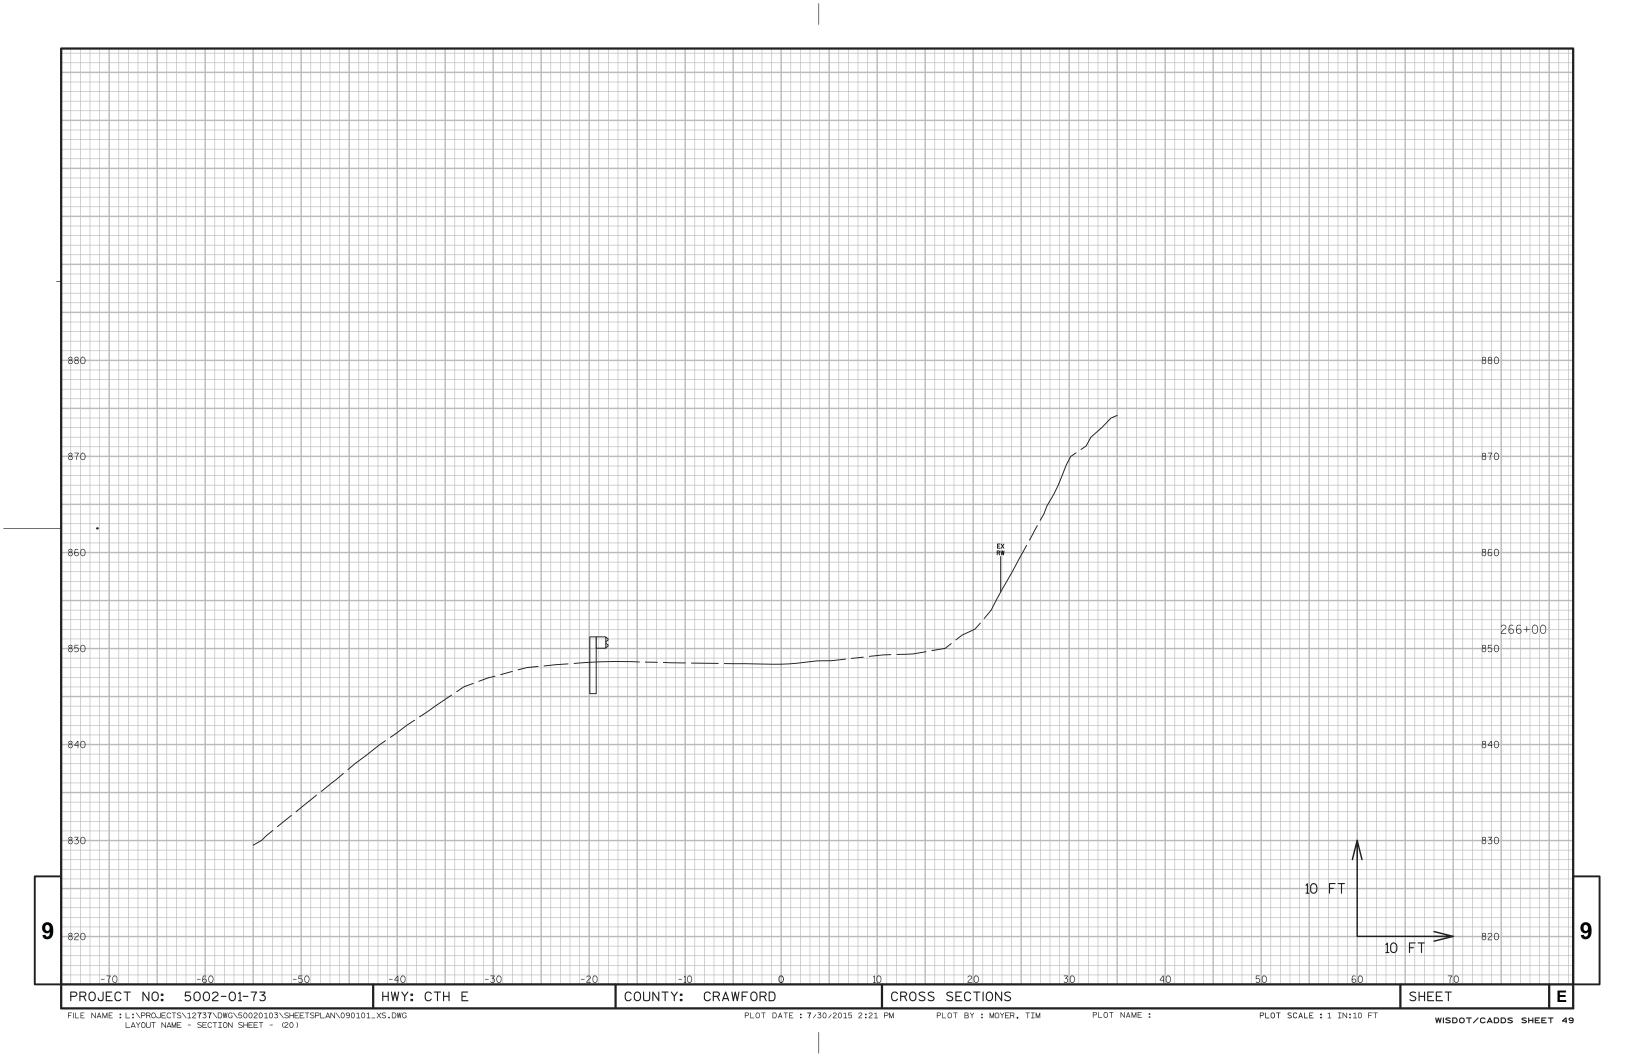


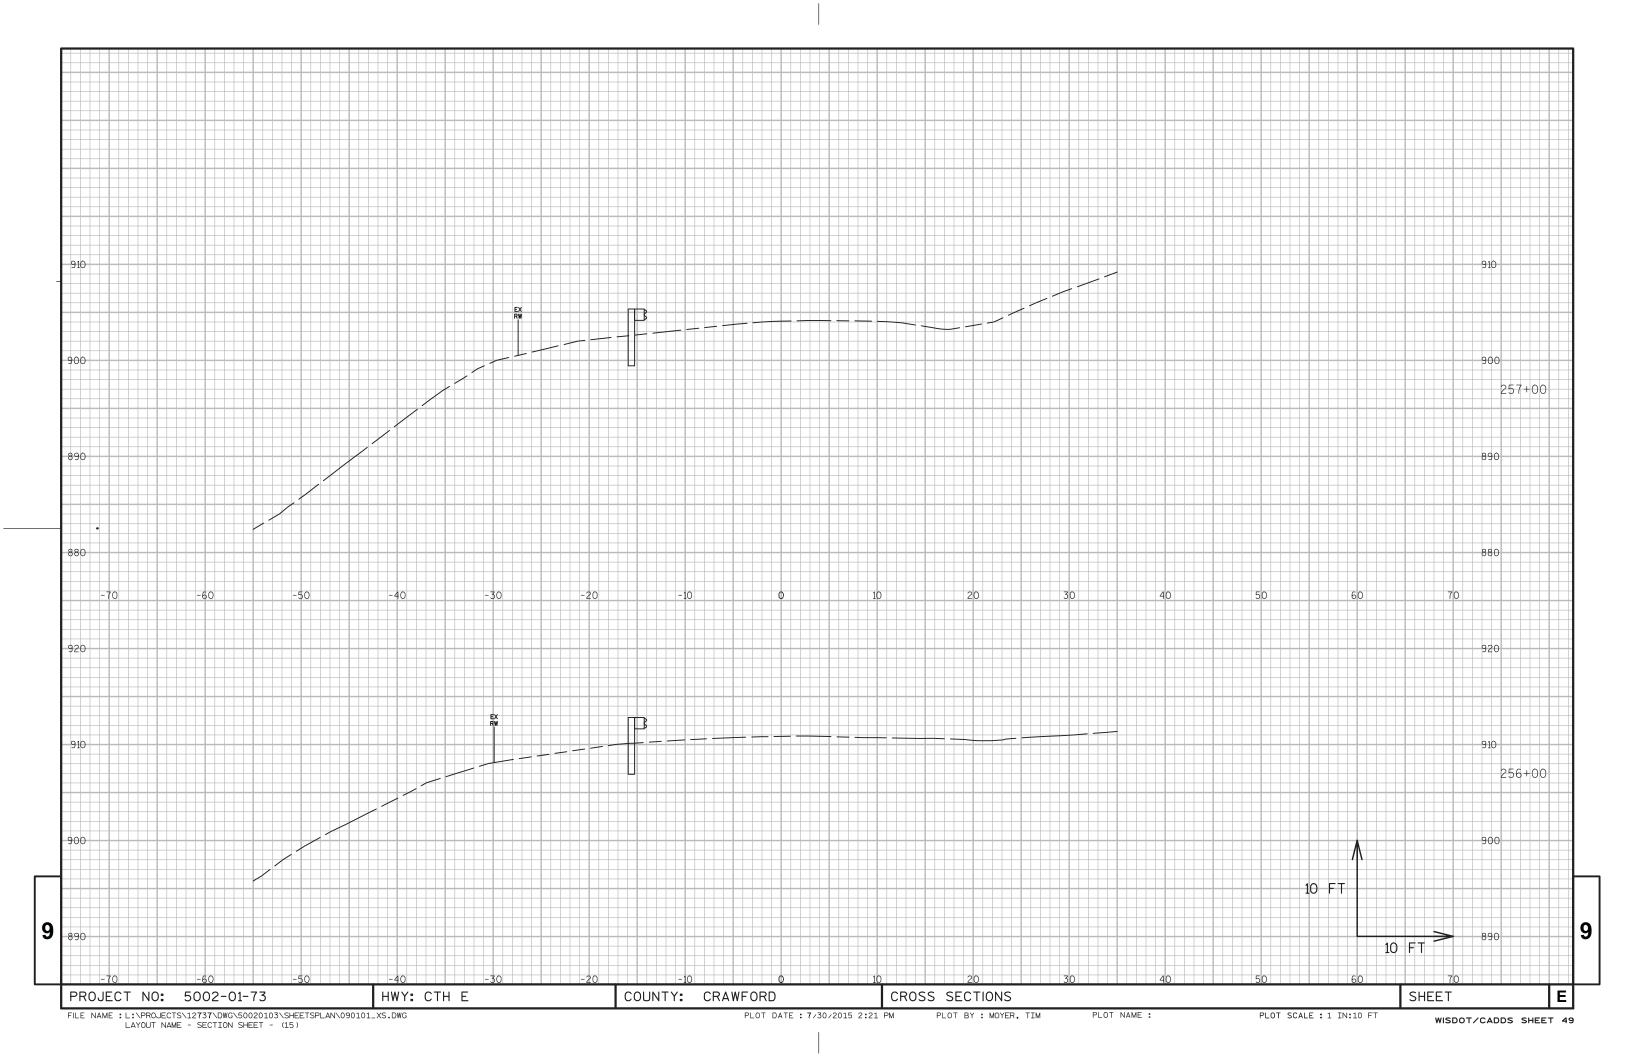


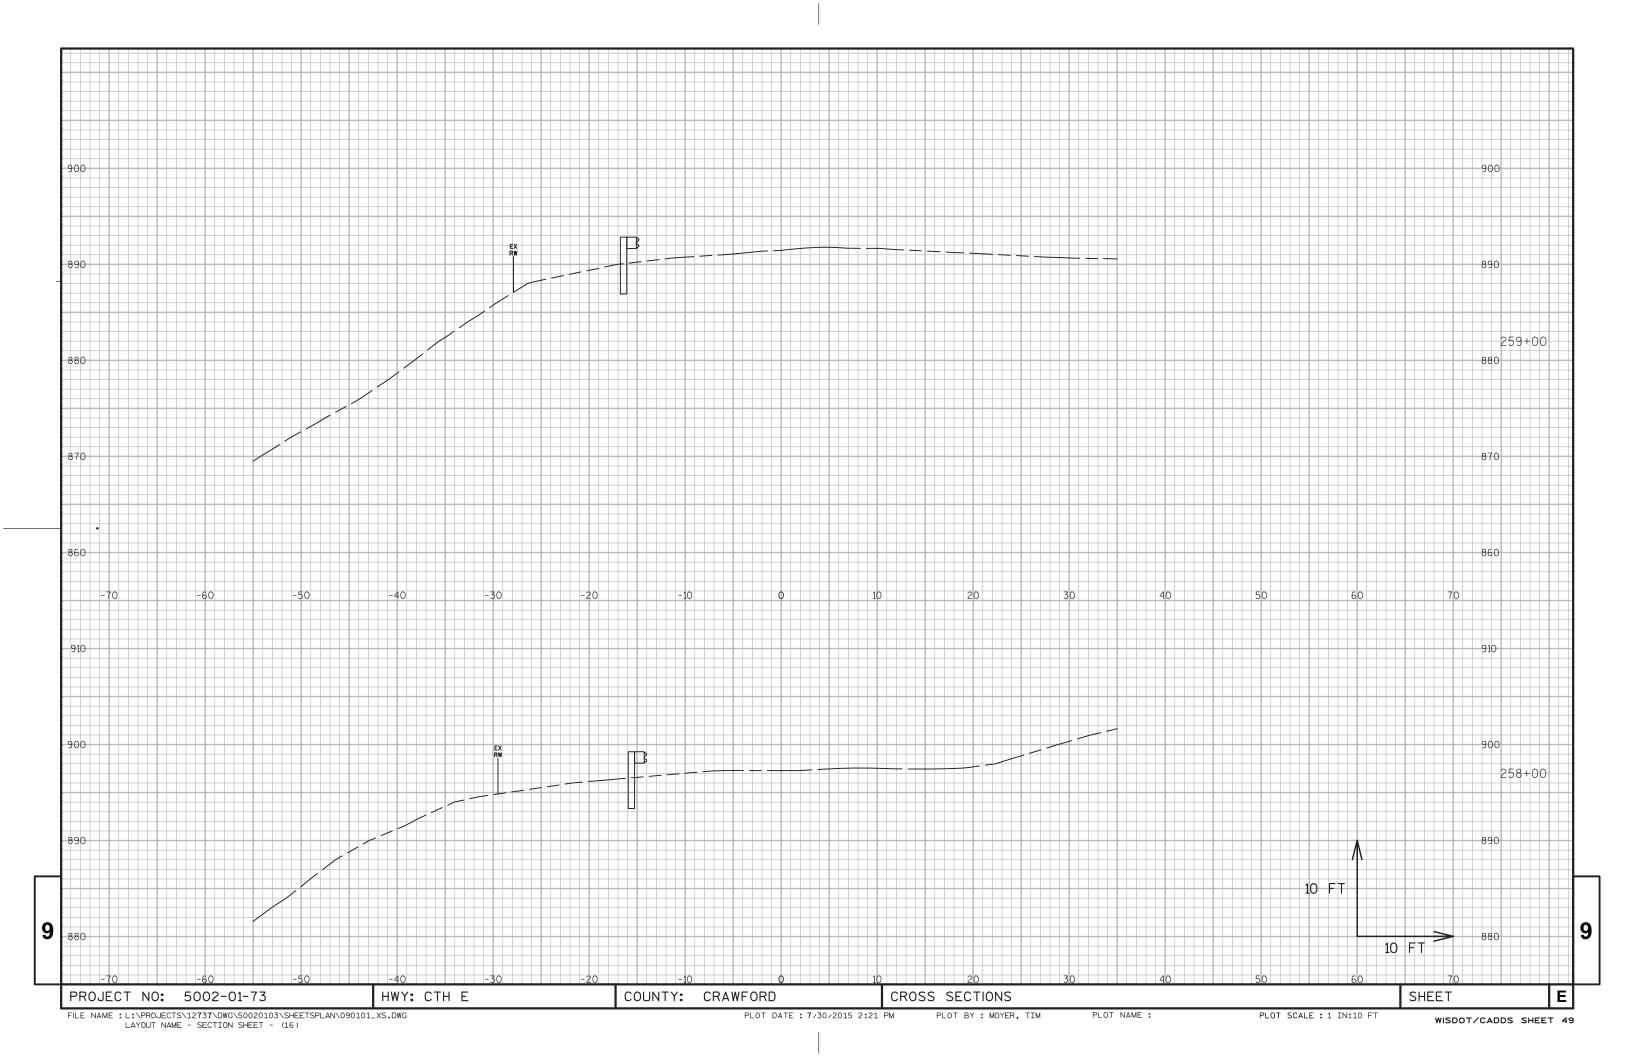


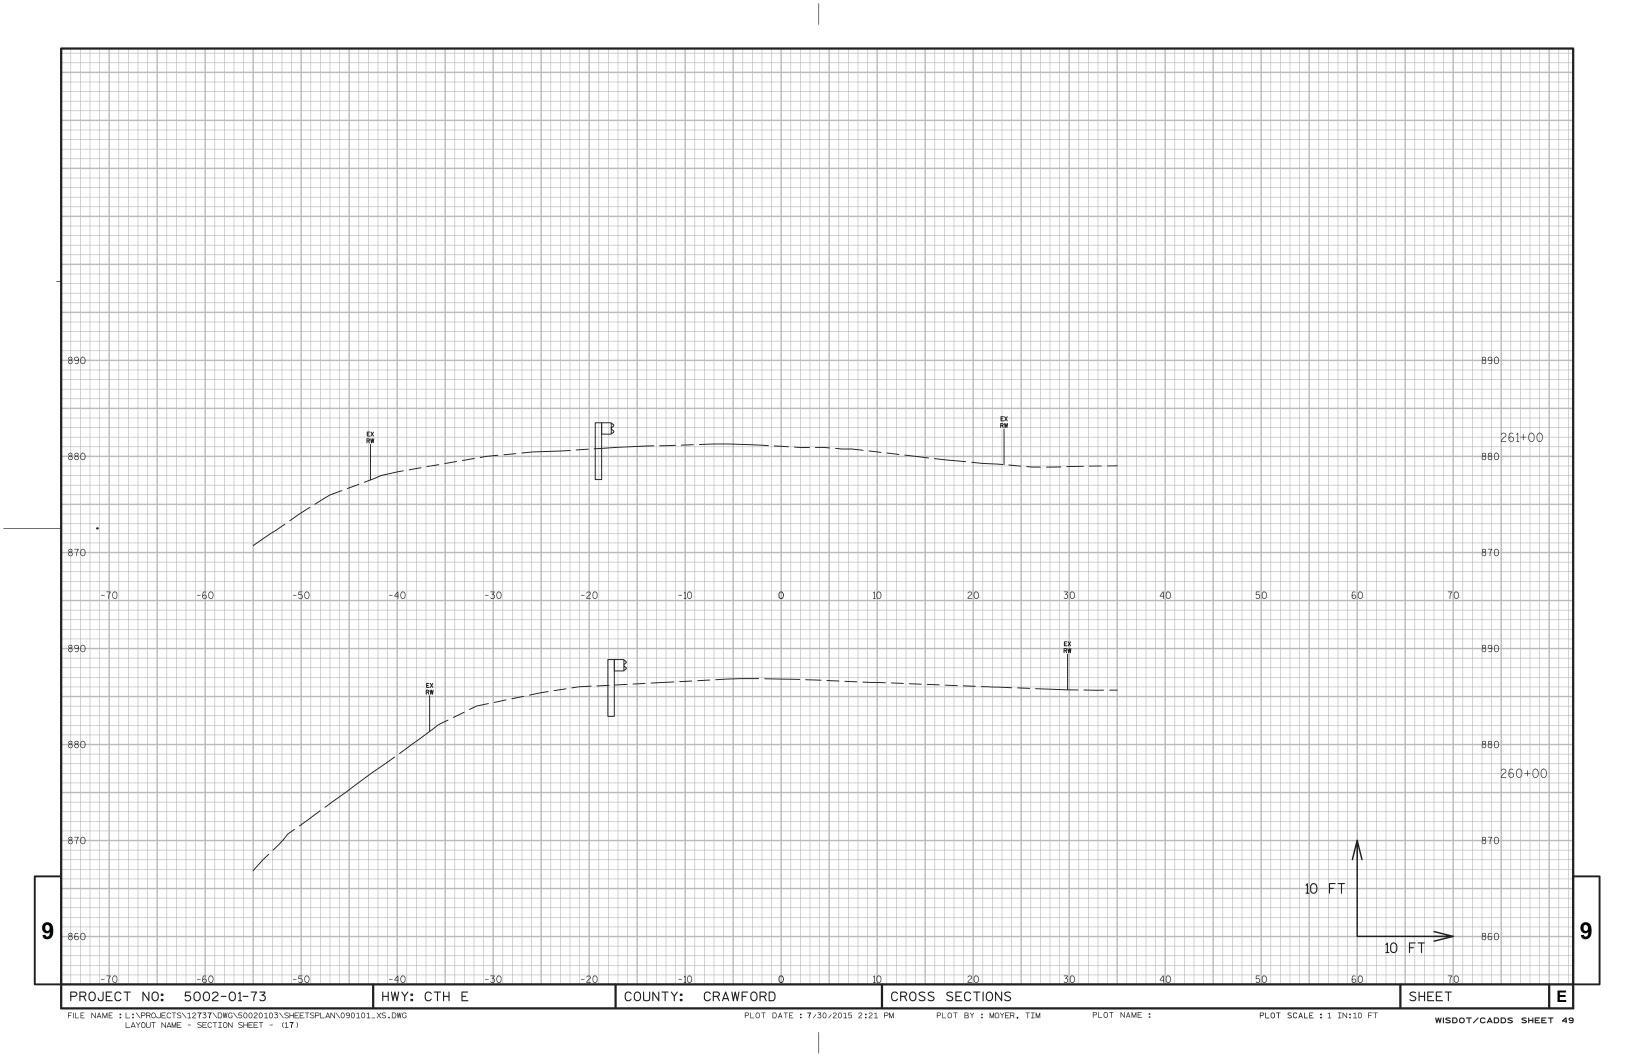


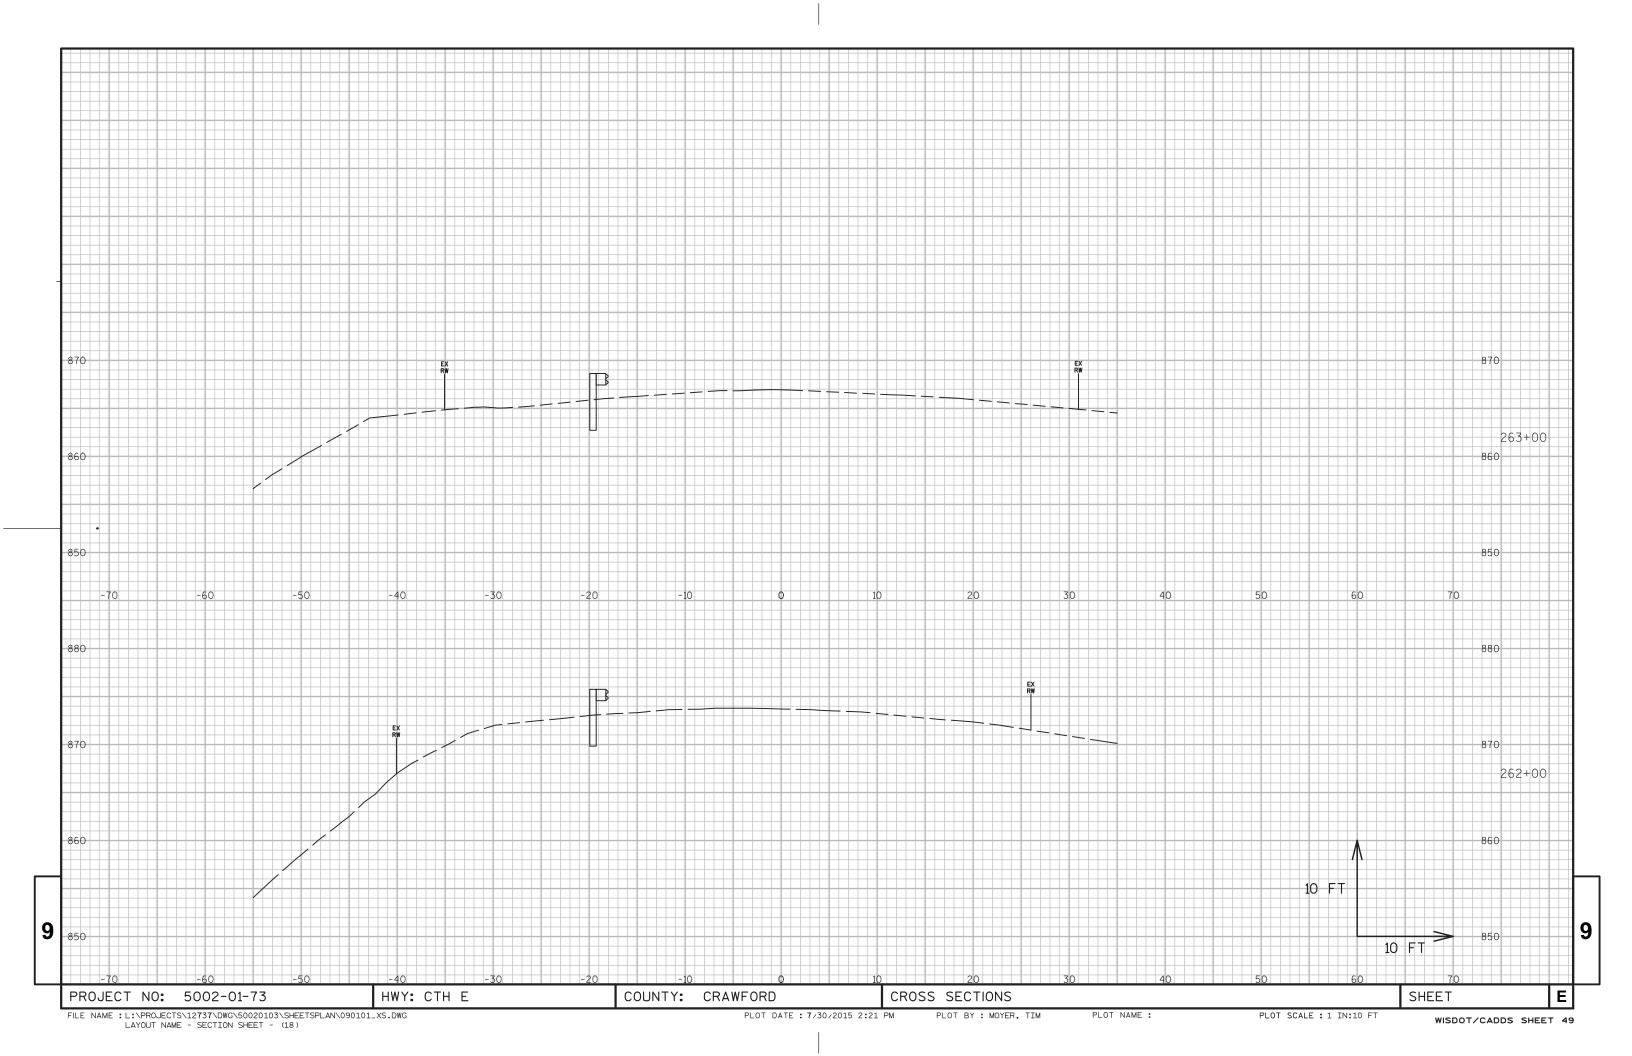


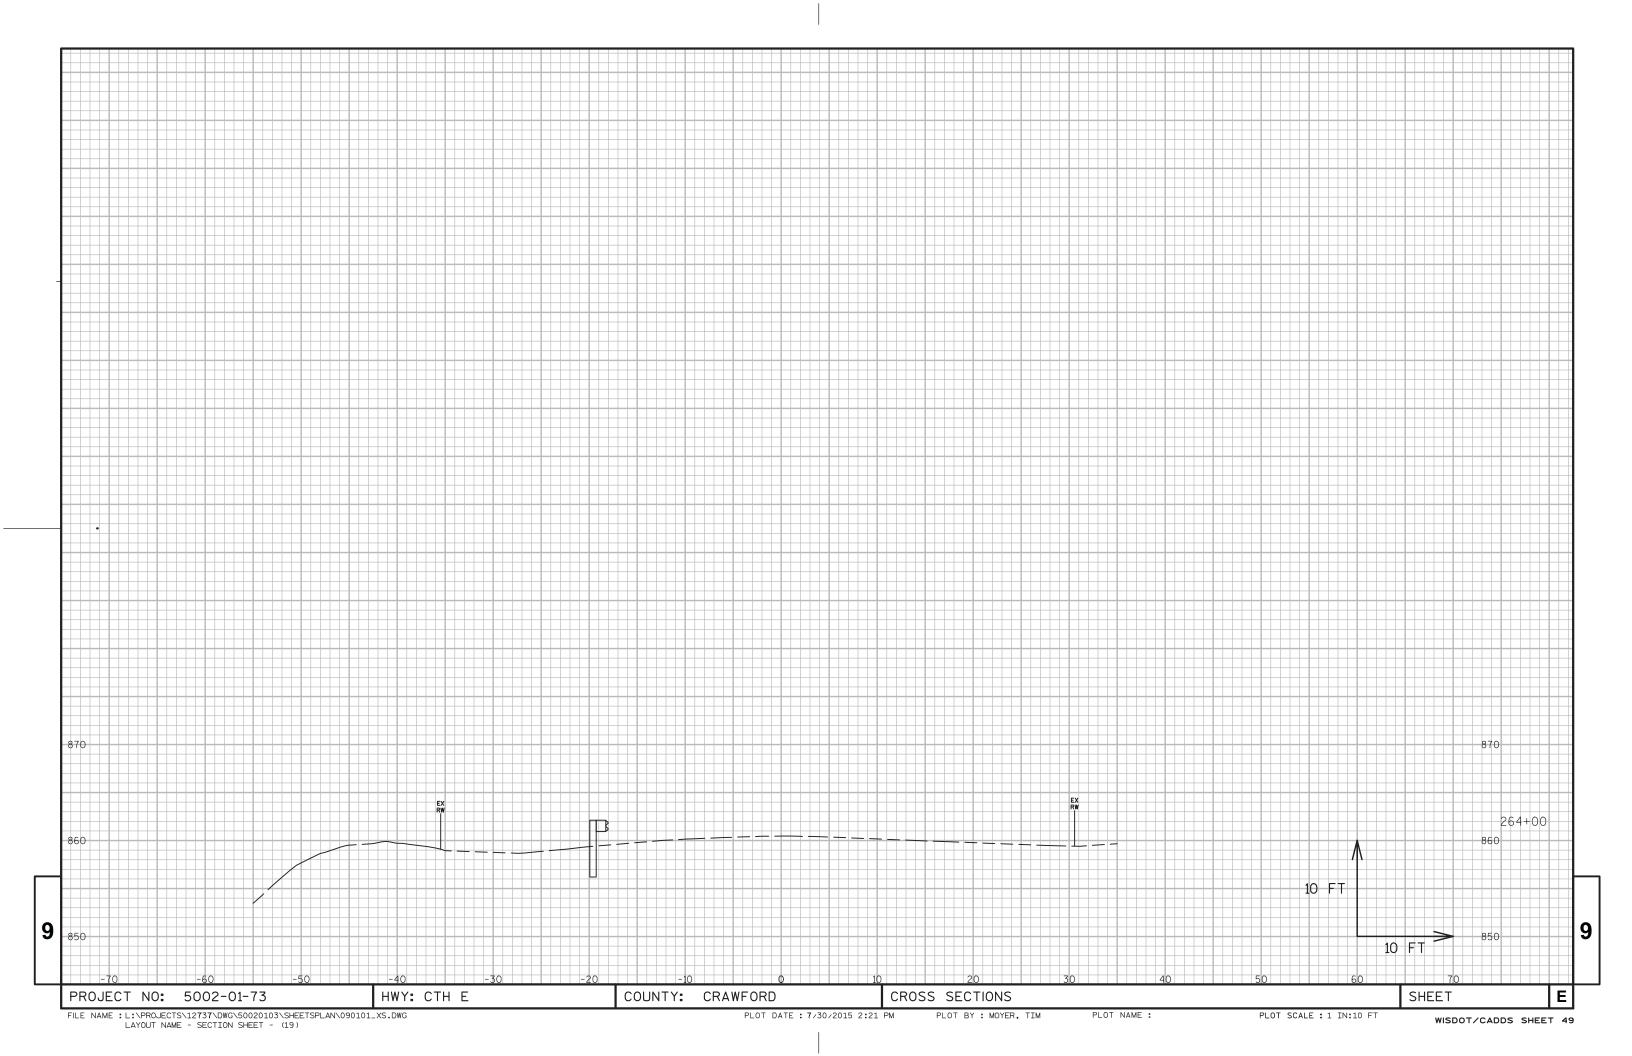


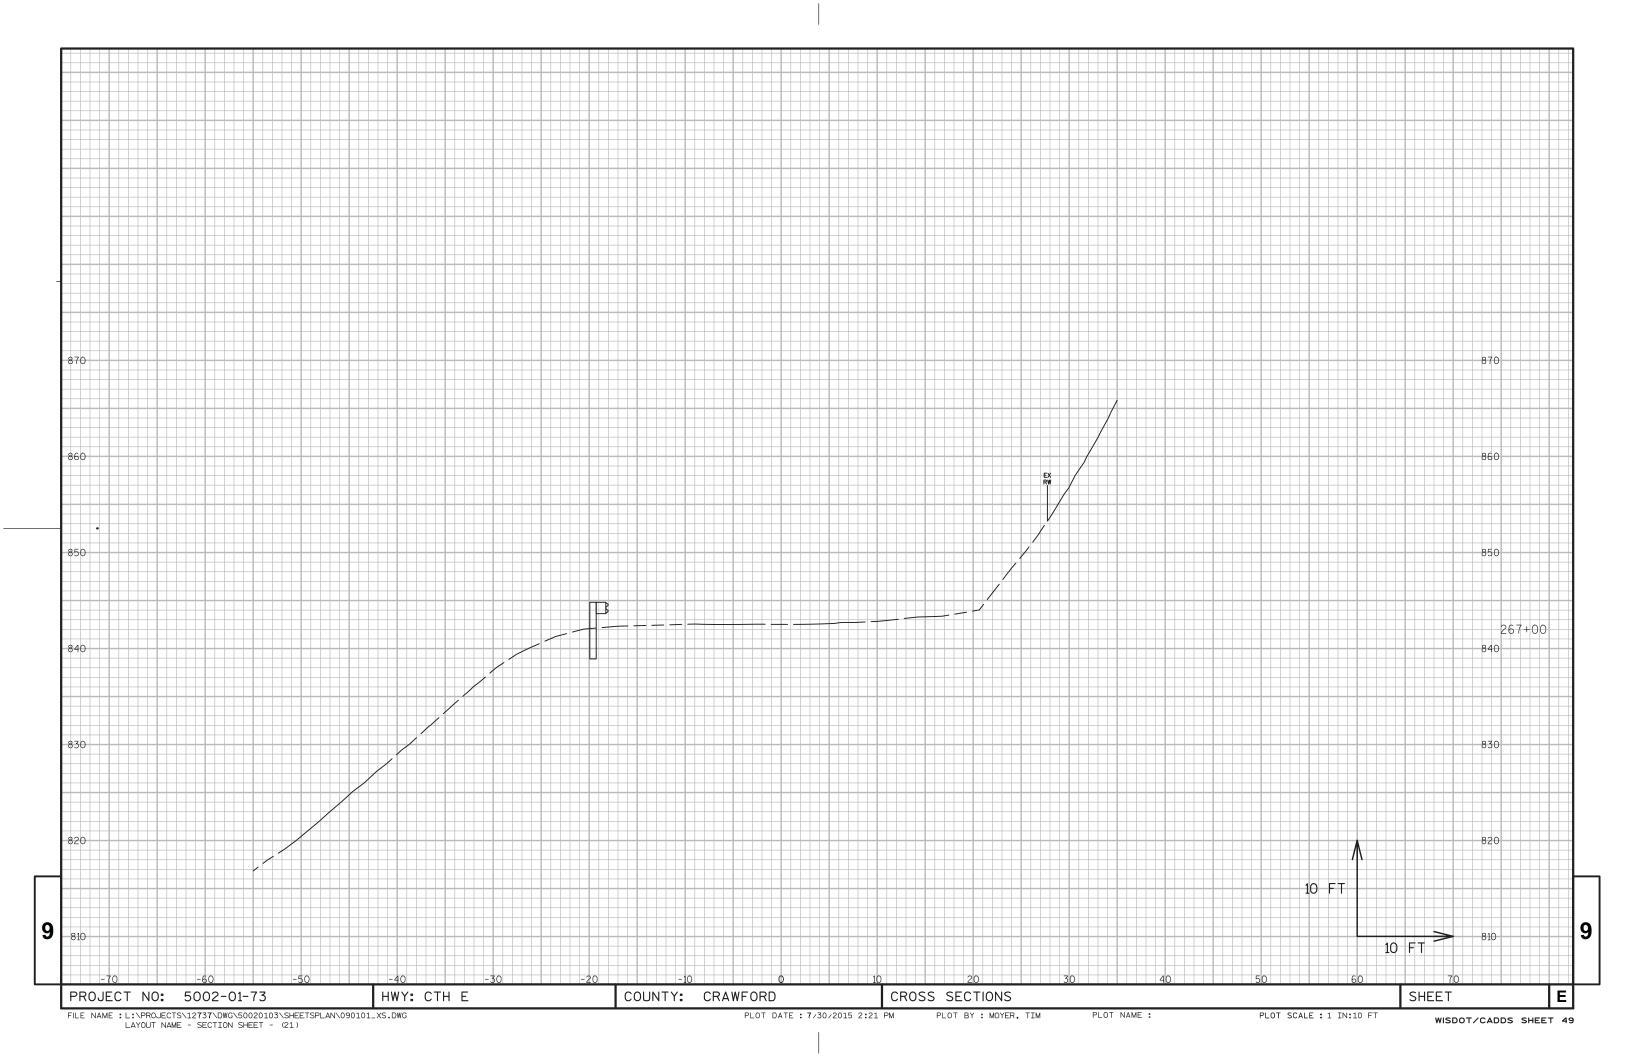


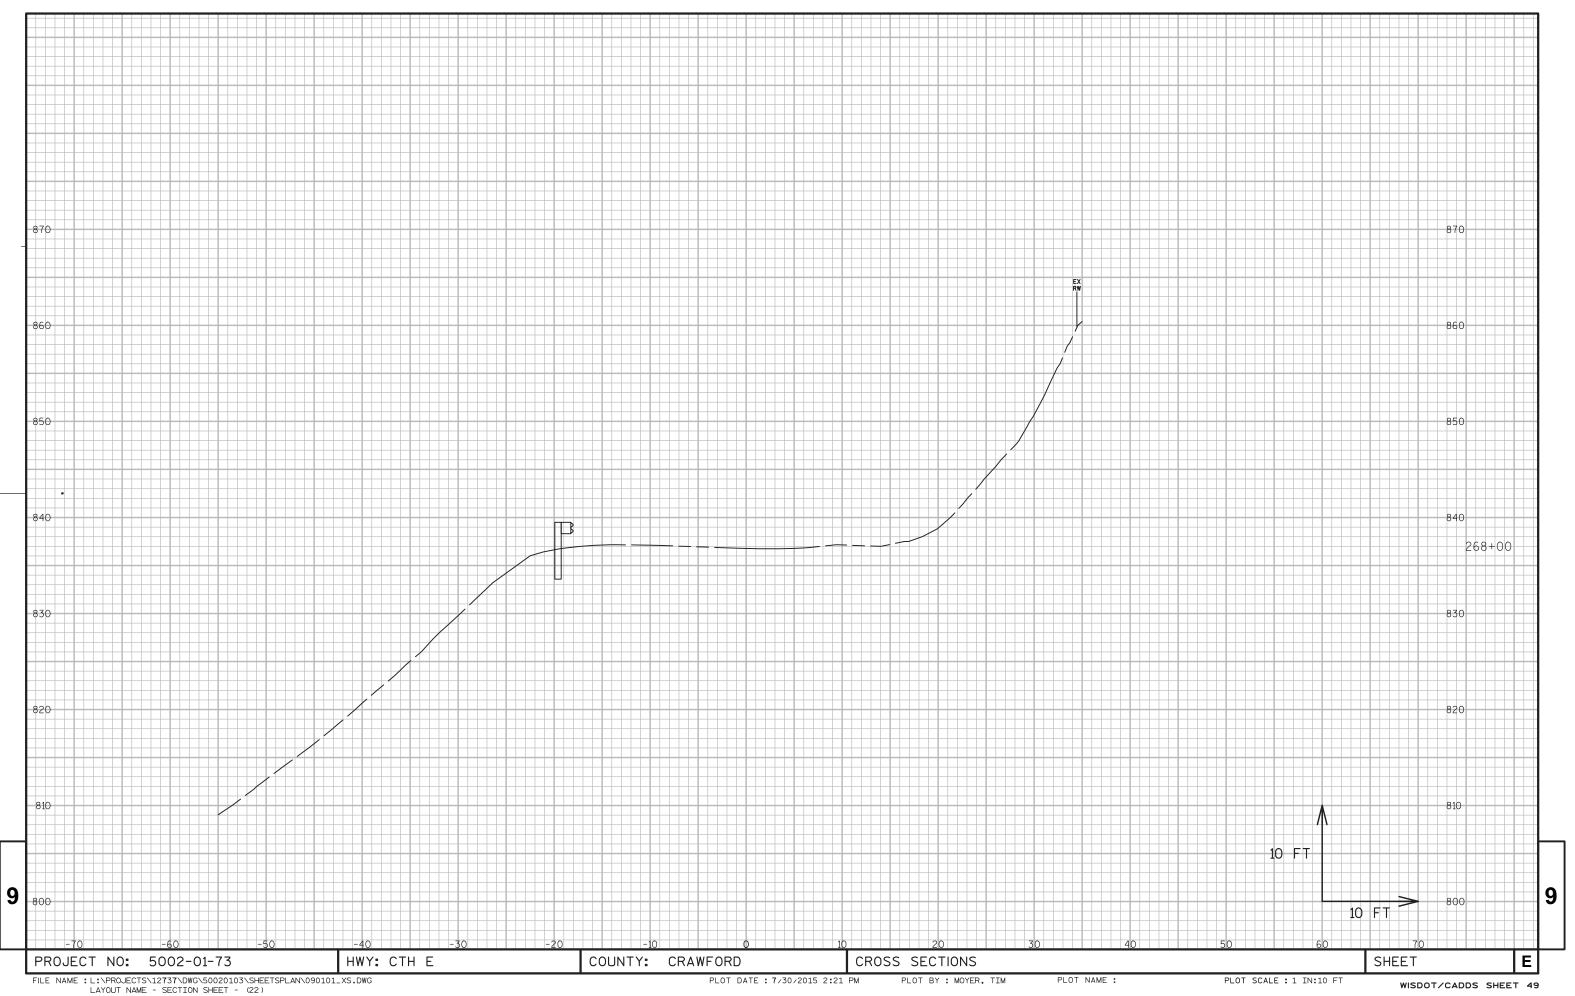


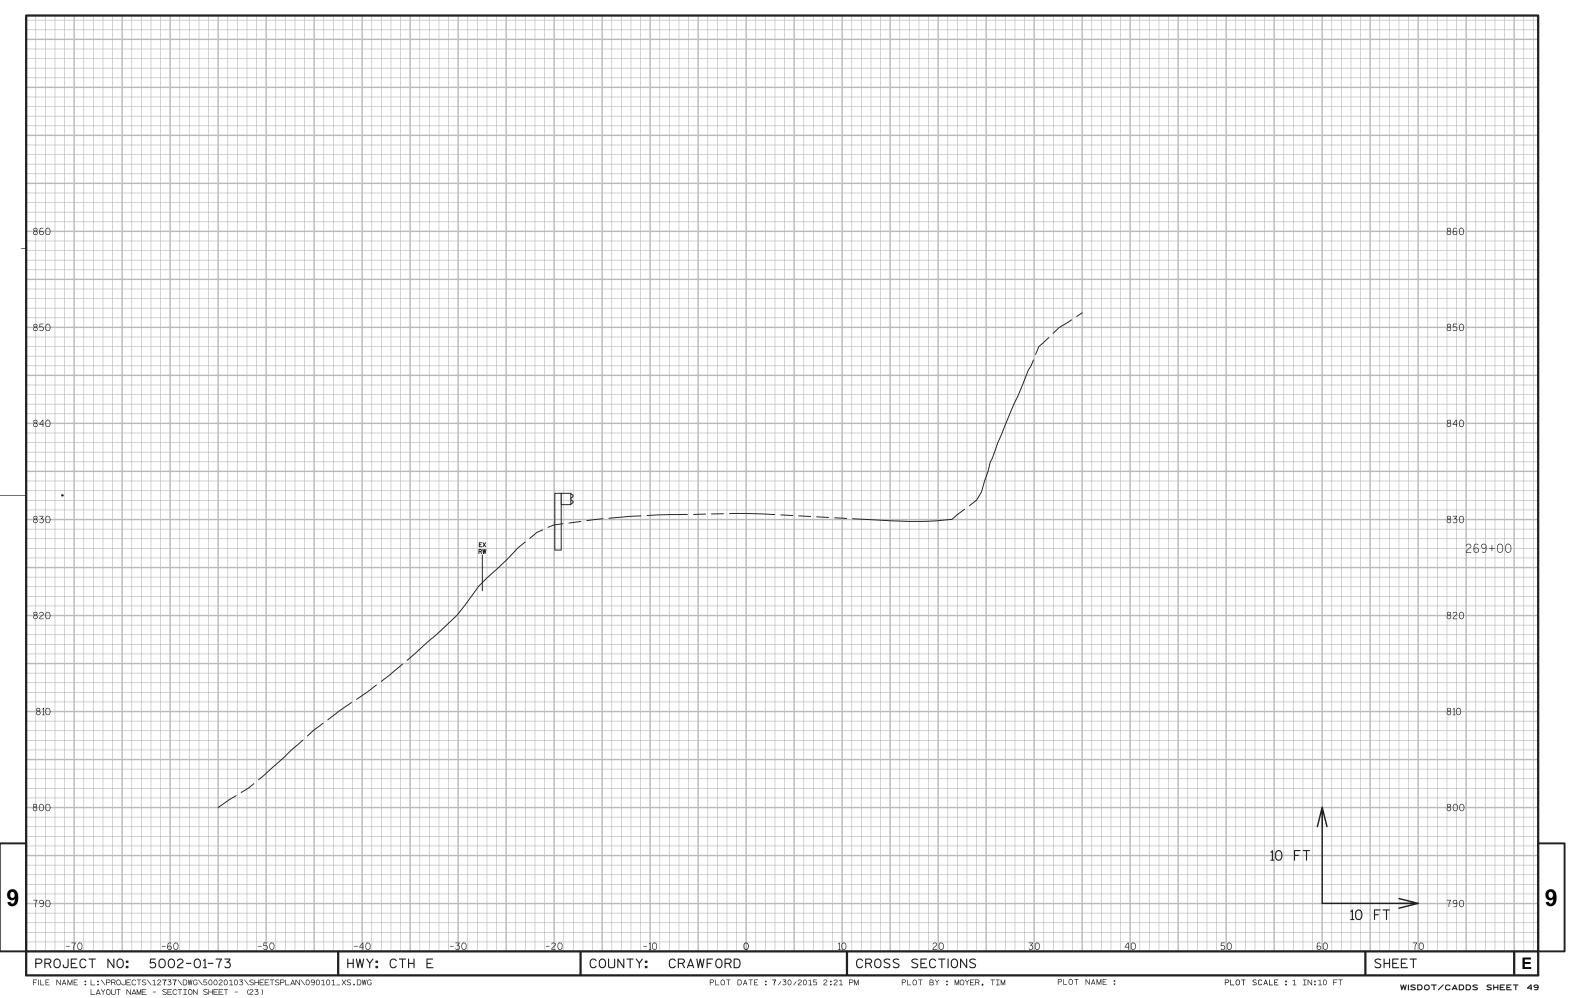


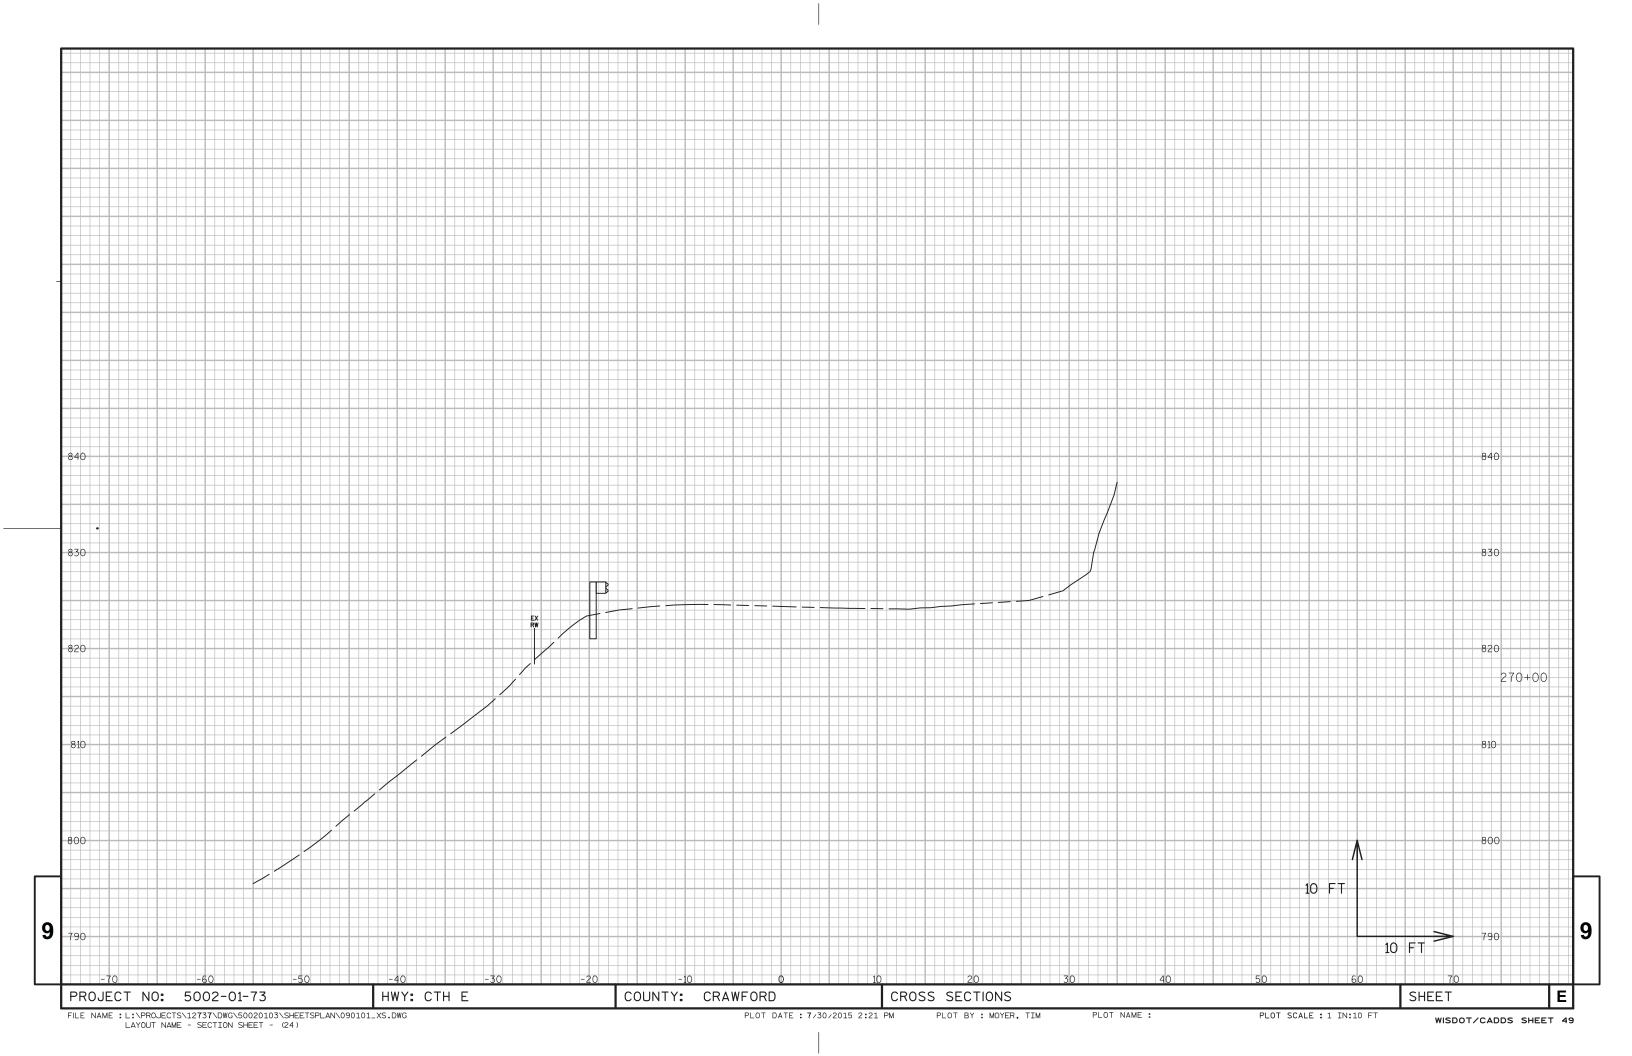


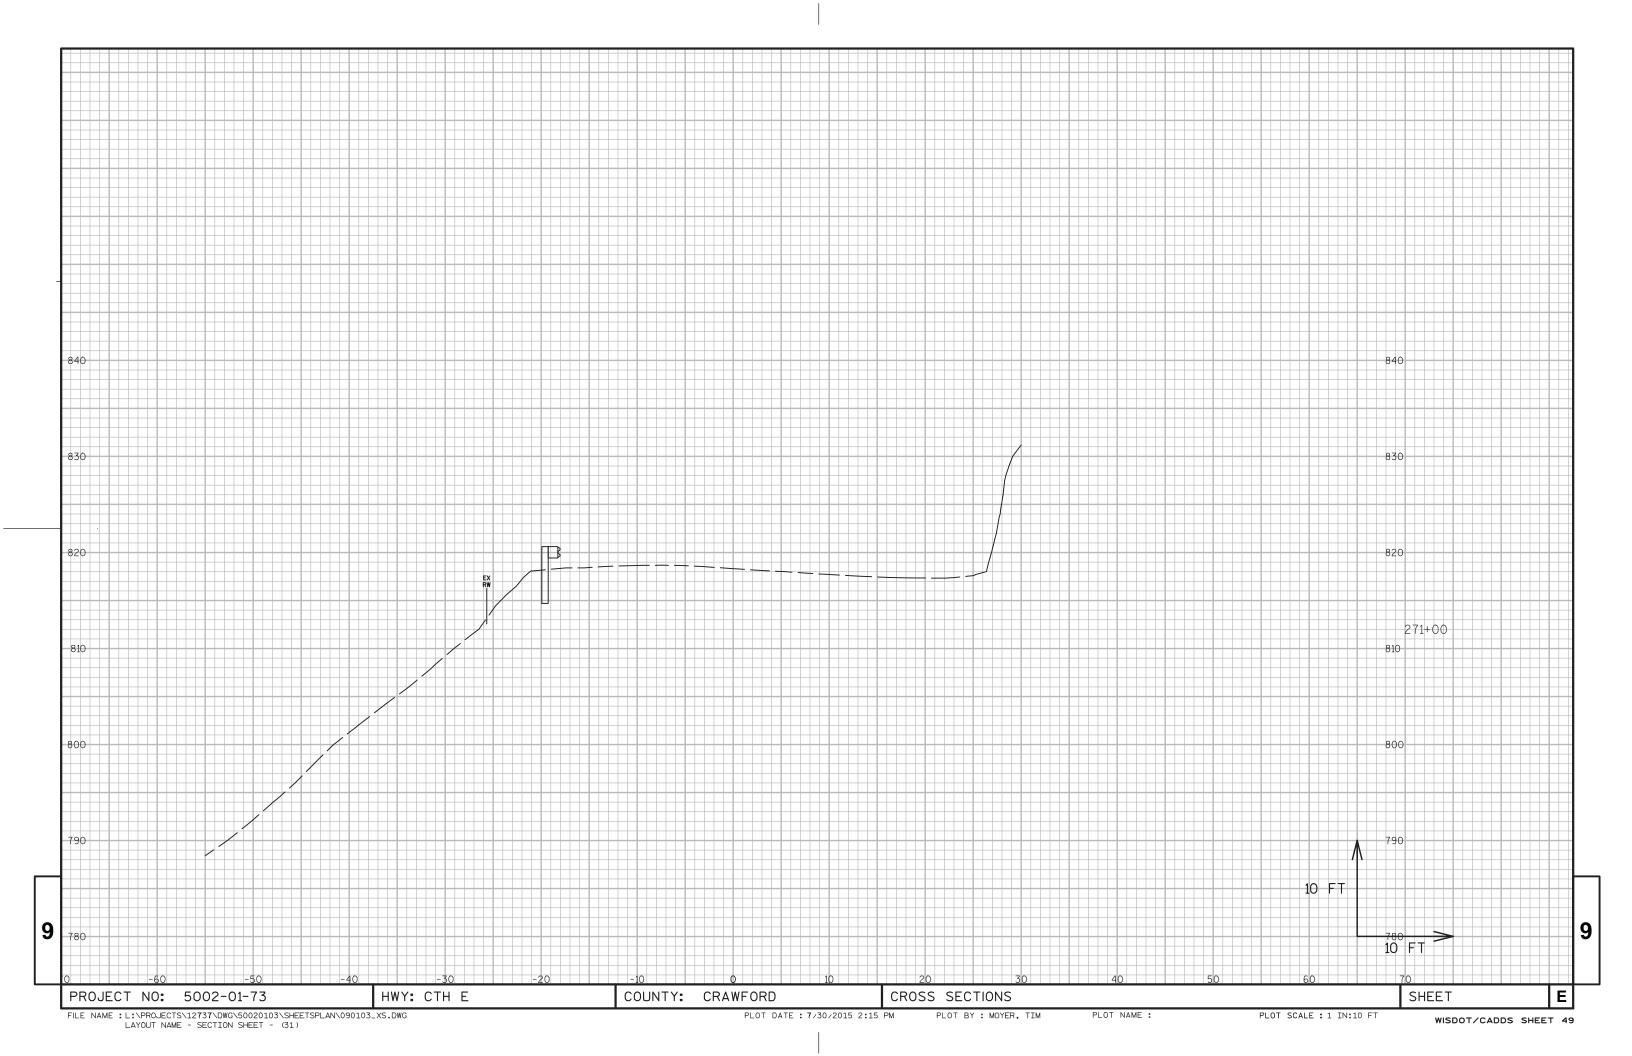


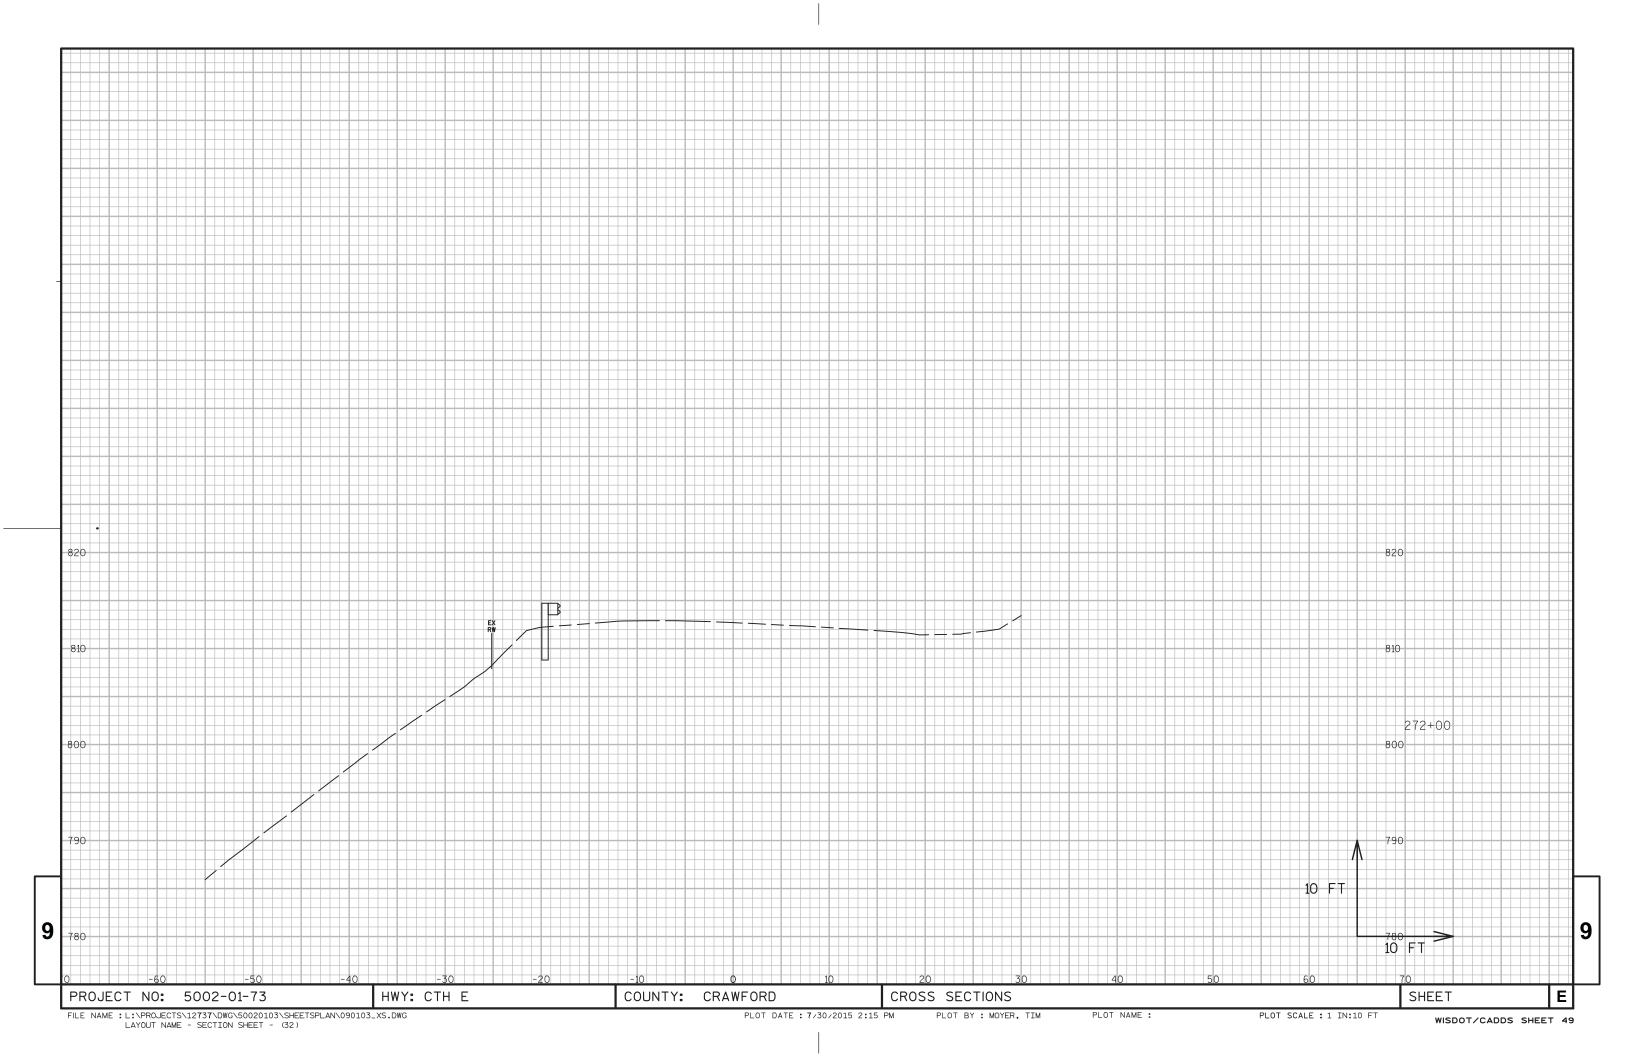


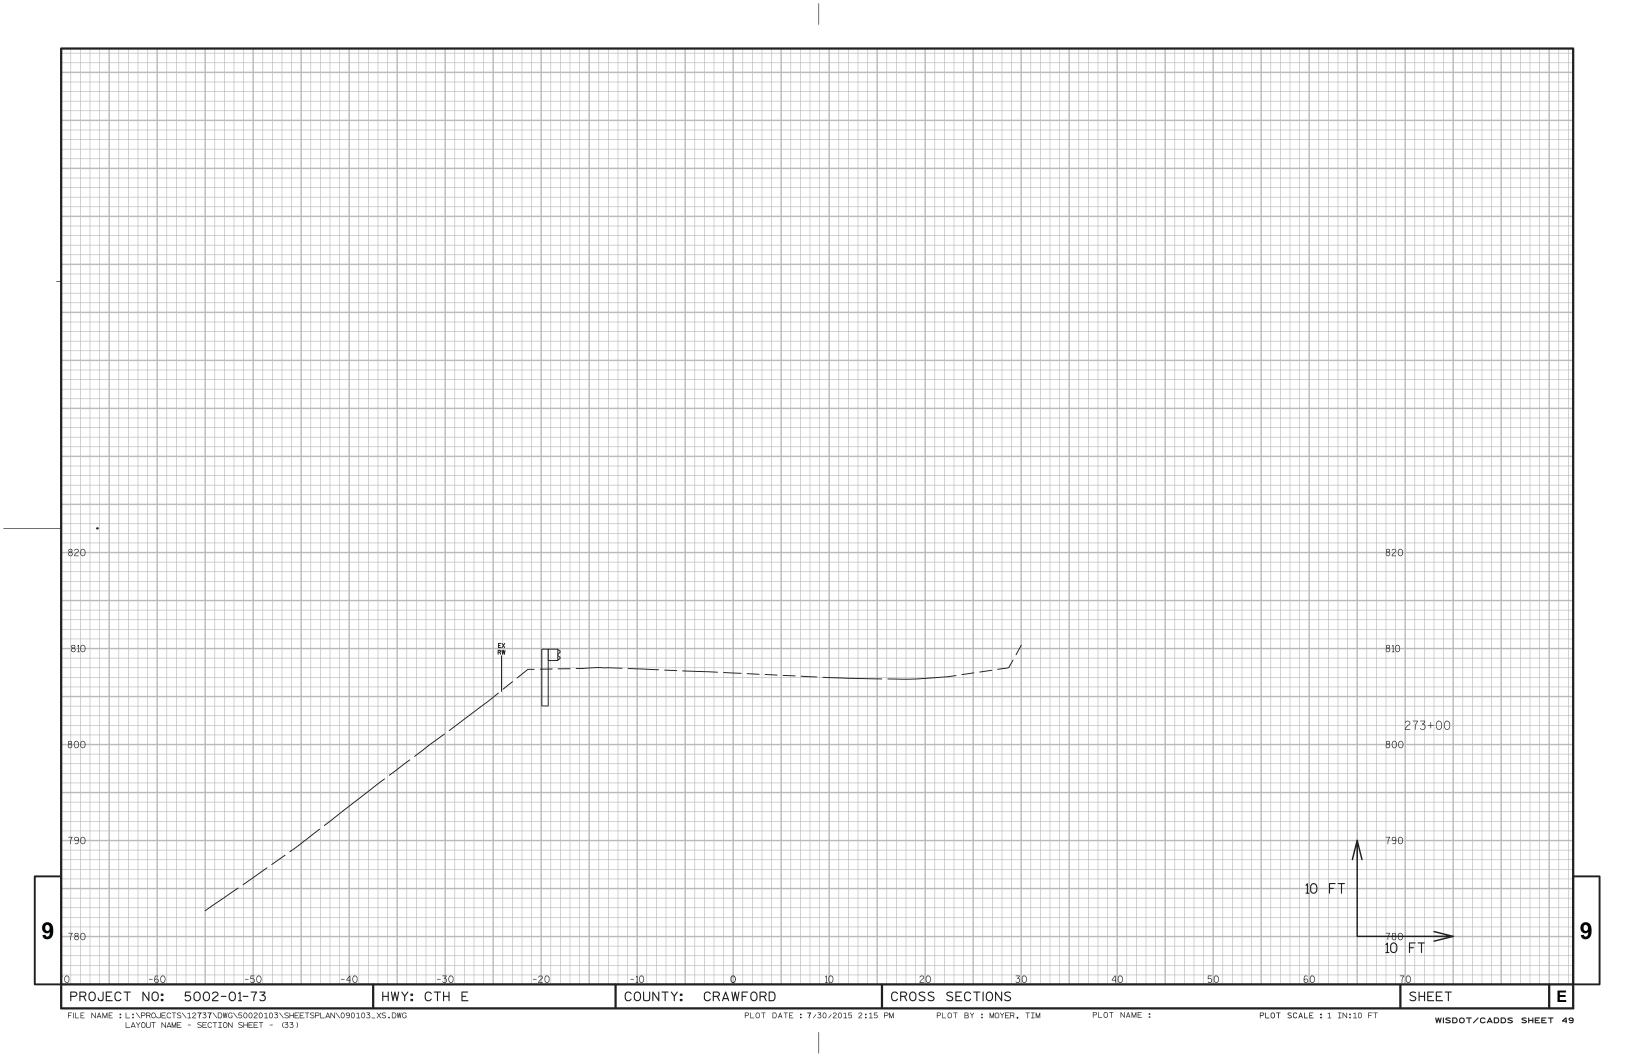


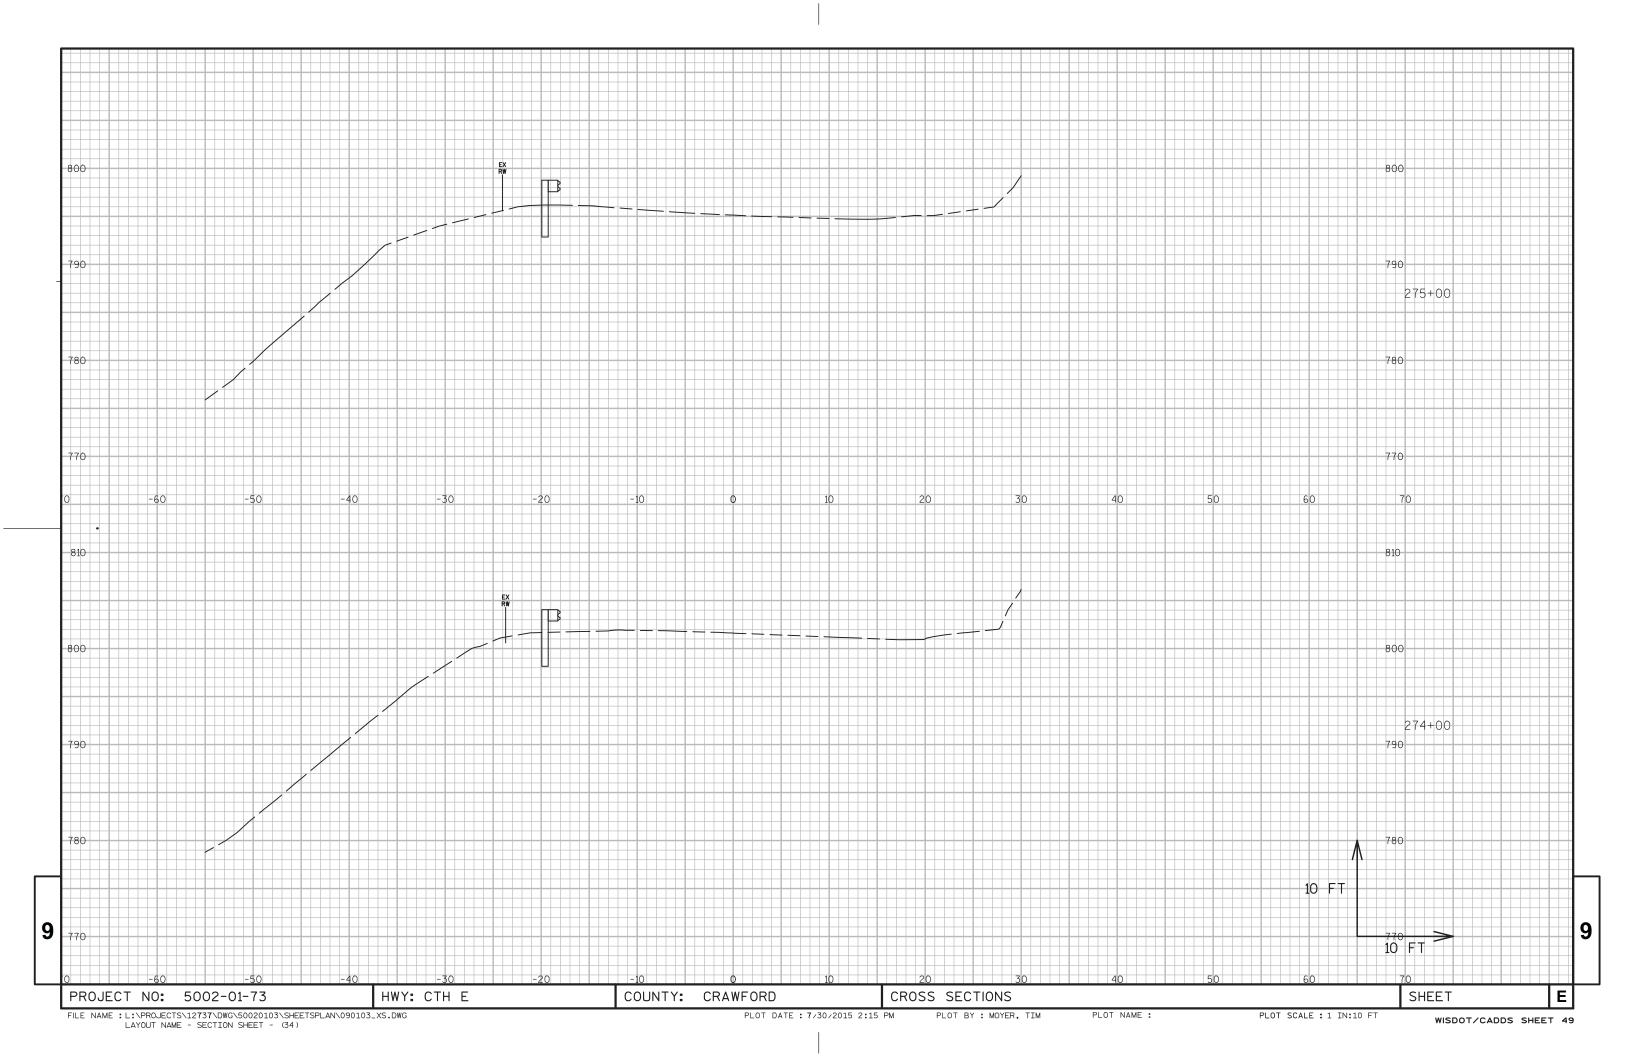


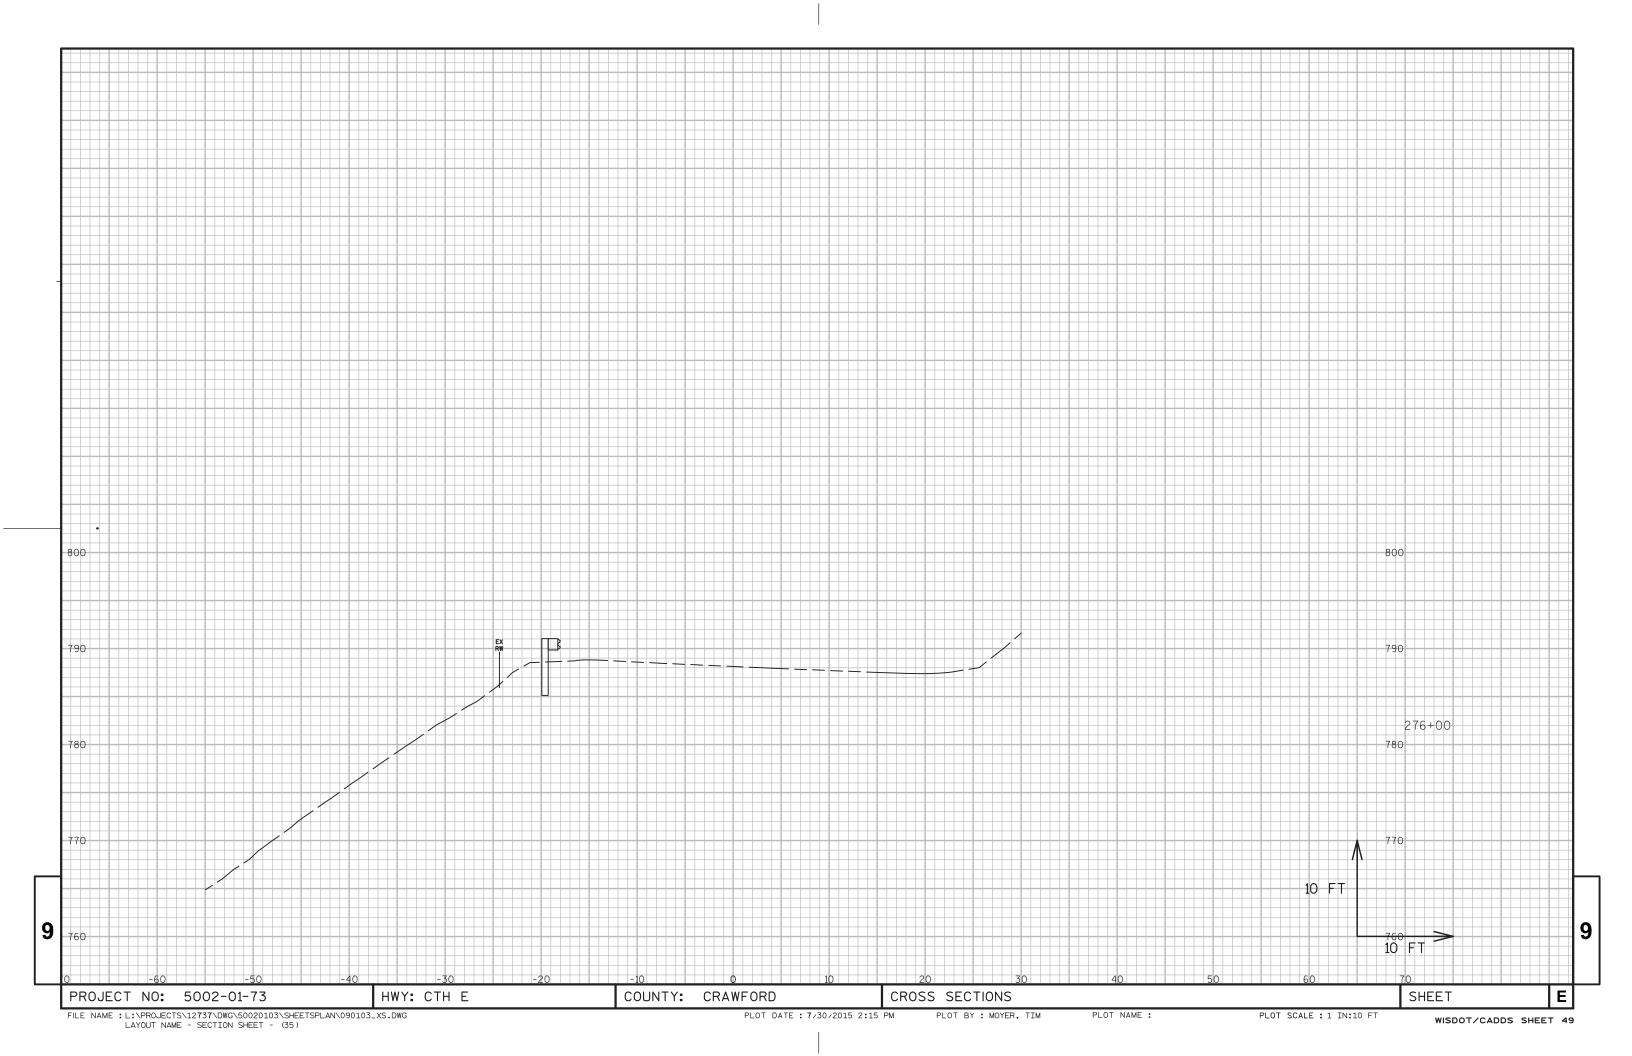


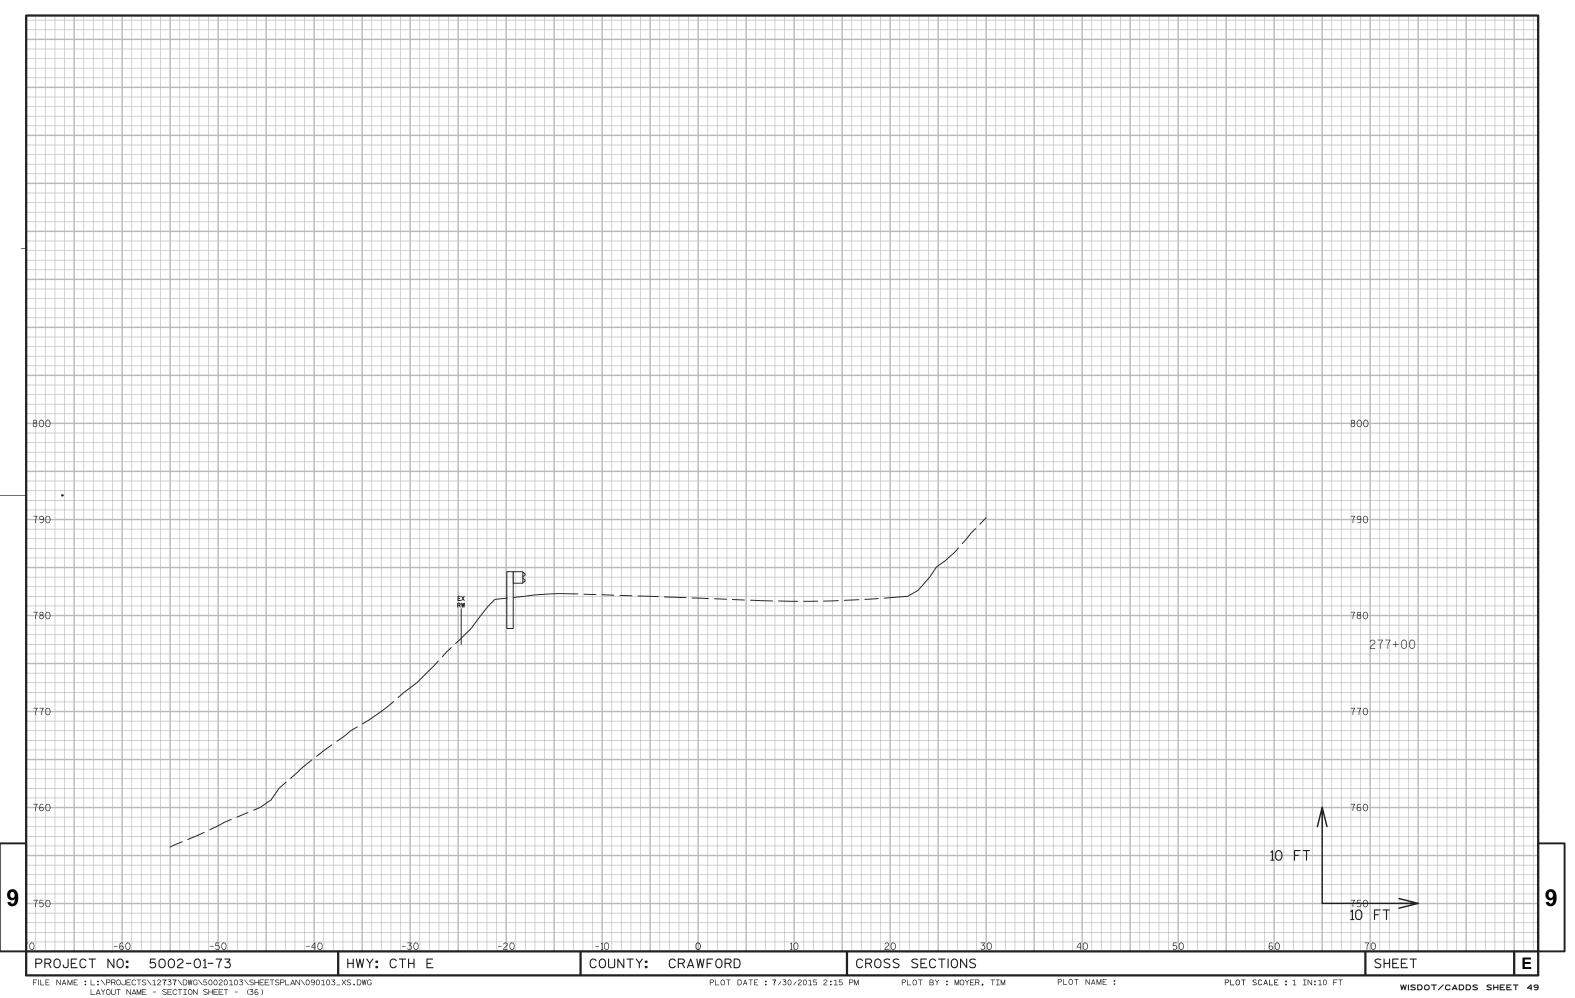


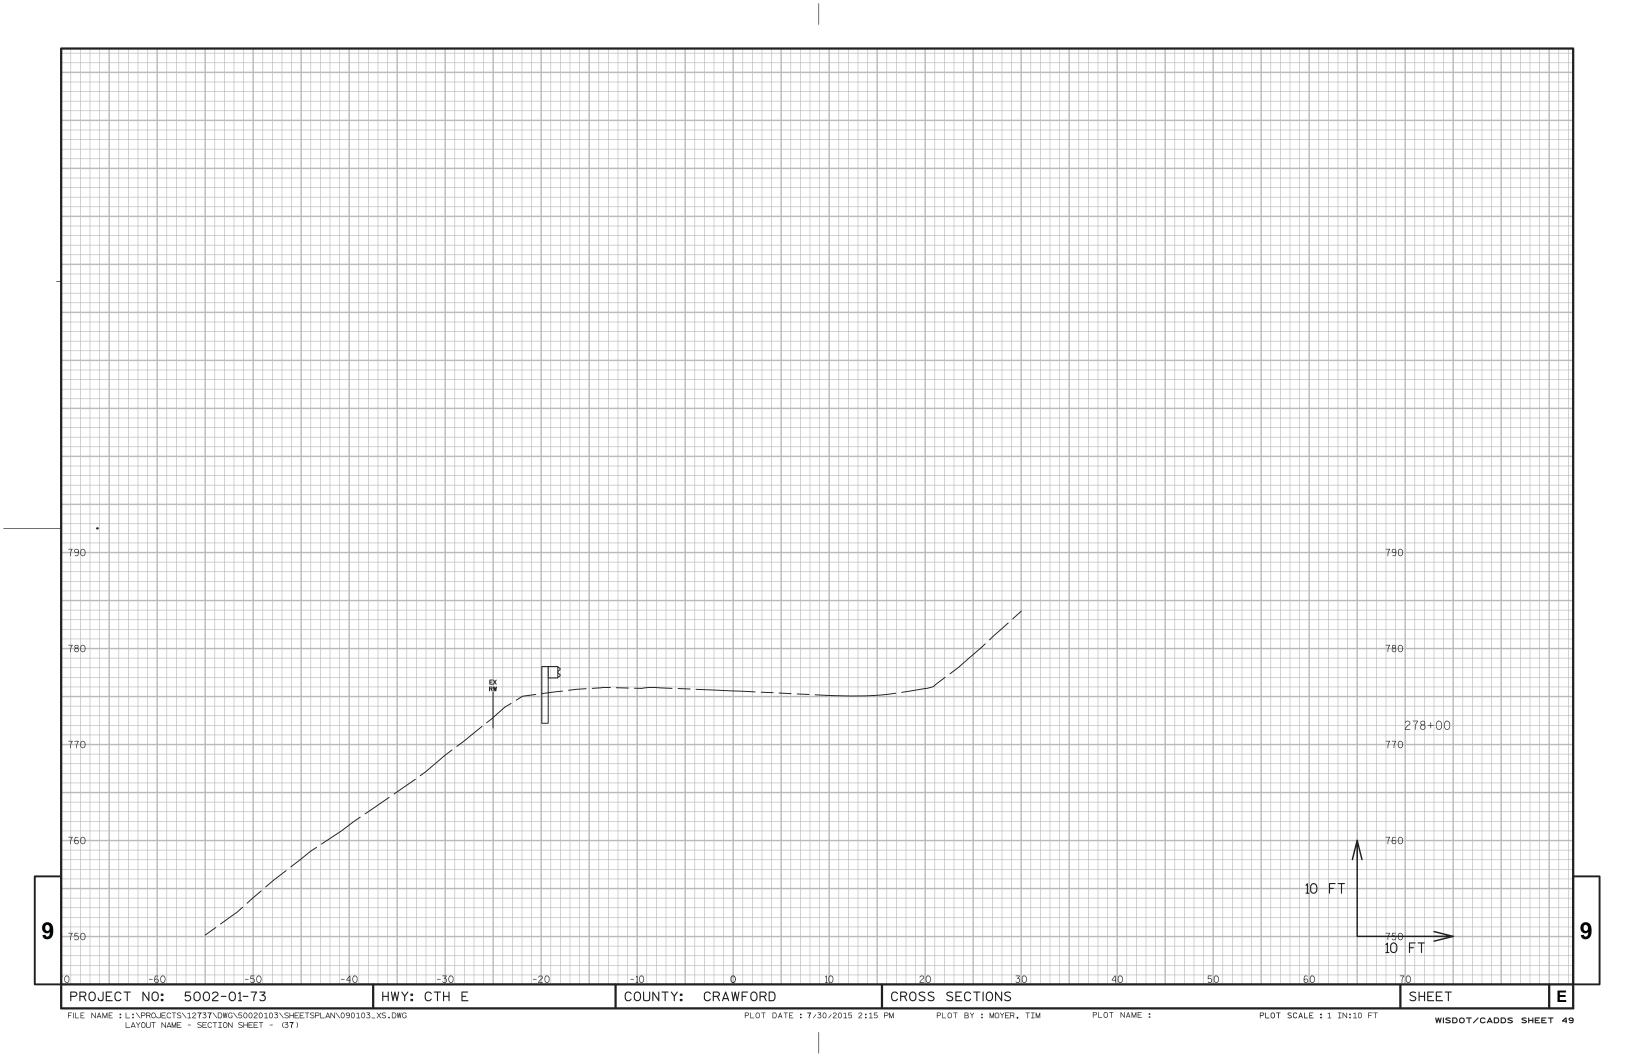


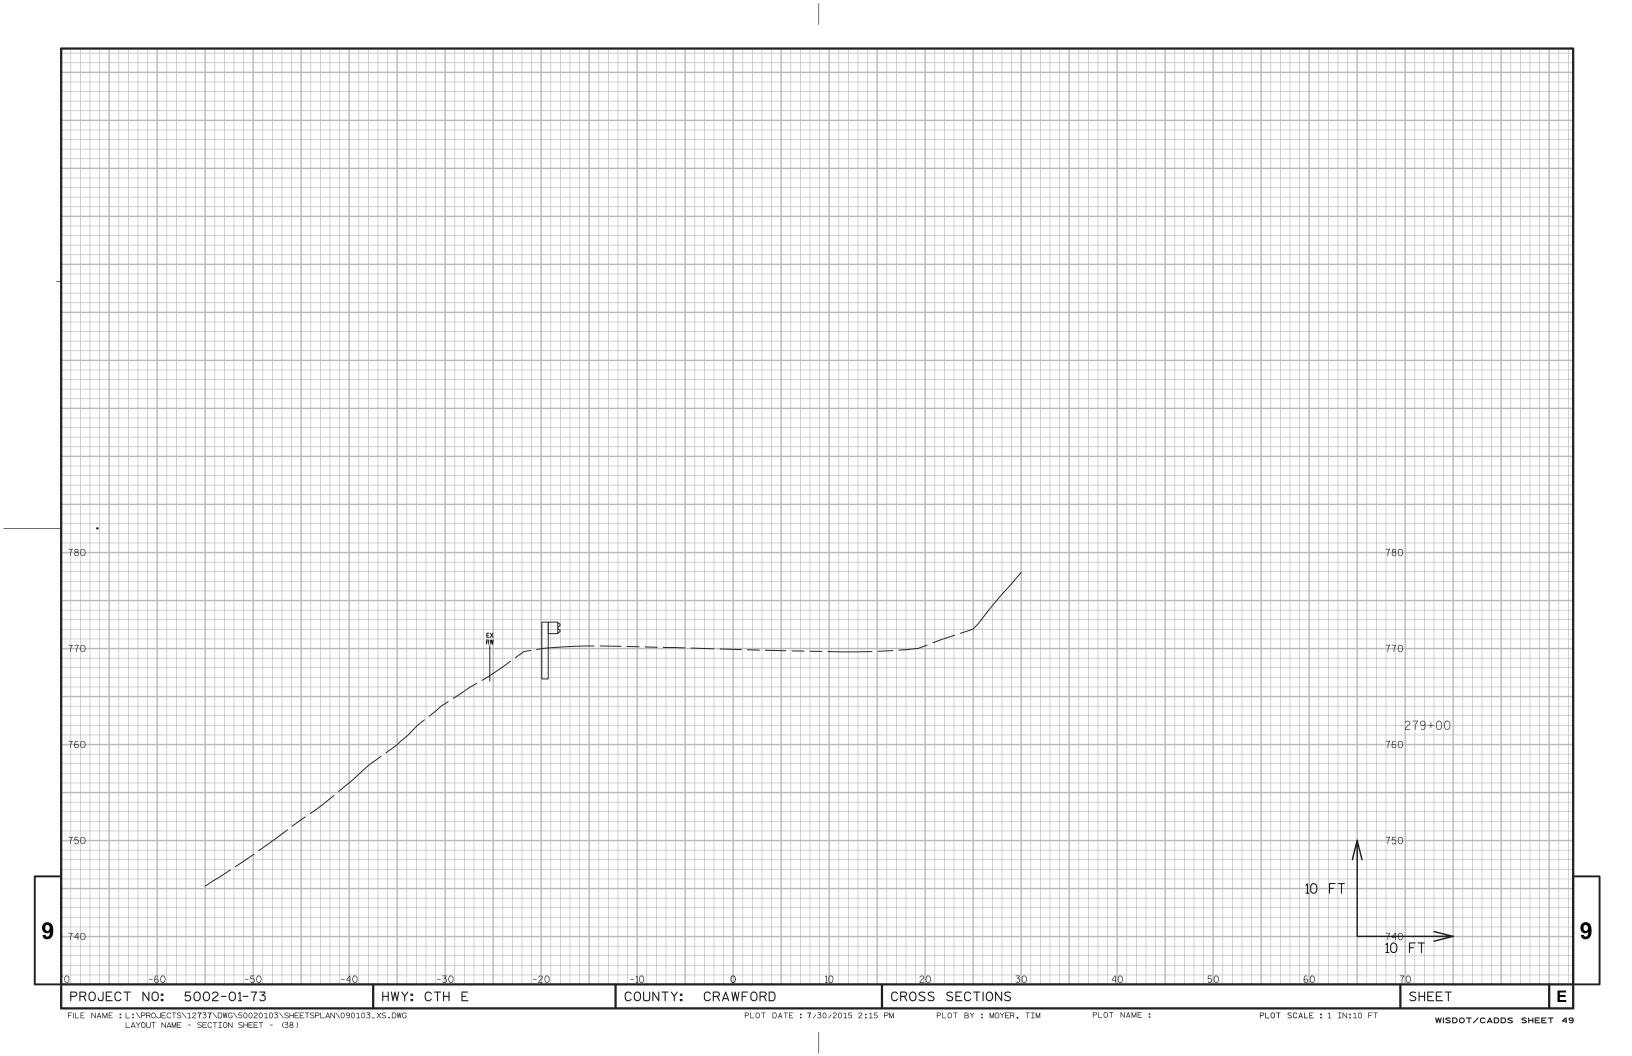


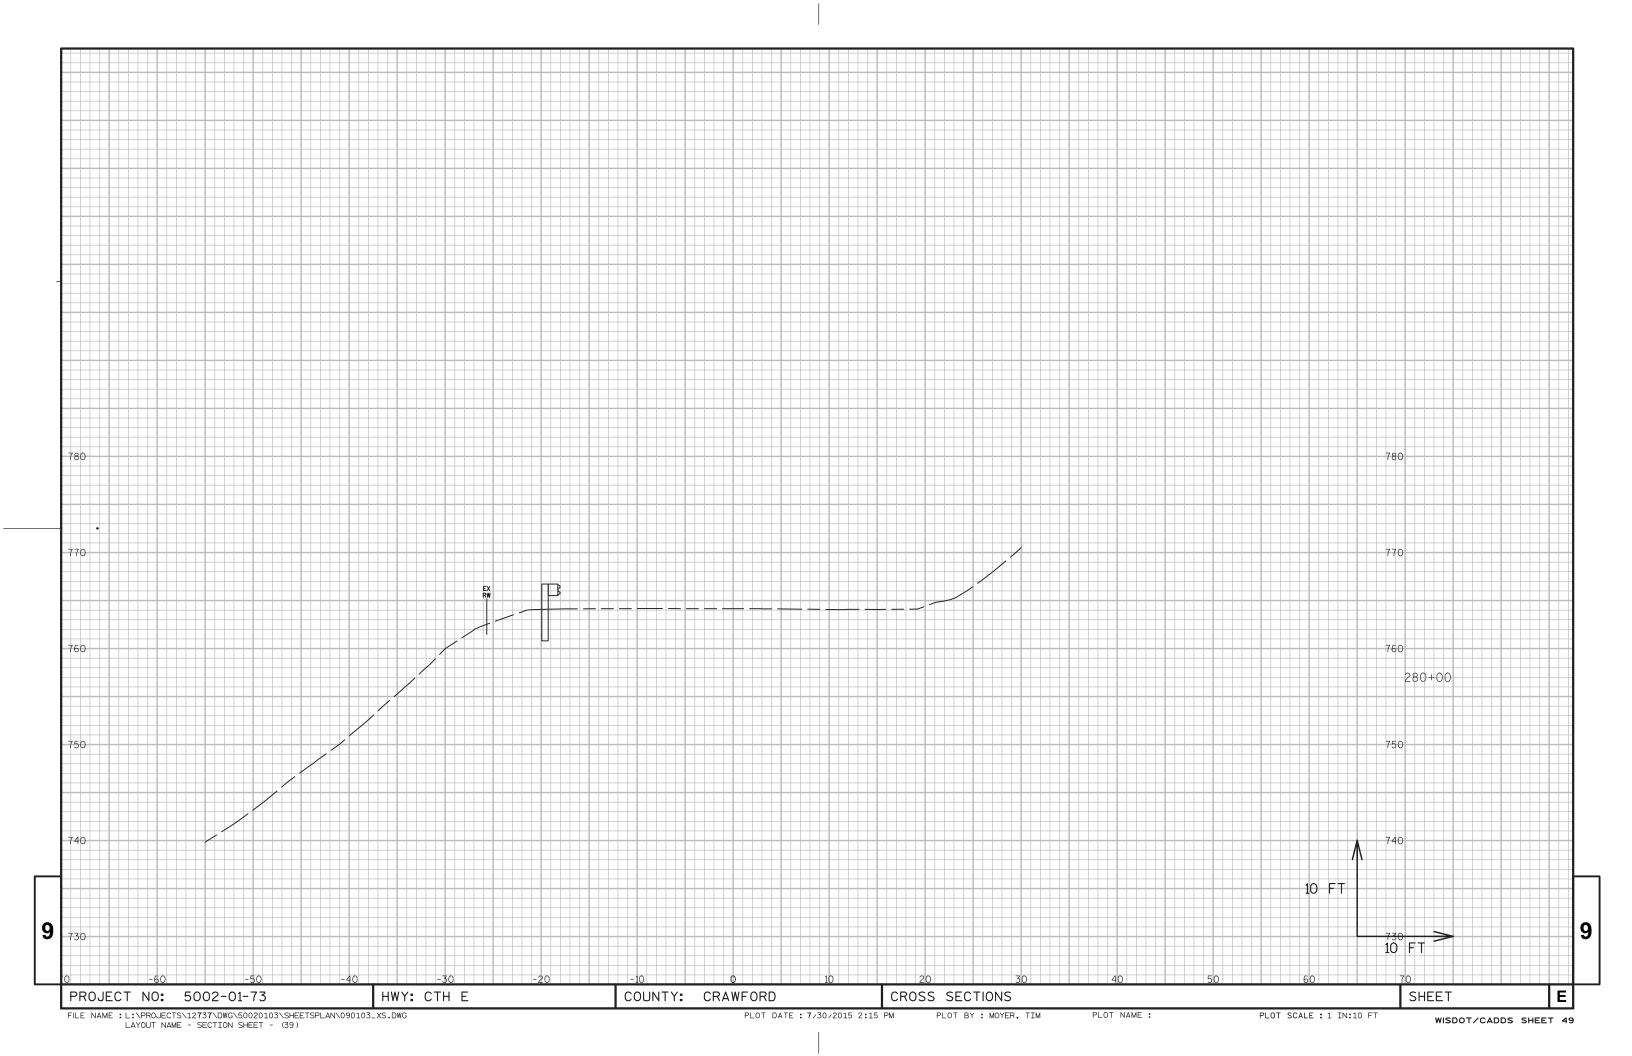


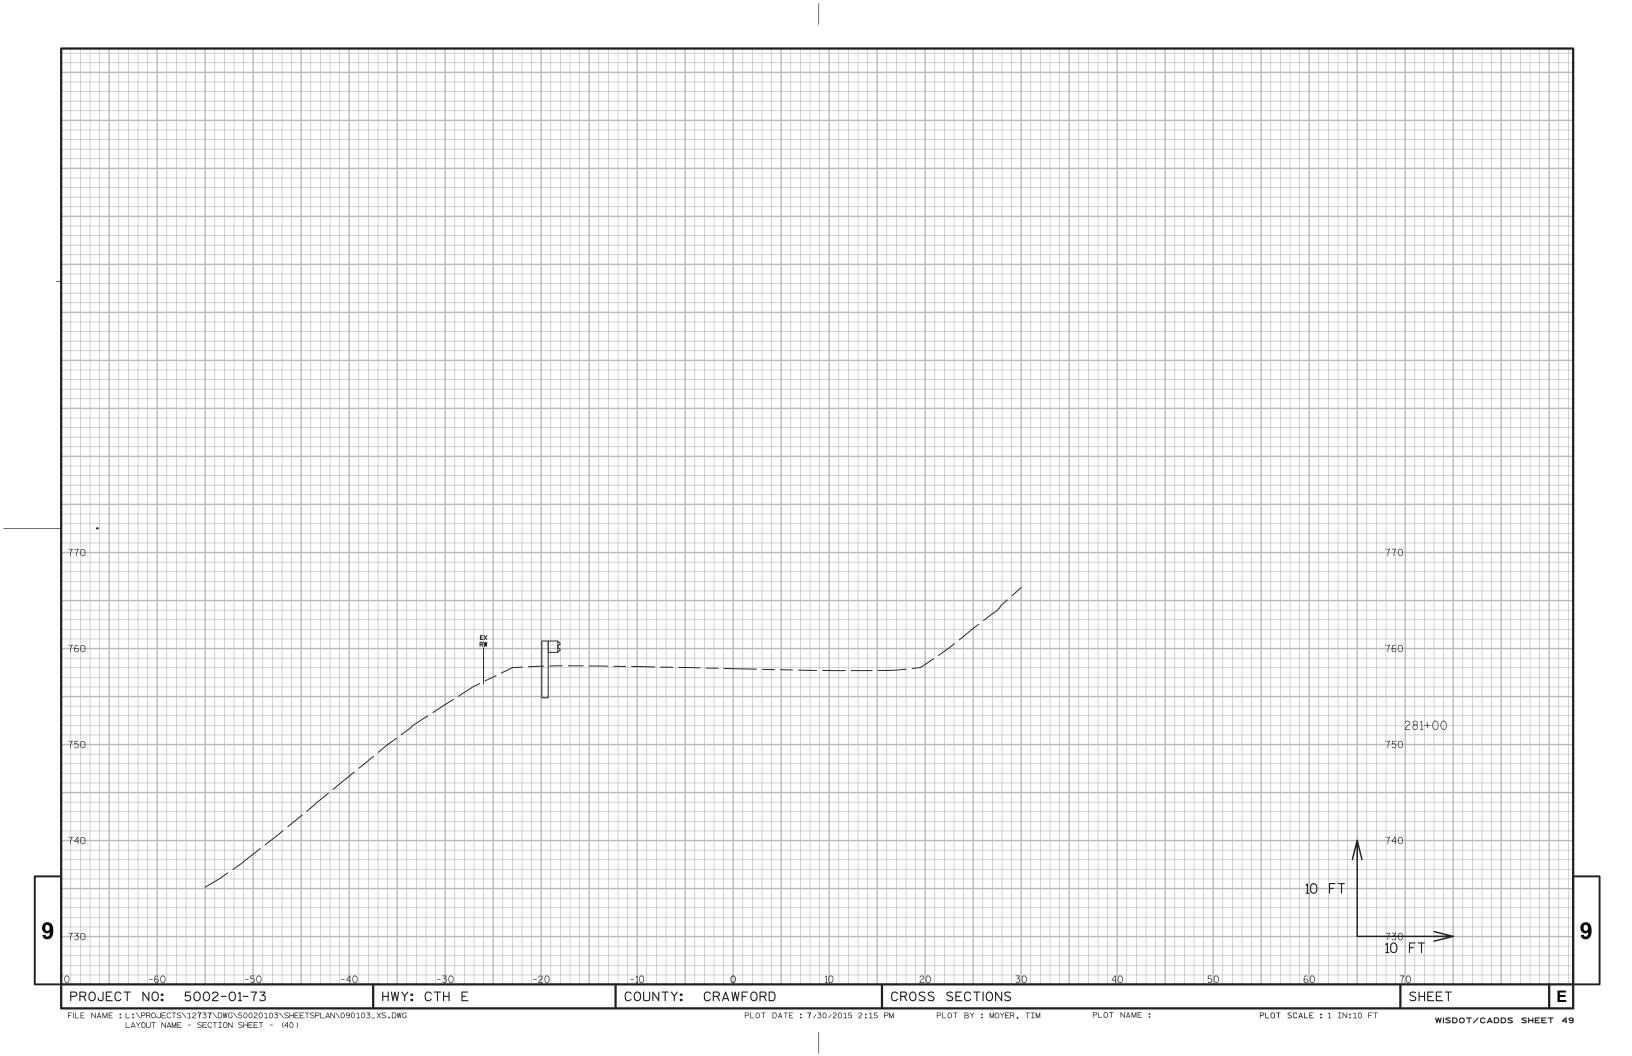


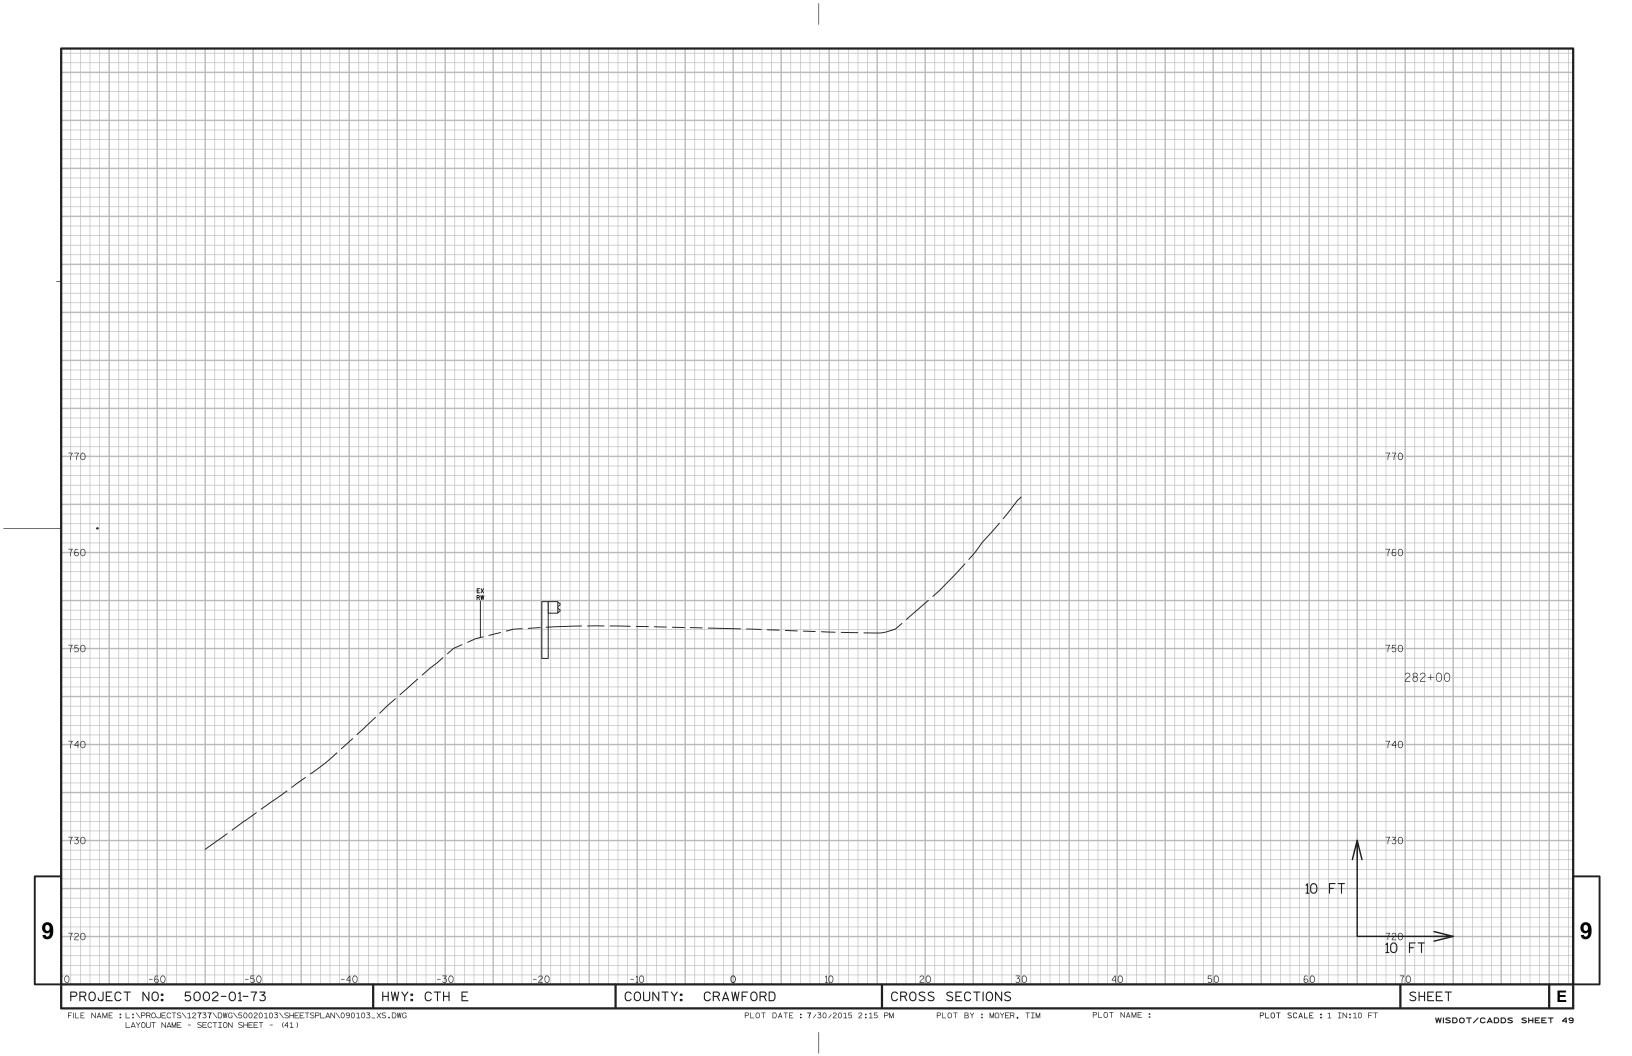


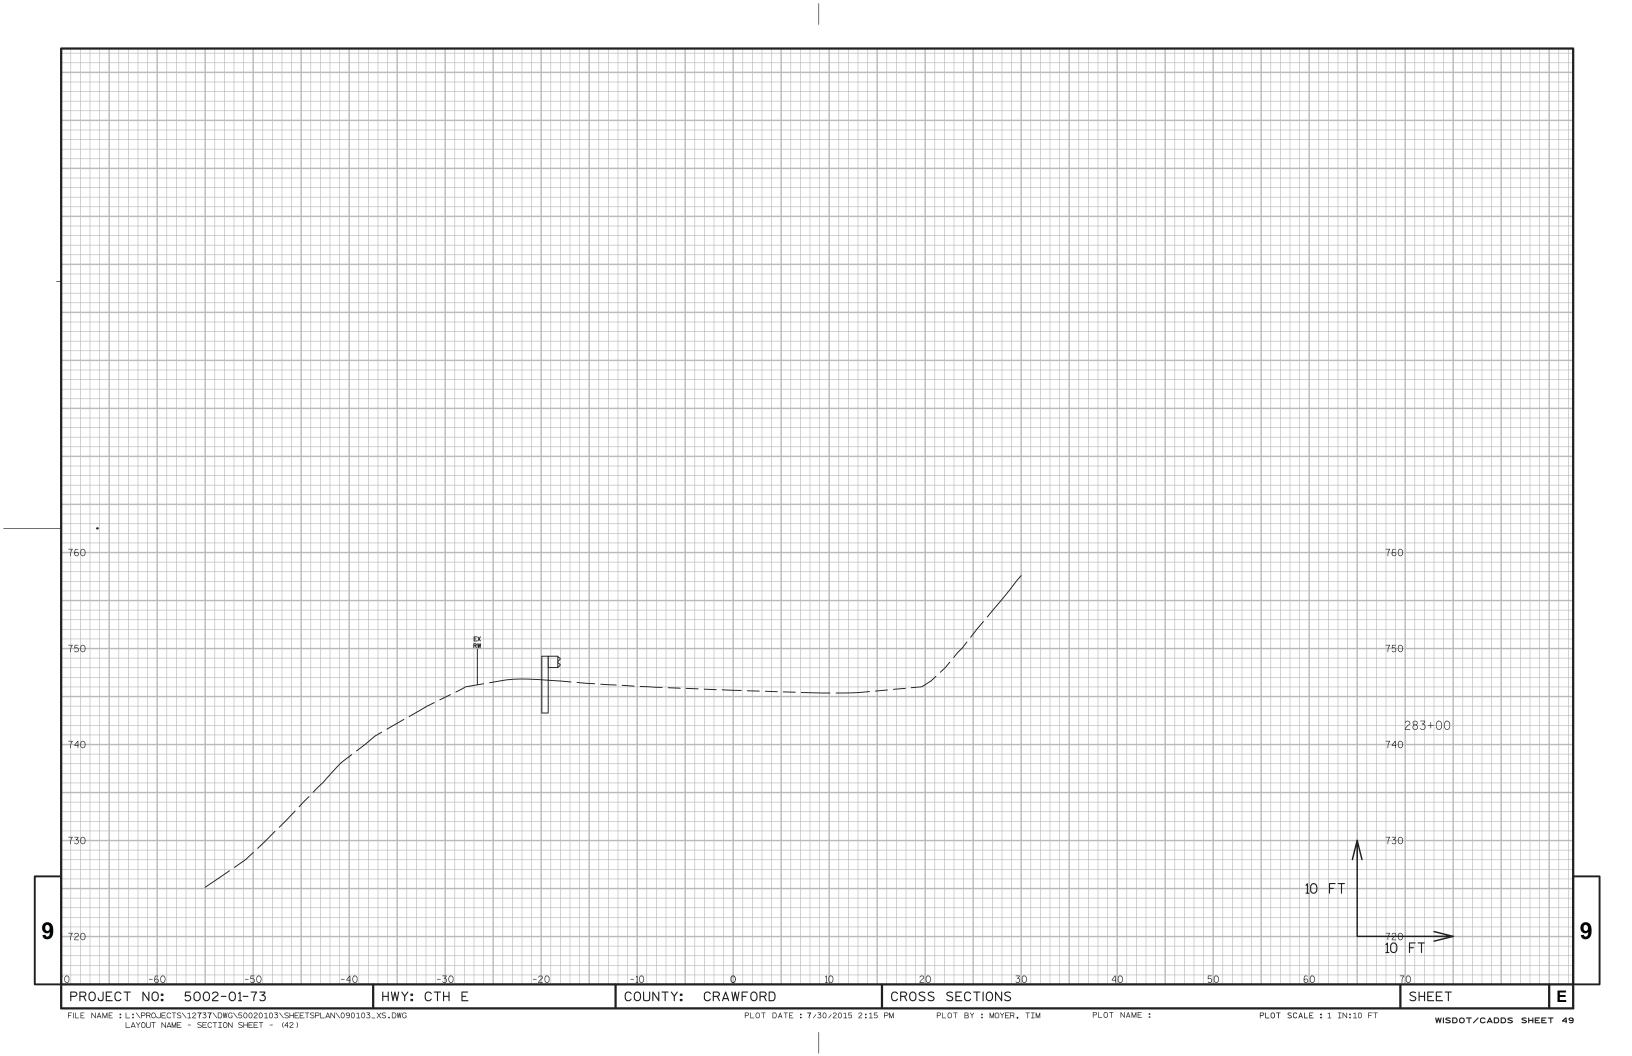


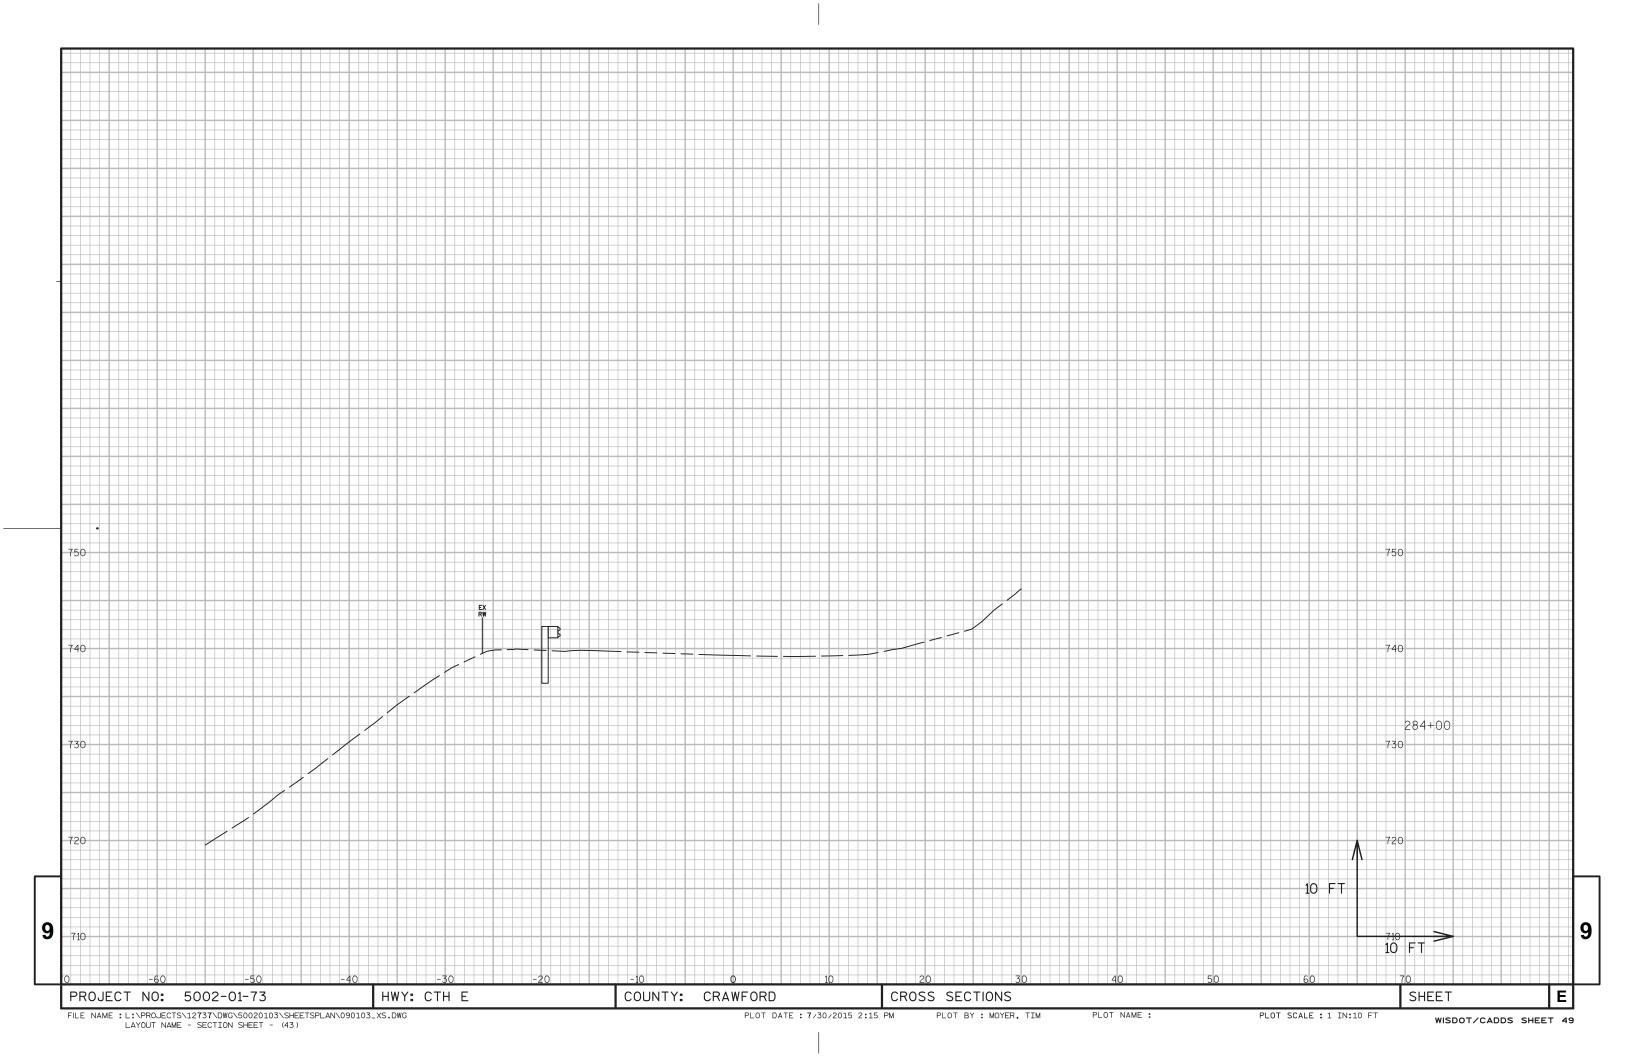


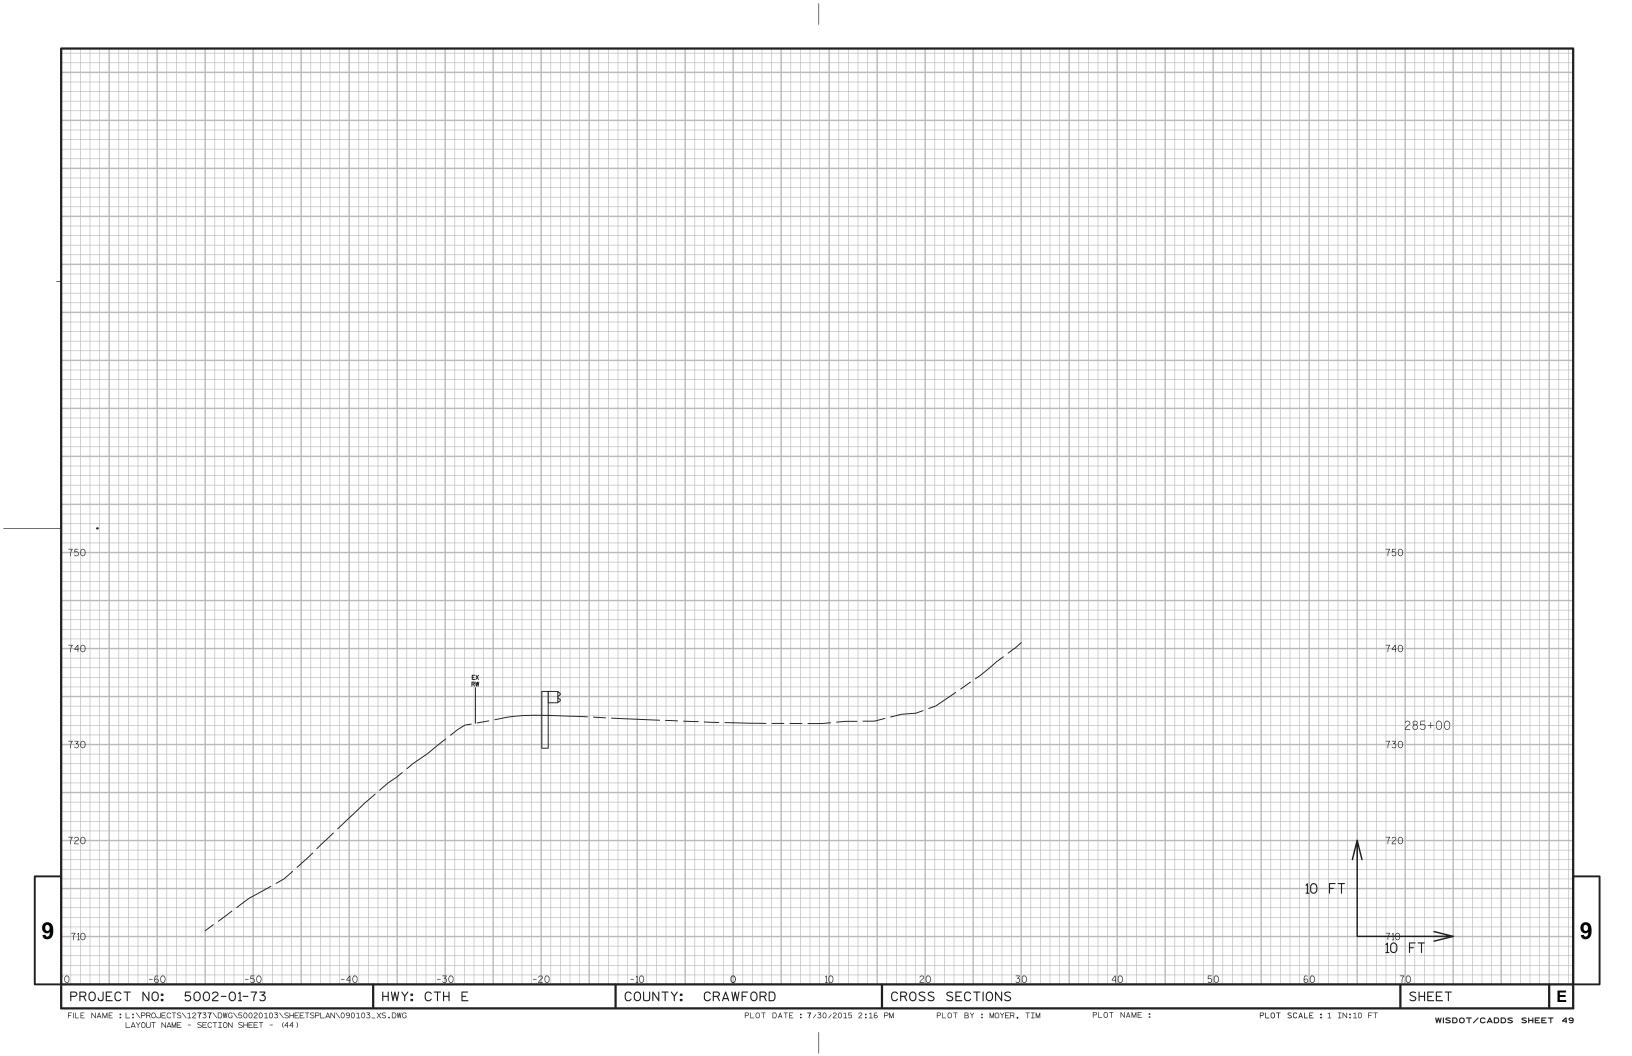


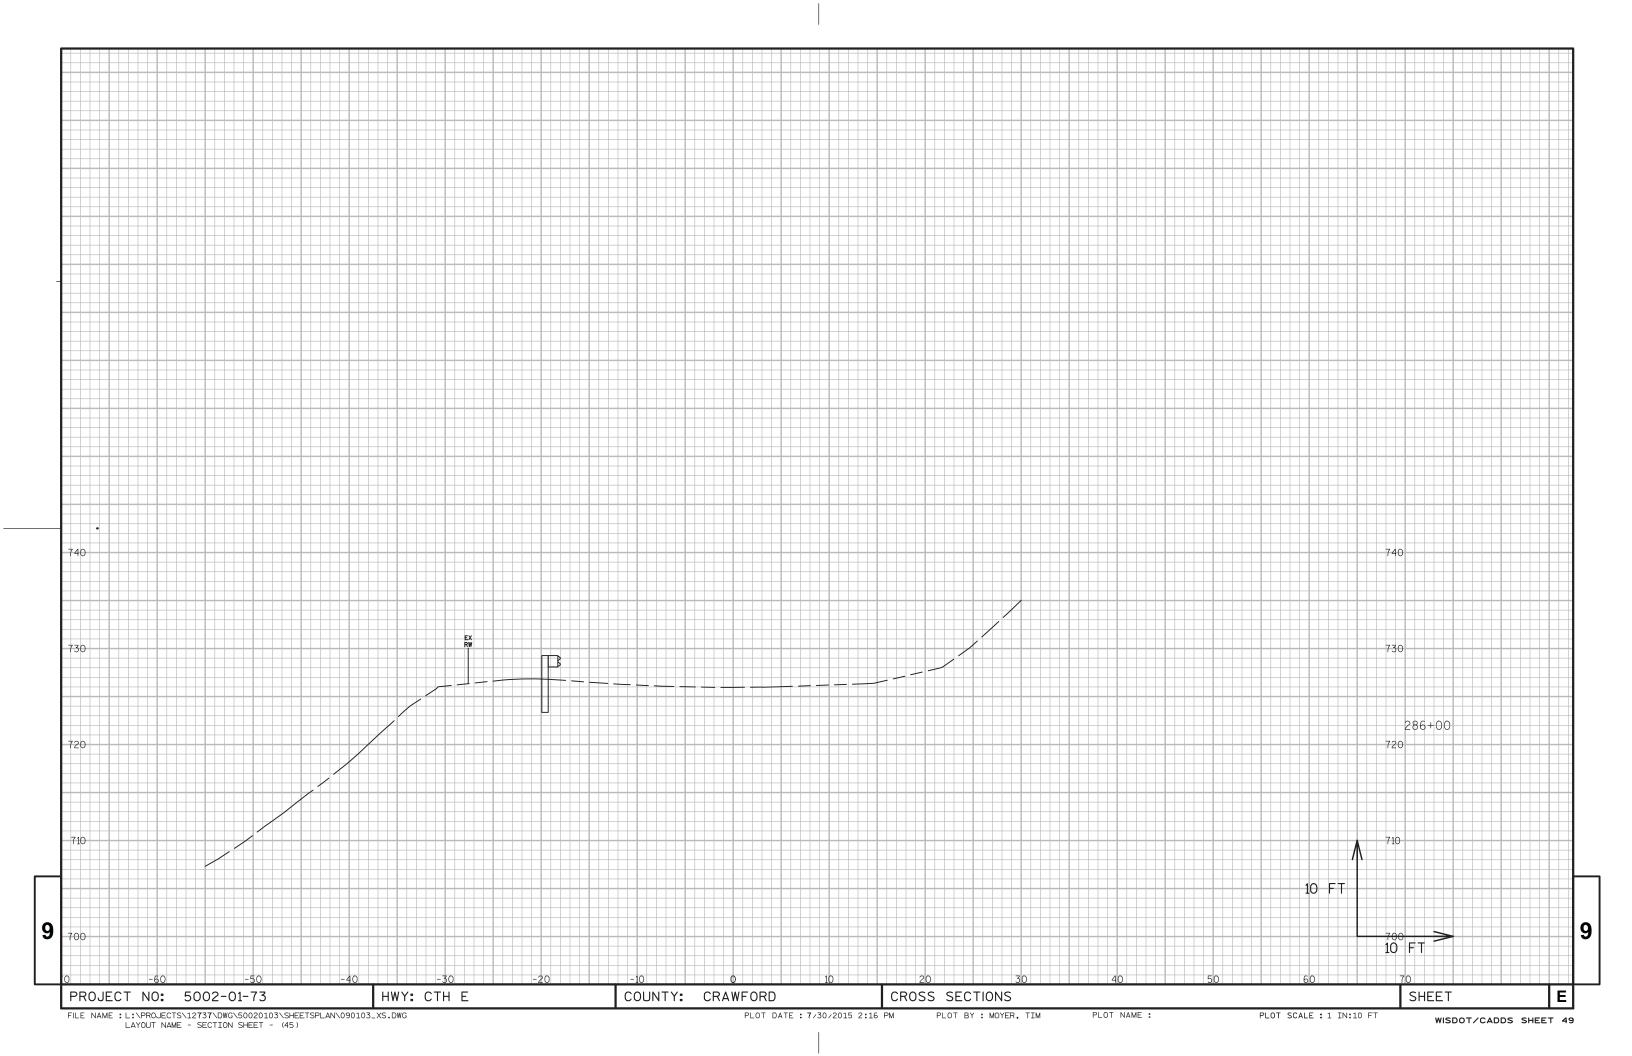


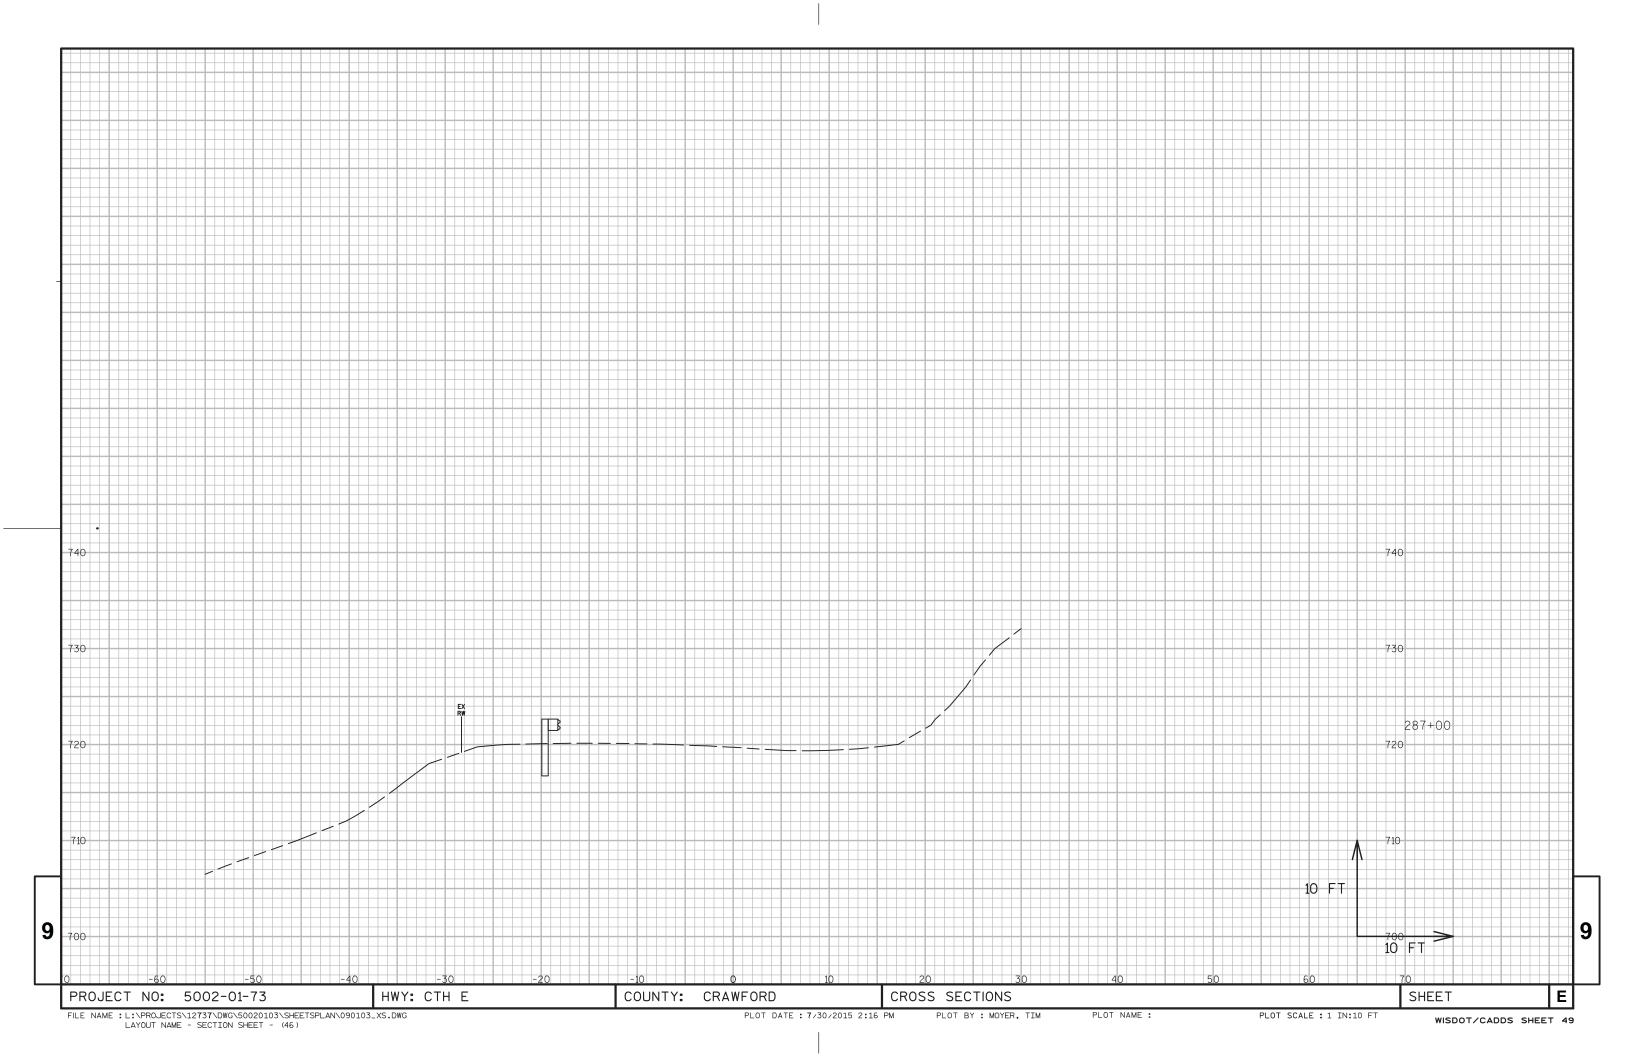


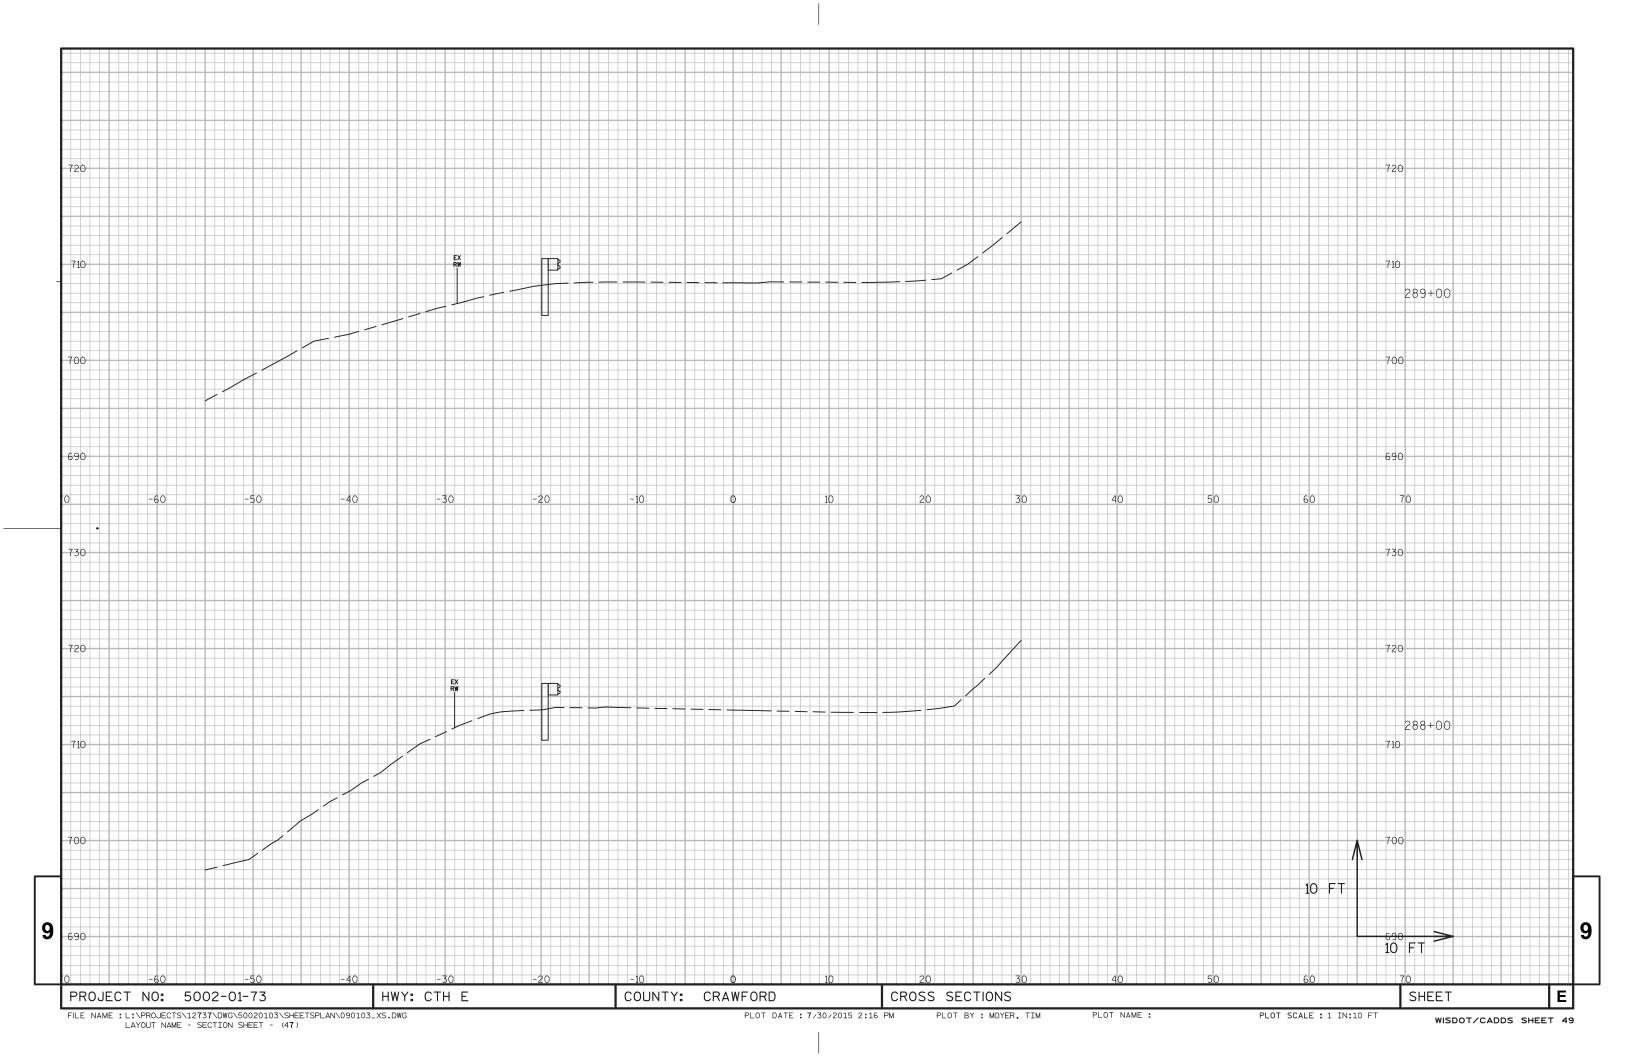


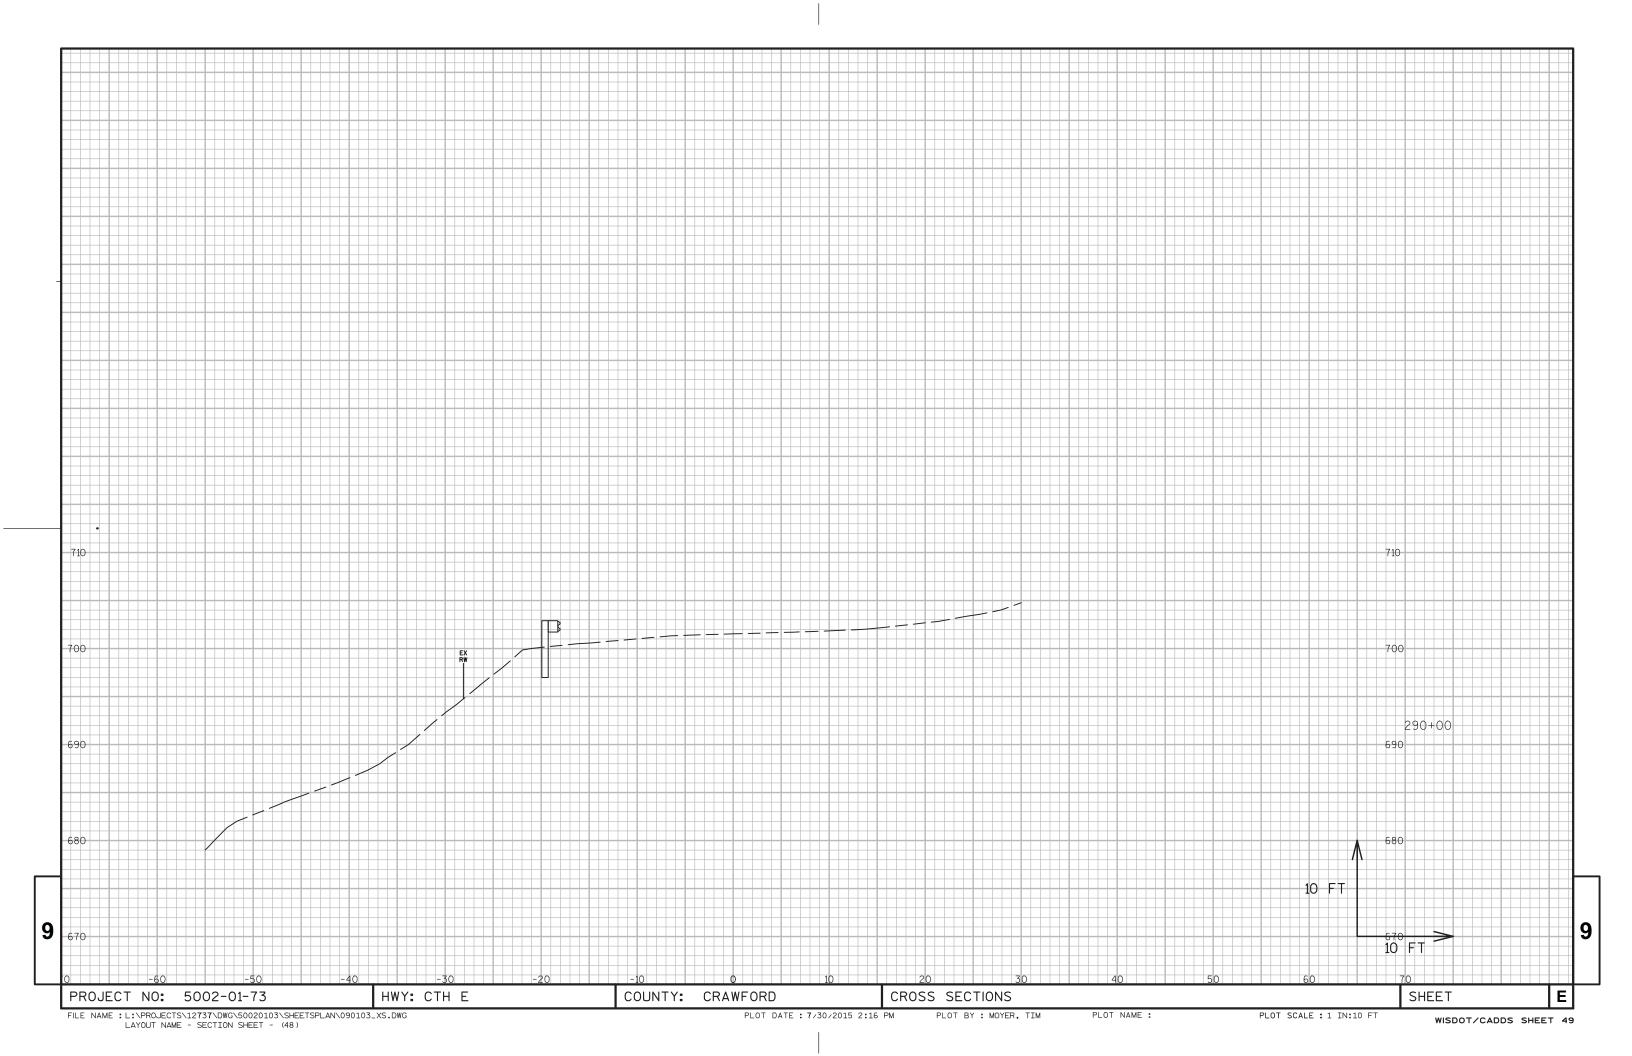


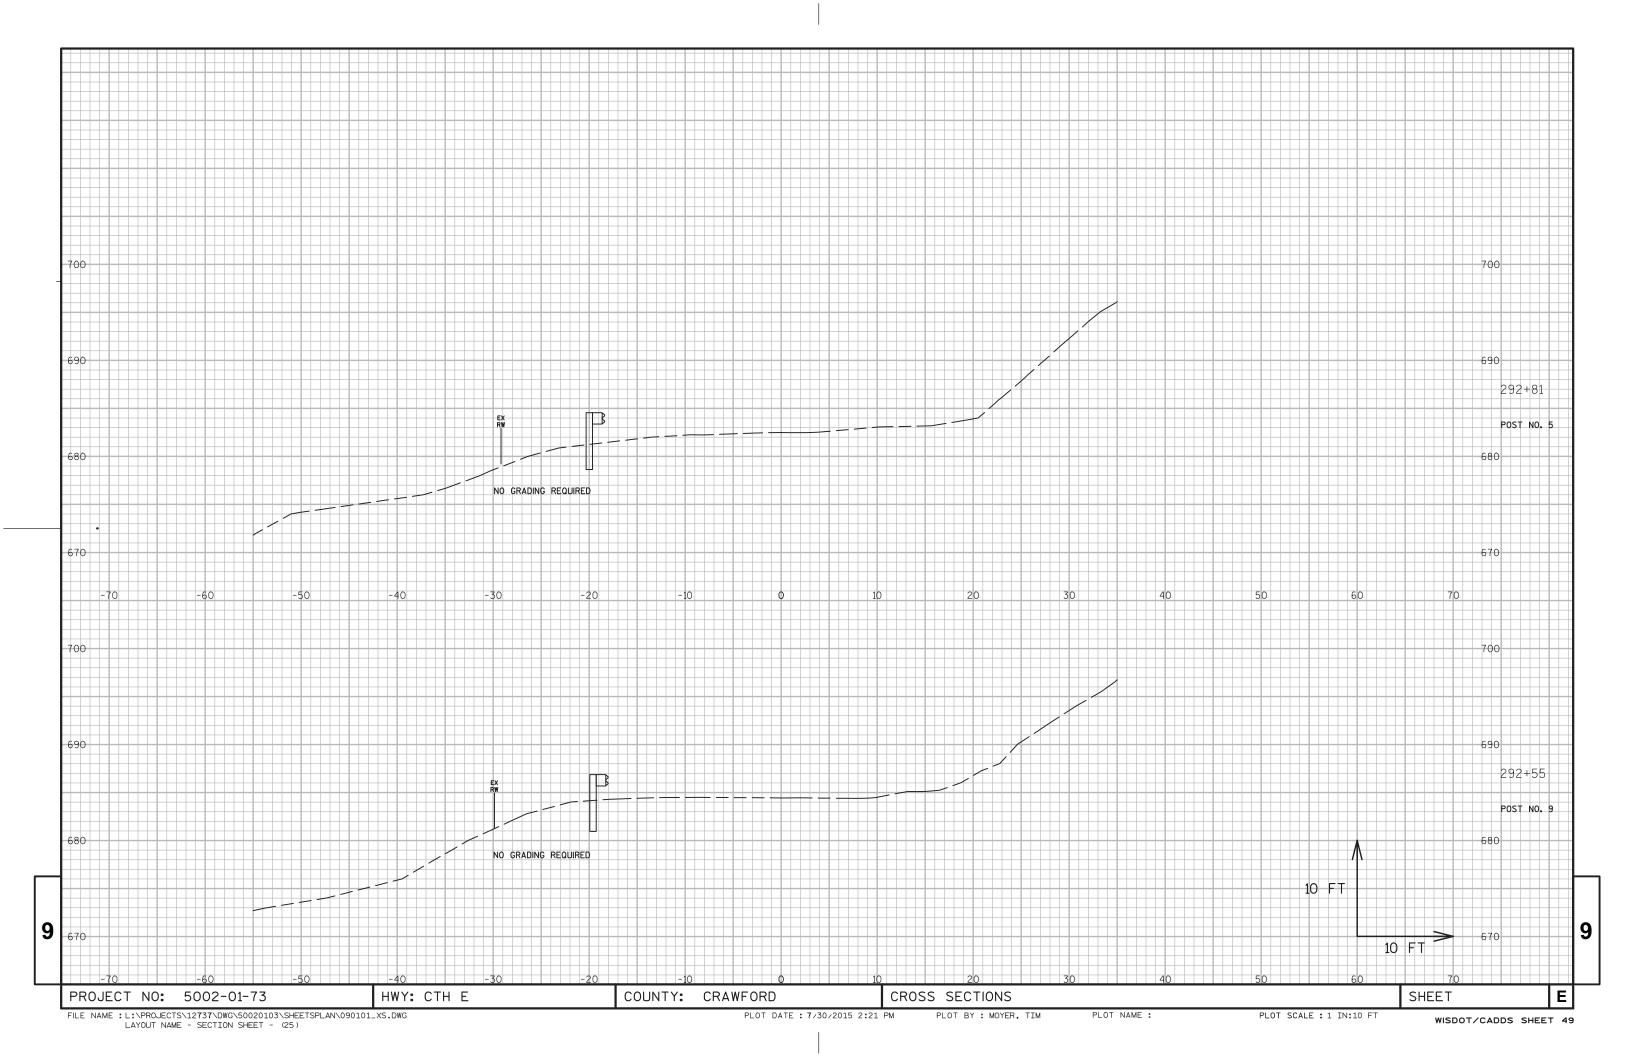


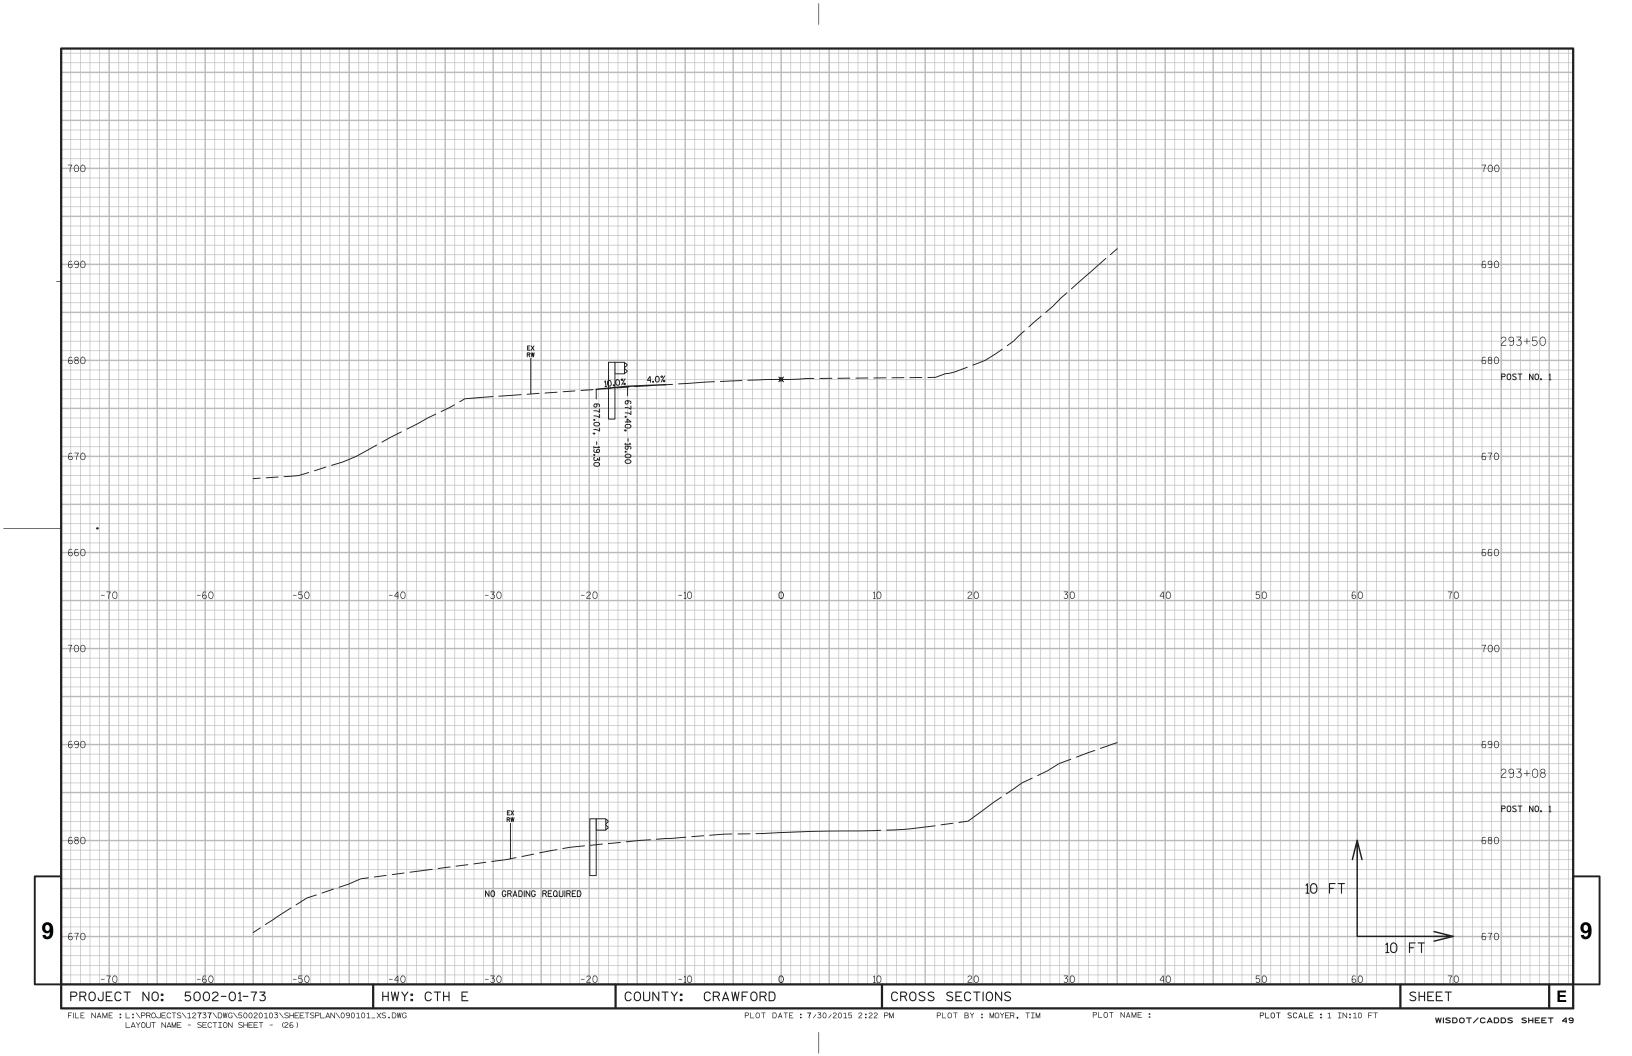

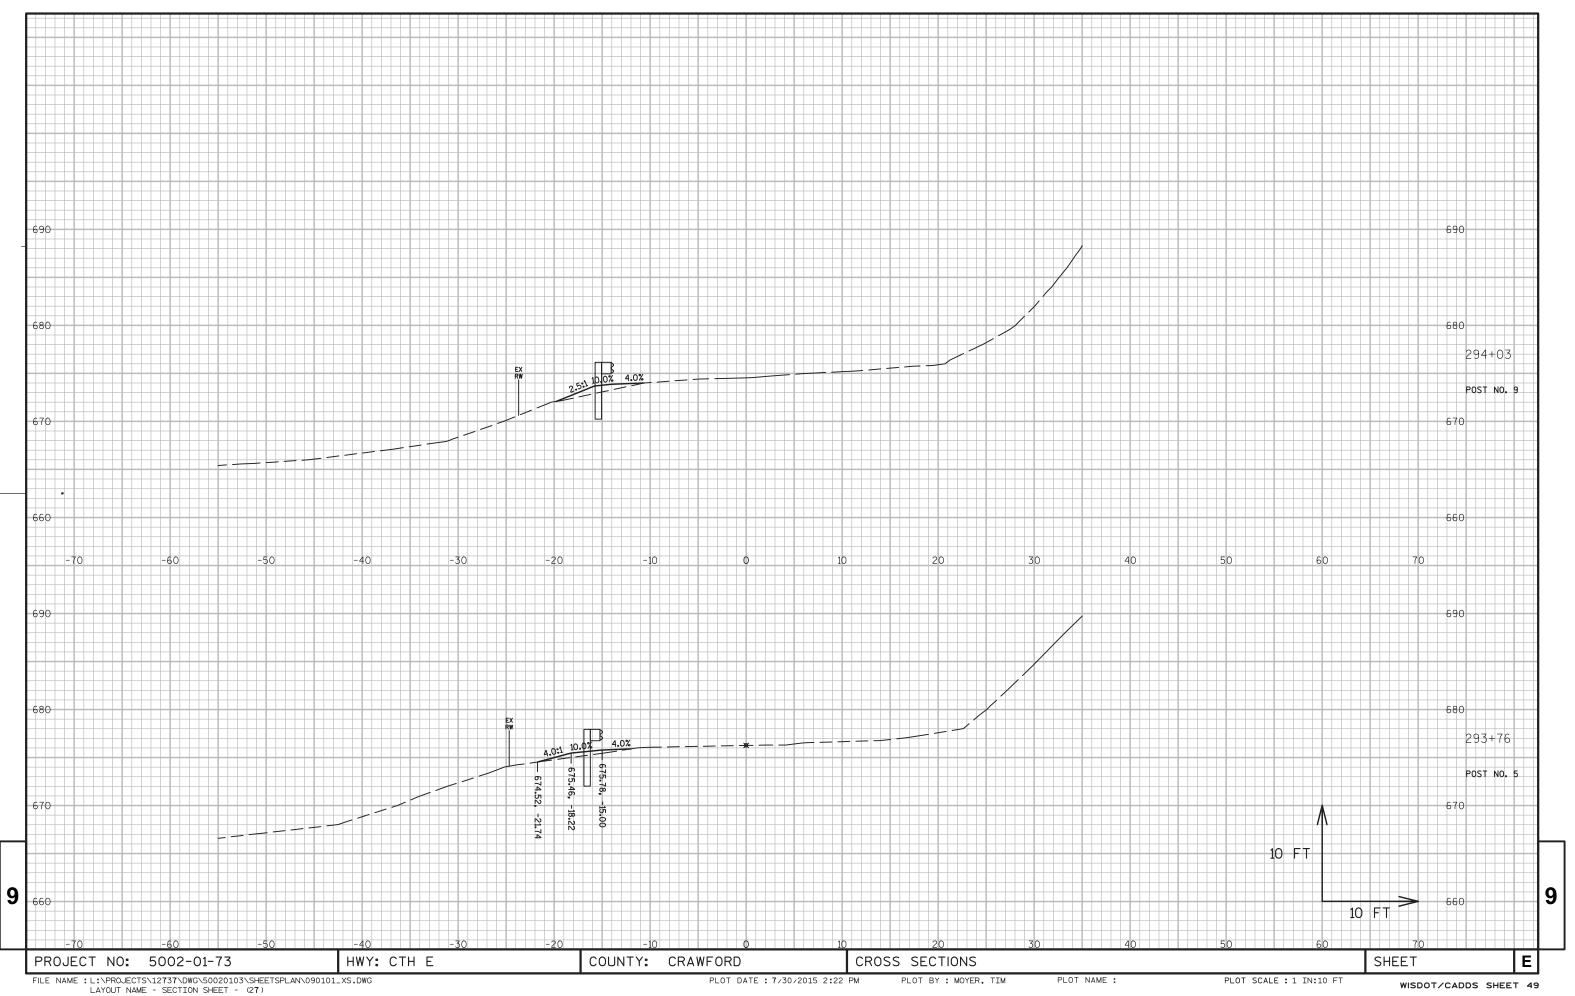

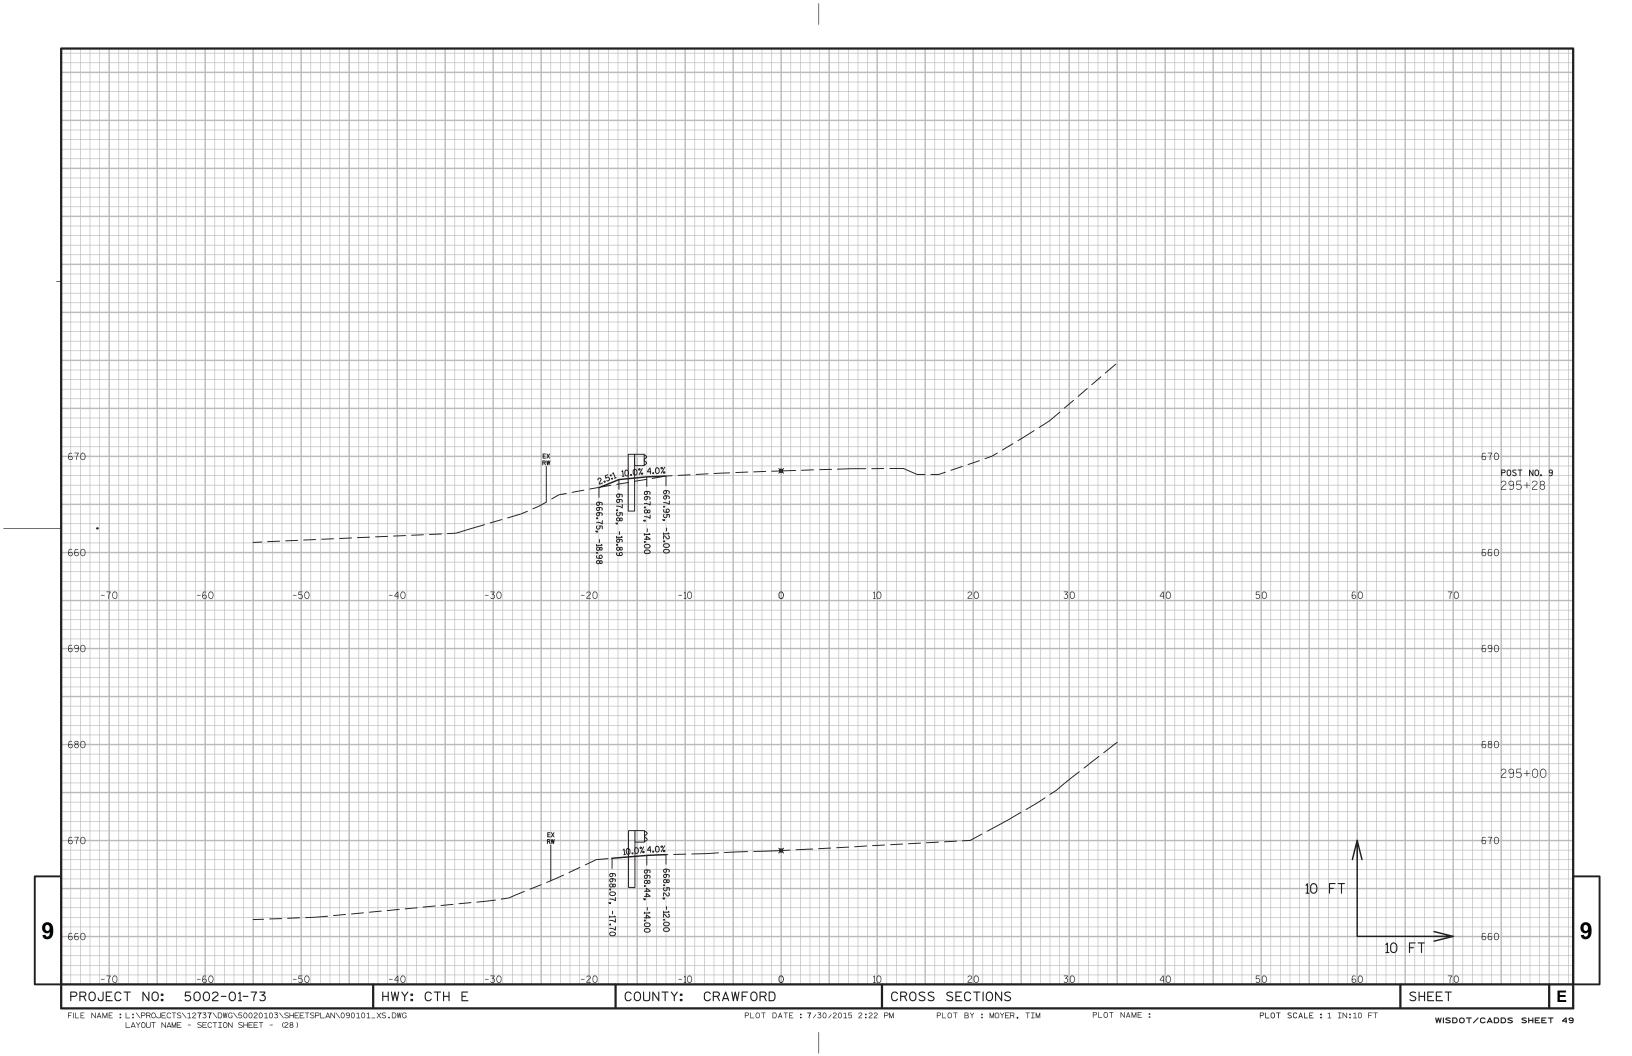

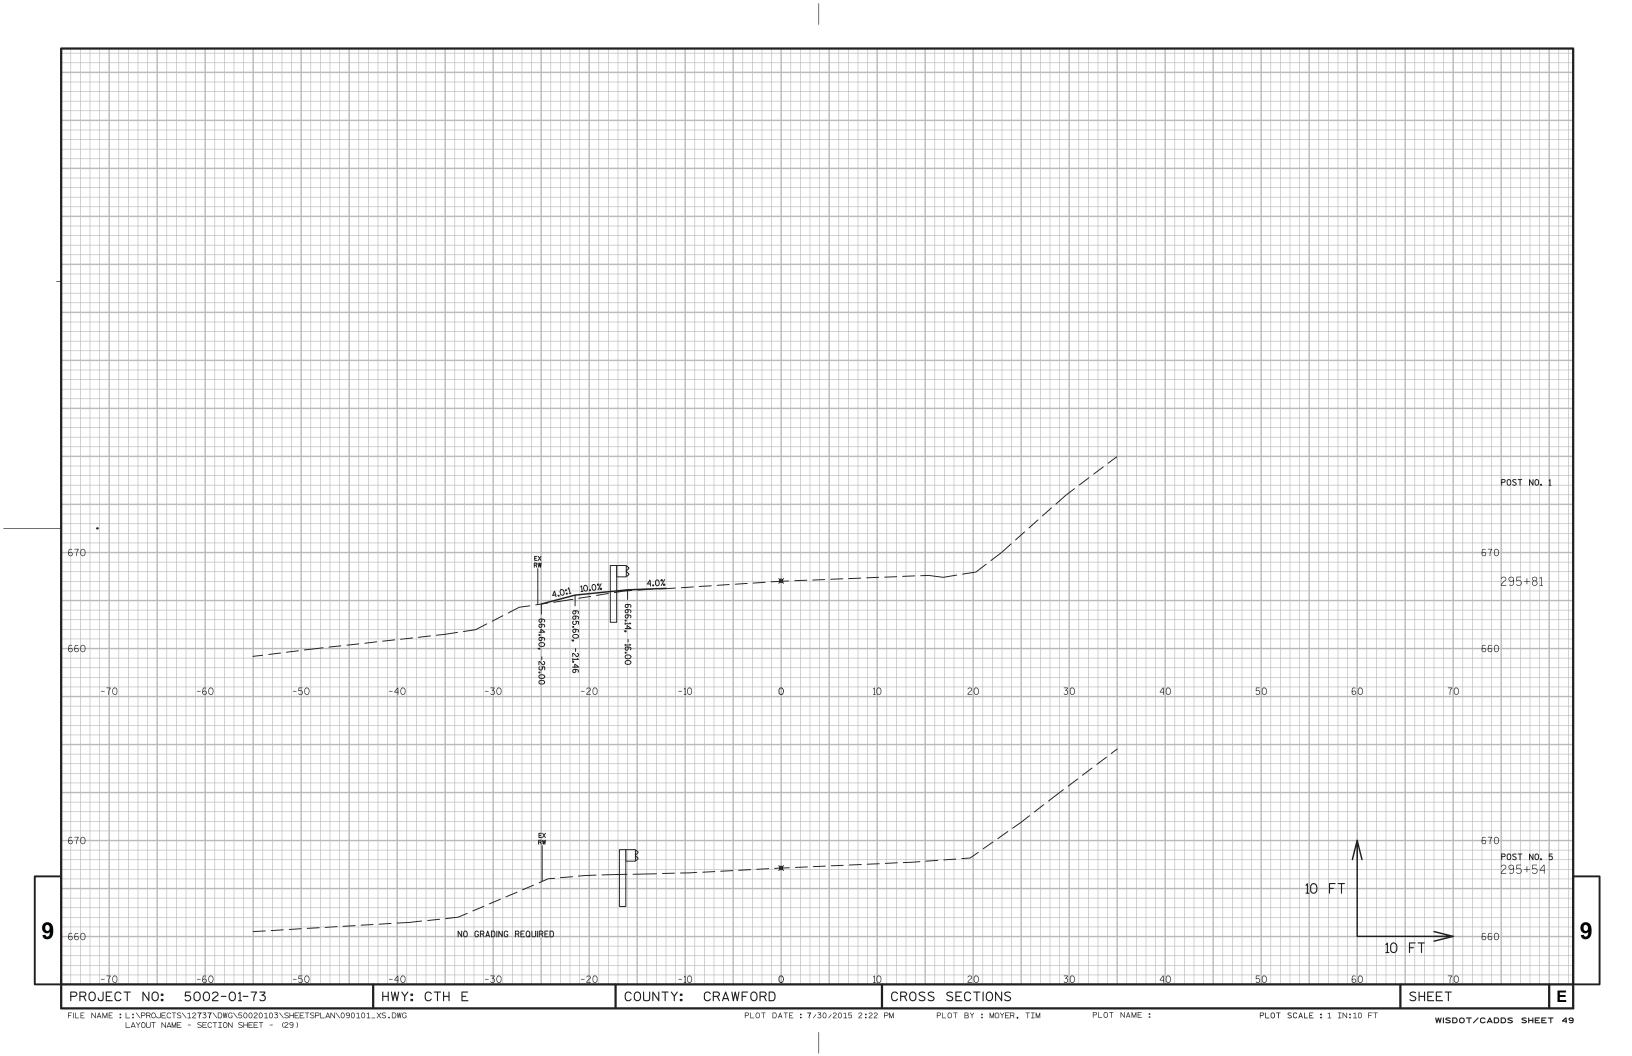

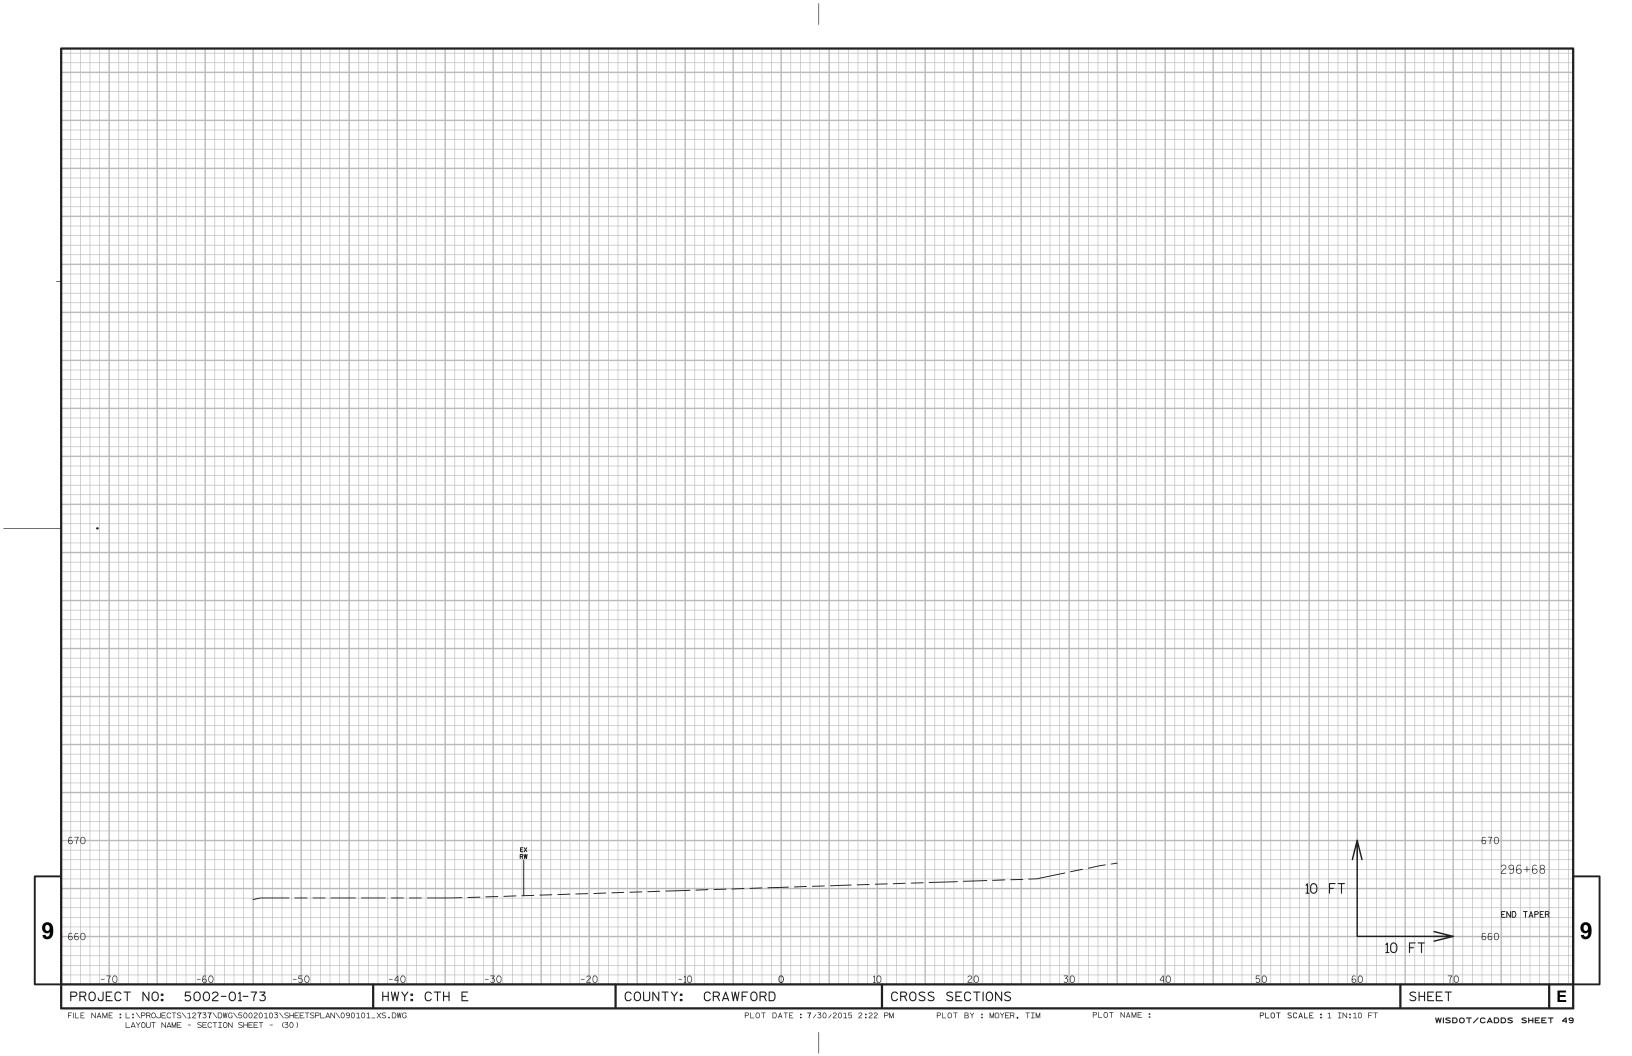

Notes



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