## AUG 2015

## ORDER OF SHEETS

Section No. 1 Title Section No. 2 Typical Sections and Details Estimate of Quantities Miscellaneous Quantities Right of Way Plat

Plan and Profile Section No. 6 Standard Detail Drawings Section No. 7 Sign Plates

Section No. 9 Computer Earthwork Data Section No. 9 Cross Sections

TOTAL SHEETS = 138

# STATE OF WISCONSIN DEPARTMENT OF TRANSPORTATION

PLAN OF PROPOSED IMPROVEMENT


## FEDERAL PROJECT STATE PROJECT PROJECT CONTRACT WISC 2015469 4100-31-71

# E. CHESTNUT STREET, CITY OF CHILTON

S. MADISON STREET - ELM STREET

## **USH 151 CALUMET COUNTY**

STATE PROJECT NUMBER 4100-31-71

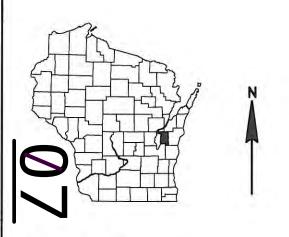

## DESIGN DESIGNATION

A.A.D.T. 2016 = 9,000 A.A.D.T. 2036 = 11,200 D.H.V. = 7.6 = 50/50 = 8.7% DESIGN SPEED = 35 MPH = 3,496,700

## CONVENTIONAL SYMBOLS

PLAN CORPORATE LIMITS PROPERTY LINE LOT LINE LIMITED HIGHWAY EASEMENT EXISTING RIGHT OF WAY PROPOSED OR NEW R/W LINE SLOPE INTERCEPT

REFERENCE LINE EXISTING CULVERT ---PROPOSED CULVERT (Box or Pipe) COMBUSTIBLE FLUIDS

MARSH AREA

WOODED OR SHRUB AREA

PROFILE GRADE LINE ORIGINAL GROUND MARSH OR ROCK PROFILE (To be noted as such) SPECIAL DITCH GRADE ELEVATION CULVERT (Profile View) UTILITIES ELECTRIC FIBER OPTIC

SANITARY SEWER

UTILITY PEDESTAL

TELEPHONE POLE

POWER POLE

STORM SEWER

Ø

BEGIN PROJECT

STA. 211+13.91 Y = 475749.18

X = 891802.80

MAY BANCROFT TRUCKER RD **JUINNEY** QUARRY BROOK COFFEEN RD SHORT LIME KILN JEFFERSON RD DD R-20-E R-19-E LAYOUT HORIZONTAL POSITIONS SHOWN ON THIS PLAN ARE WISCONSIN COUNTY COORDINATES, CALUMET COUNTY, NADB3 (1991), IN U.S. SURVEY SCALE

R-19-F R-20-F

STA. 218+69.96 END CONSTRUCTION STA. 221+20.92

END PROJECT

## ORIGINAL PLANS PREPARED BY



Alfred Benesch & Company 1300 West Canal Street, Suite 150 Milwaukee Wisconsin 53233 414-308-1310 Job No. 20140.00

E-35716

## STATE OF WISCONSIN DEPARTMENT OF TRANSPORTATION

PREPARED BY WISDOT Surveyor ALFRED BENESCH & CO TIM VERHAGEN CHUCK KAROW C.O. Examiner

APPROVED FOR THE DEPARTMENT DATE: 4/27/2015 Vim Verlage

TOTAL NET LENGTH OF CENTERLINE = 0.143

FEET. VALUES ARE GRID COORDINATES, GRID BEARINGS, AND GRID

DISTANCES. GRID DISTANCES MAY BE USED AS GROUND DISTANCES.

## GENERAL NOTES

- 1. NO TREES OR SHRUBS ARE TO BE REMOVED WITHOUT THE APPROVAL OF
- 2. UNLESS NOTED ON THE PLAN, ALL STATIONS AND OFFSETS ARE REFERENCED FROM & USH 151.
- 3. DISTURBED AREAS WITHIN THE RIGHT-OF-WAY SHALL BE FINISHED WITH SOD.
- 4. EROSION CONTROL FEATURES AS SHOWN IN THE PLANS ARE AT SUGGESTED LOCATIONS. EXACT LOCATIONS SHALL BE DETERMINED BY THE ENGINEER IN
- 5. EXISTING DRIVEWAYS BEHIND THE BACK OF WALK SHALL BE RESTORED IN KIND AS DIRECTED BY THE ENGINEER IN THE FIELD AT THE LOCATIONS
- 6. TRAFFIC CONTROL DEVICES SHALL BE ADJUSTED TO FIT FIELD CONDITIONS AS DIRECTED BY THE ENGINEER. NO WORK MAY BEGIN UNTIL PROPER TRAFFIC CONTROL DEVICES ARE PLACED AND APPROVED BY THE ENGINEER.
- 7. A SAWED JOINT IS REQUIRED WHERE NEW PAVEMENT MEETS EXISTING

- 8. ALL ELEVATIONS AND OFFSETS SHOWN IN THE PLAN SHALL BE VERIFIED IN THE FIELD.
- 9. THE LOCATIONS OF EXISTING AND PROPOSED UTILITY INSTALLATIONS AS SHOWN ON THE PLANS ARE APPROXIMATE. THERE MAY BE OTHER UTILITY INSTALLATIONS WITHIN THE PROJECT AREA THAT ARE NOT SHOWN.
- 10. THE CONTRACTOR SHALL NOTIFY DIGGERS HOTLINE AND AFFECTED UTILITIES PRIOR TO THE START OF WORK. ANY LOCAL MUNICIPALITY OR PUBLIC AGENCY WHICH IS NOT A MEMBER OF DIGGERS HOTLINE MUST BE CONTACTED
- 11. EROSION CONTROL MEASURES SHALL BE INSTALLED PRIOR TO THE START OF CONSTRUCTION AND SHALL BE MAINTAINED UNTIL SUCH TIME AS THE ENGINEER DEEMS THE MEASURE NO LONGER NECESSARY.
- 12. CROSS SECTIONS ARE REFERENCED TO THE R USH 151.
- 13. THE LOCATIONS OF EXISTING AND PROPOSED UTILITY FACILITIES (WITH THE EXCEPTION OF SANITARY SEWER AND WATERMAIN) AS SHOWN ON THE PLAN AND CROSS SECTIONS ARE APPROXIMATE AND ARE BASED ON UTILITY LOCATES OBTAINED FROM THE UTILITIES WHEN THE SURVEY DATA WAS COLLETED PRIOR TO THE FINAL DESIGN OF THE PROJECT. IT IS ANTICIPATED THAT UTILITY FACILITIES WILL BE RELOCATED AS PART OF THIS PROJECT AS DESCRIBED IN THE SPECIAL PROVISIONS, LOCATIONS OF THE PROPOSED RELOCATED UTILITY FACILITIES ARE NOT SHOWN ON THE PLAN SHEETS OR CROSS SECTIONS.

## LIST OF STANDARD ABBREVIATIONS

ABUT	ABUTMENT	HYD	HYDRANT INCH DIAMETER INLET INSIDE DIAMETER INVERT IRON PIPE JOINT JUNCTION LEFT LENGTH OF CURVE LEFT-HAND FORWARD LINEAR FOOT LITER LUMP SUM MANHOLE MESSAGE BOARD MAILBOX MATCH LINE NORMAL CROWN NORTH NORTH GRID COORDINATE NORTHBOUND NUMBER OUTSIDE DIAMETER PAVEMENT PERMANENT PERMANENT PERMANENT POINT POLYVINYL CHLORIDE PORTLAND CEMENT CONCRETE	RD	ROAD
AC	ACRE	IN DIA	INCH DIAMETER	RDWY	ROADWAY
AGG	AGGREGATE	INL	INLET	SALV	SALVAGED
AADT	ANNUAL AVERAGE DAILY TRAFFIC	ID	INSIDE DIAMETER	SSS	SANITARY AND STORM SEWER
ASPH	ASPHALT	INV	INVERT	SAN S	SANITARY SEWER
AVG	AVERAGE	IP	IRON PIPE	SEC	SECTION
ADT	AVERAGE DAILY TRAFFIC	JT	JOINT	SHLDR	SHOULDER
BF	BACK FACE	JCT	JUNCTION	SW	SIDEWALK
BL	BASE LINE	LT	LEFT	S	SOUTH
ВМ	BENCH MARK	Ē	LENGTH OF CURVE	SB	SOUTHBOUND
CB	CATCH BASIN	LHF	LEFT-HAND FORWARD	SP	SPECIAL
C/L	CENTERLINE	LF	LINEAR FOOT	SPECS	SPECIFICATIONS
CC	CENTER TO CENTER	Ē.	LITER	SQ	SQUARE
CE	COMMERCIAL ENTRANCE	īs	LUMP SUM	SF	SQUARE FEET
CONC	CONCRETE	MH	MANHOL F	SY	SQUARE YARD
CO	COUNTY	MB	MESSAGE BOARD	STD	STANDARD
CTH	COUNTY TRUNK HIGHWAY	MI B	MAII BOX	SDD	STANDARD DETAIL DRAWINGS
CY	CLIBIC YARD	MI	MATCH LINE	STH	STATE TRUNK HIGHWAYS
ČÚLV	CULVERT	NC.	NORMAL CROWN	STA	STATION
C&G	CURB AND GUTTER	N	NORTH	SS	STORM SEWER
DHV	DESIGN HOUR VOLUME	Ÿ	NORTH GRID COORDINATE	STR	STRUCTURE OR STRUCTURAL
DIA	DIAMETER	NB	NORTHBOLIND	SL	SURVEY LINE
DD	DIRECTIONAL DISTRIBUTION	NO	NUMBER	TEL	TELEPHONE
F	FAST	OD	OUTSIDE DIAMETER	TEMP	TEMPORARY
E X	FAST GRID COORDINATE	PAVT	PAVEMENT	TLE	TEMPORARY LIMITED EASEMENT
ËВ	FASTROUND	PFRM	PERMANENT	Ť	TON
ELEC	FI FCTRIC	PLF	PERMANENT LIMITED FASEMENT	тс	TOP OF CURB
ELEV	FLEVATION	PT	POINT	Ť	TRUCKS (PERCENT OF)
ESALS	FOUIVALENT SINGLE AXLE LOADS	PVC	POLYVINYI CHI ORIDE	ŤΥΡ	TYPICAL
EXC	FXCAVATION	PCC	PORTLAND CEMENT CONCRETE	ÜĞ	UNDERGROUND
EBS	EXCAVATION BELOW SUBGRADE	PF	PRIVATE ENTRANCE	ÜSH	UNITED STATES HIGHWAY
EXIST	EXISTING	PROJ	PROJECT	VAR	VARIABLE
FF	FACE TO FACE	PL	PROPERTY LINE	VERT	VERTICAL
FE	FIFLD ENTRANCE	R	PORTAIND CEMENT CONCRETE PRIVATE ENTRANCE PROJECT PROPERTY LINE RADIUS REFERENCE LINE	w	WATER
FG	FINISHED GRADE	R/I	REFERENCE LINE	WM	WATER MAIN
FL	FLOW LINE	RCCP	REINFORCED CONCRETE CULVERT PIPE	WV	WATER VALVE
FT	FOOT	REOD	REQUIRED	w	WEST
FTMS	ABUTMENT ACRE AGGREGATE ANNUAL AVERAGE DAILY TRAFFIC ASPHALT AVERAGE AVERAGE DAILY TRAFFIC BACK FACE BASE LINE BENCH MARK CATCH BASIN CENTERLINE CENTER TO CENTER COMMERCIAL ENTRANCE CONCRETE COUNTY TRUNK HIGHWAY CUBIC YARD CULVERT CURB AND GUTTER DESIGN HOUR VOLUME DIAMETER DIRECTIONAL DISTRIBUTION EAST EAST GRID COORDINATE EASTBOUND ELECTRIC ELEVATION EXCAVATION BELOW SUBGRADE EXISTING FACE TO FACE FIELD ENTRANCE FINISHED GRADE FLOW LINE FOOT FREEWAY TRAFFIC MANAGEMENT SYSTEM HIGH EARLY STRENGTH	RT	RIGHT	₩В	WESTBOUND
HES	HIGH EARLY STRENGTH	RHF	RIGHT HAND FORWARD	ŸĎ	YARD
CWT	HUNDREDWEIGHT	R/W	RIGHT-OF-WAY		
	··=·=·				

ORDER OF SECTION 2 SHEETS

GENERAL NOTES PROJECT OVERVIEW TYPICAL SECTIONS CONSTRUCTION DETAILS PLAN DETAILS PAVEMENT GRADES EROSION CONTROL STORM SEWER PERMANENT SIGNING PAVEMENT MARKING TRAFFIC CONTROL DETOUR PLAN ALIGNMENT PLAN

## UTILITY CONTACTS

## CHARTER COMMUNICATIONS (COMMUNICATION LINE)

3315 LINCOLN AVE TWO RIVERS, WI 54241 MR. NICK FRASE (920) 793-2216 nicholas.frase@chartercom.com

## CHILTON LAKE DISTRICT - WATER

42 SCHOOL STREET CHILTON, WI 53014 MR. TODD SCHWARZ (920) 849-2451 EXT, 320

#### FRONTIER NORTH, INC (COMMUNICATION LINE)

100 COMMUNICATIONS DRIVE SUN PRAIRIE, WI 53590 MR. RYAN OSNESS (608) 837-1881 ryan.d.osness@ftr.com

## WISCONSIN PUBLIC SERVICE CORPORATION (GAS/PETROLEUM)

933 S WILDWOOD AVE SHEBOYGAN, WI 53081 MR. MIKE LOWTHER (920) 451-3743 (920) 946-3198 (MOBILE) mllowther@wisconsinpublicservice.com

## WISCONSIN PUBLIC SERVICE CORPORATION (ELECTRICITY)

P.O. BOX 236 TWO RIVERS, WI 54241 MR. JEFF PELISCHEK (920) 657-1816 (920) 323-4836 (MOBILE) jpelischek@wisconsinpublicservice.com

## CHILTON LAKE DISTRICT - SANITARY

42 SCHOOL STREET CHILTON, WI 53014 MR. TODD SCHWARZ (920) 849-2451 EXT. 320 chiltondpw@chiltonwi.com

#### OTHER AGENCIES

#### DNR

DESIGN

DNR NORTHEAST REGION 2984 SHAWANO AVE GREEN BAY, WI 54313 MR. MATTHEW SCHAEVE (920) 662-5472 matthew.schaeve@wisconsin.gov

ALFRED BENESCH & COMPANY 1300 W CANAL ST, SUITE 150 MILWAUKEE, WI 53233 MS. AMANDA ZACHARIAS (414) 308-1320 azacharlas@benesch.com

CITY OF CHILTON

42 SCHOOL ST CHILTON, WI 53014 MR. TODD SCHWARZ (920) 849-2451 EXT. 320 chiltondpw@chiltonwi.com

## WISDOT

WISCONSIN DOT, NORTHEAST REGION 944 VANDERPERRE WAY GREEN BAY, WI 54324 MR. TIM VERHAGEN (920) 492-4116 timothy.verhagen@dot.wi.gov



PROJECT NO: 4100-31-71

HWY: USH 151

COUNTY: CALUMET

GENERAL NOTES

PLOT BY : WATT, TIMOTHY

PLOT NAME :

SHEET

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FILE NAME : Y:\MTLWAUKEE\20100S\20140.00\41003100\SHEETSPLAN\020201\_P0.DWG

PLOT DATE : 4/22/2015 9:59 AM


PLOT BY: WATT, TIMOTHY

PLOT NAME :


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WISDOT/CADDS SHEET 42



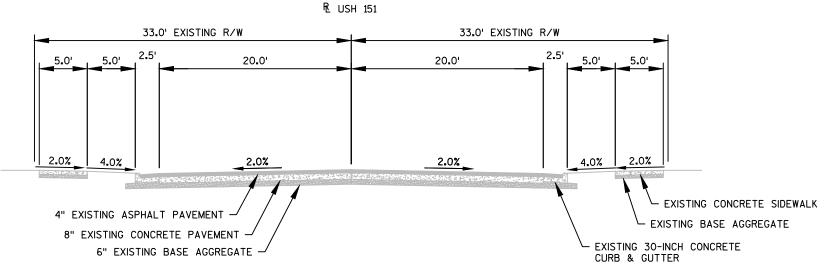

TYPICAL EXISTING SECTION
USH 151
STA 211+13.91 TO STA 218+69.96

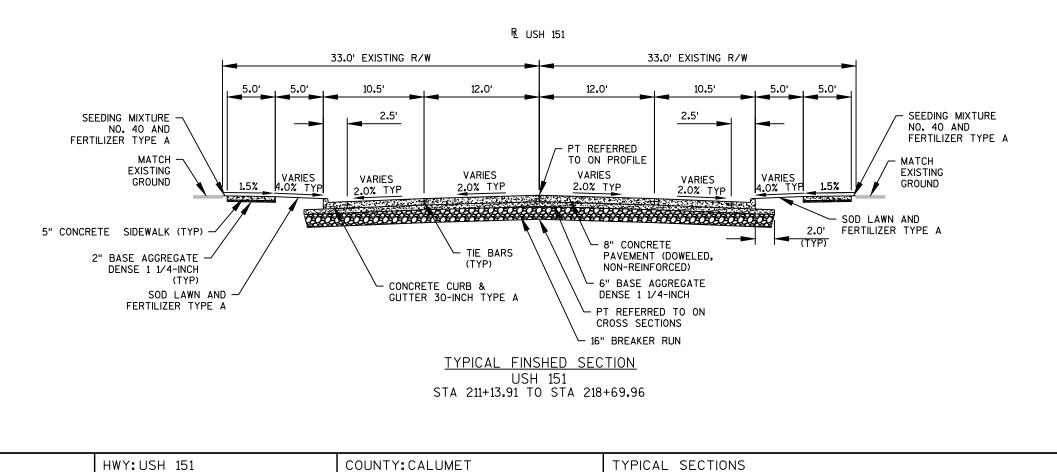

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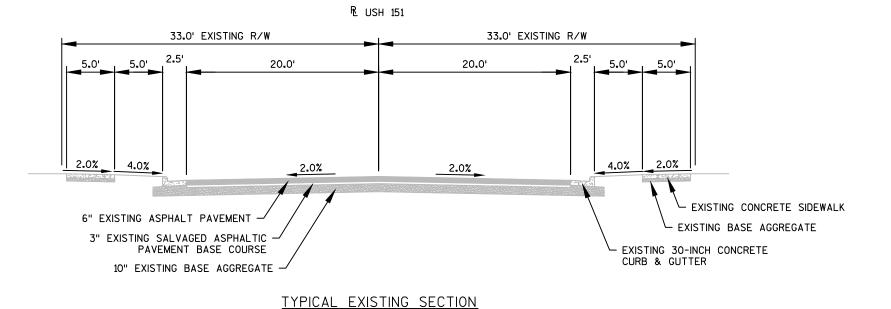
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PLOT BY : WATT, TIMOTHY

PLOT NAME: \_\_\_\_\_PLOT SCALE: 1 IN:10 FT

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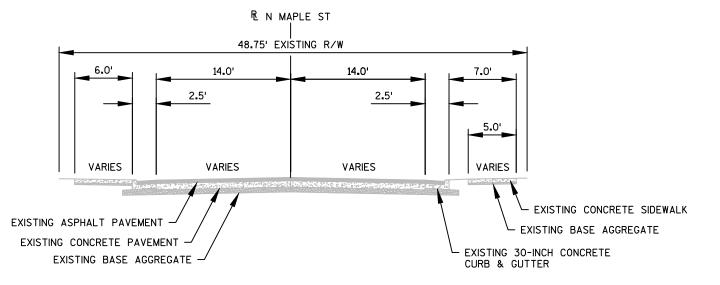
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PROJECT NO:4100-31-71 HWY:USH 151 COUNTY:CALUMET TYPICAL SECTIONS SHEET \_\_\_\_ E


USH 151 STA 218+69.96 TO STA 221+20.92





TYPICAL EXISTING SECTION

N MAPLE ST
STA 10+24.01 TO STA 10+49.28

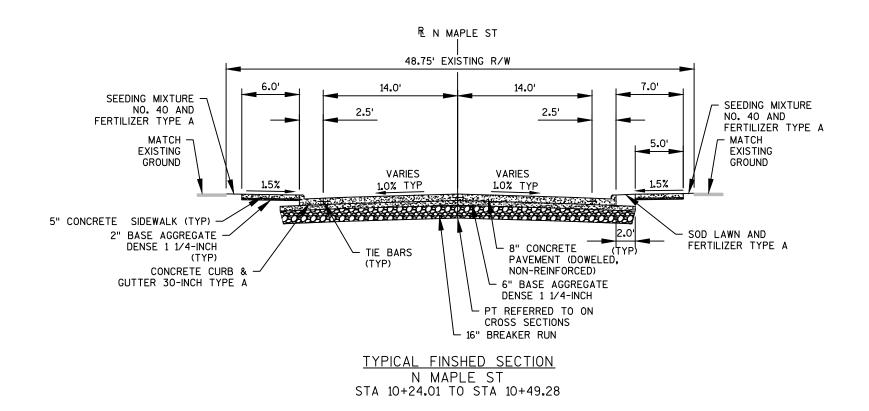

FILE NAME : Y:\MILWAUKEE\20100S\20140.00\41003100\SHEETSPLAN\020301\_TS.DWG

HWY: USH 151

PROJECT NO: 4100-31-71

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COUNTY: CALUMET


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TYPICAL SECTIONS

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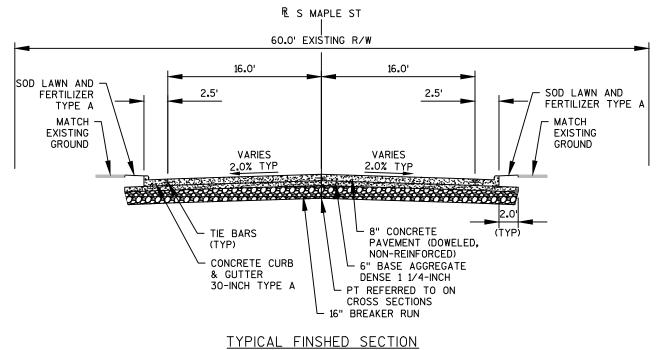
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TYPICAL EXISTING SECTION

S MAPLE ST
STA 15+20.00 TO STA 15+47.97



S MAPLE ST STA 15+20.00 TO STA 15+47.97

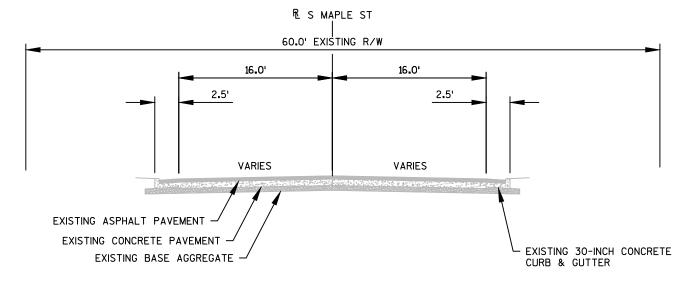COUNTY: CALUMET T

TYPICAL SECTIONS


AM PLOT BY: WATT, TIMOTHY

PLOT NAME: \_\_\_\_\_PLOT SCALE: 1 IN:10 FT

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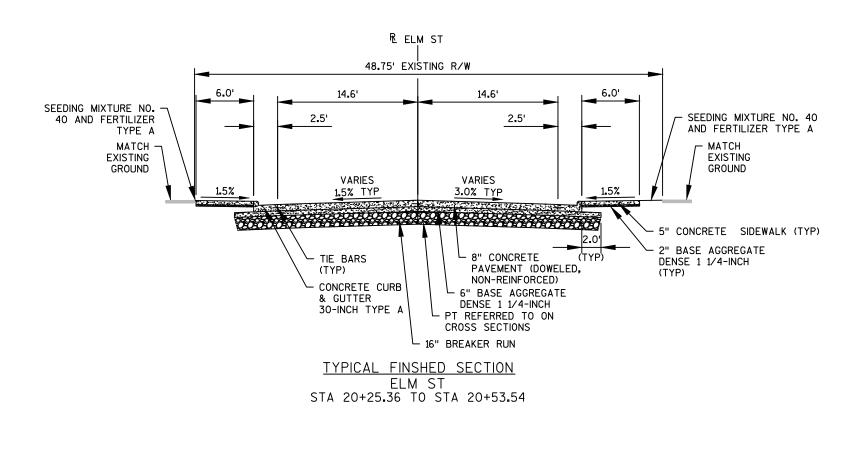
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TYPICAL EXISTING SECTION

ELM ST
STA 20+25.36 TO STA 20+53.54

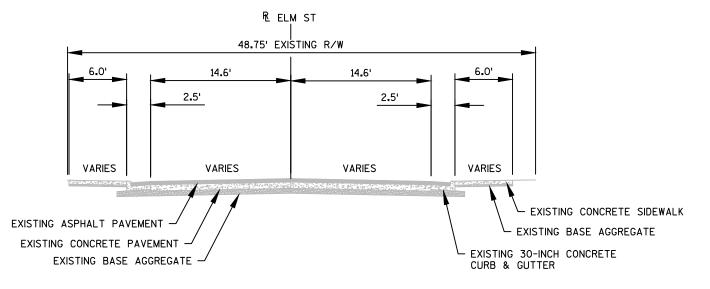

FILE NAME : Y:\MILWAUKEE\20100S\20140.00\41003100\SHEETSPLAN\020301\_TS.DWG

HWY: XXXX

PROJECT NO:XXXX-XX-XX

PLOT DATE: 4/22/2015 9:59 AM

COUNTY: XXXX

PLOT BY: WATT, TIMOTHY

PLAN: TYPICAL SECTION

PLOT NAME : \_\_\_\_\_PLOT SCALE : 1 IN:10 FT

WISDOT/CADDS SHEET 42


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SHEET

----- PLOT SCALE : 1 IN:10 FT WISDOT





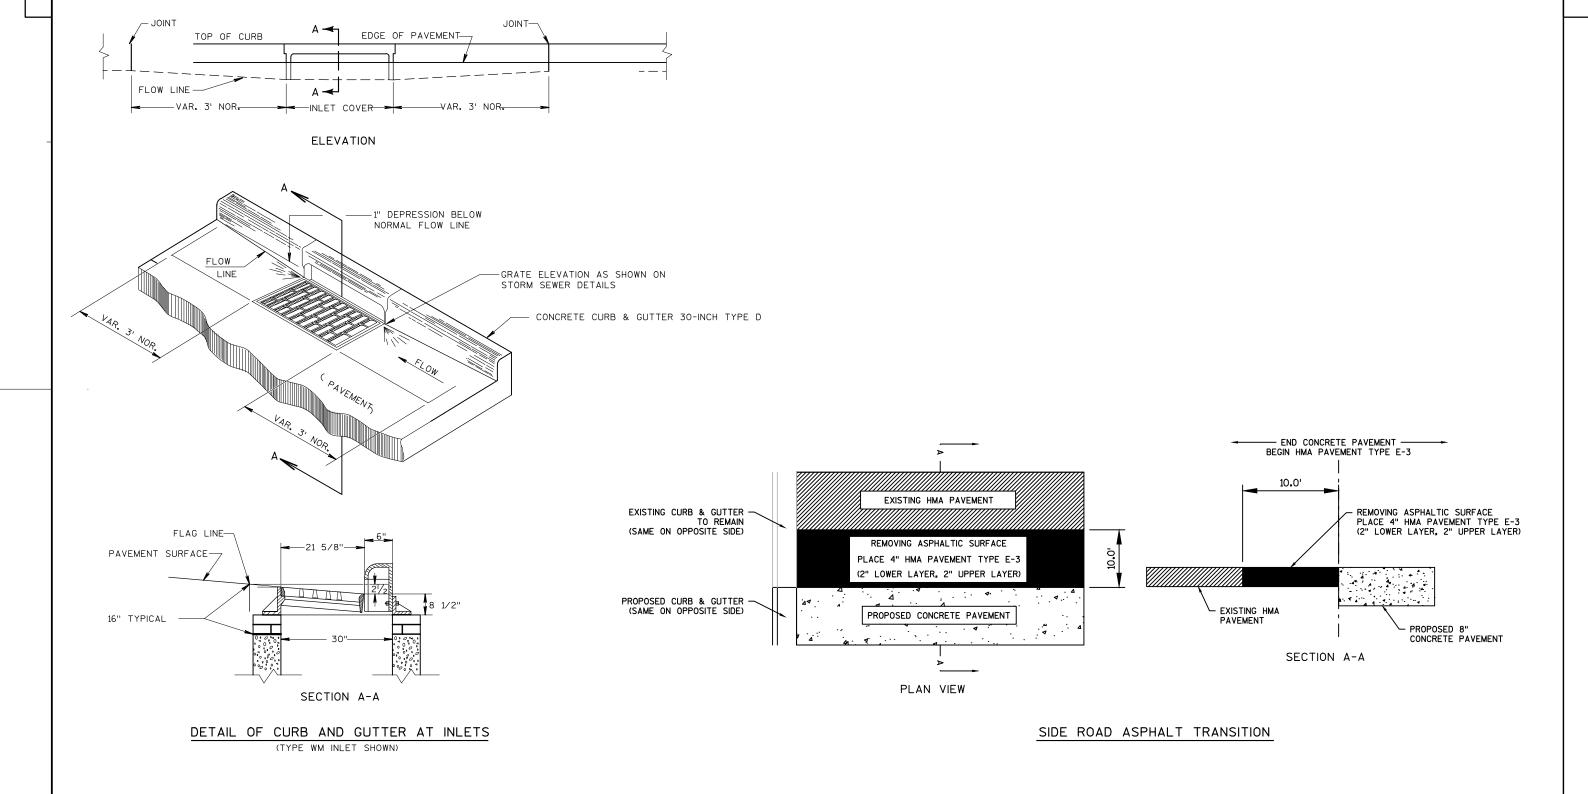

HWY: USH 151


PROJECT NO: 4100-31-71

COUNTY: CALUMET

CONSTRUCTION DETAILS

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## DRIVEWAY ENTRANCE DETAIL WITH SIDEWALK, CURB & GUTTER

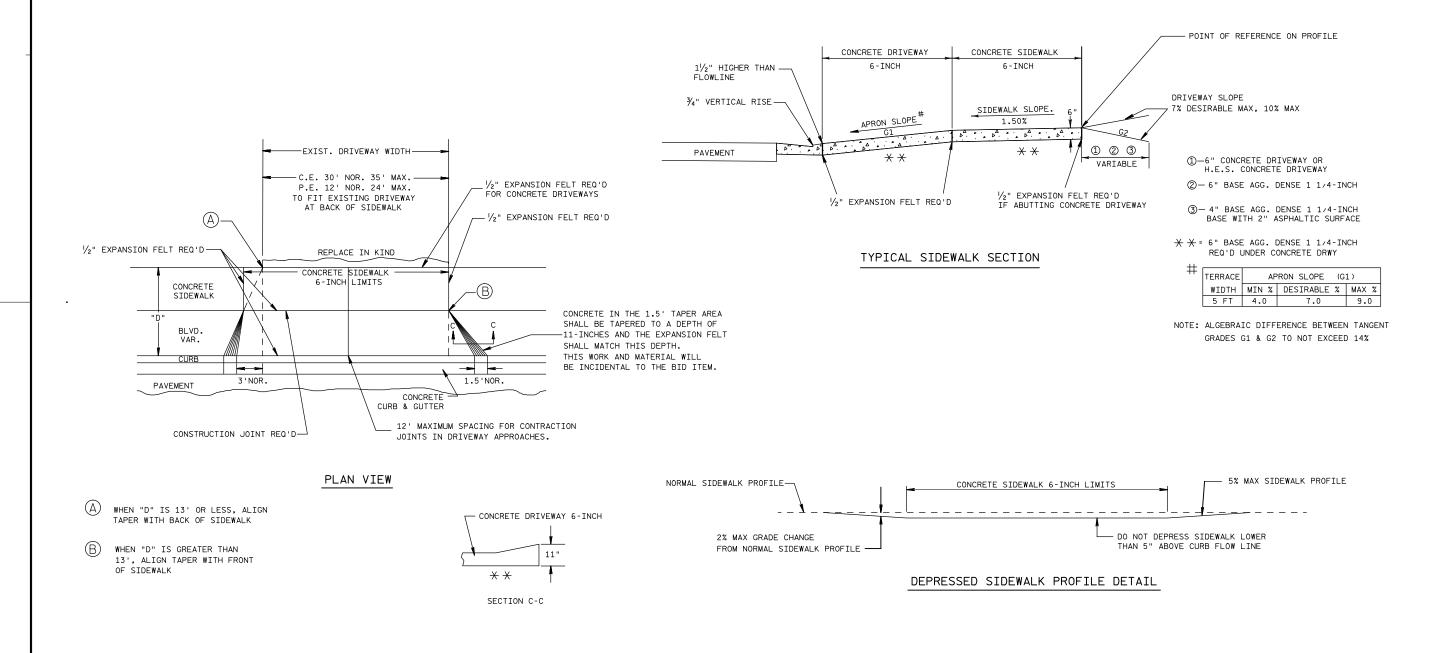

HWY: USH 151

PROJECT NO: 4100-31-71


COUNTY: CALUMET

CONSTRUCTION DETAILS

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FILE NAME : Y:\MILWAUKEE\20100S\20140.00\41003100\SHEETSPLAN\021001\_CD.DWG

HWY: USH 151

PROJECT NO: 4100-31-71

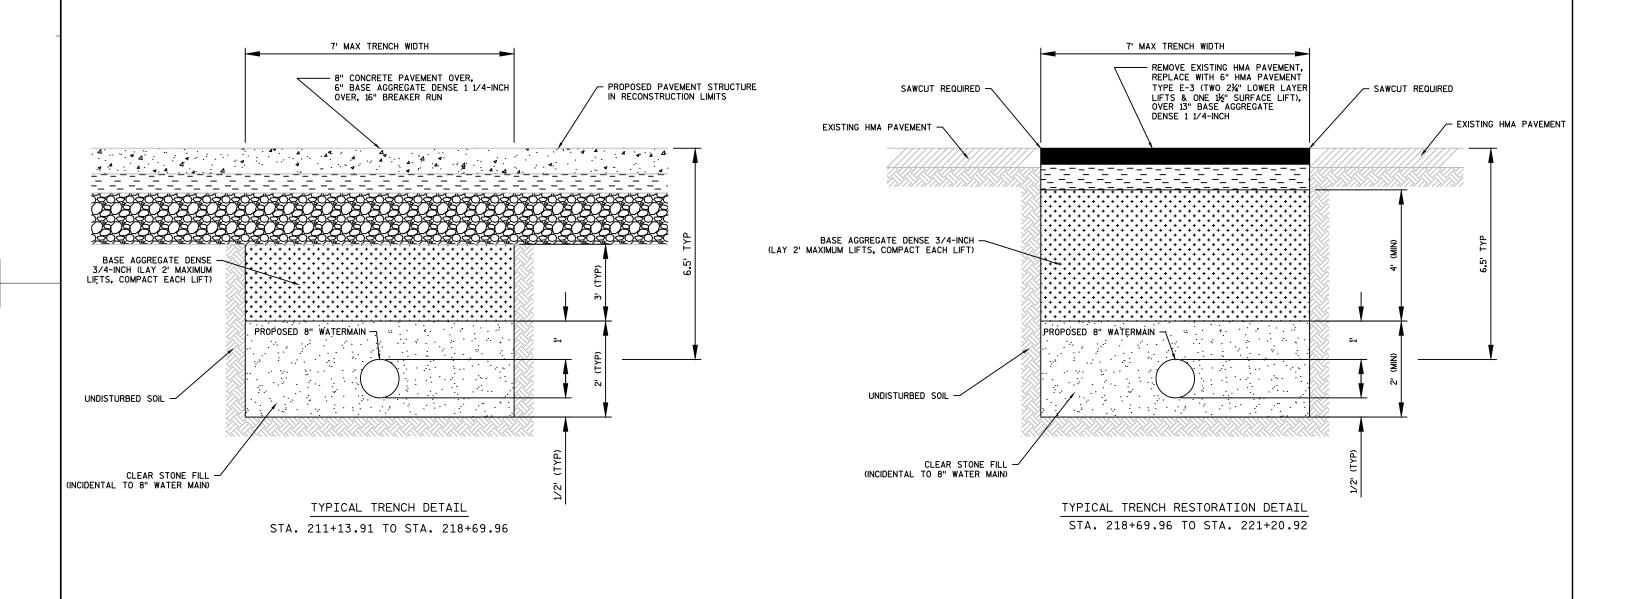PLOT DATE : 4/22/2015 9:59 AM

COUNTY: CALUMET


PLOT BY : WATT, TIMOTHY

CONSTRUCTION DETAILS


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## TYPICAL WATER SERVICE CONNECTION DETAIL



FILE NAME : Y:\MILWAUKEE\20100S\20140.00\41003100\SHEETSPLAN\021001\_CD.DWG

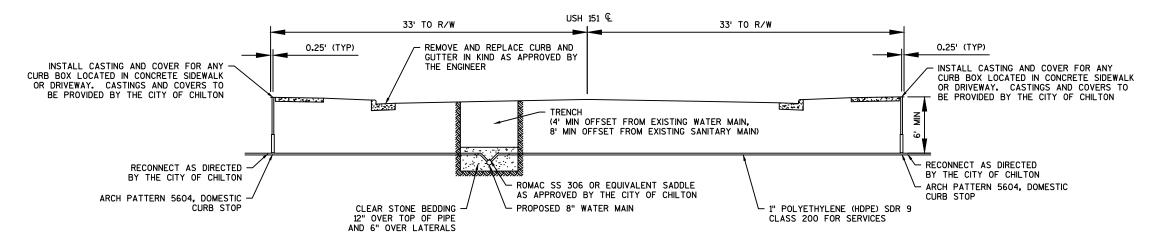
HWY: USH 151

PROJECT NO: 4100-31-71

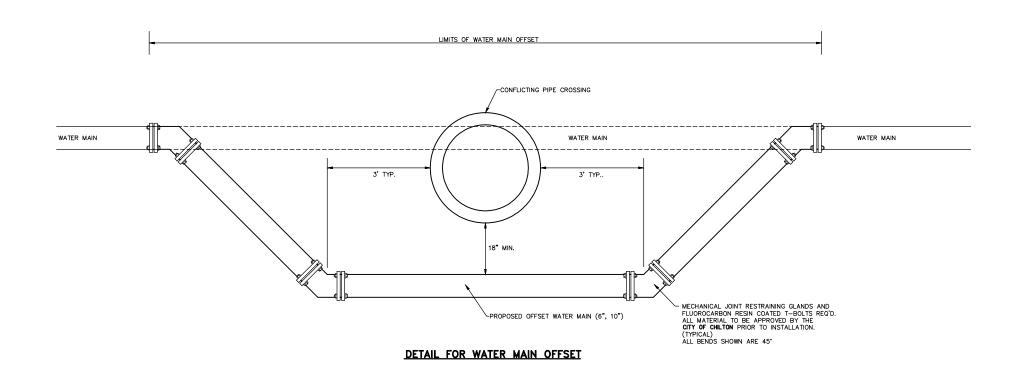COUNTY: CALUMET


CONSTRUCTION DETAILS

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5. ALL IRON PIPE AND FITTINGS SHALL BE WRAPPED IN POLYETHYLENE.

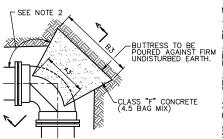




		BUTTR	ESS DI	MENSIO	NS	
PIPE		BENDS	45° E	ENDS	90° BENDS	
SIZE	B1	D1	B2	D2	В3	D3
6"	1'-0"	1'-0"	1'-0"	1'-0"	1'-4"	1'-2"
8"	1'-0"	1'-0"	1'-4"	1'-2"	1'-10"	1'-6"
12"	1'-4"	1'-4"	1'-10"	1'-10"	2'-0"	2'-3"
16"	1'-10"	1'-8"	2'-6"	2'-4"	3'-10"	2'-10"
20"	2'-4"	2'-0"	3'-3"	2'-10"	3'-0"	3'-4"
24"	2'-10"	2'-4"	4'-0"	3'-3"	6'-4"	3'-10"
30"	3'-6"	3'-0"	5'-4"	3'-10"	8'-0"	4'-8"

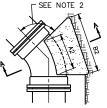PLAN - 45° BEND




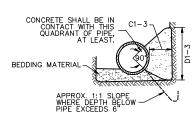

PLAN - 22-1/2° BEND SECTION A-A **BLOCKING FOR BENDS** 

GRADE BONNET TO REST ON CONCRETE BLOCKS CONCRETE BLOCK

SIDE VIEW FRONT VIEW STANDARD VALVE & VALVE BOX SETTING

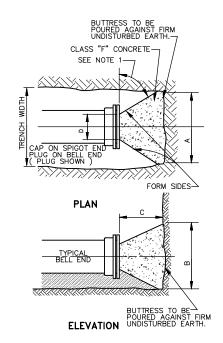


BUTTRESS DIMENSIONS					
DIA.	Α	В	С	D	
6"	1'-6"	1'-2"			
8"	2'-0"	1'-4"	SEE	SEE	
12"	2'-5"	1'-10"	NOTE	NOTE	
16"	3'-4"	2'-4"	2	3	
20"	4'-3"	2'-10"			
24"	5'-2"	3'-4"			
30"	6'-9"	4'-0"			

#### NOTES:


2. DIMENSION C SHOULD BE LARGE ENOUGH TO MAKE ANGLE EQUAL TO OR LARGER THAN 45.

5. ALL IRON PIPE AND FITTINGS SHALL BE WRAPPED IN POLYETHYLENE.

## **BLOCKING FOR PLUGS**

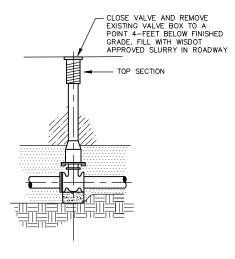

VALVE ABANDONMENT DETAIL

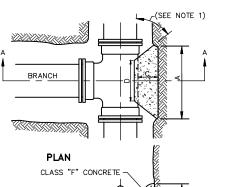

BEDDING MATERIAL


SECTION A-A

BUTTRESS DIMENSIONS						
B.D.	Α	В	С	D		
6"	1'-3"	1'-0"				
8"	1'-6"	1'-4"	SEE	CEE.		
12"	2'-3"	2'-0"	NOTE	SEE NOTE		
16"	3'-2"	2'-6"	1	2		
20"	4'-0"	3'-0"				
24"	5'-3"	3'-4"	Ī			
30"	6'-6"	4'-3"				
B.D. = BRANCH DIAMETER						

5. ALL IRON PIPE AND FITTINGS SHALL BE WRAPPED IN POLYETHYLENE.

## **BLOCKING FOR TEES**

Fitting Type/Nominal Size	6"	8"	12	16
11 1/4° Bend	2	2	3	3
22 1/2' Bend	3	3	5	6
45' Bend	5	6	9	11
90° Bend	11	15	21	27
Dead End	30	40	56	73
Top Side of a Vertical Offset	13	17	24	31
Tee Run x Branch 6"BY	14			
Tee Run x Branch 8"B"	10	24		
Tee Run x Branch 12"BY	1	15	40	1
Tee Run x Branch 16*BY	1	7	33	56

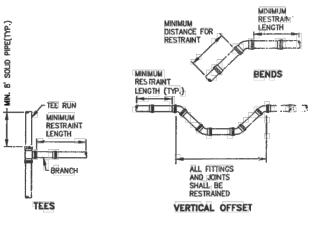

- USE EBBA 1100 HD\_SPLIT\_HARNESS ON EXISTING PUSH-ON PIPE BELLS: - USE EBBA 1100 MEGALUGS ON NEW MECHANICAL JOINTS!


WATER MAIN RESTRAINT DETAIL


PROJECT NO: 4100-31-71 HWY: USH 151


COUNTY: CALUMET


CONSTRUCTION DETAILS PLOT BY: WATT, TIMOTHY


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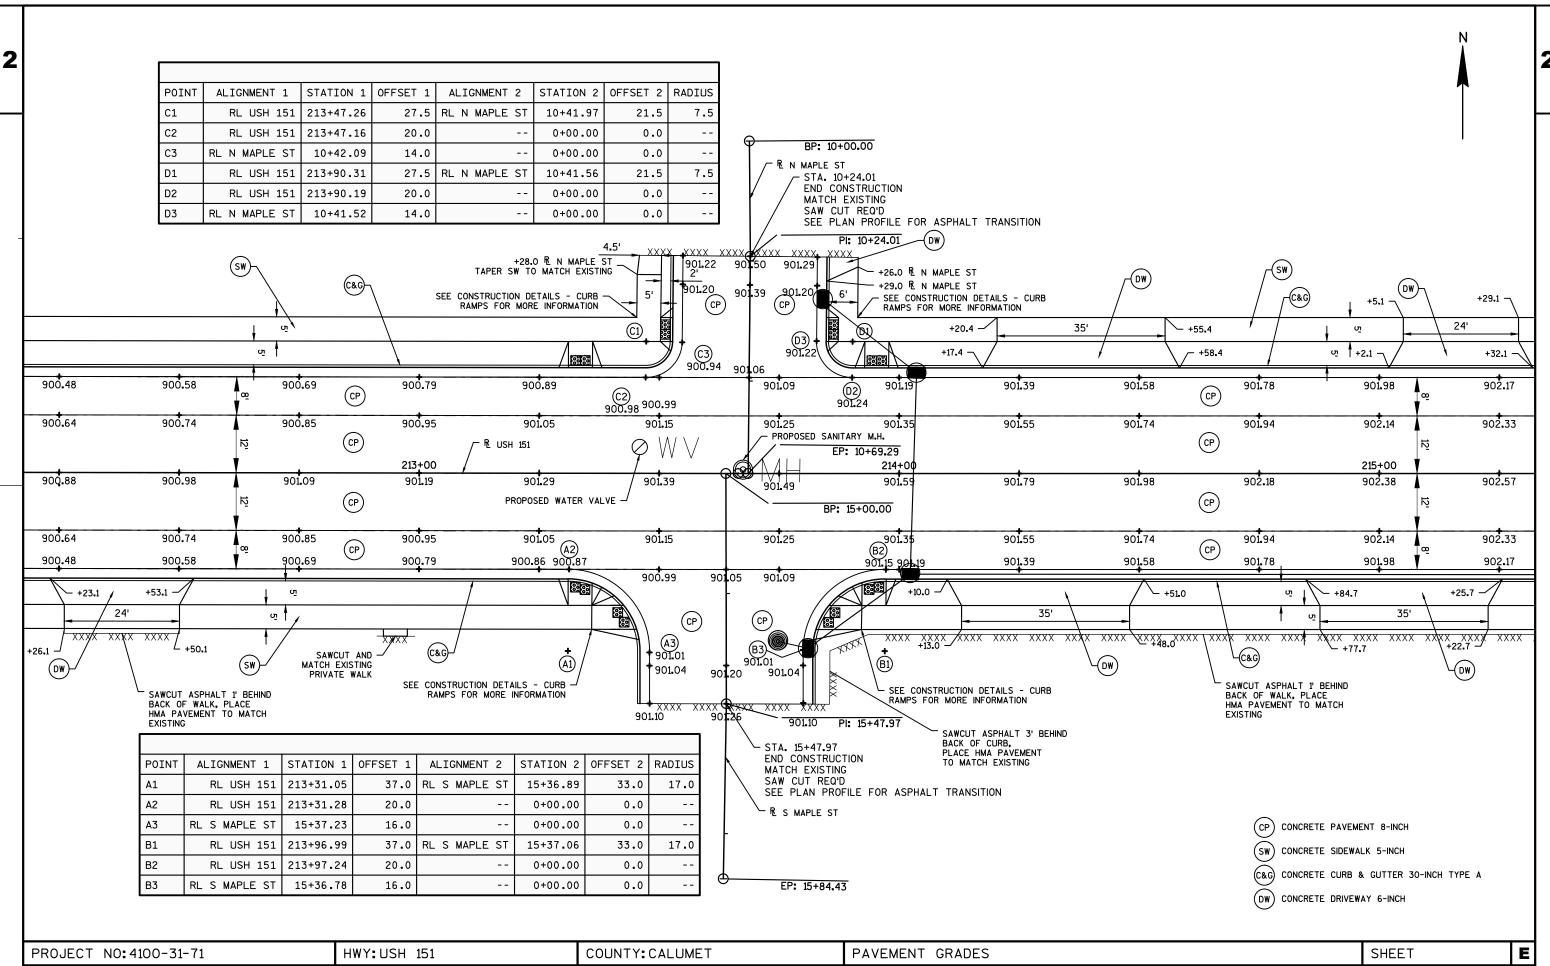


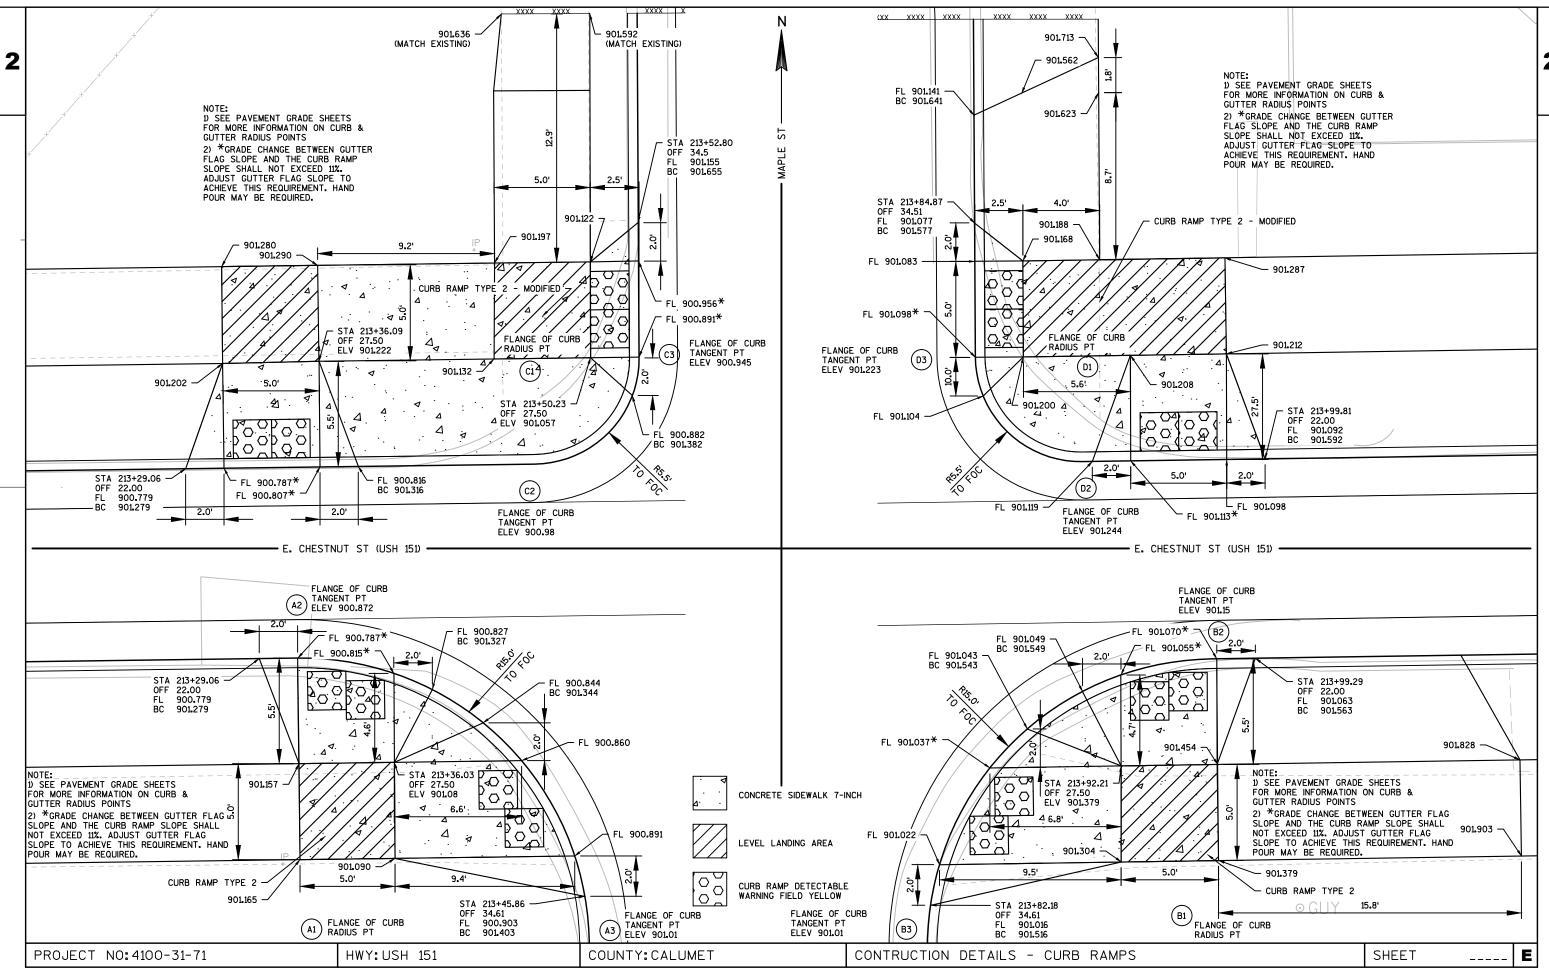


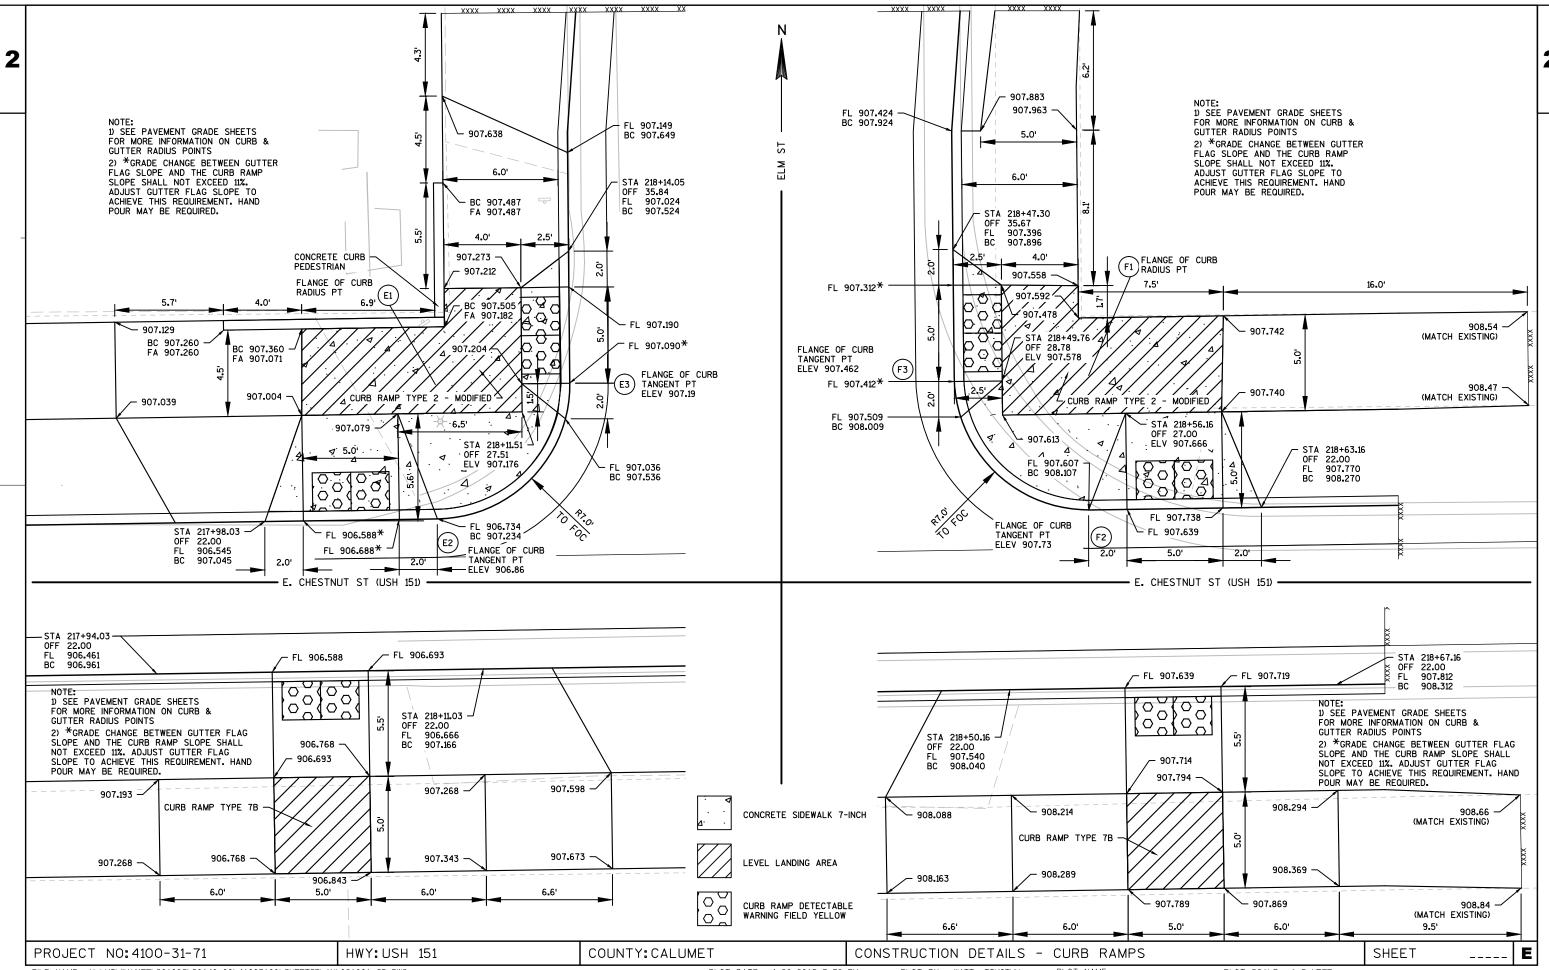


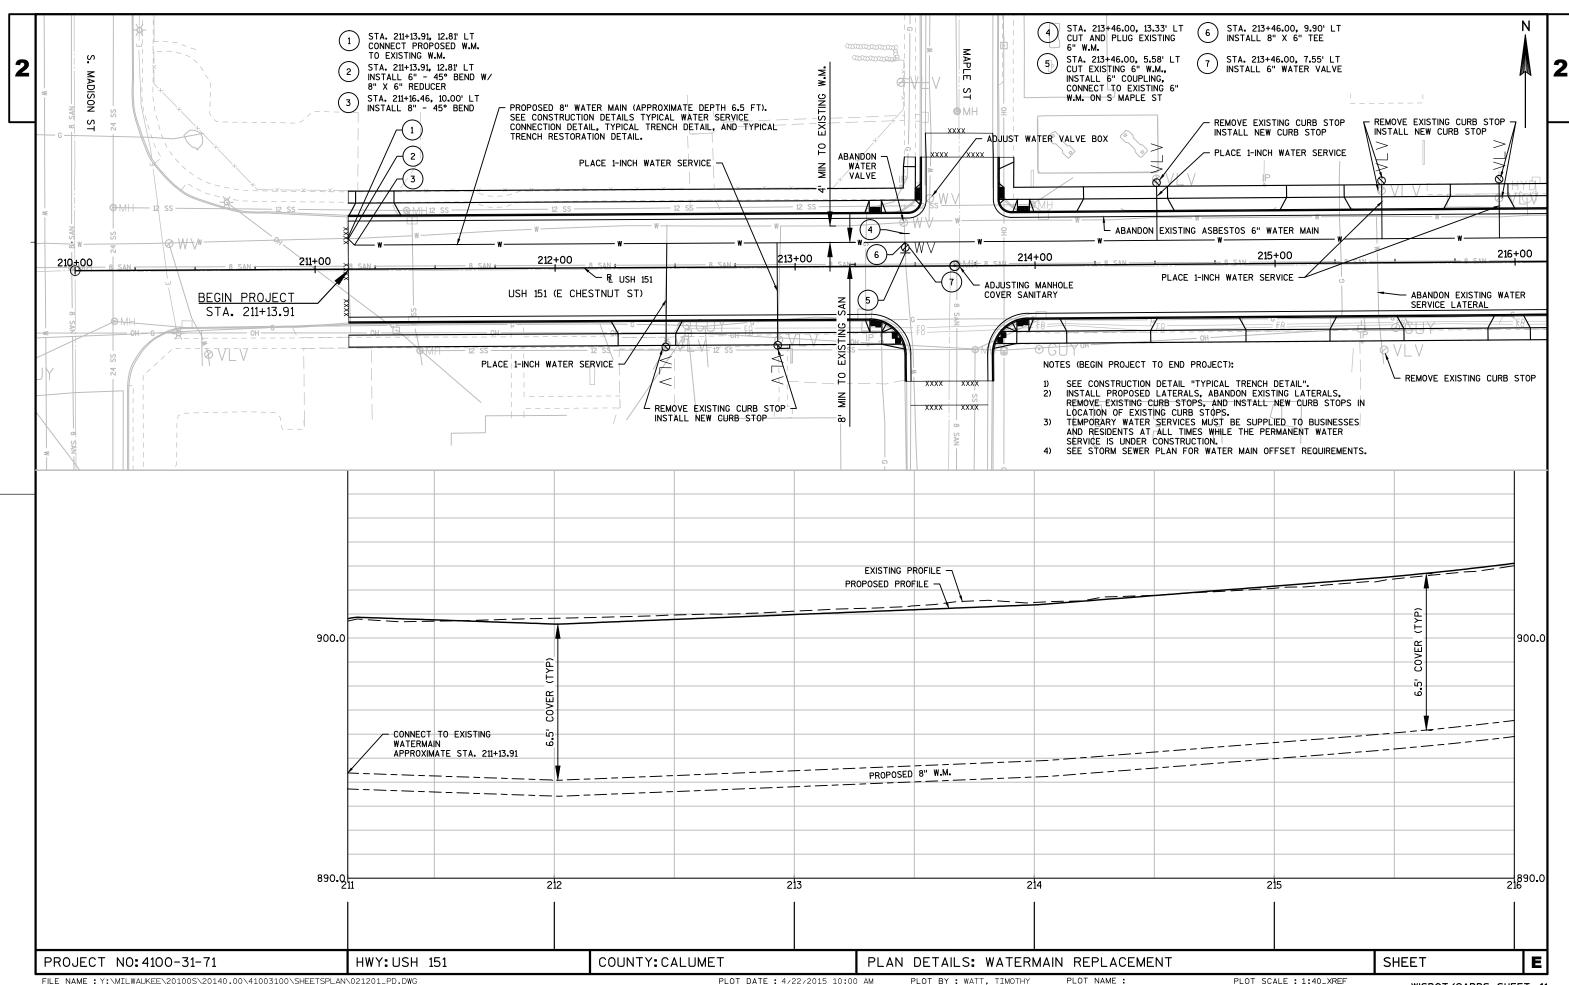


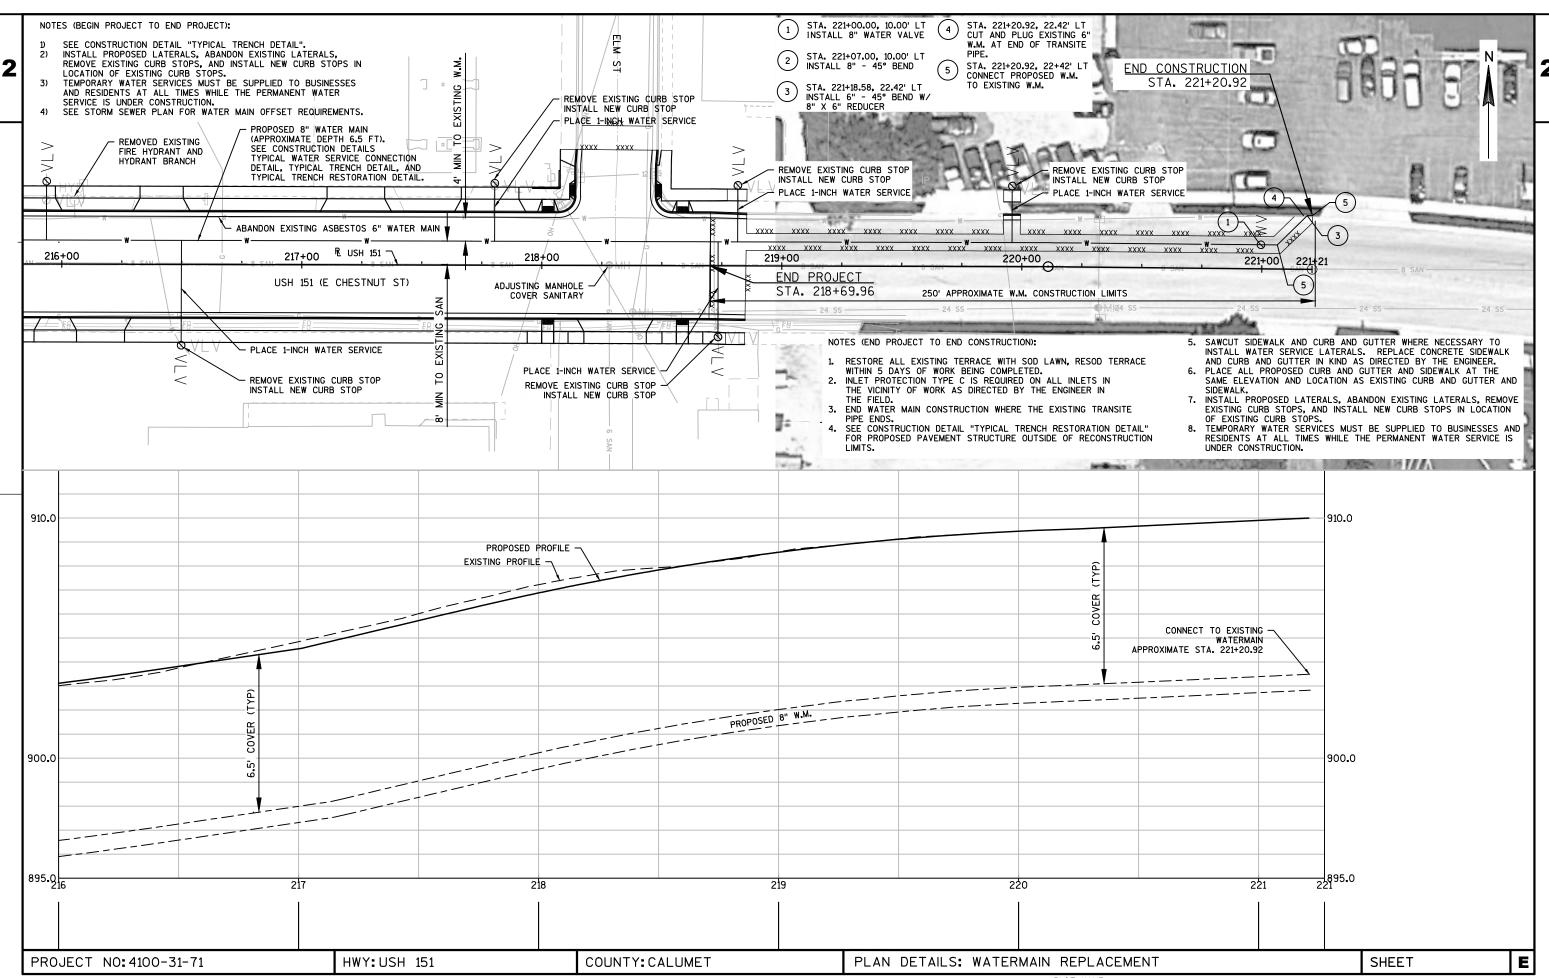


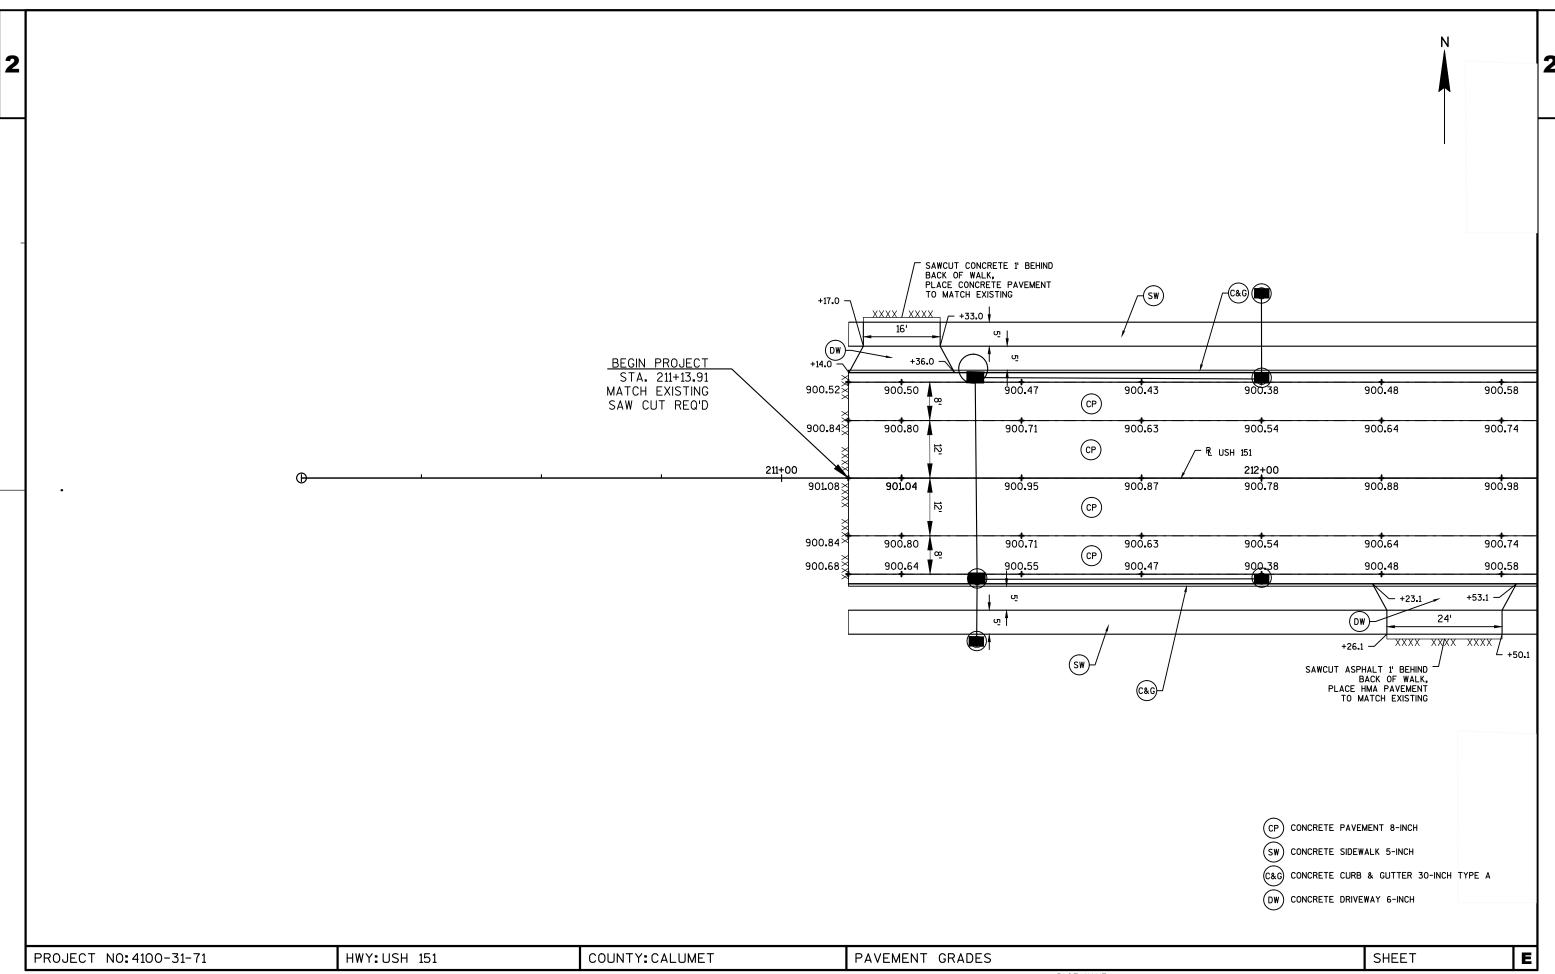


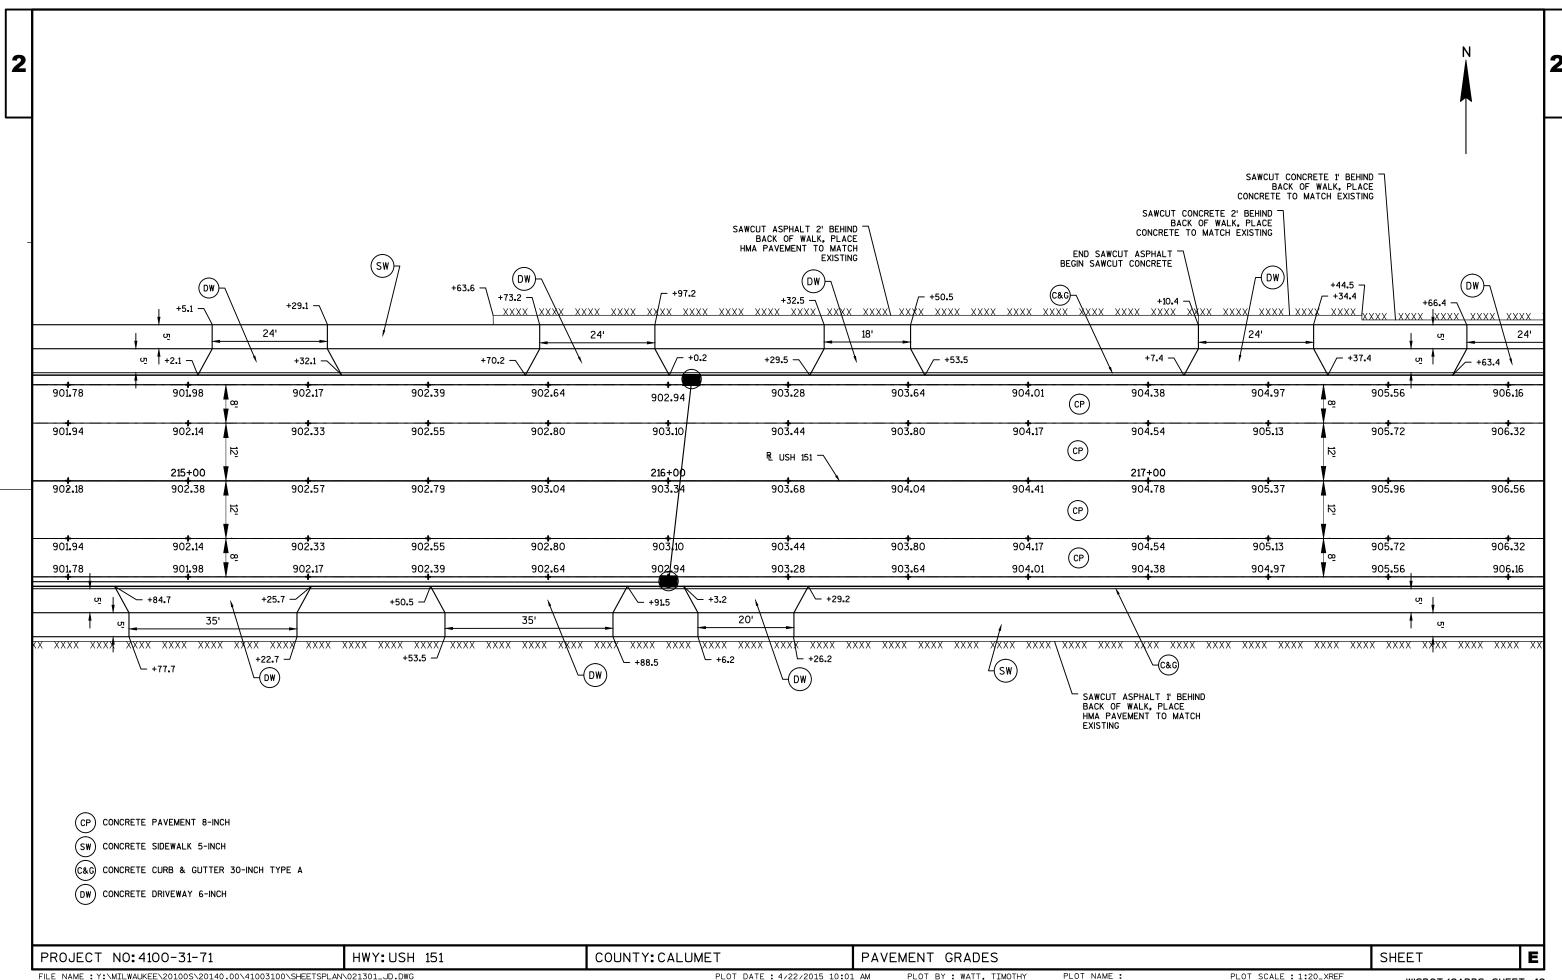


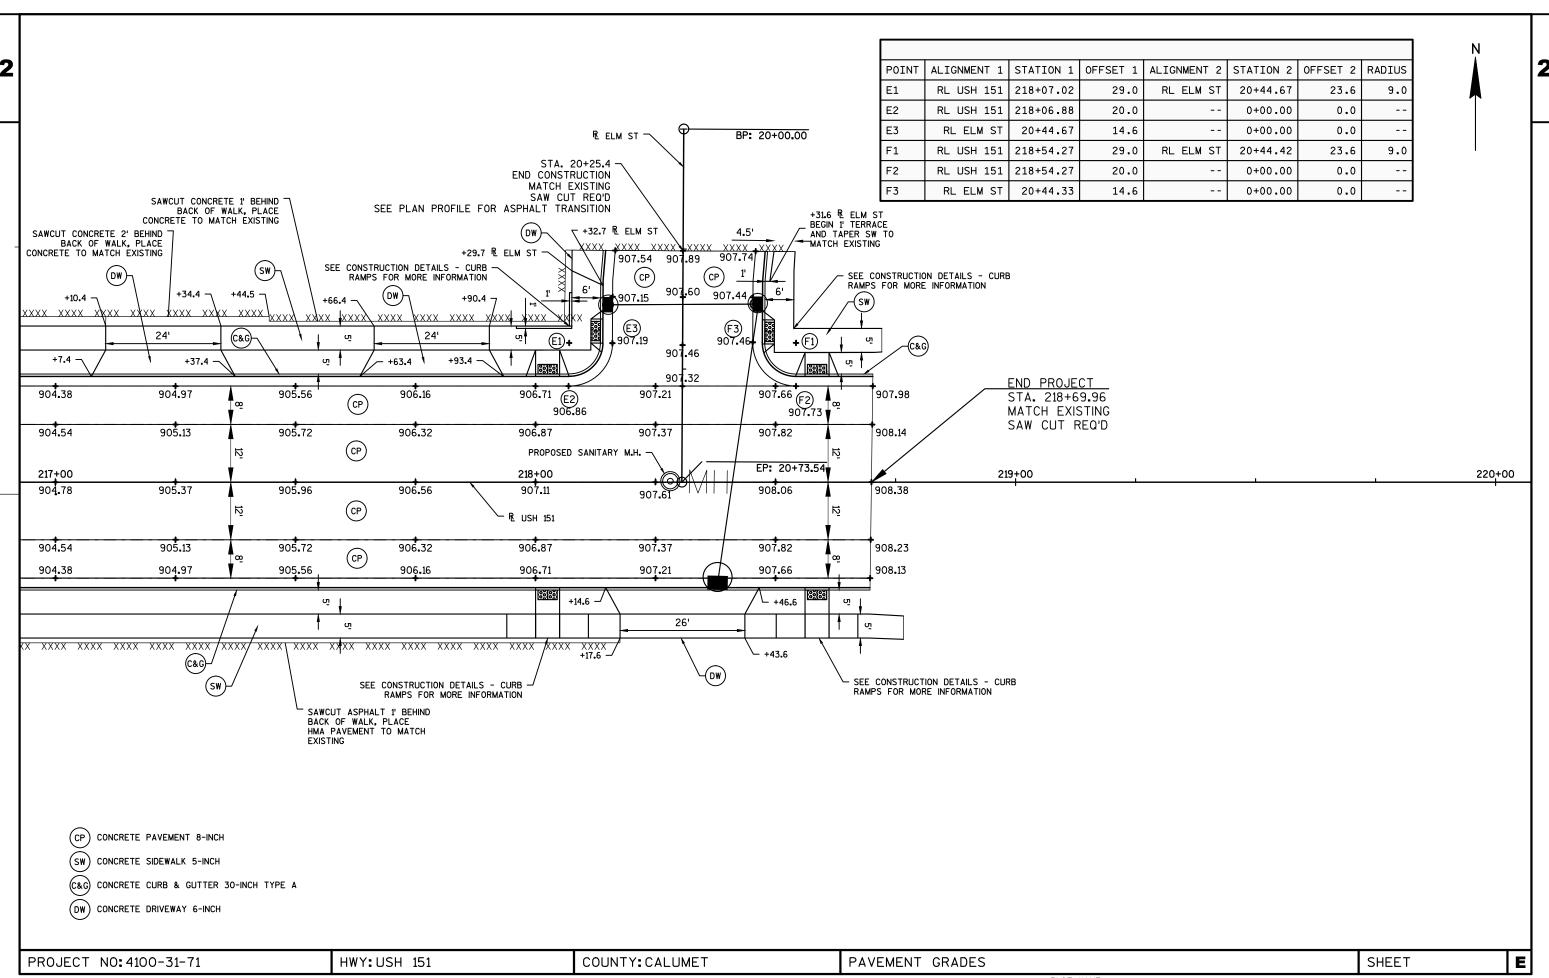


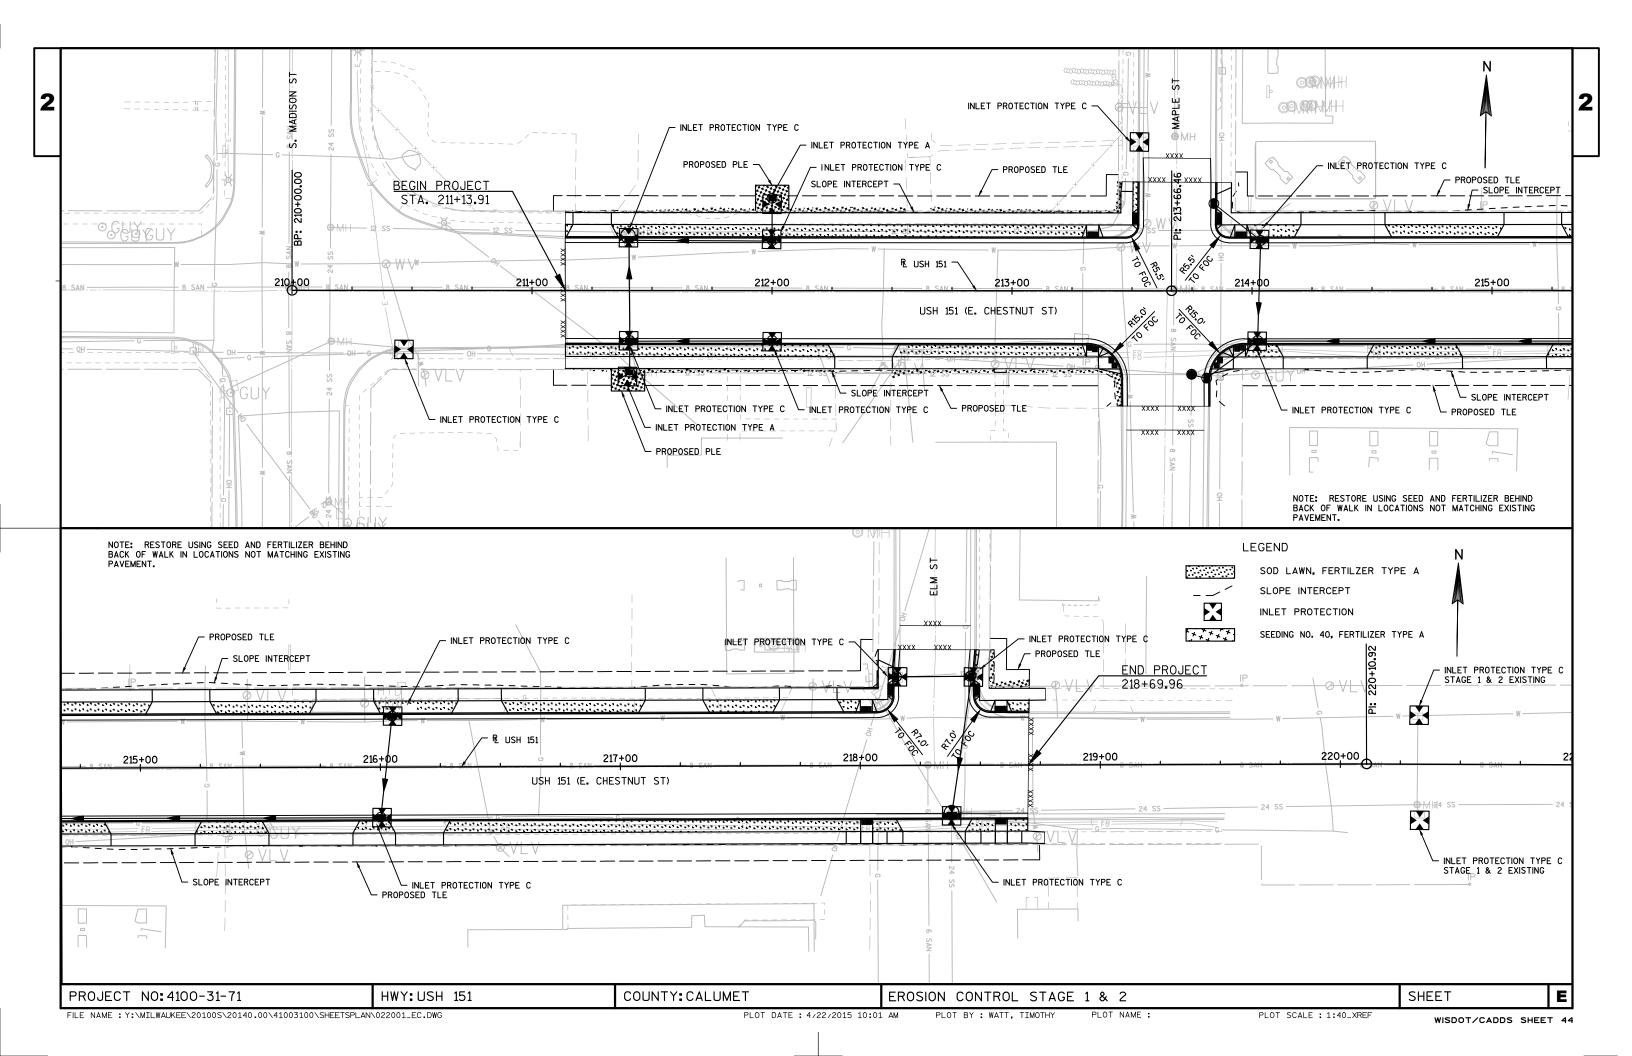

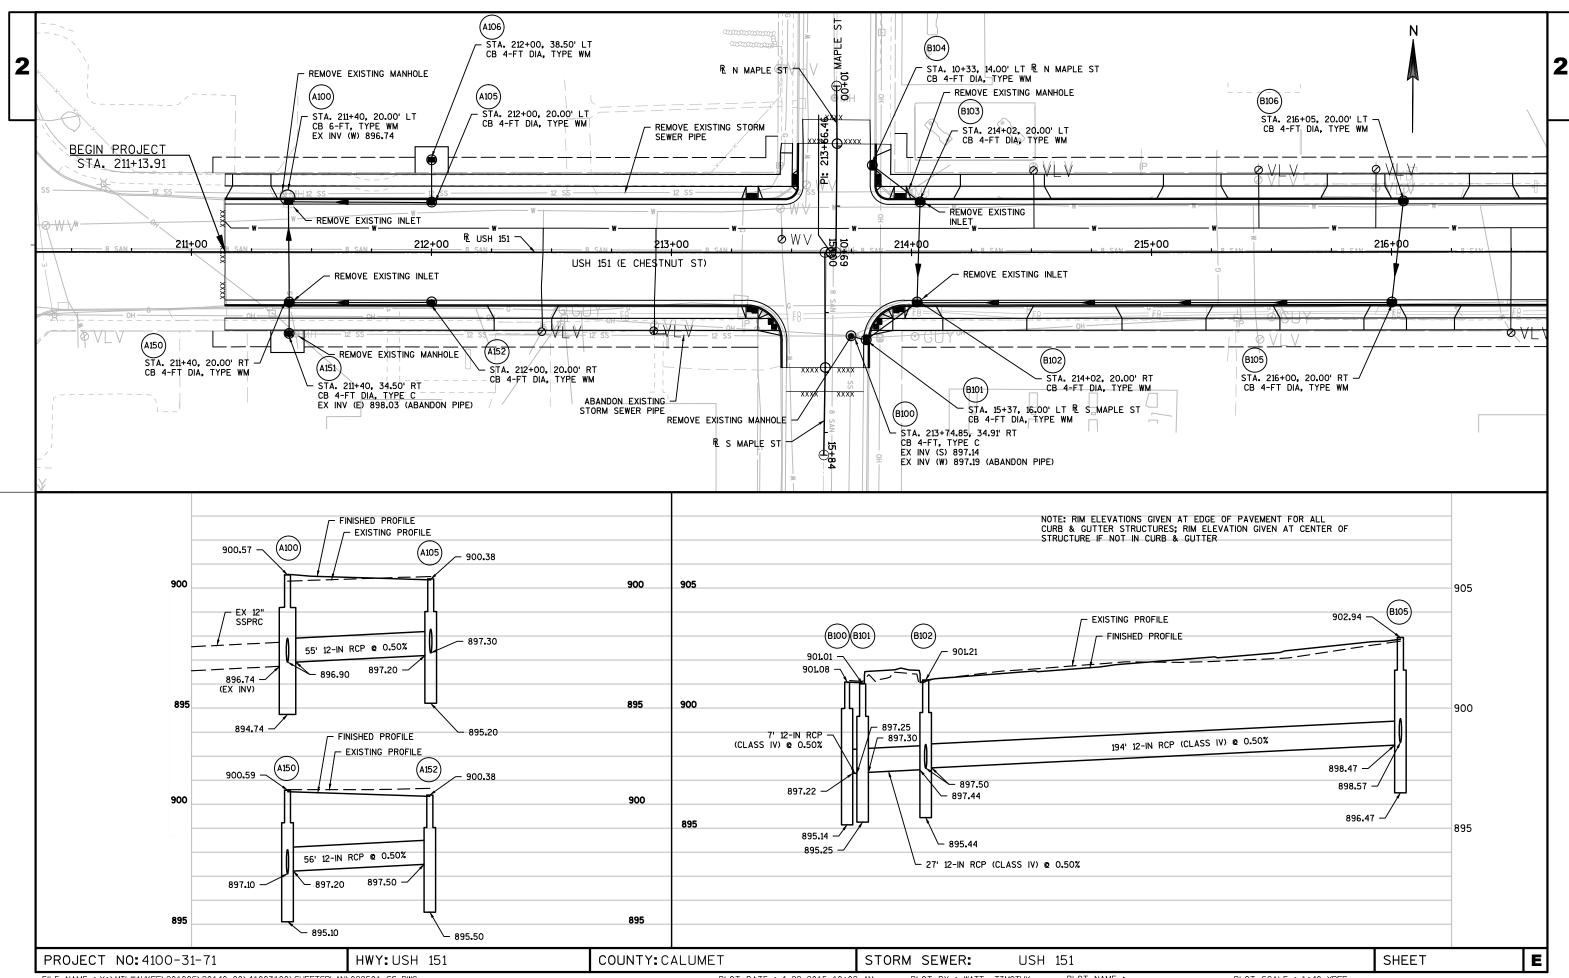


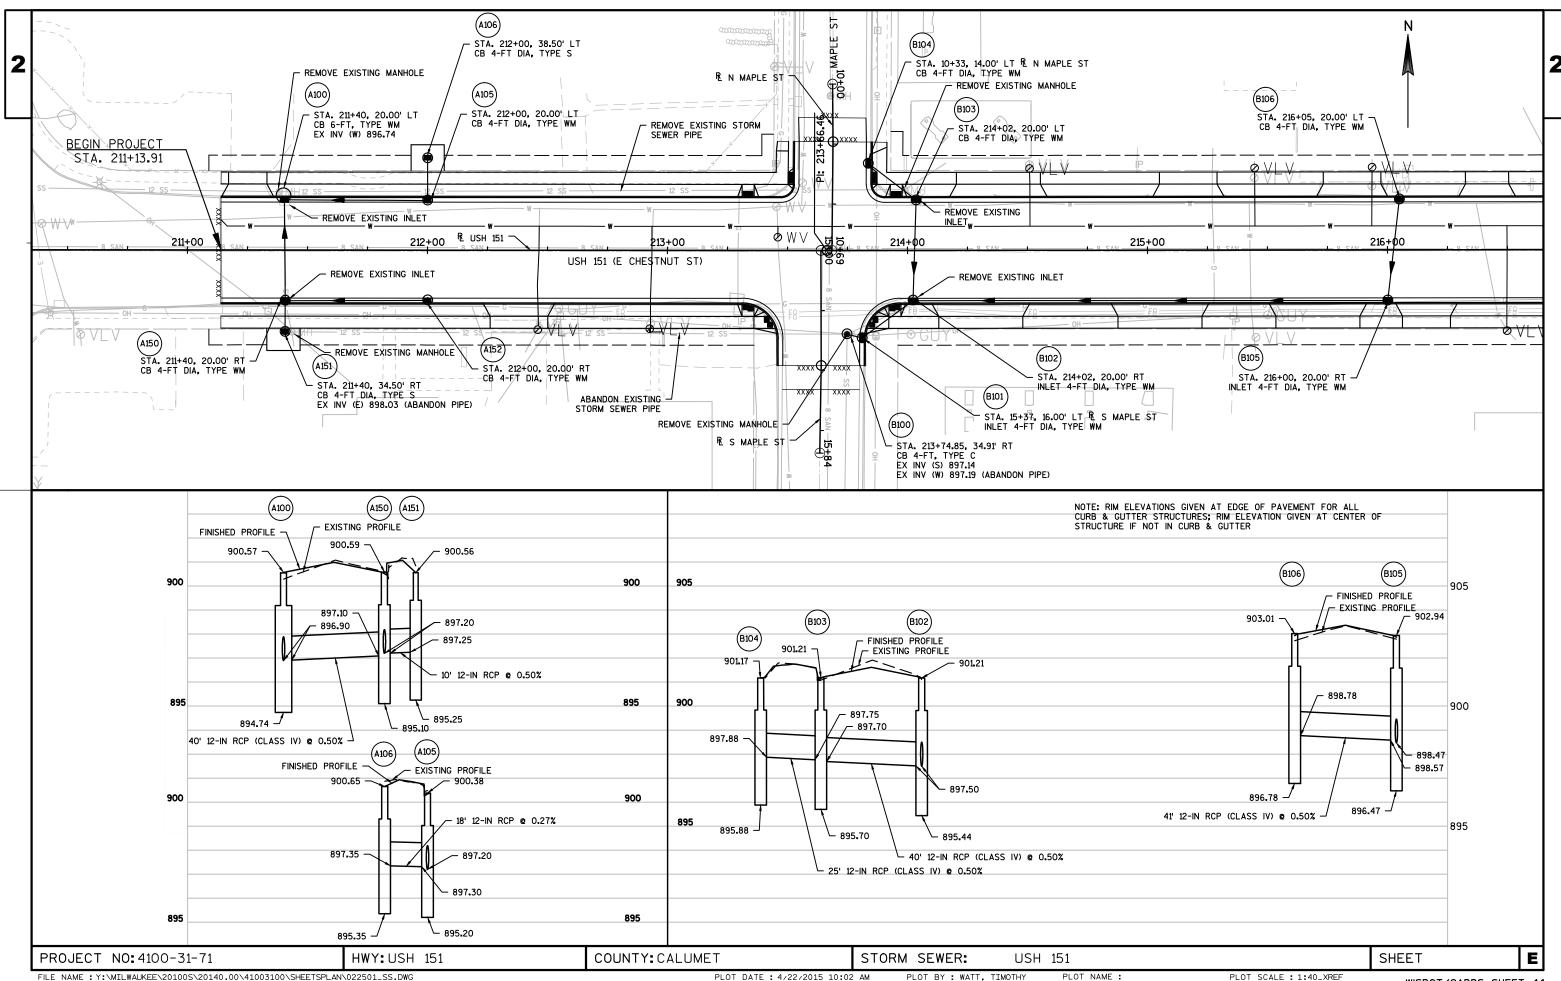

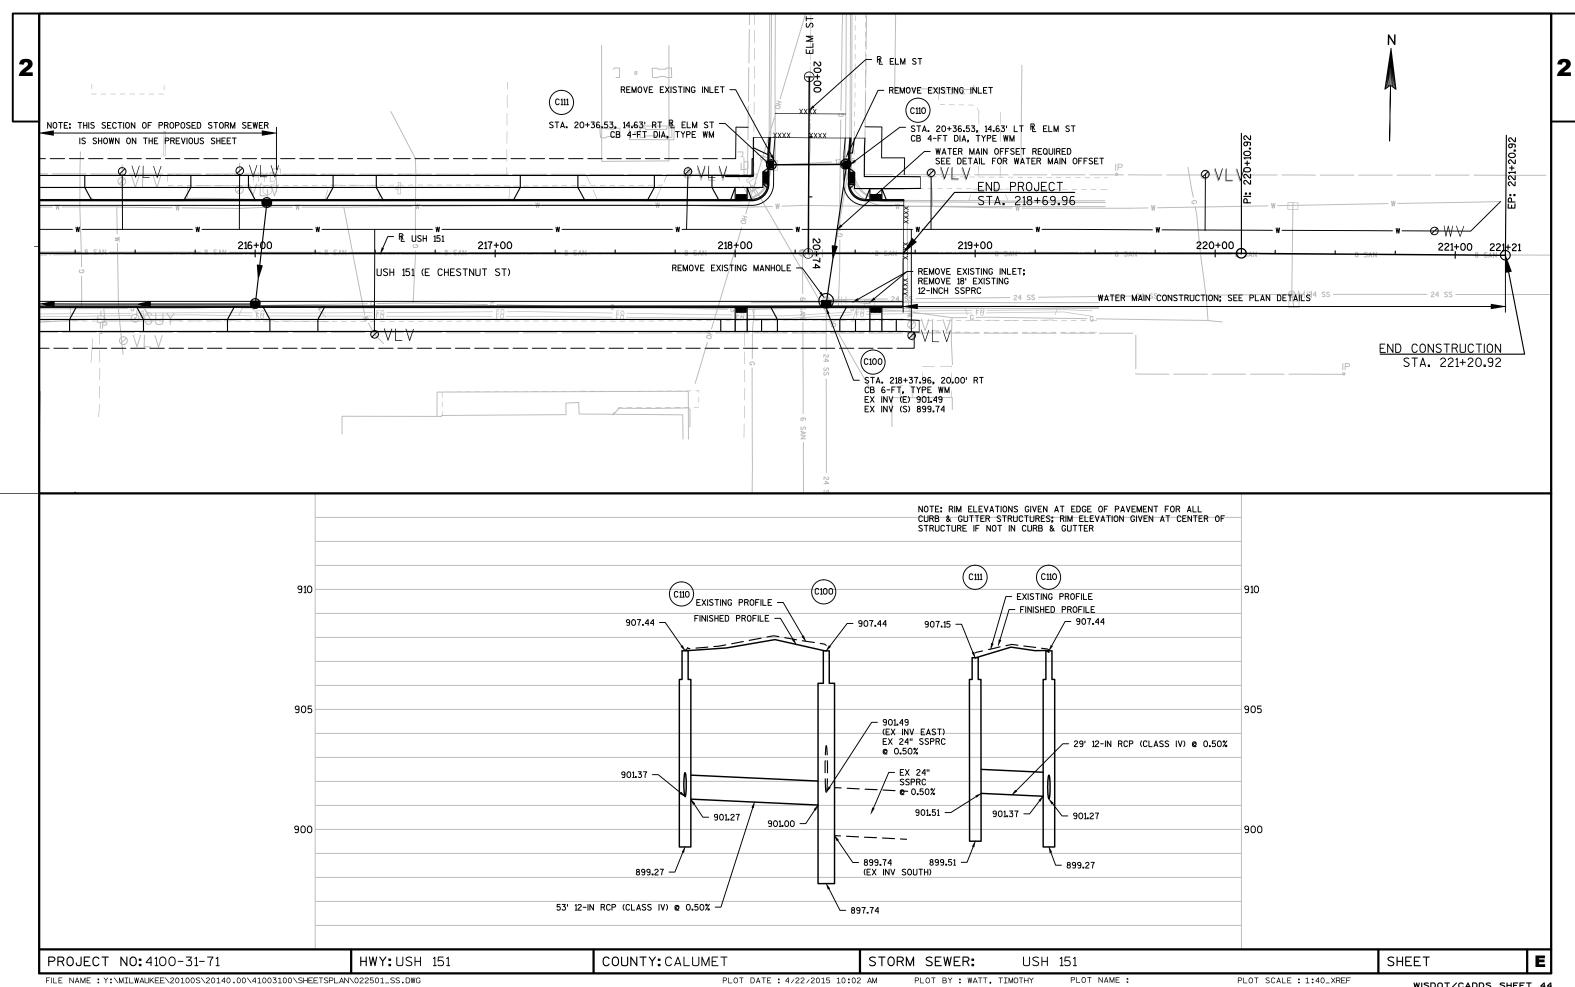

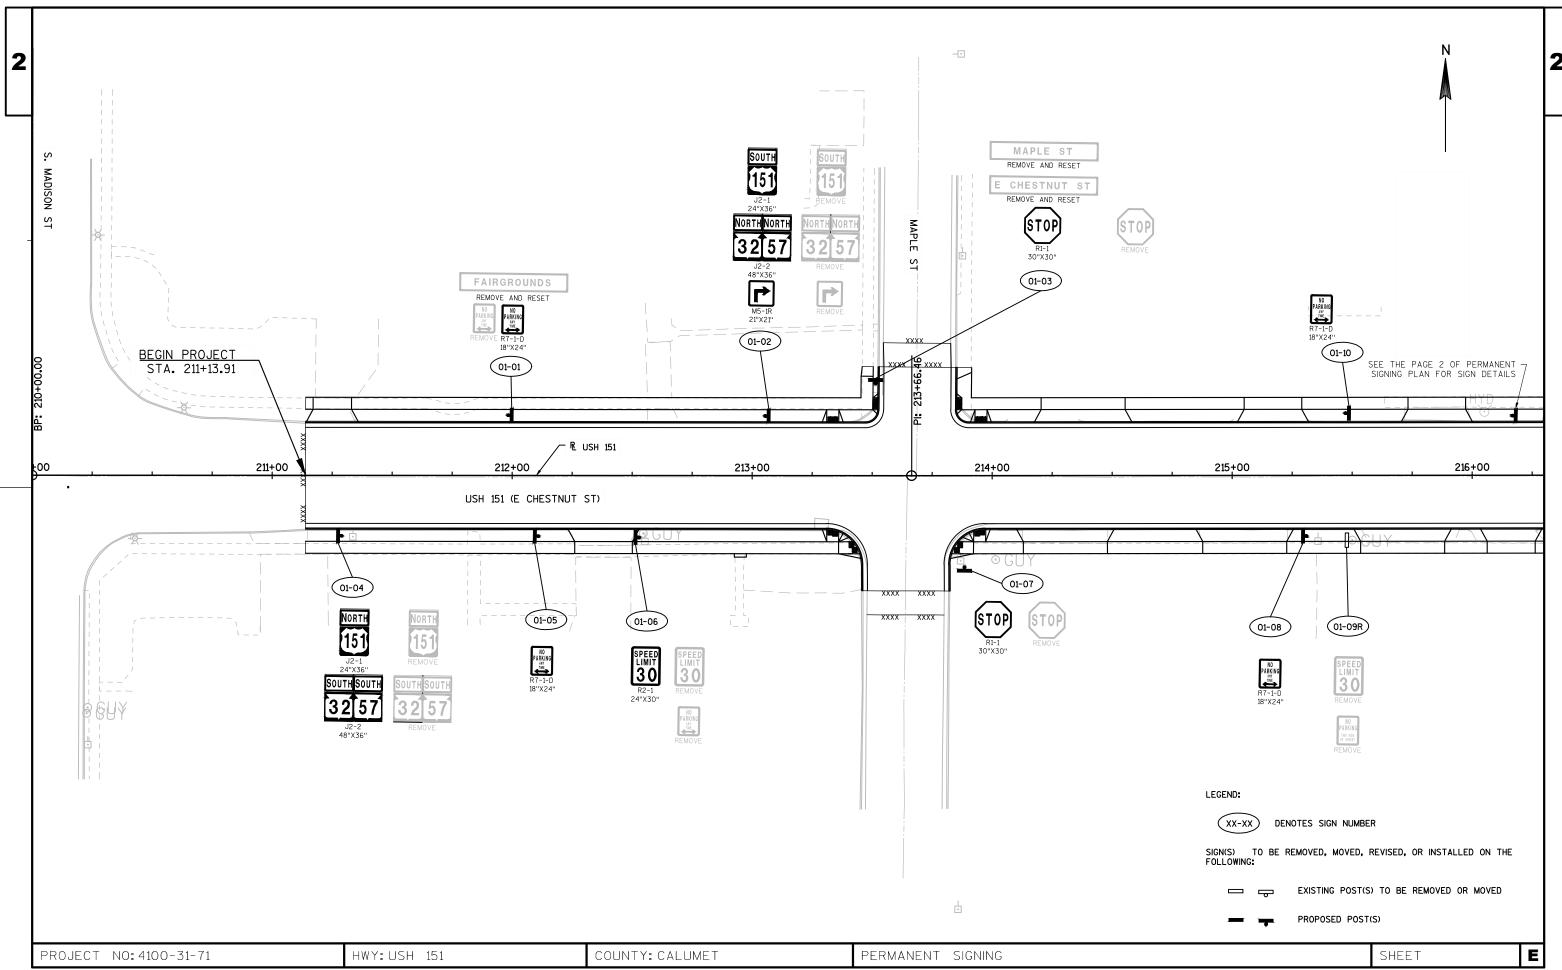

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WISDOT/CADDS SHEET 42

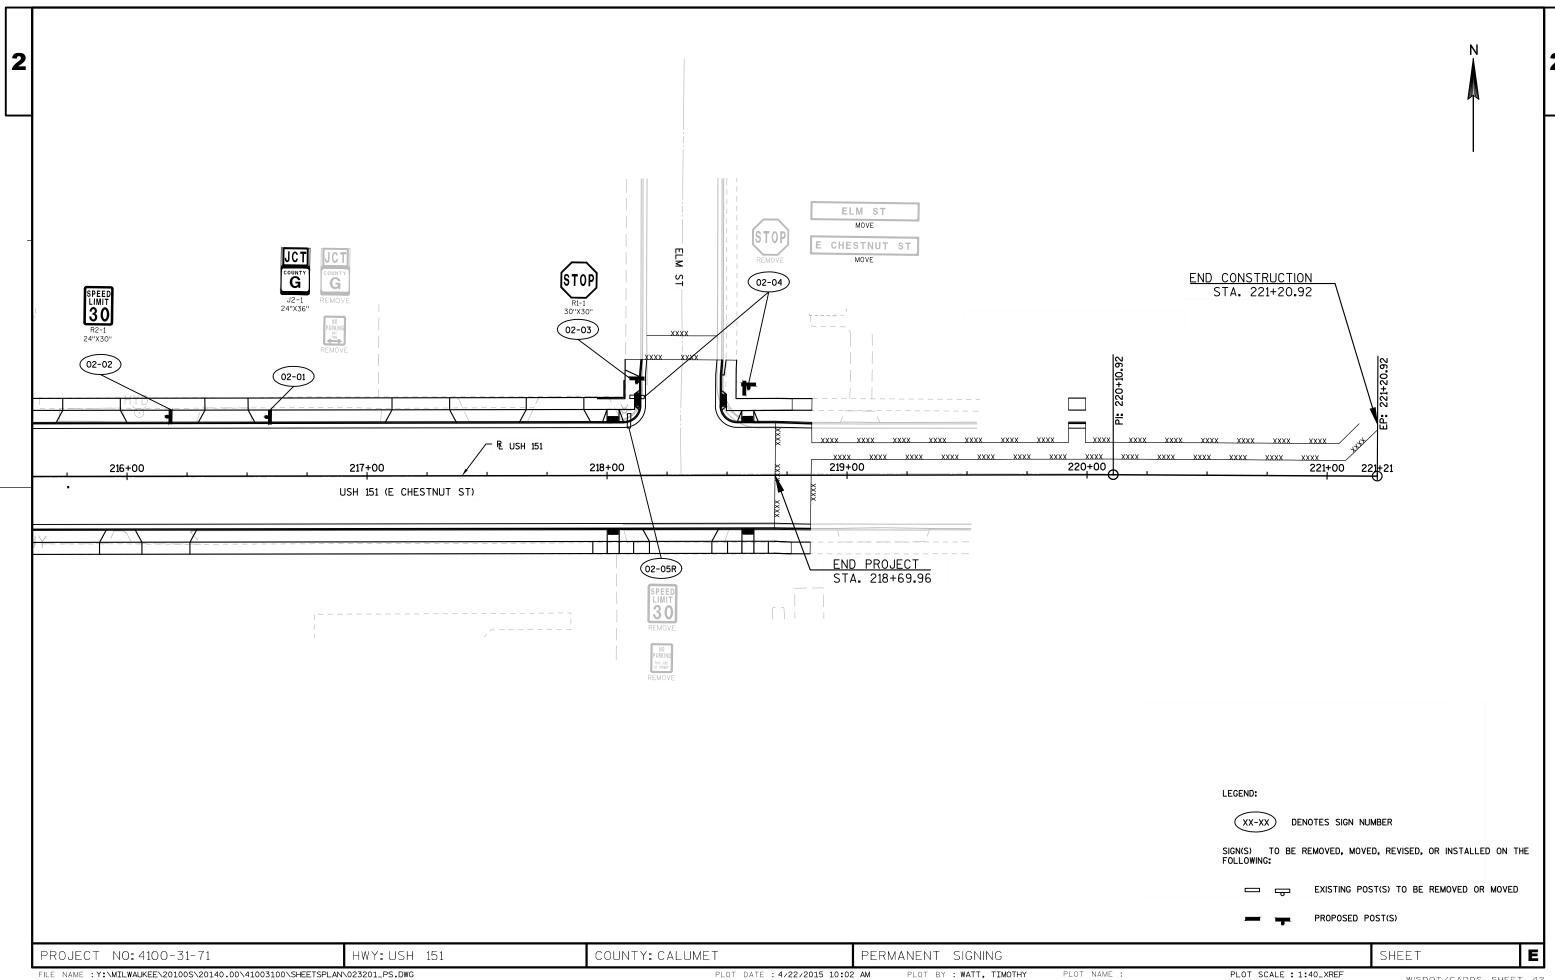


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PLOT NAME :

PLOT SCALE : 1:40\_XREF

WISDOT/CADDS SHEET 42

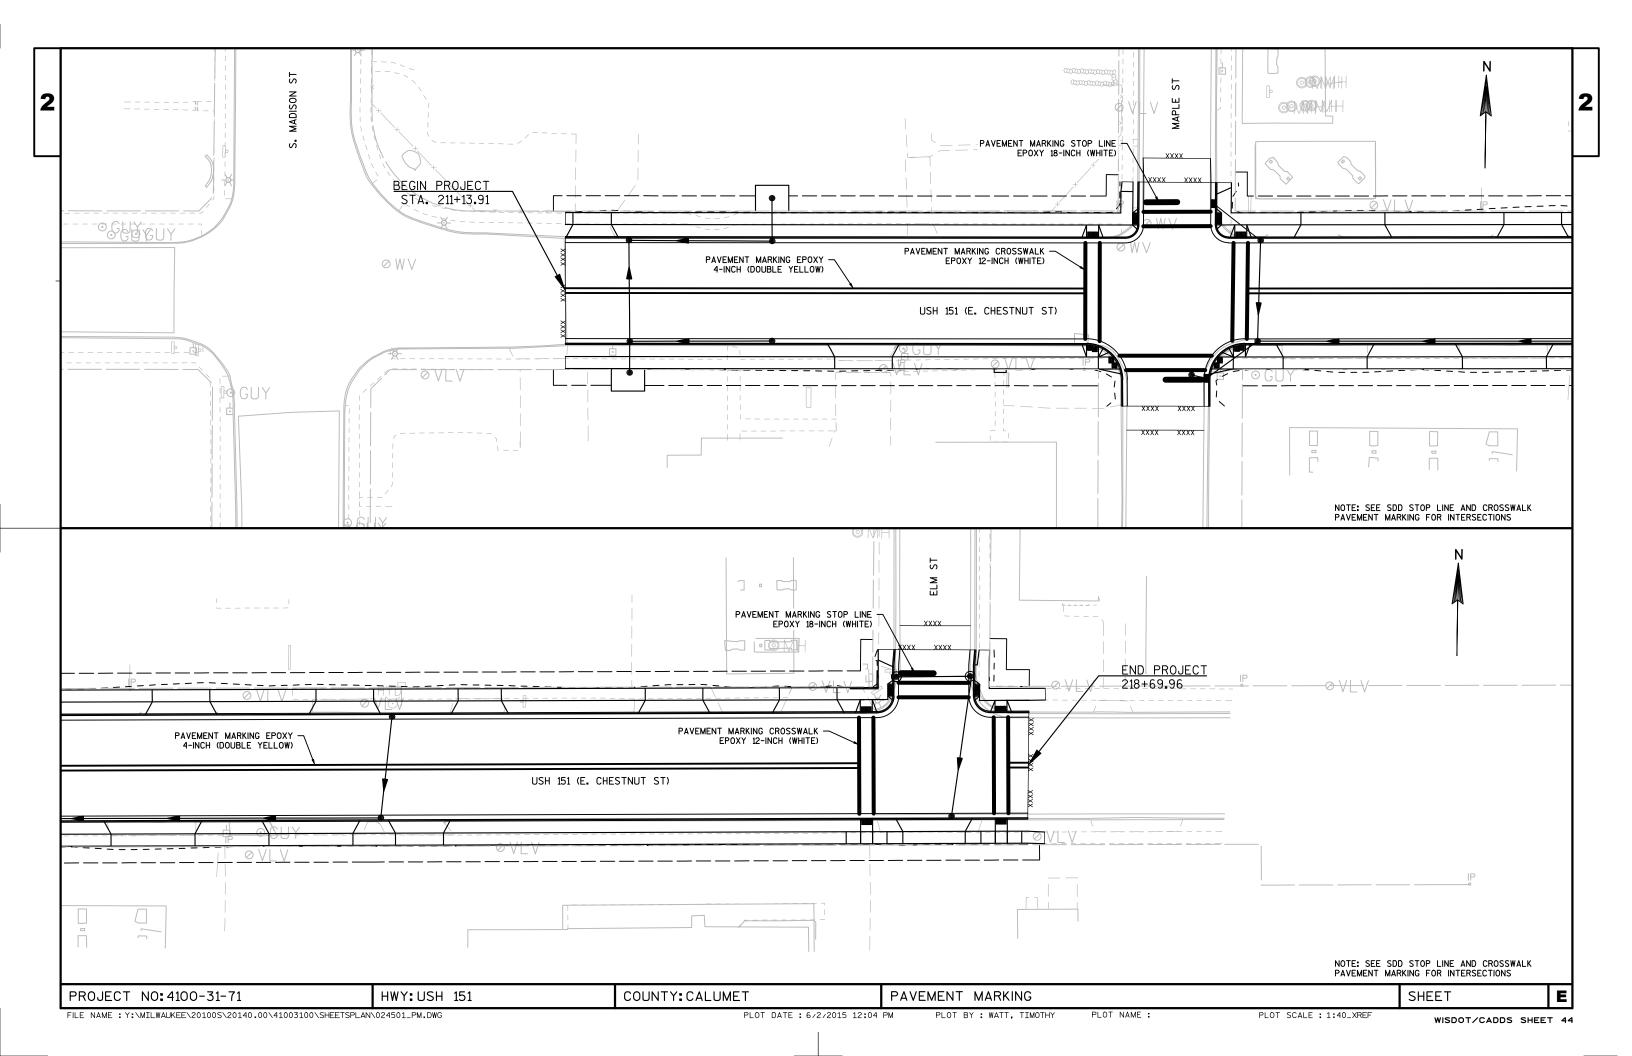

## CLOSED AHEAD WORK 1000 F MANHATTAN ST SCHOOL CT BROOKLYN ROAD ROAD HEIGHTS ŔOAD CLOSED CLOSED WORK AHEAD AHEAD 500 F. 36" X 36" E. BROOKLYN ST S OAK ST END END END END ROAD WORK ROAD WORK ROAD WORK ROAD WORK CLOSED W. CHESTNUT ST / USH 151 END ROAD WORK ROAD WORK ROAD ROAD END CLOSED 48" X 24" WORK G20-2A 48" X 24" ROAD WORK PROJECT WORKZONE 1000 F \HEAI USH 151 ROAD CALUMET ST WORK WORK AHEAD ROAD CLOSED AHEAD

## STAGE TRAFFIC CONTROL NOTES:

CLOSE ROAD ON E. CHESTNUT STREET (USH 151/STH 32/57) TO TRAFFIC FROM S. MADISON STREET TO ELM STREET (EASTBOUND). CLOSE ROAD ON E. CHESTNUT STREET TO THRU TRAFFIC FROM ELM STREET TO S. MADISON STREET (WESTBOUND), HOWEVER MAINTAIN ONE WAY TRAFFIC IN THIS DIRECTION FOR LOCAL ACCESS. MAINTAIN DRIVEWAY ACCESS WITHIN THE WORK ZONE AREA. AT A MINIMUM MAINTAIN ROADWAY AND DRIVEWAY SURFACES WITH BASE AGGREGATE, MAINTAIN ACCESS FOR EMERGENCY VEHICLES AT ALL TIMES. CONSTRUCT PIPE CROSSINGS IN HALVES TO MAINTAIN ONE WAY WESTBOUND

CLOSE THE LEFT TURN ONLY LANE ON S. MADISON STREET TO E. CHESTNUT STREET FOR THE DURATION OF THE PROJECT.

SETUP DETOUR PRIOR TO BEGINNING CONSTRUCTION AND MAINTAIN THROUGH THE COMPLETION OF THE PROJECT. CONFIRM ALL DETOUR SIGNING IN ACCORDANCE WITH THE MANUAL ON UNIFORM TRAFFIC CONTROL DEVICES LATEST EDITION. SUBMIT THE PROPOSED DETOUR AND SIGNING PLAN TO THE CITY OF CHILTON AND CALUMET COUNTY HIGHWAY DEPARTMENT FOR REVIEW AND APPROVAL PRIOR TO BEGINNING CONSTRUCTION OPERATIONS.

PROVIDE FLAGGERS AND SIGNING IN ACCORDANCE WITH THE MANUAL ON UNIFORM TRAFFIC CONTROL DEVICES LATEST EDITION WHEN TEMPORARY LANE SHIFTS ARE REQUIRED FOR PIPE OR UTILITY CROSSINGS. WHEN MORE THAN ONE PIPE OR UTILITY CROSSING IS OCCURRING AT THE SAME TIME, PROVIDE SEPARATE SIGNING AND FLAGGERS FOR EACH OPERATION UNLESS THEY ARE IN CLOSE PROXIMITY TO BE CONSOLIDATED INTO A SINGLE SIGNING AND FLAGGING OPERATION.

PHASE THE CONSTRUCTION ON MAPLE STREET TO THE SOUTH TO MAINTAIN LOCAL ACCESS

PORTABLE SUPPORTS ALLOWED FOR SIGN PLACEMENT ON PAVEMENT AND AGGREGATE SURFACES ONLY.

CONFIRM DETAILS OF TRAFFIC CONTROL DEVICES AND THEIR LOCATION NOT SHOWN ON THE TRAFFIC CONTROL DRAWINGS WITH THE PERTINENT REQUIREMENTS OF THE MANUAL ON UNIFORM TRAFFIC CONTROL DEVICES LATEST EDITION. ADJUST SIGNS, BARRICADES, AND DRUM LOCATIONS AS DIRECTED BY THE ENGINEERING IN THE FIELD. CONFORM ALL SIGN SIZES TO THE REQUIREMENTS FOR A CONVENTIONAL ROAD AS DESCRIBED IN THE MANUAL ON UNIFORM TRAFFIC CONTROL DEVICES. THE MINIMUM SIZE FOR A DIAMOND SHAPED TEMPORARY TRAFFIC CONTROL SIGN IS 48" X 48".

REMOVE ALL PAVEMENT MARKING THAT IS NOT APPROPRIATE TO THE TRAVEL PATH.

PLACE ADDITIONAL DRUMS AT SIDE ROADS AND PRIVATE ENTRANCES AS DIRECTED BY THE ENGINEER IN THE FIELD.

EXISTING UTILITIES ARE NOT SHOWN ON TRAFFIC CONTROL SHEETS.

SEE SDD BARRICADES AND SIGNS FOR MAINLINE CLOSURES AND SDD DETOUR SIGNING FOR MAINLINE CLOSURES FOR ADVANCED SIGNING AND MARKING.

SEE SDD BARRICADES AND SIGNS FOR SIDEROAD CLOSURES FOR SIGNING AND MARKING OF MAPLE STREET AND ELM STREET CLOSURES.

SEE SDD TRAFFIC CONTROL, SIDEWALK CLOSURE FOR SIGNING AND MARKING FOR A CLOSED SIDEWALK DURING CONSTRUCTION. ONE SIDEWALK ON EITHER SIDE OF THE STREET MUST REMAIN OPEN AT ALL TIMES.

HWY: USH 151

PROJECT NO: 4100-31-71

COUNTY: CALUMET

TRAFFIC CONTROL:

ADVANCED WARNING SIGNS AND NOTES


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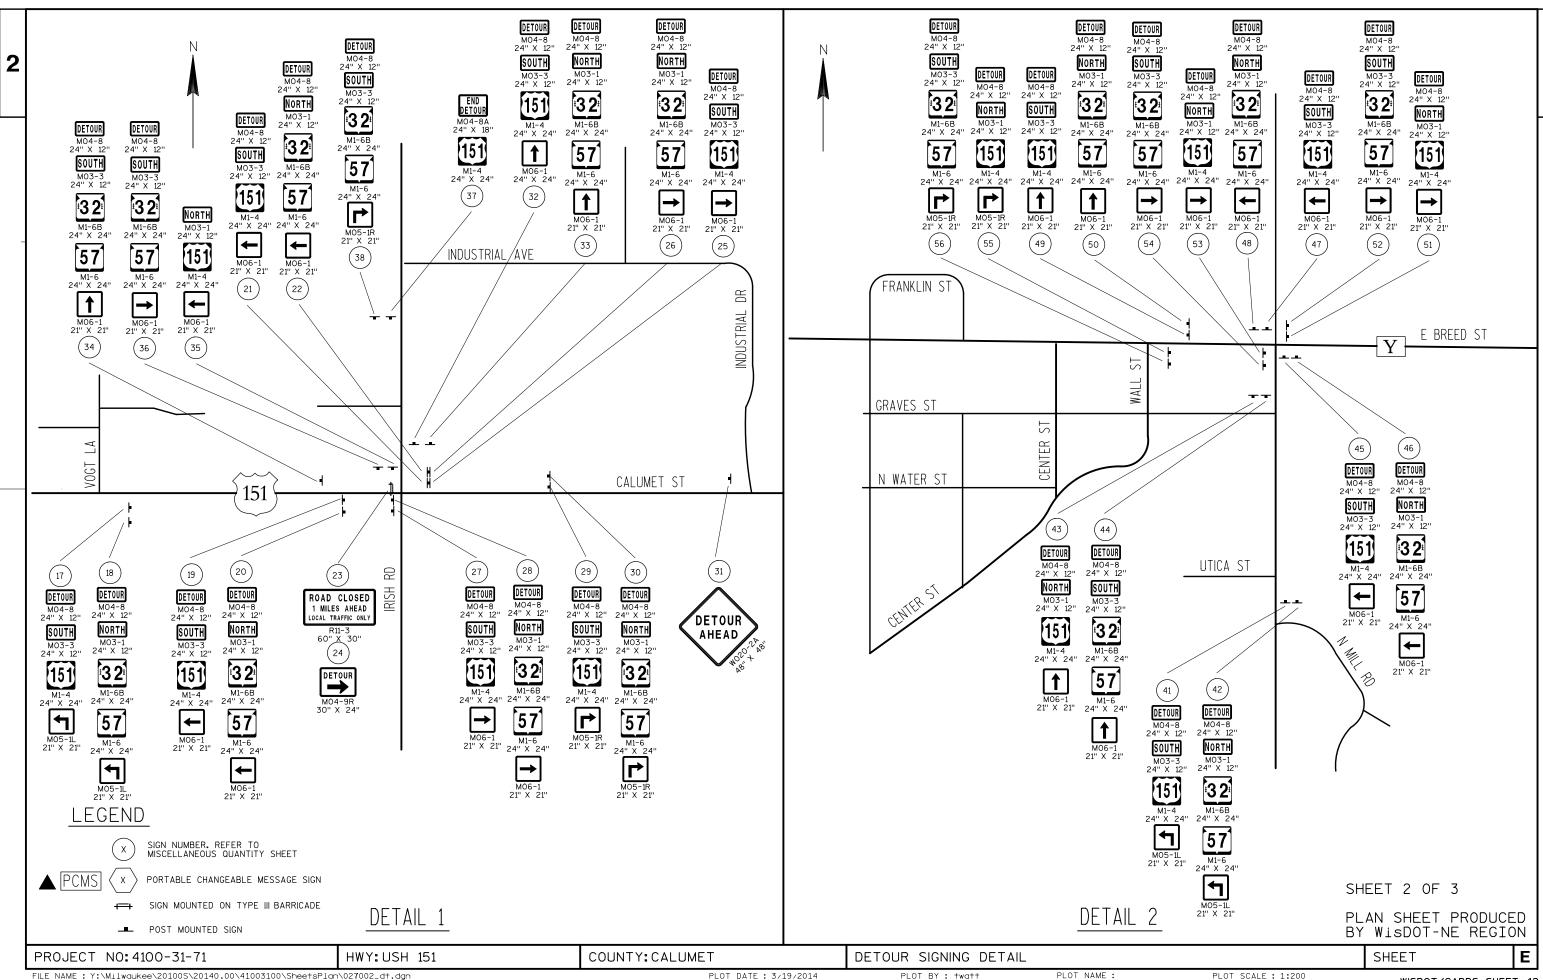



FILE NAME: Y:\MILWAUKEE\20100S\20140.00\41003100\SHEETSPLAN\025002\_TC.DWG PLOT DATE: 4/22/2015 10:03 AM PLOT BY: WATT, TIMOTHY PLOT NAME: PLOT SCALE: 1:50\_XREF WISDOT/CADDS SHEET 42




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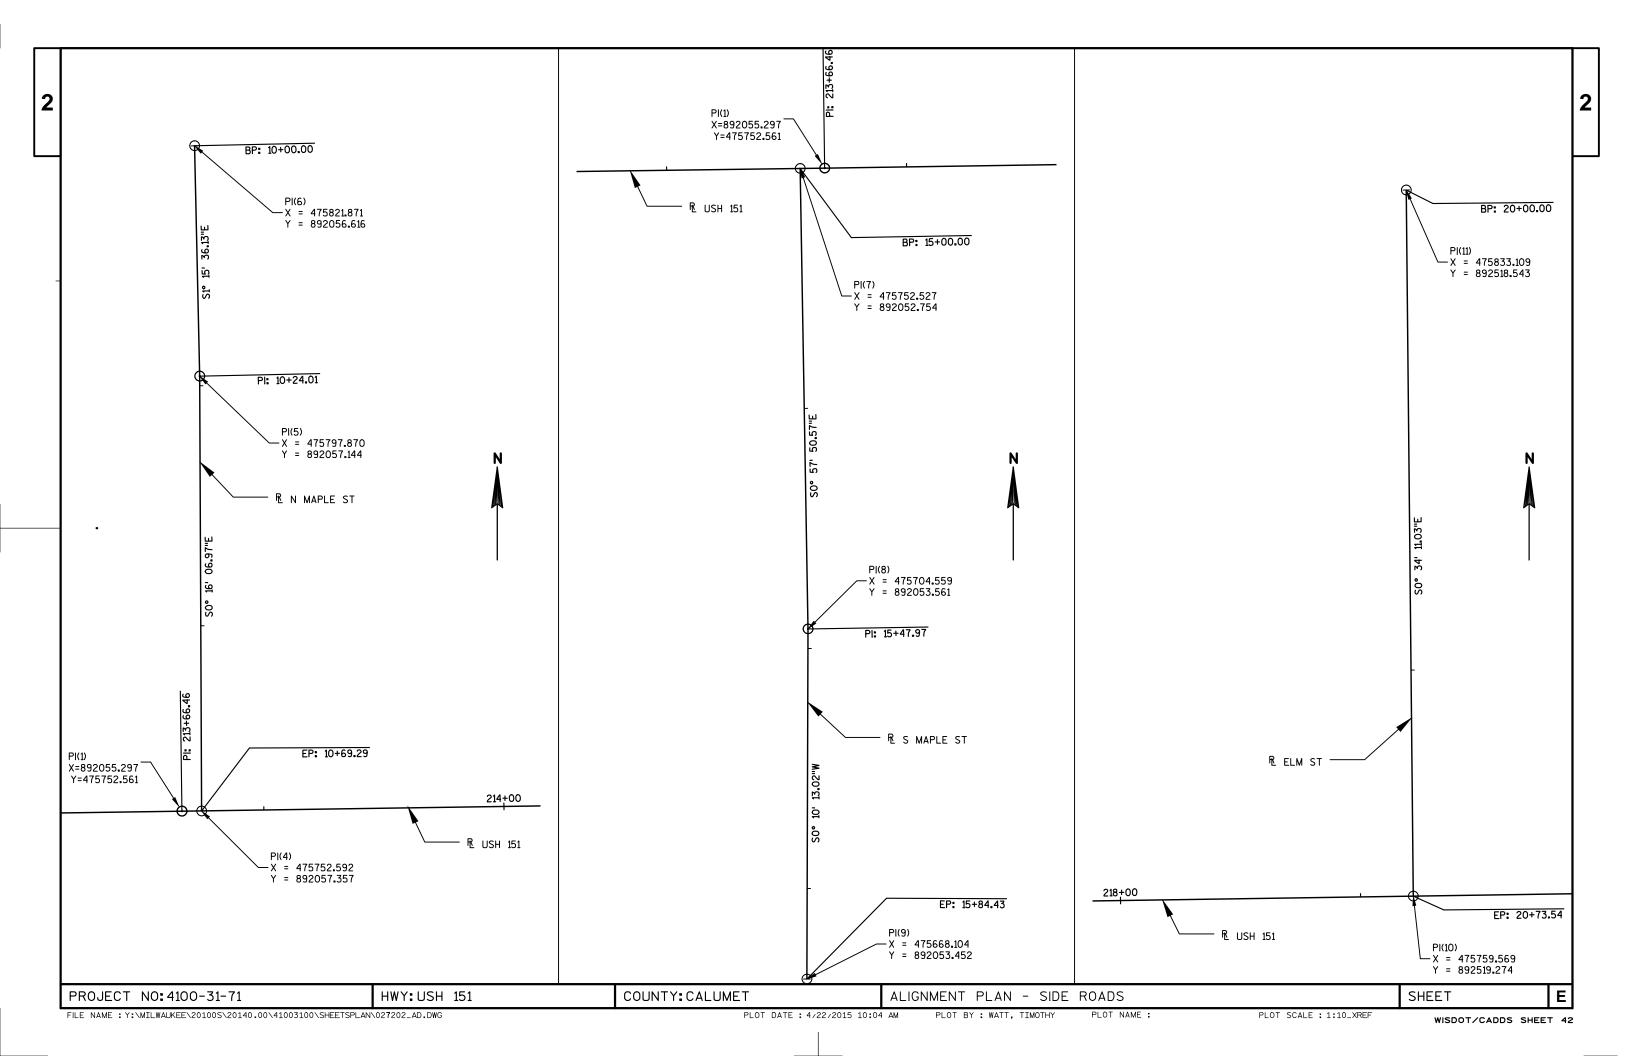




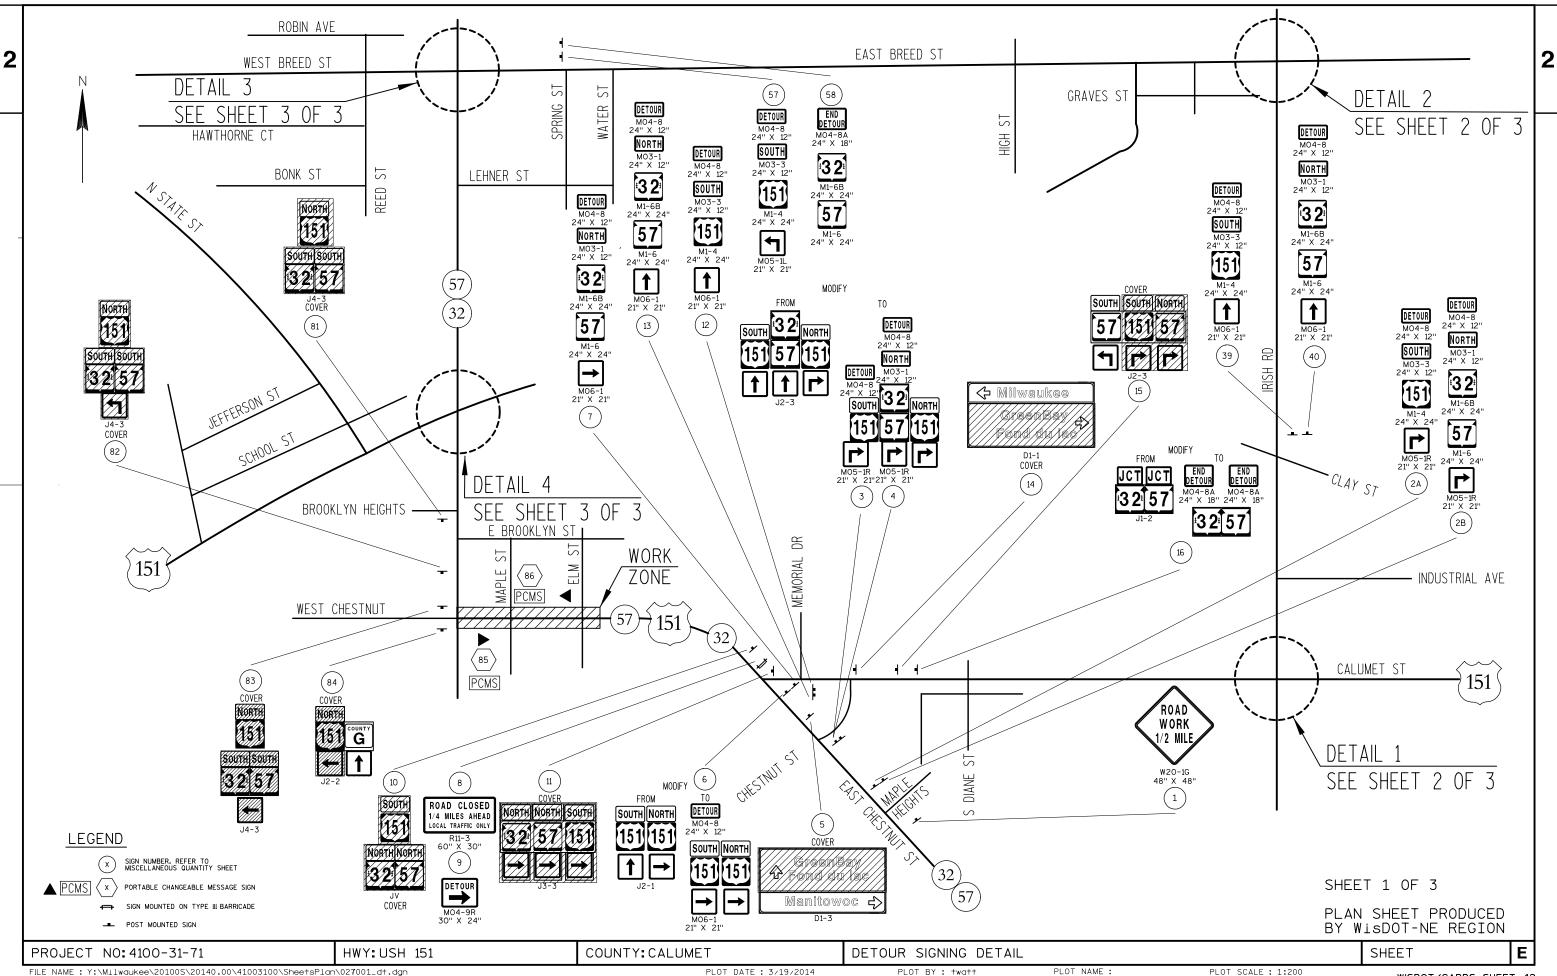

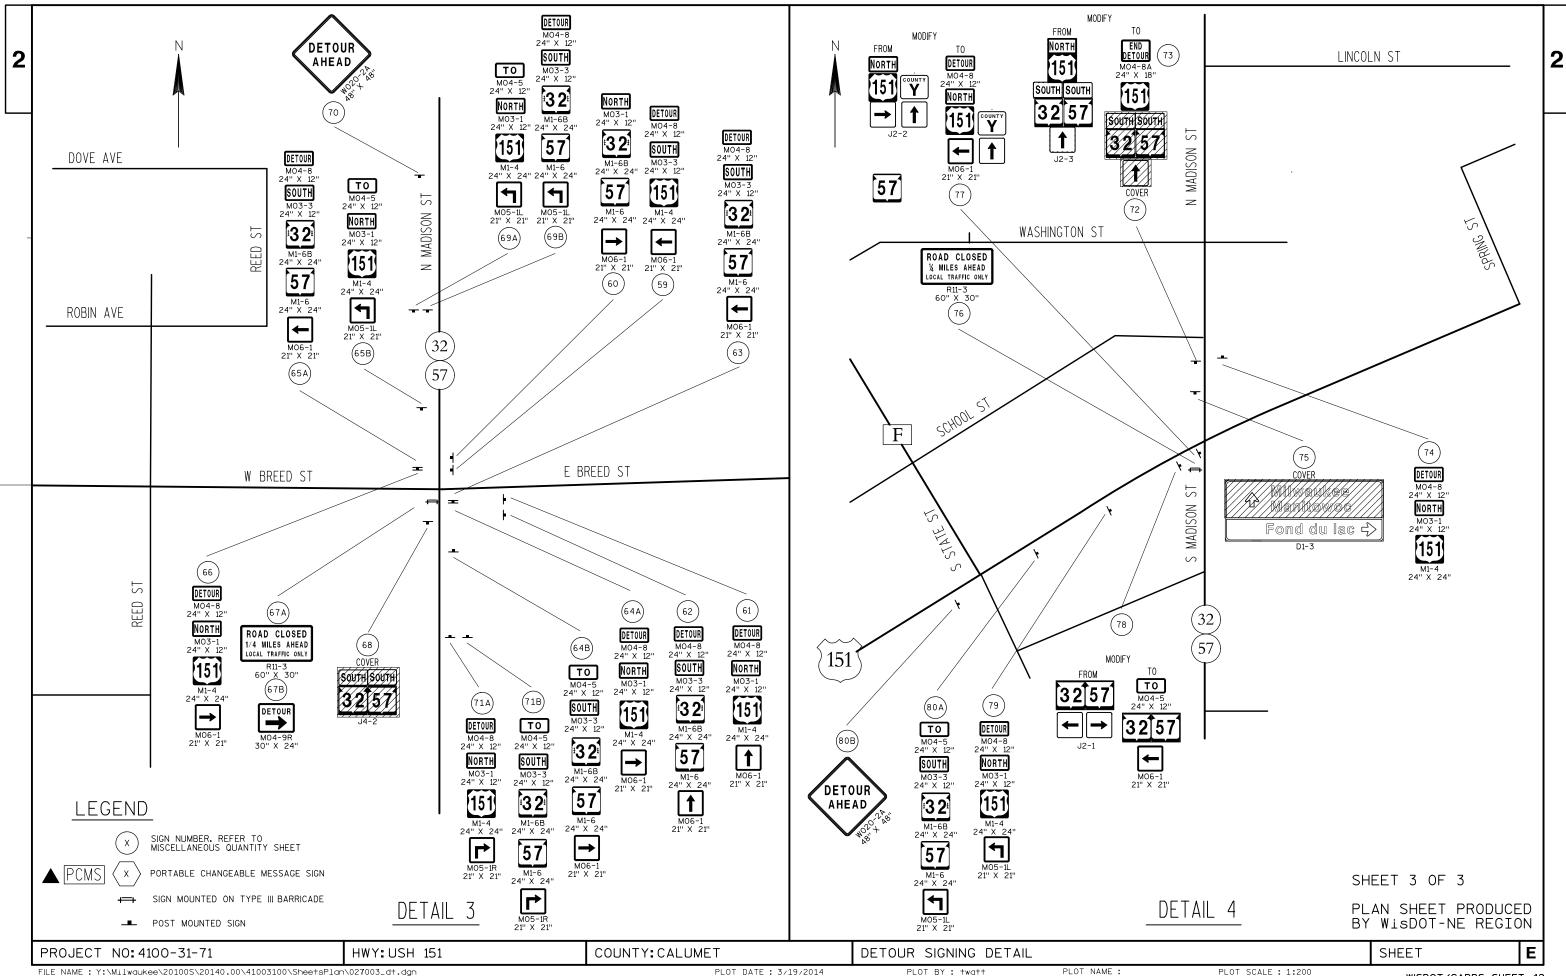

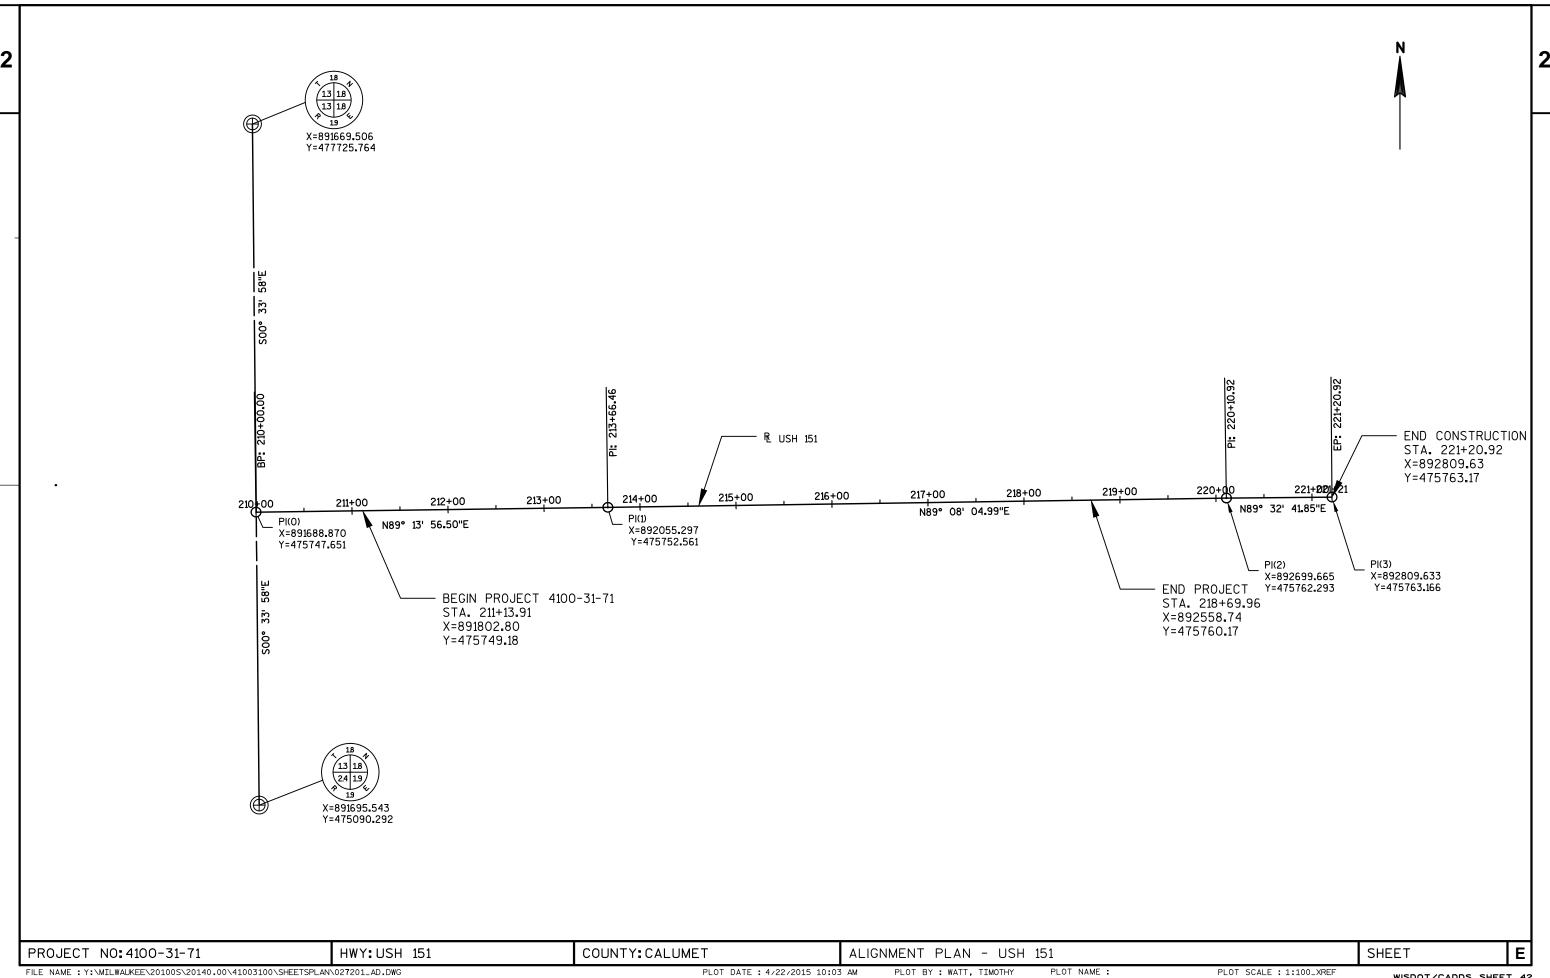WISDOT/CADDS SHEET 42



DATE 09 LINE	JUN15	E S	ГІМАТЕ	0 F Q U A N	T I T I E S 4100-31-71	
NUMBER 0010	203. 0210. S	ITEM DESCRIPTION Abatement of Asbestos Containing Material (structure) 01. Water Main	UNI T LS	TOTAL 1. 000	QUANTI TY 1. 000	
0020 0030	204. 0100 204. 0110	Removing Pavement Removing Asphaltic Surface	SY SY	3, 800. 000 130. 000	3, 800. 000 130. 000	
0040 0050	204. 0150 204. 0155	Removing Curb & Gutter Removing Concrete Sidewalk	LF SY	1, 665. 000 870. 000	1, 665. 000 870. 000	
0060 0070	204. 0210 204. 0220	Removing Manholes Removing Inlets	EACH EACH	5. 000 8. 000	5. 000 8. 000	
0800	204.0245	Removing Storm Sewer (size) 01. 8-Inch	LF LF	35.000	35.000	
0090 0100	204. 0245 204. 0291. S	Removing Storm Sewer (size) 02. 12-Inch Abandoning Sewer	CY	770. 000 10. 000	770. 000 10. 000	
0110	205. 0100	Excavation Common	CY	4, 077. 980	4, 077. 980	
0120	213. 0100	Finishing Roadway (project) 01. 4100-31-71	EACH	1. 000	1. 000	
0130	305. 0110	Base Aggregate Dense 3/4-Inch	TON	1, 520. 000	1, 520. 000	
0140 0150	305. 0120 311. 0110	Base Aggregate Dense 1 1/4-Inch Breaker Run	TON TON	2, 080. 000 4, 270. 000	2, 080. 000 4, 270. 000	
					· 	
0160 0170	415. 0080 415. 0210	Concrete Pavement 8-Inch Concrete Pavement Gaps	SY EACH	3, 730. 000 3. 000	3, 730. 000 3. 000	
0180	416. 0160 416. 0610	Concrete Driveway 6-Inch Drilled Tie Bars	SY EACH	210. 000 50. 000	210. 000 50. 000	
0190 0200	416. 0620	Drilled Dowel Bars	EACH	25. 000	25. 000	
0210	455. 0120	Asphaltic Material PG64-28	TON	12. 000	12. 000	
0220 0230	455. 0605 460. 1103	Tack Coat HMA Pavement Type E-3	GAL TON	40. 000 155. 000	40. 000 155. 000	
0240	460. 2000	Incentive Density HMA Pavement	DOL	110.000	110.000	
0250	520. 8000	Concrete Collars for Pipe	EACH	2. 000	2. 000	
0260	601. 0409	Concrete Curb & Gutter 30-Inch Type A	LF	1, 650. 000	1, 650. 000	
0270 0280	601. 0411 601. 0600	Concrete Curb & Gutter 30-Inch Type D Concrete Curb Pedestrian	LF LF	55. 000 20. 000	55. 000 20. 000	
0290	602. 0410	Concrete Sidewalk 5-Inch	SF	6, 175. 000	6, 175. 000	
0300	602. 0415	Concrete Sidewalk 6-Inch	SF	1, 700. 000	1, 700. 000	
0310 0320	602. 0420 602. 0505	Concrete Sidewalk 7-Inch Curb Ramp Detectable Warning Field	SF SF	830. 000 112. 000	830. 000 112. 000	
		Yellow				
0330	608. 0312	Storm Sewer Pipe Reinforced Concrete Class III 12-Inch	LF	145. 000	145. 000	
0340	608. 0412	Storm Sewer Pipe Reinforced Concrete	LF	467. 000	467. 000	
0350	611. 0612	Class IV 12-Inch Inlet Covers Type C	EACH	1. 000	1. 000	
0360	611. 0651	Inlet Covers Type S	EACH	2. 000	2. 000	
0370	611.0660	Inlet Covers Type WM	EACH	13.000	13.000	
0380 0390	611. 1004 611. 1006	Catch Basins 4-FT Diameter Catch Basins 6-FT Diameter	EACH EACH	14. 000 2. 000	14. 000 2. 000	
0400	618. 0100	Maintenance And Repair of Haul Roads (project) 01. 4100-31-71	EACH	1. 000	1. 000	
0410	619. 1000	Mobilization	EACH	1. 000	1. 000	
0420	624.0100	Water	MGAL	16.000	16.000	
0430 0440	628. 1905 628. 1910	Mobilizations Erosion Control Mobilizations Emergency Erosion Control	EACH EACH	2. 000 2. 000	2. 000 2. 000	
0450	628. 7005	Inlet Protection Type A	EACH	3. 000	3. 000	
0460	628. 7015	Inlet Protection Type C	EACH	23. 000	23. 000	
0470 0480	629. 0205 630. 0140	Fertilizer Type A Seeding Mixture No. 40	CWT LB	57. 000 4. 000	57. 000 4. 000	
0490	631. 0300	Sod Water	MGAL	15. 000	15. 000	

DATE 09	JUN15	EST	IMAT	E OF QUAN	
LINE NUMBER 0500	I TEM 631. 1000	I TEM DESCRIPTION Sod Lawn	UNIT SY	TOTAL 583. 000	4100-31-71 QUANTI TY 583. 000
0510	634. 0614	Posts Wood 4x6-Inch X 14-FT	EACH	9. 000	9. 000
0520	634.0616	Posts Wood 4x6-Inch X 16-FT	EACH	2.000	2.000
0530 0540	634. 0618 634. 0620	Posts Wood 4x6-Inch X 18-FT Posts Wood 4x6-Inch X 20-FT	EACH EACH	1. 000 1. 000	1. 000 1. 000
0550	637. 2210	Signs Type II Reflective H	SF	85. 610	85. 610
0560	638. 2102	Moving Signs Type II	EACH	5.000	5.000
0570 0580	638. 2602 638. 3000	Removing Signs Type II Removing Small Sign Supports	EACH EACH	10. 000 8. 000	10. 000 8. 000
0590	642. 5001	Field Office Type B	EACH	1. 000	1. 000
0600	643. 0100	Traffic Control (project) 01. 4100-31-71		1. 000	1. 000
0610	643. 0300	Traffic Control Drums	DAY	3, 974. 000	3, 974. 000
0620 0630	643. 0410 643. 0420	Traffic Control Barricades Type II Traffic Control Barricades Type III	DAY DAY	3, 070. 000 3, 058. 000	3, 070. 000 3, 058. 000
0640	643. 0705	Traffic Control Warning Lights Type A	DAY	8, 236. 000	8, 236. 000
0650	643. 0715	Traffic Control Warning Lights Type C	DAY	1, 218. 000	1, 218. 000
0660	643. 0900	Traffic Control Signs	DAY	4, 610. 000	4, 610. 000
0670 0680	643. 0920 643. 1050	Traffic Control Covering Signs Type II Traffic Control Signs PCMS	EACH DAY	12. 000 14. 000	12. 000 14. 000
0690	643. 2000	Traffic Control Detour (project) 01. 4100-31-71	EACH	1. 000	1. 000
0700	643. 3000	Traffic Control Detour Signs	DAY	35, 746. 000	35, 746. 000
0710	646. 0106	Pavement Marking Epoxy 4-Inch	LF	1, 270. 000	1, 270. 000
0720	647. 0566	Pavement Marking Stop Line Epoxy 18-Inch		50.000	50.000
0730 0740	647. 0776 650. 4000	Pavement Marking Crosswalk Epoxy 12-Inch Construction Staking Storm Sewer	LF EACH	520. 000 14. 000	520. 000 14. 000
0740	650. 4500	Construction Staking Storm Sewer	LF	831. 000	831. 000
0760	650. 5500	Construction Staking Curb Gutter and Curb & Gutter	LF	65. 000	65. 000
0770	650. 7000	Construction Staking Concrete Pavement	LF	831.000	831.000
0780	650. 9910	Construction Staking Supplemental Control (project) 01. 4100-31-71	LS	1. 000	1. 000
0790	690. 0150	Sawing Asphalt	LF	1, 485. 000	1, 485. 000
0800	690. 0250	Sawing Concrete	LF	305. 000	305. 000
0810	715. 0415	Incentive Strength Concrete Pavement	DOL	500.000	500.000
0820	ASP. 1TOA	On-the-Job Training Apprentice at \$5. OO/HR	HRS	300.000	300.000
0830	ASP. 1TOG	On-the-Job Training Graduate at \$5.00/HR		600.000	600.000
0840	SPV. 0060	Special O1. Adjusting Water Valve Boxes Special O2. Abandon Water Valve	EACH EACH	1.000	1. 000 1. 000
0850	SPV. 0060	·		1.000	
0860 0870	SPV. 0060 SPV. 0060	Special 03. Remove Fire Hydrant Special 04. Cut and Plug Existing Water	EACH EACH	1. 000 2. 000	1. 000 2. 000
0070		Main 6-Inch			
0880	SPV. 0060	Special 05. Tee 8" X 6"	EACH	1.000	1.000
0890	SPV. 0060	Special O6. Bend 45-Degree 8" Special O7. Bend 45-Degree 6" With 8" X	EACH	10.000	10.000
0900	SPV. 0060	Special 07. Bend 45-Degree 6" With 8" X 6" Reducer	EACH	2. 000	2. 000
0910	SPV. 0060	Special O8. Remove Water Service Curb	EACH	11. 000	11. 000
0920	SPV. 0060	Special 09. Water Service Curb Stop	EACH	10.000	10.000
0930	SPV. 0060	Special 10. Connect to Existing Water Main	EACH	3. 000	3. 000
0940	SPV. 0060	Special 11. Water Valve and Box 6-Inch	EACH	1.000	1.000
0950	SPV. 0060	Special 12. Water Valve and Box 8-Inch	EACH	1. 000	1.000

DATE O	9JUN15	E S 1	IMAT	E OF QUAN	
LI NE NUMBER	ITEM	ITEM DESCRIPTION	UNI T	TOTAL	4100-31-71 QUANTI TY
0960	SPV. 0060	Special 13. Adjusting Sanitary Manhole Cover	EACH	2. 000	2. 000
0970	SPV. 0090	Special O1. Water Main 6-Inch PVC	LF	10.000	10.000
0980	SPV. 0090	Special O2. Water Main 8-Inch	LF	1, 030. 000	1, 030. 000
0990	SPV. 0090	Special 03. Water Service 1-linch	LF	325.000	325.000
1000	SPV. 0090	Special 04. Removing Asbestos Water Main	LF	25. 000	25. 000
1010	SPV. 0105	Special 01. Concrete Pavement Joint Layout	LS	1.000	1. 000
1020	SPV. 0105	Special O2. Construction Staking Water Main	LS	1. 000	1. 000
1030	SPV. 0105	Special 03. Temporary Water	LS	1. 000	1. 000

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					REMOVALS					
		ITEM 204.0100 REMOVING PAVEMENT	ITEM 204.0110 REMOVING ASPHALTIC SURFACE	ITEM 204.0150 REMOVING CURB & GUTTER	ITEM 204.0155 REMOVING CONCRETE SIDEWALK	ITEM 204.0210 REMOVING MANHOLES	ITEM 204.0220 REMOVING INLETS	ITEM 204.0245.01 REMOVING STORM SEWER 8-INCH	REM 204.0245.02 REM OVING STORM SEWER 12-INCH	ITEM 204.0291.S ABANDONING SEWER
LOCATION	CATEGORY	(SY)	(SY)	(LF)	(SY)	(EACH)	(EACH)	(LF)	(LF)	(CY)
211+13 to 218+69	0010	3650	118	1571	815	5	7	31	734	7
218+69 to 218+69	0010	-	-	45	12	-	-	-	-	-
UNDISTRIBUTED	0010	150	12	49	43	-	1	4	36	3
TOTALS	i	3800	130	1665	870	5	8	35	770	10

## PAVEMENT

		ITEM 305.0110 BASE AGGREGATE	ITEM 305.0120 BASE AGGREGATE	ITEM 311.0110 BREAKER RUN	ITEM 415.0080 CONCRETE PAVEMENT	ITEM 415.0210 CONCRETE PAVEMENT	ITEM 416.0160 CONCRETE DRIVEWAY	ITEM 416.0610 DRILLED TIE	ITEM 416.0620 DRILLED DOWEL	ITEM 601.0409 CONCRETE CURB & GUTTER	ITEM 601.0411 CONCRETE CURB & GUTTER	ITEM 601.0600 CONCRETE CURB	ITEM 602.0410 CONCRETE SIDEWALK	ITEM 602.0415 CONCRETE SIDEWALK	ITEM 602.0420 CONCRETE SIDEWALK	ITEM 602.0505 CURB RAMP DETECTABLE	ITEM SPV.0105.01 CONCRETE PAVEMENT
		DENSE	DENSE		8-INCH	GAPS	6-INCH	BARS	BARS	30-INCH TYPE A	30-INCH TYPE D	PEDESTRIAN	5-INCH	6-INCH	7-INCH	WARNING FIELD	
LOCATION	CATECORY	3/4-INCH	1 1/4-INCH	(TON)	(6)()	(FA)	(6)()	(FACID	/FACID	<i>(</i> 1.5)	4.5	4.5	(60)	(CD)	(CD)	YELLOW	LAYOUT
LOCATION	CATEGORY	(TON)	(TON)	(TON)	(SY)	(EA)	(SY)	(EACH)	(EACH)	(LF)	(LF)	(LF)	(SF)	(SF)	(SF)	(SF)	(LS)
211+13 to 218+69	0010	885	1372	3659	3361	3	-	38	8	1415	-	-	5375	1700	-	16	1
MAPLE ST NORTH	0010	-	31	108	82	-	-	-	4	52	-	-	260	-	340	32	-
MAPLE ST SOUTH	0010	-	33	128	114	-	-	-	4	52	-	-	-	-	205	32	-
ELM ST	0010	-	30	95	96	-	-	-	4	52	-	19	150	-	273	32	-
DRIVEWAYS	0010	-	55	-	-	-	190	-	-	-	-	-	-	-	-	-	-
PARKING LOTS	0010	-	10	-	20	-	-	-	-	-	-	-	-	-	-	-	-
SIDEWALKS	0010	-	55	-	-	-	-	-	-	-	-	-	-	-	-	-	-
218+69 to 221+21	0010	550	180	-	-	-	-	-	-	-	55	-	200	-	-	-	-
UNDISTRIBUTED	0010	85	314	280	57	-	20	12	5	79	-	1	190	-	12	-	-
TOTALS		1520	2080	4270	3730	3	210	50	25	1650	55	20	6175	1700	830	112	1

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		ITEM 455.0120 ASPHALTIC MATERIAL PG64-28	TACK COAT	HMA PAVEMENT TYPE E-3
LOCATION	CATEGORY	(TON)	(GAL)	(TON)
218+69 to 221+21	0010	6	26	92
S Maple Street	0010	1	2	9
N Maple Street	0010	1	2	9
Elm Street	0010	1	2	9
DRIVEWAYS & PARKING LOTS	0010	2	3	26
UNDISTRIBUTED	0010	1	5	10
TOTALS		12	40	155

PROJECT NO: 4100-31-71 HWY: USH 151 COUNTY: CALUMET MISCELLANEOUS QUANTITIES SHEET E

**EARTHWORK SUMMARY** 

Division  Division 1 (Category 0010)	From/To Station	Location	Common Excavation (1) Cut (2)	(item # 205.0100) EBS Excavation (3)	Unusable Pavement Material (4)	Available Material (5)	Unexpanded Fill	Expanded Fill (6) Factor 1.33	Mass Ordinate +/- (7)	Waste	<b>Borrow</b> (item #208.0100)	Comment:
S. Maple Street	15+20.01/15+47.91	S. Maple St	87	0	38	48	0	0	48	48	0	
N. Maple Street	15+20.01/10+49.25	N. Maple St	82	0	34	48	0	0	48	48	0	
Elm Street	10+24.03/20+53.54	Elm St	80	0	40	40	0	0	40	40	0	
USH 151 (E. Chestnut Street)	211+13.91/218+69.69	USH 151	3,729	0	1,353	2,376	14	19	2,358	2,358	0	
Division 1 Subtotal			3,978	0	1,465	2,513	14	19	2,494	2,494	0	
Division 2 (Category 0010)												
Undistributed			0	100	0	100	0	0	100	100	0	
Division 2 Subtotal			0	100	0	100	0	0	100	100	0	
Grand Total			3,977.98	100.00	1,465.30	2,612.68	14.21	18.90	2,593.78	2,593.78	0.00	
		Total Co	mmon Exc	4,077.98	•							

- 1) Common Excavation is the sum of the Cut and EBS Excavation columns. Item number 205.0100
- 2) Unsuable Pavement Material is included in Cut.
- 3) EBS Excavation to be considered Waste
- 4) Unusable Pavement Material is paid for under Items Removing Pavement, Removing Concrete Sidewalk, and Removing Curb & Gutter
- 5) Available Material = Cut Unusuable Pavement Material
- 6) Expanded Fill. Factor = 1.33
- Depending on selections:

## Expanded Fill = Unexpanded Fill \* Fill Factor

7) The Mass Ordinate + or - Qty calculated for the Division. Plus quantity indicates an excess of material within the Division. Minus indicates a shortage of material within the Division. Note: EBS Excavation Areas - This is to be filled with Breaker Run material and is paid for under Item Breaker Run

PROJECT NO: 4100-31-71	HWY: USH 151	COUNTY: CALUMET	MISCELLANEOUS QUANTITIES	SHEET	Е
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ILE NAME : \_\_\_\_\_\_ PLOT DATE : \_\_\_\_\_ PLOT BY : \_\_\_\_\_ PLOT BY : \_\_\_\_ ORIGINATOR : DIST PLOT SCALE : 1:1

## STORM SEWER PIPES

					ITEM 520.8000 CONCRETE	ITEM 608.0312 STORM SEWER	ITEM 608.0412 STORM SEWER
PIPE NO.					COLLARS FOR	PIPE REINFORCED	PIPE REINFORCED
&					PIPE	CONCRETE CLASS	CONCRETE CLASS
UPSTREAM	DOWNSTREAM					III 12-INCH	IV 12-INCH
STRUCTURE	STRUCTURE	LENGTH	SLOPE	CATEGORY	(EACH)	(LF)	(LF)
A105	A100	55	0.50%	0010	-	55	-
A152	A150	56	0.50%	0010	-	56	-
B105	B101	194	0.50%	0010	-	-	194
B101	B100	7	0.50%	0010	-	-	7
B102	B101	27	0.50%	0010	-	-	27
A151	A150	10	0.50%	0010	-	10	-
A150	A100	40	0.50%	0010	-	-	40
A105	A106	18	0.27%	0010	-	18	-
B103	B102	40	0.50%	0010	-	-	40
B104	B103	25	0.50%	0010	-	-	25
B106	B105	41	0.50%	0010	-	-	41
C110	C100	53	0.50%	0010	-	-	53
C111	C110	29	0.50%	0010	-	-	29
	UNDISTRIBUT	ΓED		0010	2	6	11
	_		TOTALS	_	2	145	467

STORM SEWER STRUCTURES

STR	CATEGORY	ALIGNMENT RL	STATION	OFFS	<b>SET</b>	RIM OR GRATE ELEV	NORTH I	NORTHEAST	SOUTHEAST		ERT ELEV SOUTH N		SOUTHWEST	West	611.0612 INLET COVERS TYPE C	611.0651 INLET COVERS TYPE S (EACH)	ITEM 611.0660 INLET COVERS TYPE WM (EACH)	ITEM 611.1004 CATCH BASINS 4-FT DIAMETER (EACH)	ITEM 611.1006 CATCH BASINS 6-FT DIAMETER (EACH)	SPV.0060.13 ADJUSTING SANITARY MANHOLE COVER (EACH)
A100	0010	E CHESTNUT ST	211+40	20.00	LT	900.57	-	-	-	896.90	896.90	-	-	896.74	-	-	1	-	1	-
A105	0010	E CHESTNUT ST	212+00	20.00	LT	900.38	897.30	-	-	-	-	-	-	897.20	-	-	1	1	-	-
A106	0010	E CHESTNUT ST	212+00	38.50	LT	900.65	-	-	-		897.35	-	-	-	-	1	-	1	-	-
A150	0010	E CHESTNUT ST	211+40	20.00	RT	900.59	897.10	-	-	897.20	897.20	-	-	-	-	-	1	1	-	-
A151	0010	E CHESTNUT ST	211+40	34.50	RT	900.56	897.25	-	-	-	-	-	-	-	-	1	-	1	-	-
A152	0010	E CHESTNUT ST	212+00	20.00	RT	900.38	-	-	-	-	-	-	-	897.50	-	-	1	1	-	-
B100	0010	E CHESTNUT ST	213+74.85	34.91	RT	901.08	-	-	-	897.22	897.14	-	-	897.19 (ABANDON)	1	-	-	1	-	-
B101	0000	S. MAPLE ST	15+37	16.00	LT	901.01	-	897.30	-	-	-	-	-	897.25	-	-	1	1	-	-
B102	0010	E CHESTNUT ST	214+02	20.00	RT	901.21	897.50	-	-	897.50	-	-	897.44	-	-	-	1	1	-	-
B103	0010	E CHESTNUT ST	214+02	20.00	LT	901.21	-	-	-	-	897.70	897.75	-	-	-	-	1	1	-	-
B104	0010	N. MAPLE ST	10+33	14.00	LT	901.17	-	-	897.88	-	-	-	-	-	-	-	1	1	-	-
B105	0010	E CHESTNUT ST	216+00	20.00	RT	902.94	898.57	-	-	-	-	-	-	898.47	-	-	1	1	-	-
B106	0010	E CHESTNUT ST	216+05	20.00	LT	903.01	-	-	-	-	898.78	-	-	-	-	-	1	1	-	-
C100	0010	E CHESTNUT ST	218+37.96	20.00	RT	907.44	901.00	-	-	901.49	899.74	-	-	-	-	-	1	-	1	-
C110	0010	ELM ST	20+36.53	14.63	LT	907.44	-	-	-	-	901.27	-	-	901.37	-	-	1	1	-	-
C111	0010	ELM ST	20+36.53	14.63	RT	907.15	-	-	-	901.51	-	-	-	-	-	-	1	1	-	-
SANITARY MANHOLES	0020	E CHESTNUT ST	-	-	-	-	-	-	-	_	-	-	-	-	-	-	-	-	-	2
														TOTALS	1	2	13	14	2	

NOTE: RIM AND GRATE ELEVATIONS ARE TO FLANGE LINE OF CURB AND GUTTER FOR INLETS IN CURB AND GUTTER, ALL OTHER ELEVATION ARE TO CENTER OF STRUCTION

	PROJECT NO: 4100-31-71	HWY: USH 151	COUNTY: CALUMET	MISCELLANEOUS QUANTITIES	SHEET	Е
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PERM ANENT	SIGNING.	TYPEII

SIGN   SIGN									PERMANEN	T SIGNING, TYPE II						
Part   Part	SIGN NO.	CATEGORY	SIGN CODE	SIGN TYPE	SIGN MESSAGE	SIGN SIZE	H [IN.]	POSTS WOOD 4X6- INCH X 14-FT	POSTS WOOD 4X6- INCH X 16-FT	POSTS WOOD 4X6- INCH X 18-FT	POSTS WOOD 4X6- INCH X 20-FT	SIGNS TYPE II REFLECTIVE H	MOVING SIGNS TYPE II	REMOVING SIGNS TYPE II	REMOVING SMALL SIGN SUPPORTS	REMARKS
Part   Part																
19-12-14	01-01(R)			II				-	1	-	-		1	-	1	
1				II				-	-	-	-		-	1	-	REMOVE AND REPLACE
1	01-02(R)	0010	J2-1			24	36	-	-	-	1	6.00	-	1	1	-
		0010	10.0	"		40	20					12.00				
		0010	J2-2	"		48	30	-	-	-	-	12.00	-	-	-	-
0100   R1-1   I		0010	M5-1R	"		21	21	_	_	_	_	3.06	_	_	_	_
MARLEST   SPECIAL   B		0010	WO III		[7]							0.00				
1	01-03(R)	0010	R1-1	II	-	30	30	1	-	-	-	5.18	-	1	1	REMOVE AND REPLACE
10-04 R		0010	SPECIAL	II	MAPLE ST	-	-	-	-	-	-	-	1	-	-	REMOVE AND RESET
1   15   1   2   2   2   2   3   15   1   3   2   2   2   3   3   3   5   5   5   5   5   5   5		0010	SPECIAL	II	E CHESTNUT ST	-	-	-	-	-	-	-	1	-	-	REMOVE AND RESET
1   15   1   2   2   2   2   3   15   1   3   2   2   2   3   3   3   5   5   5   5   5   5   5	04.04(D)	0040	10.4		NODTI	0.4	00					0.00		4	4	
12-0   12-0	01-04(R)	0010	J2-1	"		24	36	-	-	1	-	6.00	-	1	1	<del>-</del>
01-05		0040	10.0	"		40	20					12.00				
01-05 010		0010	J2-2	"		48	30	-	-	-	-	12.00	-	-	-	-
01-06(R) 010					[32] [37]											
01-06(R) 010	01-05	0010	R7-1-D		_	18	24	1	-	-	=	3.00	-	-	=	-
010	01-06(R)	0010	R2-1	II	SPEED LIMIT 30	24	30	1	-	-	-	5.00	-	1	1	-
01-07 (R) 010 R1-1	, ,		R7-1-D	II	-	18		-	-	-	-	3.00	-	-	-	-
01-09R 0010 REMOVE II SPEED LIMT 30	01-07(R)	0010	R1-1	II	-	30	30	1	-	-	-	5.18	-	1	1	-
01-09R 0010 REMOVE II SPEED LIMT 30																
01-10 010 REMOVE II R7-6-12 01-10 010 RF-1-D II				II		18	24	1	-	-	-	3.00	-	-	-	
01-10 010 R7-1-D II - 18 24 1 - 18 24 1 - 3.00 - 3.00 - 5 - 5 - 5 - 5 - 5 - 5 - 5 - 5 - 5 -	01-09R				SPEED LIMIT 30	-	-	-	-	-	-	-	-	1	-	
02-01(R) 010					-	-	-	-	-	-	=	-	-	-	-	R7-6-12
1	01-10	0010	R7-1-D	ll .	-	18	24	1	-	-	-	3.00	-	-	-	
1	02-01(R)	0010	.12-1	Ш	JCT	24	36	_	1	-	_	6.00	_	1	1	_
02-02         0010         R2-1         II         SPEED LIMIT 30         24         30         1         -         -         -         5.00         -         -         -         -         -           02-03         0010         R1-1         -         -         30         30         1         -         -         5.18         - </td <td>02 01(14)</td> <td>0010</td> <td>02 1</td> <td> II</td> <td></td> <td>2.</td> <td>00</td> <td></td> <td>•</td> <td></td> <td></td> <td>0.00</td> <td></td> <td></td> <td>,</td> <td></td>	02 01(14)	0010	02 1	 II		2.	00		•			0.00			,	
02-04 0010 R1-1 II	02-02	0010	R2-1	 II		24	30	1	-	-	<u>=</u>	5.00	=	<u>-</u>	<u>=</u>	-
02-04 0010 R1-1 II																
0010 SPECIAL II ELM'ST - 1 1 1 2 1 1 1 1 1 1 1 1 1 1 1 1 1 1 1					-	30	30	1	-	-	-	5.18	-	-	-	
0010   SPECIAL   II   ECHESTNUT ST   -   -   -   -   -   -   -   MOVE     0010   REMOVE   II   SPEED LIMIT 30   -   -   -   -   -   -   -   -   -	02-04			II	-	-	-	-	-	-	-	-	-	1	1	
02-05R 0010 REMOVE II SPEED LIMIT 30 1 - R2-1 R7-6-12				II		-	-	1	-	-	-	-	1	-	-	
0010 REWOVE II R7-6-12		0010	SPECIAL	II	E CHESTNUT ST	-	-	-	-	-	-	-	1	-	-	MOVE
0010 REWOVE II R7-6-12	02 0EB	0010	DEMOV/E	п	SDEED LIMIT 20									1		D2 1
	02-05K			II		-	-	-	-	-	-	-	-	-	-	
	(D) DEMOTE			CAMELOCATION			TOTALO	-	-		<u> </u>		-	- 40	-	K1-0-12

PROJECT NO: 4100-31-71	HWY: USH 151	COUNTY: CALUMET	MISCELLANEOUS QUANTITIES	SHEET	Е
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## **EROSION CONTROL**

	ERU	SION CONTI	ROL	
			ITEM 628.7005	ITEM 628.7015
			INLET	INLET
			PROTECTION	PROTECTION
			TYPE A	TYPEC
LOCA	ATION	CATEGORY	(EA)	(EA)
Begin Project	RT	0010	-	1
STA 211+40	RT	0010	1	1
STA 211+40	LT	0010	-	1
STA 212+00	LT	0010	1	1
STA 212+00	RT	0010	-	1
STA 213+53	LT (MAPLE ST)	0010	-	1
STA 214+02	RT	0010	-	1
STA 214+03	LT	0010	-	1
STA 216+00	RT	0010	-	1
STA 216+05	LT	0010	-	1
STA 218+15	LT (ELM ST)	0010	-	1
STA 218+38	RT	0010	-	1
STA 218+47	LT (ELM ST)	0010	-	1
End Project	LT	0010	-	1
End Project	RT	0010	-	1
WATER MAIN EX	TENSION	0010	-	1
UNDISTI	RIBUTED	0010	1	7
	TOTALS		3	23

## **EROSION CONTROL MOBILIZATION & RESTORATION**

						LIZATION & RES				
			ITEM 618.0100	ITEM 624.0100	ITEM 628.1905	ITEM 628.1910	629.0205	630.0140	ITEM 631.0300	ITEM 631.1000
			MAINTENANCE	WATER	MOBILIZATIONS	MOBILIZATIONS	FERTILIZER	SEEDING	SOD WATER	SOD LAWN
			AND REPAIR		EROSION	<b>EM ERGENCY</b>	TYPE A	MIXTURE		
			OF HAUL ROADS		CONTROL	EROSION		NO. 40		
			(4100-31-71)			CONTROL				
LOC	ATION	CATEGORY	`(EACH)	(MGAL)	(EA)	(EA)	(CWT)	(LB)	(MGAL)	(SY)
211+13	to 218+69	0010	1	15	2	2	56	3	13	540
218+69	to 221+21	0010	-	-	-	-	1	1	1	9
LINDIST	TRIBUTED	0010		1		_		_	1	34
UNDIST				<u> </u>						
	TOTALS		1	16	2	2	57	4	15	583

## TRAFFIC CONTROL

						TRAFFIC	ONTINOL									
			TR.	ITEM 643.0300 TRAFFIC CONTROL DRUMS		TRAFFIC TRAFFIC CONTROL		AFFIC NTROL RICADES	ITEM 643.0420 TRAFFIC CONTROL BARRICADES TYPE III *		ITEM 643.0705 TRAFFIC CONTROL WARNING LIGHTS TYPE A		ITEM 643.0715 TRAFFIC CONTROL WARNING LIGHTS TYPE C		ITEM 643.0900 TRAFFIC CONTROL SIGNS	
	CATEGORY	DURATION CALANDAR DAYS	#	(DAYS)	#	(DAYS)	#	(DAYS)	#	(DAYS)	#	(DAYS)	#	(DAYS)		
TOTAL PROJECT	0010	122	32	3904	24	2928	20	2440	57	6954	9	1098	37	4514		
UNDISTRIBUTED	0010			70		142		130		306		120		96		
		TOTALS		3,974		3,070		2,570		7,260		1,218		4,610		

\*ADDITIONAL ITEMS LISTED ELSEWHERE

PROJECT NO: 4100-31-71	HWY: USH 151	COUNTY: CALUMET	MISCELLANEOUS QUANTITIES	SHEET	Е
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## TRAFFIC CONTROL DETOUR SIGN SUMMARY

						643. 3000	643. 0420	643. 0705	643. 1050	643. 0920	
					APPROX.	DETOUR	BARRI CADES	WARNI NG	SI GNS	COVERI NG	
	CATEGORY 0010			NUMBER	SERVI CE	SI GNS	TYPE III	LI GHTS	PORTABLE	SI GNS	
SI GN		SIGN	SI ZE	IN	PERI OD		*	TYPE A	CHANGEABLE	TYPE II	
					122			*	MESSAGE		
NO.	LOCATI ON	CODE	WXH	SERVI CE	DAYS	DAYS	DAYS	DAYS	DAYS	EACH	REMARKS
1	100' S OF MAPLE HEIGHTS ST ON HWY 32/57	W 20-1-G	48"x48"	1	122	122					
2A	IN FRONT OF J1-1 (JCT 151)	MO 4-8	24"x12"	1	122	122					
	" " "	MO 3-3	24"x12"	1	122	122					1-1
	и и и	M 1-4	24"x24"	1	122	122					151
0.0		MO 5-1-R	21"x21"	1	122	122					
2B	RT OF SIGN # 2A	MO 4-8	24"x12"	1	122	122					
	п п п	MO 3-1	24"x12"	1	122	122					22
	II II II	M 1-6B	24"x24" 24"x24"	1	122	122					32 57
	и и и	M 1-6			122	122					5/
		MO 5-1-R MO 4-8	21"x21" 24"x12"	1	122 122	122 122					
3	MODIFY J 2-3 (S-151-AH; 32/57/AH; N-151-AH RT)		EXI STI NG	I	122	122					
		MO 3-3 M 1-4	EXISTING EXISTING	1							151
		MO 5-1-R	21"x21"	1	122	122			1		151
4	MODIFY J 2-3 (S-151-AH; 32/57/AH; N-151-AH RT)	MO 4-8	24"x12"	1	122	122					
4	WODIFY J 2-3 (S-151-AH; 32/57/AH; N-151-AH RI)	MO 3-1	24 x12 24"x12"	1	122	122					1
	п п	M 1-6B	EXI STI NG	<u> </u>	122	122					32
	II II II	M 1-6	EXISTING								57
	II II II	MO 5-1-R	21"x21"	1	122	122					37
		WIO 3-1-K	21 721	'	122	122					AH-GREEN BAY/ FOND DU LAC; ONE
5	D 1-3 (AH-GREEN BAY/FOND DU LAC; MANITOWOC-RT)									1	CYCLE
6	MODOFY J 2-1 (151-AH & RT)	MO 4-8	24"x12"	1	122	122					OTOLL
	" " " "	MO 3-3	EXI STI NG	i i	122	122					
	п п п	M 1-4	EXI STI NG								151
	п п	MO 6-1	21"x21"	1	122	122					RI GHT
7	RT OF SIGN # 6	MO 4-8	24"x12"	1	122	122					
	п п п	MO 3-1	24"x12"	1	122	122					
	H H H	M 1-6B	24"x24"	1	122	122					32
	п п п	M 1-6	24"x24"	1	122	122					57
	н н н	MO 6-1	21"x21"	1	122	122					RI GHT
8	NE QUAD OF STH 32/57 (SOUTH LEG) & USH 151 (EAST LEG)	R 11-3	60"x30"	1	122	122	122	244			1/4 MILE
9	BELOW SIGN # 8	MO 4-9-R	30"x24"	1	122	122					
10	JV (SOUTH 151, NORTH-32/57)									1	SOUTH 151; NORTH-32/57; ONE CYCLE
11	J 3-3 (N-32-RT; N-57-RT; S-151-RT)									1	N-32-RT; N-57-RT; S-57-RT; ONE CYCLE
12	200' E OF STH 32/57 INTERSECTION ON USH 151 (EB)	MO 4-8	24"x12"	1	122	122					3.322
<u> </u>	" " "	MO 3-3	24"x12"	1	122	122					
	п п	M 1-4	24"x24"	1	122	122					151
	п п п	MO 6-1	21"x21"	1	122	122					AHEAD
13	RT OF SIGN # 12	MO 4-8	24"x12"	1	122	122					
	и и и	MO 3-1	24"x12"	1	122	122					
	и и и	M 1-6B	24"x24"	1	122	122					32
	и и и	M 1-6	24"x24"	1	122	122					57
	н н н	MO 6-1	21"x21"	1	122	122					AHEAD

CONTINUED FROM PREVIOUS SHEET

\* ADDITIONAL ITEMS LISTED ELSEWHERE

PROJECT NO: 4100-31-71	HWY: USH 151	COUNTY: CALUMET	MISCELLANEOUS QUANTITIES	SHEET	E
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						643. 3000	643. 0420	643. 0705	643. 1050	643. 0920	
					APPROX.	DETOUR	BARRI CADES	WARNI NG	SI GNS	COVERI NG	
	CATEGORY 0010			NUMBER	SERVI CE	SIGNS	TYPE III	LI GHTS	PORTABLE	SI GNS	
SI GN	STILL SOLID	SIGN	SI ZE	IN	PERI OD	0.0.10	*	TYPE A	CHANGEABLE	TYPE II	
0.00		0101	01 ZL		122			*	MESSAGE		
NO.	LOCATI ON	CODE	WXH	SERVI CE		DAYS	DAYS	DAYS	DAYS	EACH	REMARKS
1.4	D 1 1 (LT MILIMALIVEE, CDEEN DAY/FOND DILLAC DT)									1	GREEN BAY / FOND DU LAC-RT;
14	D 1-1 (LT-MILWAUKEE; GREEN BAY/FOND DU LAC-RT)									I	ONE CYCLE
15	J 2-3 (S-57-AH LT; S-151-AH RT; N-57-AH RT)									1	S-151-AH RT; N-57-AH RT;
											ONE CYCLE
16	J 1-2 (JCT 32; JCT 57)	MO 4-8-A	24"x18"	2	122	244					
	" "	M 50-2	EXI STI NG								32/57
17	100' E OF VOGT ST INTERSECTION ON USH 151 (EB)	MO 4-8	24"x12"	1	122	122					
	" " "	MO 3-3	24"x12"	1	122	122					
	п п	M 1-4	24"x24"	1	122	122					151
	II II II	MO 5-1-L	21"x21"	1	122	122					
18	RT OF SIGN # 17	MO 4-8	24"x12"	1	122	122					
	п п	MO 3-1	24"x12"	1	122	122					
	п п	M 1-6B	24"x24"	1	122	122					32
	п п	M1-6	24"x24"	1	122	122					57
	п п	MO 5-1-L	21"x21"	1	122	122					
19	@ BEGINNING OF LT TURN LANE ON HWY 151 EB	MO 4-8	24"x12"	1	122	122					
	и и и	MO 3-3	24"x12"	1	122	122					
	п п п	M 1-4	24"x24"	1	122	122					151
	и и и	MO 6-1	21"x21"	1	122	122					LEFT
20	RT OF SIGN # 19	MO 4-8	24"x12"	1	122	122					
	и и и	MO 3-1	24"x12"	1	122	122					
	н н н	M 1-6B	24"x24"	1	122	122					32
	н н н	M 1-6	24"x24"	1	122	122					57
	п п п	MO 6-1	21"x21"	1	122	122					LEFT
	NE QUAD OF HWY 151 & IRISH RD INTERSECTION (FACING EB										
21	TRAFFIC)	MO 4-8	24"x12"	1	122	122					
	п п п	MO 3-3	24"x12"	1	122	122					
	н н н	M 1-4	24"x24"	1	122	122					151
	и и и	MO 6-1	21"x21"	1	122	122					LEFT
22	RT OF SIGN # 21	MO 4-8	24"x12"	1 1	122	122					
	и и и	MO 3-1	24"x12"	1	122	122					
	п п п	M 1-6B	24"x24"	1	122	122					32
	и и и	M 1-6	24"x24"	1	122	122					57
	и и и	MO 6-1	21"x21"	1	122	122					LEFT
23	NW QUAD OF USH 151 & IRISH RD INTERSECTION	R 11-3	60"x30"	1	122	122	122	244			1 MILE
24	BELOW SI GN # 23	MO 4-9-R	30"x24"	1	122	122					22
25	WITH SIGN # 21 (FACING WB TRAFFIC)	MO 4-8	24"x12"	1	122	122	1				
	" " "	MO 3-3	24"x12"	1	122	122					
	п п	M 1-4	24"x24"	1	122	122					151
	11 11 11	MO 6-1	21"x21"	1	122	122					RI GHT
26	WITH SIGN # 22 (FACING WB TRAFFIC)	MO 4-8	24"x12"	1	122	122					N. OITI
20		MO 3-1	24"x12"	1	122	122	<del>                                     </del>				
	н н н	M 1-6B	24"x24"	1	122	122	<del>                                     </del>				32
	п п п	M 1-6	24"x24"	1	122	122					57
<del>     </del>	н н н	MO 6-1	21"x21"	1	122	122	<del>                                     </del>				RI GHT
CONTINUE	D FROM PREVIOUS SHEET	1110 0 1	21 NZ1	<del>'</del>	122	122	+	* ADDITION	AL ITEMS LIS	TED ELSEWHE	

CONTINUED FROM PREVIOUS SHEET

\* ADDITIONAL ITEMS LISTED ELSEWHERE

PROJECT NO: 4100-31-71	HWY: USH 151	COUNTY: CALUMET	MISCELLANEOUS QUANTITIES	SHEET	Ε
			<u> </u>		

				T		643. 3000	643. 0420	643. 0705	643. 1050	643. 0920	
					APPROX.	DETOUR	BARRI CADES	WARNI NG	SI GNS	COVERI NG	 
	CATEGORY 0010			NUMBER	SERVI CE	SIGNS	TYPE III	LI GHTS	PORTABLE	SI GNS	 
SI GN	5/11 <u>2</u> 55/11 55/15	SI GN	SI ZE	IN	PERI OD	01 0110	*	TYPE A	CHANGEABLE	TYPE II	 
0.0		0. 0.1	0.22		122			*	MESSAGE		 
NO.	LOCATI ON	CODE	WXH	SERVI CE	DAYS	DAYS	DAYS	DAYS	DAYS	EACH	REMARKS
27	SW QUAD OF USH 151 & IRISH RD INTERSECTION (FACING WB	MO 4-8	24"x12"	1	122	122					
	TRAFFIC)			1							
	11 11 11	MO 3-3 M 1-4	24"x12" 24"x24"	1 1	122 122	122 122					151
	п п		24 x24 21"x21"	1	122	122			1		RI GHT
28	RT OF SIGN # 27	MO 6-1 MO 4-8	24"x12"	1	122	122					RIGHI
20	KI OF 310N # 27	MO 3-1	24"x12"	1 1	122	122					
	0 0 0	M 1-6B	24" x24"	1 1	122	122					32
	и и и	M 1-6	24"x24"	1	122	122					57
	и и и	MO 6-1	21"x21"	1	122	122					RI GHT
29	500' E OF SIGN # 25 ON USH 151 WB	MO 4-8	24"x12"	1	122	122					KI GITI
	" " " "	MO 3-3	24"x12"	1	122	122					
	11 11 11	M 1-4	24"x24"	1	122	122					151
	п п п	MO 5-1-R	21"x21"	1	122	122					
30	RT OF SIGN # 29	MO 4-8	24"x12"	1	122	122					
- 00	" " "	MO 3-1	24"x12"	1	122	122					
	и и п	M 1-6B	24"x24"	1	122	122					32
	п п	M 1-6	24"x24"	1	122	122					57
	п п п	MO 5-1-R	21"x21"	1	122	122					
31	400' E OF SIGN # 29 ON USH 151 WB	WO 20-2-A	48"x48"	1	122	122					
32	200' N OF HWY 151 INTERSECTION ON IRISH RD	MO 4-8	24"x12"	1	122	122					
	п п п	MO 3-3	24"x12"	1	122	122					
	11 11 11	M 1-4	24"x24"	1	122	122					151
	п п п	MO 6-1	21"x21"	1	122	122					AHEAD
33	RT OF SIGN # 32	MO 4-8	24"x12"	1	122	122					
	и и п	MO 3-1	24"x12"	1	122	122					
	и и п	M 1-6B	24"x24"	1	122	122					32
	н н	M 1-6	24"x24"	1	122	122					57
	п п	MO 6-1	21"x21"	1	122	122					AHEAD
34	200' W OF IRISH RD INTERSECTION ON HWY 151 (WB)	MO 4-8	24"x12"	1	122	122					
	11 11 11	MO 3-3	24"x12"	1	122	122					
	" " "	M 1-6B	24"x24"	1	122	122					32
	0 0	M 1-6	24"x24"	1	122	122					57
6-	" " " " " " " " " " " " " " " " " " "	MO 6-1	21"x21"	1 1	122	122					AHEAD
35	RT OF STOP SIGN (SB IRISH RD @ HWY 151)	MO 3-1	24"x12"	1	122	122	1		1		
	" " "	M 1-4	24"x24"	1	122	122	1				151
27		MO 6-1	21"x21"	1	122	122			<del>                                     </del>		LEFT
36	RT OF SIGN # 35	MO 4-8	24"x12"	1	122	122	-		-		
	n n n	MO 3-3	24"x12" 24"x24"	1 1	122 122	122 122	-		-		32
	и и и	M 1-6B		1					+		57
	п п п	M 1-6 MO 6-1	24"x24" 21"x21"	1 1	122 122	122 122			+		81 GHT
37	500' N OF SIGN # 35 ON SB IRISH RD	MO 4-8-A	24"x18"	1	122	122	1		<del>                                     </del>		KI OHI
31	500 N OF SIGN # 35 ON SB IRISH RD	M 1-4	24 X18 24"x24"	1	122	122	<del> </del>		<del>                                     </del>		151
38	RT OF SIGN # 37	MO 4-8	24" x12"	1	122	122	†		<del>                                     </del>		131
30	KI OI 310N # 31	MO 3-3	24" x12"	1	122	122					i
		M 1-6B	24" x24"	1 1	122	122					32
		M 1-6	24"x24"	1	122	122					57
	11 11 11	MO 5-1-R	21"x21"	1 1	122	122					
CONTINUI	I FD FROM PREVIOUS SHEET	0 1 10	21 AZI	'	122	122		* ADDITION	AL ITEMS IIS	TED ELCEWIE	DE

CONTINUED FROM PREVIOUS SHEET

\* ADDITIONAL ITEMS LISTED ELSEWHERE

PROJECT NO: 4100-31-71 HWY: USH 151 COUNTY: CALUMET MISCELLANEOUS QUANTITIES SHEET E

					APPROX.	643. 3000 DETOUR	643. 0420 BARRI CADES	643. 0705 WARNI NG	643. 1050 SI GNS	643. 0920 COVERI NG	
	CATEGORY 0010			NUMBER	SERVI CE	SI GNS	TYPE III	LI GHTS	PORTABLE	SI GNS	I
SIGN		SIGN	SI ZE	I N	PERI OD 122		*	TYPE A	CHANGEABLE MESSAGE	TYPE II	
NO.	LOCATI ON	CODE	W X H	SERVI CE	DAYS	DAYS	DAYS	DAYS	DAYS	EACH	REMARKS
39	200' N OF CLAY ST INTERSECTION ON IRISH RD	MO 4-8	24"x12"	1	122	122	57110	271.0	57110	271011	TEM INTO
<u> </u>	" " "	MO 3-3	24"x12"	1	122	122					i
	и и и	M 1-4	24"x24"	1	122	122					151
	и и и	MO 6-1	21"x21"	1	122	122					AHEAD
40	RT OF SIGN # 39	MO 4-8	24"x12"	1	122	122					7 TIE TO
40	II II II	MO 3-1	24"x12"	1	122	122					
	и и и	M 1-6B	24"x24"	1	122	122					32
	п п п	M 1-6	24"x24"	1	122	122	1				57
	п п п	MO 6-1	21"x21"	1	122	122	1				AHEAD
41	250' S OF MILL ST (NORTH LEG) ON IRISH RD	MO 4-8	24"x12"	1	122	122					ALIEAD
41	250 3 OI WILL 31 (NORTH LEG) ON TRISH RD	MO 3-3	24 X12 24"x12"	1	122	122					
	п п	M 1-4	24 X12 24"x24"	1	122	122	1				151
	п п	M 1-4 MO 5-1-L	24 x24 21"x21"	1	122	122					101
40	DT OF CLON # 44										1
42	RT OF SIGN # 41	MO 4-8	24"x12"	1	122	122					
		MO 3-1	24" x12"	1	122	122					
	и и и	M 1-6B	24"x24"	1	122	122					32
		M 1-6	24"x24"	1	122	122					57
		MO 5-1-L	21"x21"	1	122	122					
43	500' S OF BREED ST ON IRISH RD	MO 4-8	24"x12"	1	122	122					<u> </u>
	u u u	MO 3-1	24"x12"	1	122	122					
	H H H	M 1-4	24"x24"	1	122	122					151
		MO 6-1	21"x21"	1	122	122					AHEAD
44	RT OF SIGN # 43	MO 4-8	24"x12"	1	122	122					
	11 11 11	MO 3-3	24"x12"	1	122	122					
	п п	M 1-6B	24"x24"	1	122	122					32
	п п	M 1-6	24"x24"	1	122	122					57
	и и и	MO 6-1	21"x21"	1	122	122					AHEAD
45	RT OF STOP SIGN (IRISH RD & BREED ST INTERSECTION)	MO 4-8	24"x12"	1	122	122					
	п п	MO 3-3	24"x12"	1	122	122					1
	и и и	M 1-4	24"x24"	1	122	122					151
	и и и	MO 6-1	21"x21"	1	122	122					LEFT
46	RT OF SIGN # 45	MO 4-8	24"x12"	1	122	122					
	и и п	MO 3-1	24"x12"	1	122	122					
	н н н	M 1-6B	24"x24"	1	122	122					32
	п п	M 1-6	24"x24"	1	122	122					57
	п п	MO 6-1	21"x21"	1	122	122					LEFT
47	NW QUAD OF IRISH RD & BREED ST INTERSECTION (FACING NB $$\operatorname{TRAFFIC}$)$	MO 4-8	24"x12"	1	122	122					
	п п п	MO 3-3	24"x12"	1	122	122					
	п п п	M 1-4	24"x24"	1	122	122					151
	и и и	MO 6-1	21"x21"	1	122	122					LEFT
48	RT OF SIGN # 47	MO 4-8	24"x12"	1	122	122					
	п п п	MO 3-1	24"x12"	1	122	122					
	п п	M 1-6B	24"x24"	1	122	122					32
	п п	M 1-6	24"x24"	1	122	122					57
	н н н	MO 6-1	21"x21"	1	122	122					LEFT
CONTI NI IE	ED FROM PREVIOUS SHEET						1	* ADDITION	AL ITEMS LIS	TED ELSEWHE	

ADDITIONAL ITEMS LISTED ELSEWHERE CONTINUED FROM PREVIOUS SHEET

SHEET Ε PROJECT NO: 4100-31-71 HWY: USH 151 COUNTY: CALUMET MISCELLANEOUS QUANTITIES

PLOT DATE : \_ PLOT SCALE: 1:1 FILE NAME : \_ PLOT BY : \_ PLOT NAME : \_\_\_ ORIGINATOR : DIST \_ ORG DATE : \_\_\_

					APPROX.	643. 3000 DETOUR	643. 0420 BARRI CADES	643. 0705 WARNI NG	643. 1050 SI GNS	643. 0920 COVERI NG	
	CATEGORY 0010			NUMBER	SERVI CE	SI GNS	TYPE III	LI GHTS	PORTABLE	SI GNS	
SI GN		SI GN	SI ZE	ΙN	PERI OD		*	TYPE A	CHANGEABLE	TYPE II	
					122			*	MESSAGE		
NO.	LOCATI ON	CODE	WXH	SERVI CE	DAYS	DAYS	DAYS	DAYS	DAYS	EACH	REMARKS
49	250' W OF IRISH RD INTERSECTION ON BREED ST	MO 4-8	24"x12"	1	122	122					
	и и и	MO 3-3	24"x12"	1	122	122					
	и и и	M 1-4	24"x24"	1	122	122					151
	и и и	MO 6-1	21"x21"	1	122	122					AHEAD
50	RT OF SIGN # 49	MO 4-8	24"x12"	1	122	122					
	и и и	MO 3-1	24"x12"	1	122	122					
	и и и	M 1-6B	24"x24"	1	122	122					32
	н н	M 1-6	24"x24"	1	122	122					57
	и и и	MO 6-1	21"x21"	1	122	122					AHEAD
51	NE QUAD OF BREED ST & IRISH RD INTERSECTION	MO 4-8	24"x12"	1	122	122					
	и и и	MO 3-1	24"x12"	1	122	122					
	н н н	M 1-4	24"x24"	1	122	122					151
	н н н	MO 6-1	21"x21"	1	122	122					RI GHT
52	RT OF SIGN # 51	MO 4-8	24"x12"	1	122	122					
	н н н	MO 3-3	24"x12"	1	122	122					
	п п п	M 1-6B	24"x24"	1	122	122					32
	и и и	M 1-6	24"x24"	1	122	122					57
	и и и	MO 6-1	21"x21"	1	122	122					RI GHT
53	SW QUAD OF BREED ST & IRISH RD INTERSECTION	MO 4-8	24"x12"	1	122	122					
	и и и	MO 3-1	24"x12"	1	122	122					
	н н н	M 1-4	24"x24"	1	122	122					151
	и и и	MO 6-1	21"x21"	1	122	122					RIGHT
54	RT OF SIGN # 53	MO 4-8	24"x12"	1	122	122					
	и и и	MO 3-3	24"x12"	1	122	122					
	и и и	M 1-6B	24"x24"	1	122	122					32
	и и и	M 1-6	24"x24"	1	122	122					57
	и и и	MO 6-1	21"x21"	1	122	122					RI GHT
55	500' W OF SIGN # 53 ON BREED ST (EB)	MO 4-8	24"x12"	1	122	122					
	" " "	MO 3-1	24"x12"	1	122	122					
	и и и	M 1-4	24"x24"	1	122	122					151
	и и и	MO 5-1-R	21"x21"	1	122	122					
56	RT OF SIGN # 55	MO 4-8	24"x12"	1	122	122					
	II II II	MO 3-3	24"x12"	1	122	122			1		
	и и и	M 1-6B	24"x24"	1	122	122					32
	н н н	M 1-6	24"x24"	1	122	122					57
	и и п	MO 5-1-R	21"x21"	1	122	122					]
57	100' W OF SPRING ST ON BREED ST (WB)	MO 4-8	24"x12"	1	122	122					
3,	" " " " " "	MO 3-3	24"x12"	1	122	122					
<del>                                     </del>	и и и	M 1-4	24"x24"	1	122	122					151
<del>                                     </del>	н н н	MO 5-1-L	21"x21"	1	122	122					131
58	RT OF SIGN # 57	MO 4-8-A	24"x12"	1	122	122					
50	KI OF SIGN # 57	M 1-6B	24 X12 24"x24"	1	122	122					32
	п п п	M 1-6B	24 x24 24"x24"	1	122	122	+		<del> </del>		57
CONTINUED	FROM PREVIOUS SHEET	IVI I-O	Z4 XZ4	1 '	IZZ	122		* ADDITION	AL ITEMS IIS	TED ELCEWIE	

CONTINUED FROM PREVIOUS SHEET

\* ADDITIONAL ITEMS LISTED ELSEWHERE

PROJECT NO:	4100-31-71	HWY: USH 151	COUNTY: CALUMET	MISCELLANEOUS QUANTITIES	SHEET	Ε
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SIGN	CATEGORY 0010	SI GN	SI ZE	NUMBER I N	APPROX. SERVI CE PERI OD 122	643. 3000 DETOUR SI GNS	643. 0420 BARRI CADES TYPE III	643. 0705 WARNI NG LI GHTS TYPE A	643. 1050 SI GNS PORTABLE CHANGEABLE MESSAGE	643. 0920 COVERI NG SI GNS TYPE 11	
NO.	LOCATI ON	CODE	WХН	SERVI CE	DAYS	DAYS	DAYS	DAYS	DAYS	EACH	REMARKS
59	RT OF STOP SIGN (BREED ST & HWY 32/57 INTERSECTION)	MO 4-8	24"x12"	1	122	122					
	и и и	MO 3-3	24"x12"	1	122	122					
	п п	M 1-4	24"x24"	1	122	122					151
	п п	MO 6-1	21"x21"	1	122	122					LEFT
60	RT OF SIGN # 57	MO 3-1	24"x12"	1	122	122					
	п п п	M 1-6B	24"x24"	1	122	122					32
	п п	M 1-6	24"x24"	1	122	122					57
	п п	MO 6-1	21"x21"	1	122	122					RI GHT
61	200' E OF STH 32/57 INTERSECTION ON BREED ST (EB)	MO 4-8	24"x12"	1	122	122					
	п п п	MO 3-1	24"x12"	1	122	122					
	п п п	M 1-4	24"x24"	1	122	122					151
	п п п	MO 6-1	21"x21"	1	122	122					AHEAD
62	RT OF SIGN # 61	MO 4-8	24"x12"	1	122	122					
	п п п	MO 3-3	24"x12"	1	122	122					
	п п	M 1-6B	24"x24"	1	122	122					32
	п п п	M 1-6	24"x24"	1	122	122					57
	н н н	MO 6-1	21"x21"	1	122	122					AHEAD
63	SE QUAD OF HWY 32/57 & E BREED ST INTERSECTION	MO 4-8	24"x12"	1	122	122					
	п п п	MO 3-3	24"x12"	1	122	122					
	п п	M 1-6B	24"x24"	1	122	122					32
	и и и	M 1-6	24"x24"	1	122	122					57
	н н н	MO 6-1	21"x21"	1	122	122					LEFT
64A	BACKSIDE OF SIGN # 63 (FACING NB TRAFFIC)	MO 4-8	24"x12"	1	122	122					
	п п	MO 3-1	24"x12"	1	122	122					
	п п	M 1-4	24"x24"	1	122	122					151
	п п п	MO 6-1	21"x21"	1	122	122					RI GHT
64B	150' S OF SIGN # 64A ON HWY 32/57 (NB)	MO 4-5	24"x12"	1	122	122					
	11 11 11	MO 3-3	24"x12"	1	122	122					
	п п	M 1-6B	24"x24"	1	122	122					32
	н н	M 1-6	24"x24"	1	122	122					57
	п п	MO 6-1	21"x21"	1	122	122					RI GHT
65A	NW QUAD OF HWY 32/57 & W BREED ST INTERSECTION	MO 4-8	24"x12"	1	122	122					
	п п	MO 3-3	24"x12"	1	122	122					
	п п	M 1-6B	24"x24"	1	122	122					32
	п п	M 1-6	24"x24"	1	122	122					57
	п п	MO 6-1	21"x21"	1	122	122					LEFT
65B	150' N OF SIGN # 65A ON HWY 32/57 (SB)	MO 4-5	24"x12"	1	122	122					
	п п	MO 3-1	24"x12"	1	122	122					
	п п	M 1-4	24"x24"	1	122	122					151
	п п	M 5-1-L	21"x21"	1	122	122					
66	BACKSIDE OF SIGN # 65 (FACING NB TRAFFIC)	MO 4-8	24"x12"	1	122	122					
	п п	MO 3-1	24"x12"	1	122	122					
	п п	M 1-4	24"x24"	1	122	122					151
	и и и	MO 6-1	21"x21"	1	122	122			AL LITEMS LIS		RI GHT

CONTINUED FROM PREVIOUS SHEET

\* ADDITIONAL ITEMS LISTED ELSEWHERE

PROJECT NO: 4100-31-71 HWY: USH 151 COUNTY: CALUMET MISCELLANEOUS QUANTITIES SHEET E

						643. 3000	643. 0420	643. 0705	643. 1050	643. 0920	
					APPROX.	DETOUR	BARRI CADES	WARNI NG	SI GNS	COVERI NG	
	CATEGORY 0010			NUMBER	SERVI CE	SI GNS	TYPE III	LI GHTS	PORTABLE	SI GNS	
SI GN		SIGN	SI ZE	I N	PERI OD		*	TYPE A	CHANGEABLE	TYPE II	
					122			*	MESSAGE		
NO.	LOCATI ON	CODE	WXH	SERVI CE	DAYS	DAYS	DAYS	DAYS	DAYS	EACH	REMARKS
67A	SW QUAD OF STH 32/57 & BREED ST INTERSECTION	R 11-3	60"x30"	1	122	122	122	244			1/4 MILE
67B	BELOW SIGN # 67A	MO 4-9-R	30"x24"	1	122	122					
68	J4-2 (S-32; S-57)									1	S-32, S-57; ONE CYCLE
69A	500' N OF SIGN # 65 ON HWY 32/57 (SB)	MO 4-5	24"x12"	1	122	122					
	11 11 11	MO 3-1	24"x12"	1	122	122					
	п п	M 1-4	24"x24"	1	122	122					
	11 11 11	M 5-1-L	21"x21"	1	122	122					
69B	RT OF SIGN # 69A ON HWY 32/57 (SB)	MO 4-8	24"x12"	1	122	122					
	11 11 11	MO 3-3	24"x12"	1	122	122					
	н н	M 1-6B	24"x24"	1	122	122					32
	н н	M 1-6	24"x24"	1	122	122					57
	н н	MO 5-1-L	21"x21"	1	122	122					
70	500' N OF SIGN # 69 ON HWY 32/57 (SB)	WO 20-2-A	48"x48"	1	122	122					
71A	500' S OF SIGN # 64 ON HWY 32/57 (NB)	MO 4-8	24"x12"	1	122	122					
	и и и	MO 3-1	24"x12"	1	122	122					
	и и и	M 1-4	24"x24"	1	122	122					151
	н н	MO 5-1-R	21"x21"	1	122	122					
71B	150' S OF SIGN # 71A ON HWY 32/57 (NB)	MO 4-5	24"x12"	1	122	122					
	н н	MO 3-3	24"x12"	1	122	122					
	и и и	M 1-6B	24"x24"	1	122	122					32
	н н н	M 1-6	24"x24"	1	122	122					57
	и и и	MO 5-1-R	21"x21"	1	122	122					
72	J2-3 (N-151; S-32; S-57; AH)									1	S-32, S-57; ONE CYCLE
73	MODIFY J2-3 (N-151; S-32; S-57)	MO 4-8-A	24"x18"	1	122	122					
	и и и	M 1-4	EXI STI NG								
74	ABOVE J4-2 (N-32, N-57)	MO 4-8	24"x12"	1	122	122					
	11 11 11	MO 3-1	24"x12"	1	122	122					
	и и и	M 1-4	24"x24"	1	122	122					151
75	D 1-3 (AH- MILWAUKEE/MANITOWOC; FOND DU LAC-RT)									1	AH-MI LWAUKEE / MANI TOWOC; ONE CYCLE
76	SW QUAD OF STH 32/57 & HWY 151 INTERSECTION	R 11-3	60"x30"	1	122	122	122	244			1/4 MILE
77	MODI FY J2-2 (CTY Y-AH; 151-RT)	MO 4-8	24"x12"	1	122	122					
	п п п	MO 3-1	EXI STI NG								
	п п п	M 1-4	EXI STI NG								151
	п п п	MO 6-1	21"x21"	1	122	122					LEFT
78	MODIFY J2-1 (32/57-LT & RT)	MO 4-5	24"x12"	1	122	122					
	п п п	M 1-6B	EXI STI NG								32
	п п п	M 1-6	EXI STI NG								57
	п п п	MO 6-1	21"x21"	1	122	122					LEFT
	D EDOM DDEVIOUS SHEET				•	•		+ ADDITION	AL LITEMS LIG		

CONTINUED FROM PREVIOUS SHEET

\* ADDITIONAL ITEMS LISTED ELSEWHERE

PROJECT NO: 4100-31-71 HWY: USH 151	COUNTY: CALUMET	MISCELLANEOUS QUANTITIES	SHEET	Е
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					APPROX.	643. 3000 DETOUR	643. 0420 BARRI CADES	643. 0705 WARNI NG	643. 1050 SI GNS	643. 0920 COVERI NG	
	CATEGORY 0010			NUMBER	SERVI CE	SI GNS	TYPE III	LI GHTS	PORTABLE	SI GNS	
SIGN		SI GN	SI ZE	ΙN	PERI OD		*	TYPE A	CHANGEABLE	TYPE II	
					122			*	MESSAGE		
NO.	LOCATION	CODE	WXH	SERVI CE	DAYS	DAYS	DAYS	DAYS	DAYS	EACH	REMARKS
79	ABOVE J1-1 (JCT Y)	MO 4-8	24"x12"	1	122	122					
	и и и	MO 3-1	24"x12"	1	122	122					
	и и и	M 1-4	24"x24"	1	122	122					151
	и и и	MO 5-1-L	21"x21"	1	122	122					
80A	150' S OF SIGN # 79 ON HWY 151 (EB)	MO 4-5	24"x12"	1	122	122					
	и и и	MO 3-3	24"x12"	1	122	122					
	и и	M 1-6B	24"x24"	1	122	122					32
	н н	M 1-6	24"x24"	1	122	122					57
	н н	MO 5-1-L	21"x21"	1	122	122					
80B	150' W OF SIGN # 79 ON HWY 151 (EB)	WO 20-2-A	48"x48"	1	122	122					
81	J 4-3 (N-151; S-32; S-57)									1	N-151; S-32; S-57; ONE CYCLE
82	J 4-3 (N-151; S-32; S-57; AH LT)									1	N-151; S-32; S-57, AH LT; ONE CYCLE
83	J 4-3 (N-151; S-32; S-57; LT)									1	N-151; S-32; S-57, LT; ONE CYCLE
84	J2-2 (N-151-LT; G-AH)									1	N-151-LT; ONE CYCLE
85	FIELD DETERMINER (FACING SB TRAFFIC)			1					7		
86	FIELD DETERMINER (FACING NB TRAFFIC)			1				-	7		
	TOTAL			293		35,746	488	976	14	12	

CONTINUED FROM PREVIOUS SHEET \* ADDITIONAL ITEMS LISTED ELSEWHERE

PROJECT NO: 4100-31-71 HWY: USH 151 COUNTY: CALUMET MISCELLANEOUS QUANTITIES SHEET E

## 3

## ı

PLOT SCALE: 1:1

PAVEMENT MARKING

	IATE	VICIAL INIAIXIMIO		
		ITEM 646.0106	ITEM 647.0566	ITEM 647.0776
		PAVEMENT MARKING	PAVEMENT MARKING	PAVEMENT MARKING
		EPOXY 4-INCH	STOP LINE	CROSSWALK
			EPOXY 18-INCH	EPOXY 12-INCH
		YELLOW	WHITE	WHITE
LOCATION	CATEGORY	(LF)	(LF)	(LF)
211+14 TO 218+70	0010	1,253	-	-
INTERSECTION OF MAPLE ST AND E CHESTNUT	0010	-	30	290
INTERSECTION OF ELM ST AND E CHESTNUT	0010	-	15	220
UNDISTRIBUTED	0010	17	5	10
TOTALS		1,270	50	520

## CONSTRUCTION STAKING ITEMS

					ROOTION OTAL				
				ITEM 650.4000	ITEM 650.4500	ITEM 650.5500	ITEM 650.7000	ITEM 650.9910	ITEM SPV.0105.02
				CONSTRUCTION	CONSTRUCTION	CONSTRUCTION	CONSTRUCTION	CONSTRUCTION	CONSTRUCTION
				STAKING	STAKING	STAKING	STAKING	STAKING	STAKING
				STORM	SUBGRADE	CURB GUTTER	CONCRETE	SUPPLEMENTAL	WATER
				SEWER		AND	PAVEMENT	CONTROL	MAIN
						CURB & GUTTER		(4100-31-71)	
L	OCATION		CATEGORY	(EACH)	(LF)	(LF)	(LF)	(LS)	(LS)
211+13	to	218+69	0010	14	756	-	756	1	-
218+69	to	221+21	0010	-	-	45	-	-	-
218+69	to	221+21	0020	-	-	-	-	-	1
				-			-	-	-
UN	DISTRIBUTED		0010	-	75	20	75	-	-
	Т	OTALS		14	831	65	831	1	1

SAWING

		ITEM 690.0150 SAWING ASPHALT	ITEM 690.0250 SAWING CONCRETE
LOCATION	CATEGORY	(LF)	(LF)
211+13 to 218+6	9 0010	923	272
218+69 to 221+2	1 0010	540	10
UNDISTRIBUTED	0010	22	23
TOTALS	3	1,485	305

PROJECT NO: 4100-31-71 HWY: USH 151 COUNTY: CALUMET MISCELLANEOUS QUANTITIES SHEET E

## WATER MAIN ITEMS


				ITEM SPV.0060.01	ITEM SPV.0060.02	ITEM SPV.0060.03	ITEM SPV.0060.04	ITEM SPV.0060.05	ITEM SPV.0060.06	ITEM SPV.0060.07	ITEM SPV.0060.08	ITEM SPV.0060.09	ITEM SPV.0060.10	ITEM SPV.0060.11	ITEM SPV.0060.12
				ADJUSTING	ABANDON	REMOVE	CUT AND	TEE	BEND	BEND	REMOVE	WATER	CONNECT	WATER	WATER
				WATER	WATER	FIRE	PLUG EXISTING	8" X 6"	45-DEGREE 8"	45-DEGREE 6"	WATER	SERVICE	TO EXISTING	VALVE	VALVE
				VALVE	VALVE	HYDRANT	WATER MAIN			WITH	SERVICE	CURB	WATER MAIN	AND BOX	AND BOX
				BOXES			6-INCH			8" X 6"	CURB STOP	STOP		6-INCH	8-INCH
										REDUCER					
ı	OCATIO	N	CATEGORY	(EA)											
211+13	to	218+6	9 0020	1	1	1	1	1	1	1	8	7	2	1	-
218+69	to	221+2	1 0020	-	-	-	1	-	1	1	3	3	1	-	1
UN	DISTRIBU	TED	0020	-	-	-	-	-	8	-	-	-	-	-	-
		TOTAL	3	1	1	1	2	1	10	2	11	10	3	1	1

## WATER MAIN ITEMS CONTINUED

					ATEN MAINTIEN	IO GOITTINGED			
				ITEM SPV.0090.01	ITEM SPV.0090.02	ITEM SPV.0090.03	ITEM SPV.0090.04	ITEM SPV.0105.03	ITEM 203.0210.S.01
				WATER	WATER	WATER	REMOVING	TEMPORARY	ABATEMENT OF
				MAIN	MAIN	SERVICE	ASBESTOS	WATER	ASBESTOS
				6-INCH	8-INCH	1-INCH	WATER		CONTAINING
				PVC			MAIN*		MATERIAL
									WATER MAIN*
LO	CATION		CATEGORY	(LF)	(LF)	(LF)	(LF)	(LS)	(LS)
211+13	to	218+69	0020	7	760	249	25	1	1
218+69	to	221+21	0020	3	256	68	-	-	-
		_							
UNDIS	TRIBUTE	-D	0020	-	14	8	-	-	-
		TOTALS		10	1,030	325	25	1	1

<sup>\*</sup> APPROXIMATE QUANTITY OF 25 LF OF ABATEMENT OF ASBESTOS WATER MAIN AND REMOVING ASBESTOS WATER MAIN ASSUMED FOR ITEMS

PROJECT NO: 4100-31-71 HWY: USH 151 COUNTY: CALUMET MISCELLANEOUS QUANTITIES SHEET E

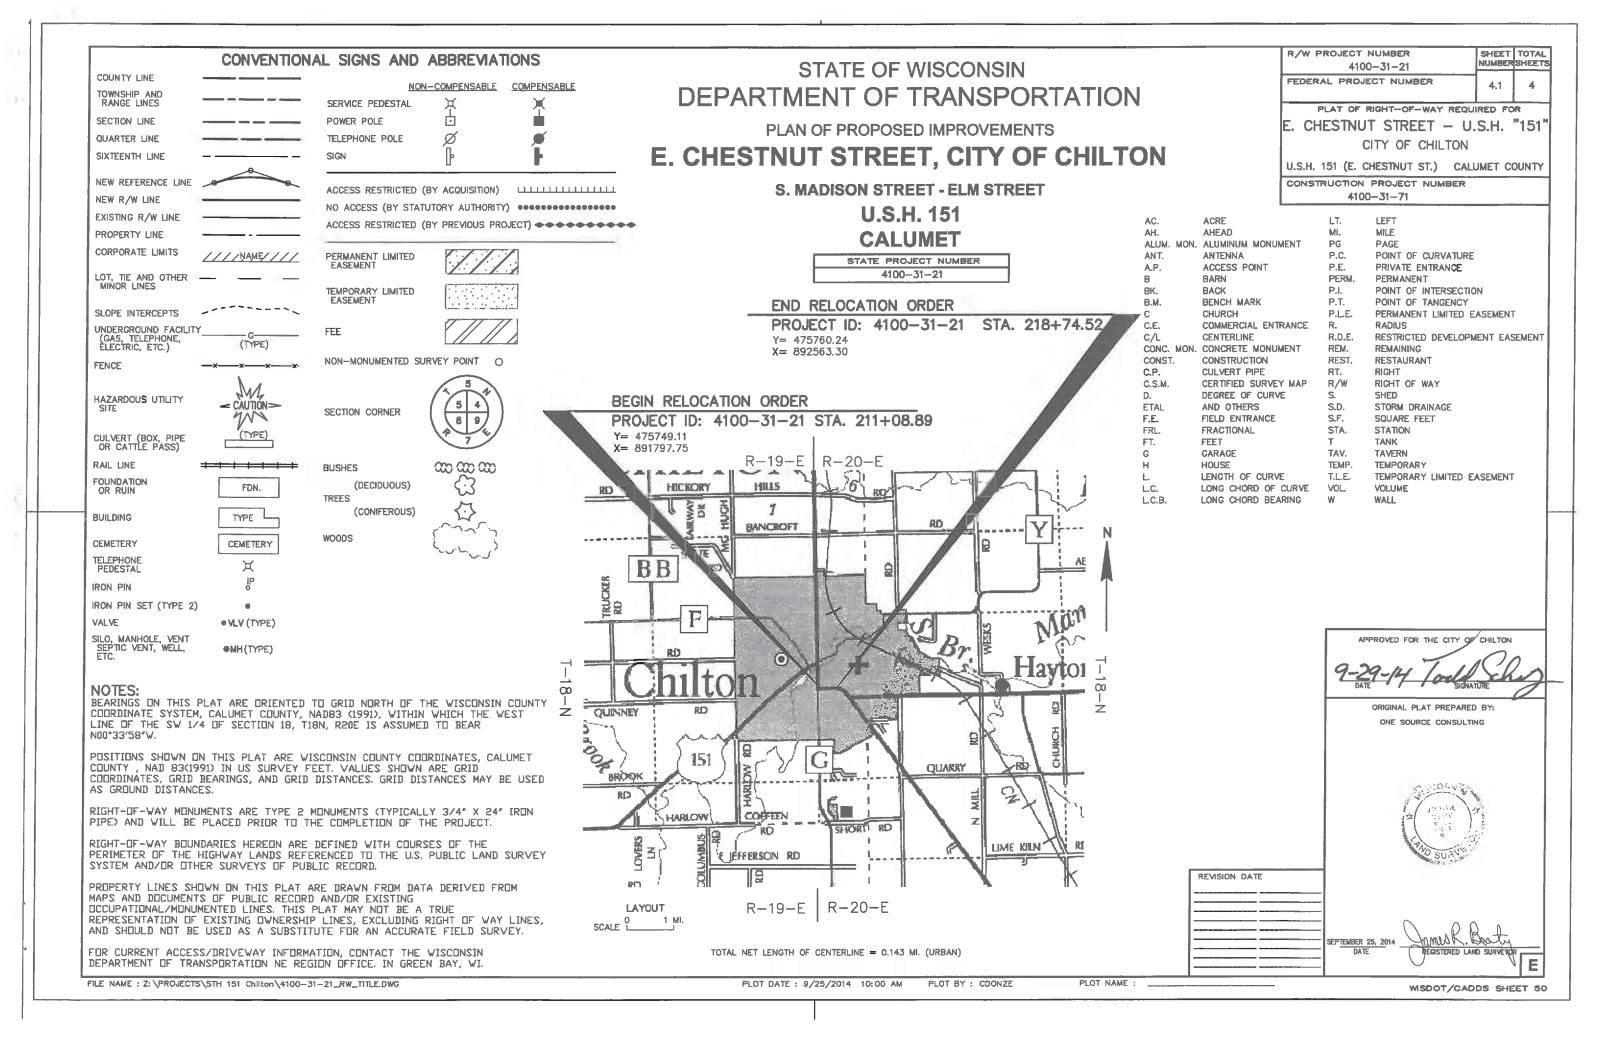


## SCHEDULE OF LANDS & INTERESTS REQUIRED

4

<u> </u>	DOLL OF LANDS & INTE	INESTS IN	LQUII	<u>. L D</u>		
PARCEL NUMBER	OWNER	INTEREST REQUIRED	TOTAL (ACRES)		P.L.E. REQ'D. (SQ. FT.)	
(-)	GREGOR PROPERTIES LLC	T.L.E.	1.64	.64 60.47 -		
2	CONVENIENCE STORE INVESTMENTS	T.L.E.	2.47	1514.51		
4	CHESTNUT STREET PROPERTIES INC	T.L.E.	1.499	1320.95		
(5)	CITY OF CHILTON (MAPLE ST. R.O.W)		0.88			
6	GREGOR PROPERTIES LLC	T.L.E.	0.22	214.50		
7	MUELLER, ERIK J	T.L.E. & P.L.E.	0.281	164.29	124.65	
8	HILBERT, WILLIAM E & JULIE A	T.L.E.	0.525	539.50		
(9)	PRODUCTIONCREDIT ASSN OF EAST	T.L.E.	0.31	682.50		
9	SCHLAEFER REVOC LIVING TRUST	T.L.E.	0.327	202.88		
(1)	WEBER DIL COMPANY	T.L.E.	0.313	736.46		
12	LA-TEC CREDIT UNION	T.L.E.	0.668	884.39		
(14)	PREMIER FINANCIAL CREDIT UNION	T.L.E.	0.840	1179.78		
17	WHALEY, JAMES A	T.L.E. & P.L.E.	0.778	1485.32	152.70	
<b>6</b>	WISCONSIN PUBLIC SERVICE	RELEASE OF RIGHTS				

OWNER'S NAMES ARE SHOWN FOR REFERENCE PURPOSES ONLY AND ARE SUBJECT TO CHANGE PRIOR TO THE TRANSFER OF LAND INTERESTS.

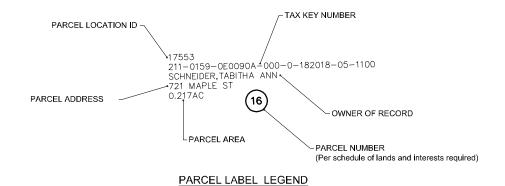



	COL	IRSE TABLE - T.L.E.
FROM	TO	IRSE TABLE — T.L.E.  BEARING DIST.
100	108	
108	115	
115	101	S 89°13'58" W 24.20'
101	100	N 00'46'02" W 6.50'
106	107	N 89*13'58" E 1.13'
107	103	S 00°33'58" E 6.50'
103	114	S 89'13'58" W 1.11'
114	106	N 00'46'02" W 6.50'
107	109	N 89°13'58" E 105.00'
109	112	S 00°33'58" E 6.50'
112	103	S 89°13'58" W 105.00'
109	110	N 89*13'58" E 83.00'
110	111	S 00°33'58" E 6.50'
111	112	S 89°13'58" W 83.00'
113	122	N 89*08'03" E 233.00'
122	121	S 00*33'58" E 6.50'
121	116	S 89°08'03" W 233.00'
116	113	N 00°33'58" W 6.50'
122	123	N 89*08'03" E 203.22'
123	124	S 00°41'28" E 6.50'
124	121	S 89°08'03" W 203.23'
123	125	N 89'08'03" E 33.00'
125	126	S 00°33'58" E 6.50'
126	124	S 89°08'03" W 33.00'
125	128	N 89'08'03" E 9.29'
128	127	S 00°51'57" E 6.50'
127	126	S 89°08'03" W 9.31'
134	133	N 00'33'58" W 20.00'
133	132	N 89'08'03" E 7.00'
132	131	S 00°33'58" E 13.00'
131	130	N 89.08'03" E 8.96'
		S 00°51'57" E 7.00'
130	129	
129	134	
139	140	N 00'33'58" W 6.50'
140	137	N 89'08'03" E 98.30'
137	136	N 00'33'58" W 13.00'
136	135	N 89'08'03" E 5.00'
135	138	S 00°33'58" E 19.50'
138	139	S 89*08'03" W 103.30'
139	143	S 89'08'03" W 136.09'
143	144	N 00'33'58" W 6.50'
144	140	N 89'08'03" E 136.09'
144	143	S 00°33'58" E 6.50'
143	147	S 89°08'03" W 173.81'
147	148	N 00°33′58″ W 16.50′
148	149	N 89°08'03" E 5.00'
149	150	S 00°33'58" E 10.00'
150	144	N 89*08'03" E 168.81'
155	160	N 00'46'02" W 6.50'
160	154	N 89*13'58" E 132.31'
154	153	N 00°33′58″ W 9.00′
153	151	N 89°13'58" E 5.00'
151	152	S 00°33'58" E 15.50'
152	155	S 89°13'58" W 137.29'
162	163	N 00°46'02" W 6.50
163	158	N 89°13'58" E 85.37'
158	157	S 00°46'02" E 6.50
157	162	S 89'13'58" W 84.18'
		2 30 10 00 11 01.10


	COURSE TABLE - P.L.E.									
FROM	TO	BEARING DIST.								
157	159	N 00°46'02" W 11.00'								
159	161	N 89*13'58" E 13.88'								
161	155	S 00°46'02" E 11.00'								
155	157	S 89*13'58" W 13.88'								
108	106	N 89*13'58" E 13.85'								
106	105	S 00°46'02" E 9.00'								
105	102	S 89*13'58" W 13.85'								
102	108	N 00°46'02" W 9.00'								


DATE SEPTEMBER 12, 2014 SCALE IN FEET HWY: U.S.H. 151 STATE R/W PROJECT NUMBER 4100-31-21 PLAT SHEET 4.02 COUNTY: CALUMET CONSTRUCTION PROJECT NUMBER 4100-31-71 PS&E SHEET — E

FILE NAME : 4100-31-21\_rw\_sht.dwg PLOT DATE : 9/12/2014 10:00 AM PLOT BY : CDONZE PLOT NAME : \_\_\_\_\_ WISDOT/CADDS SHEET 70

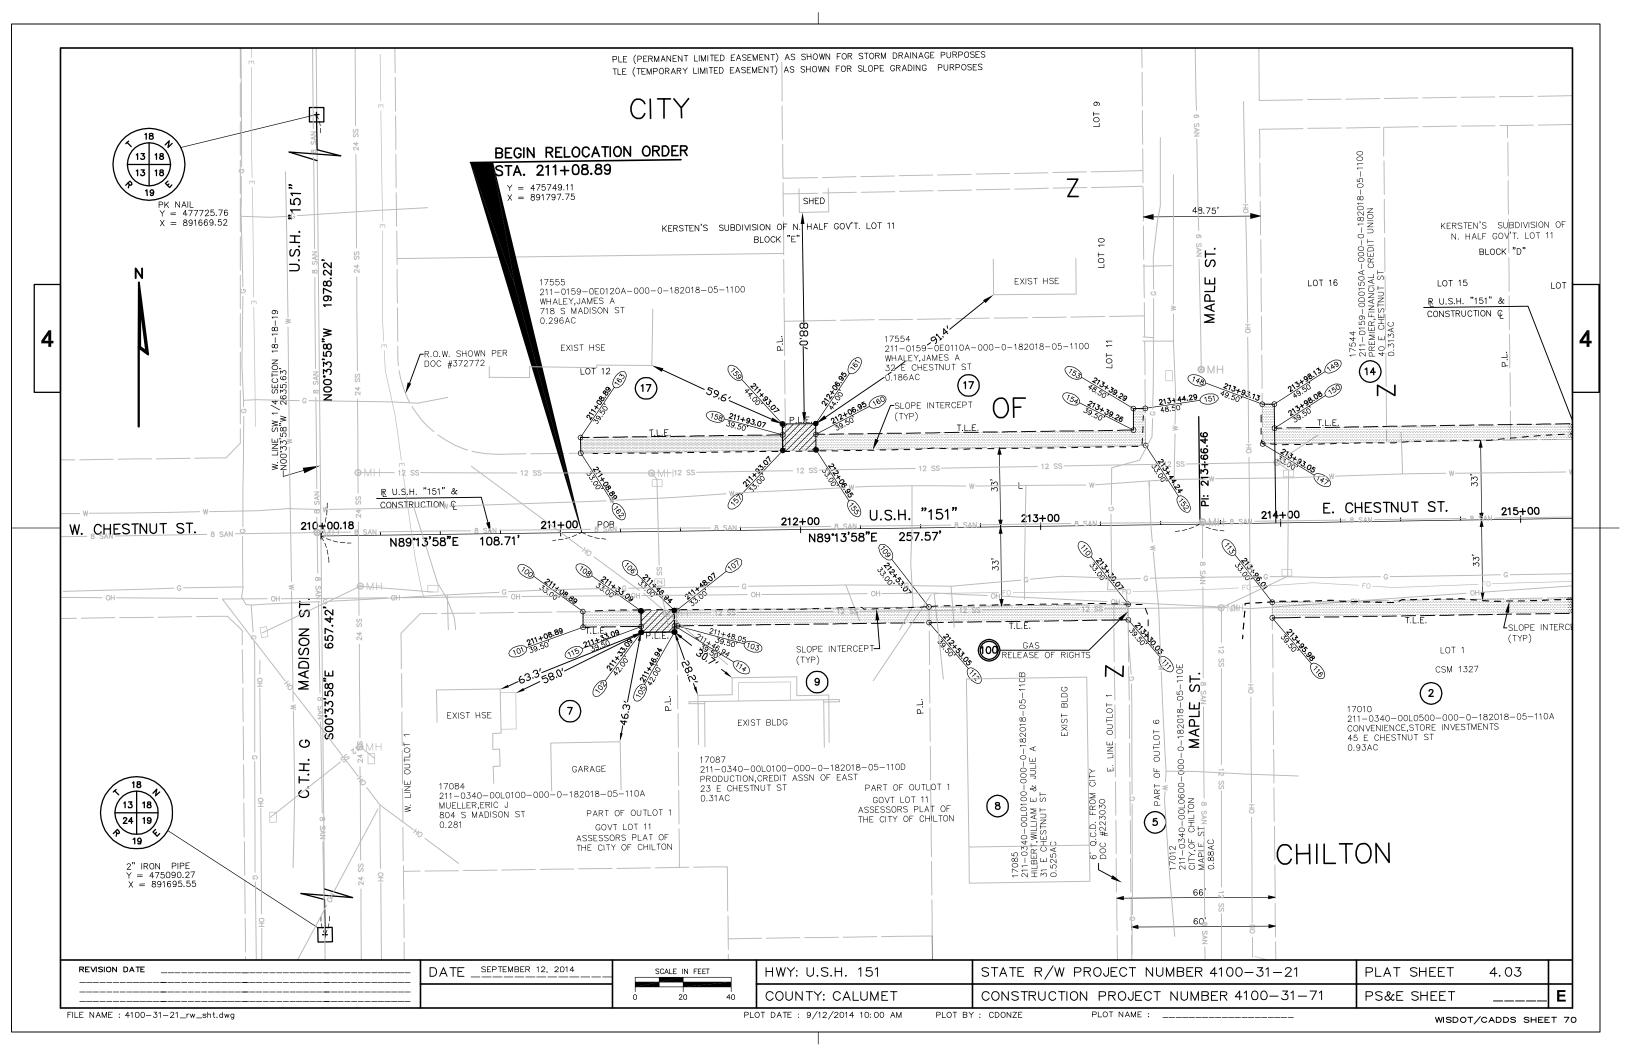

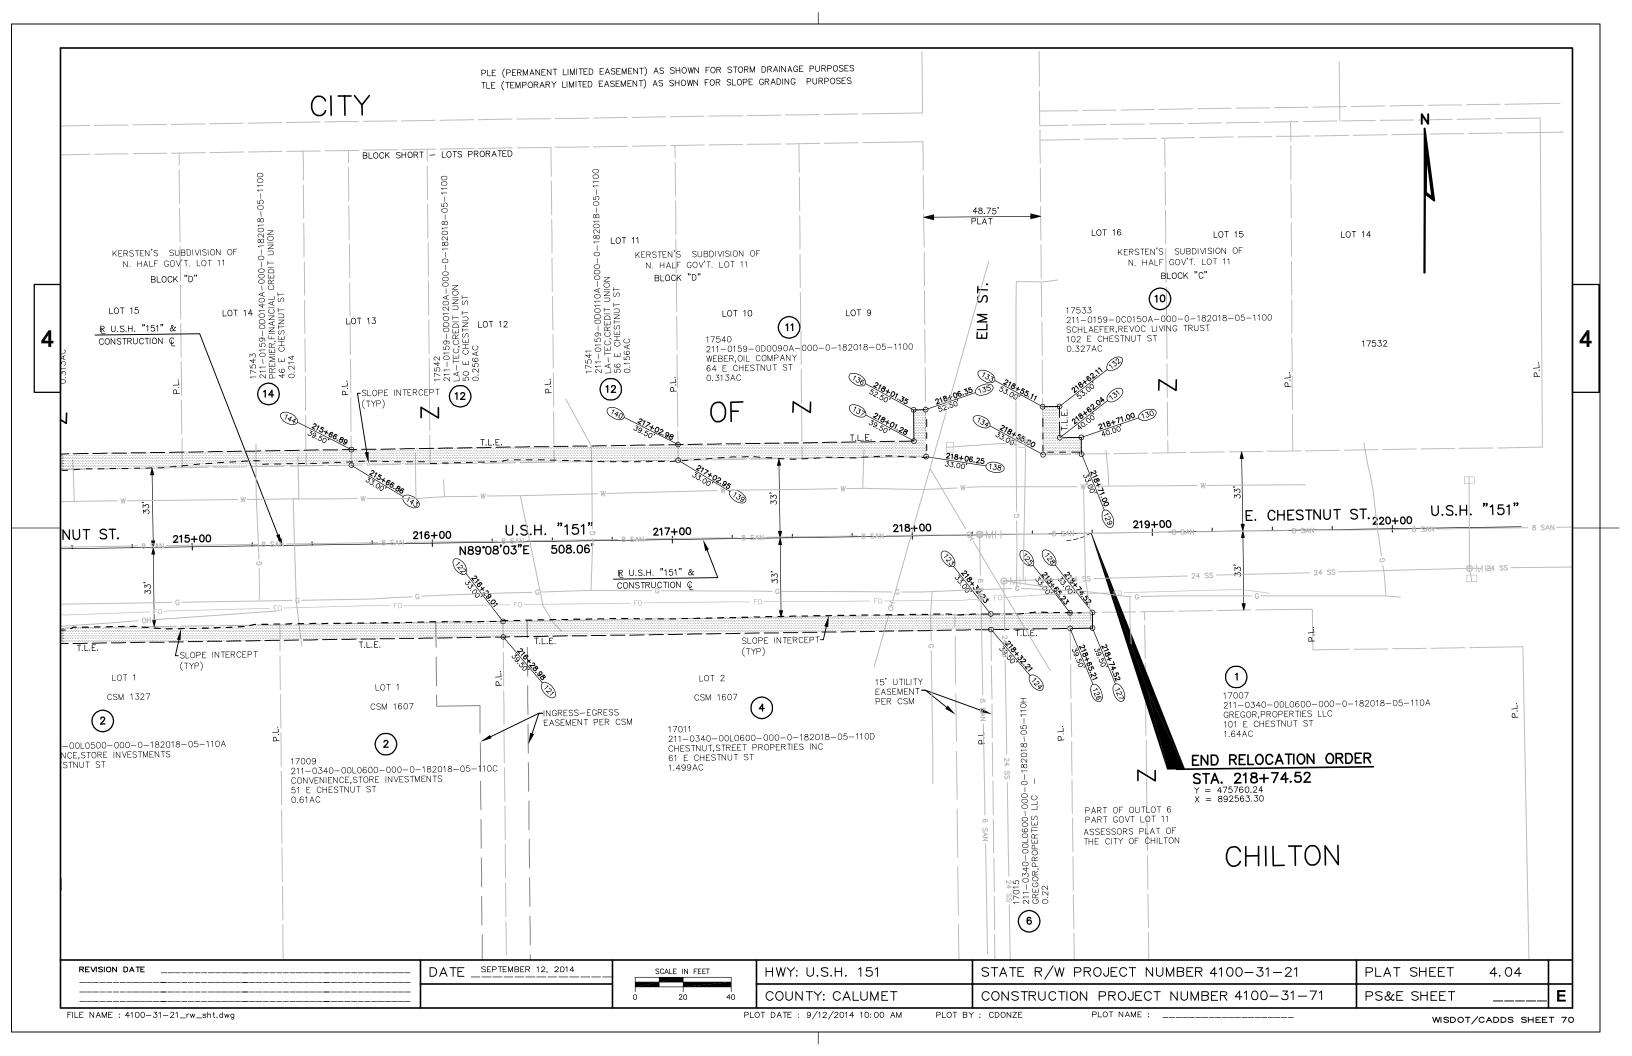

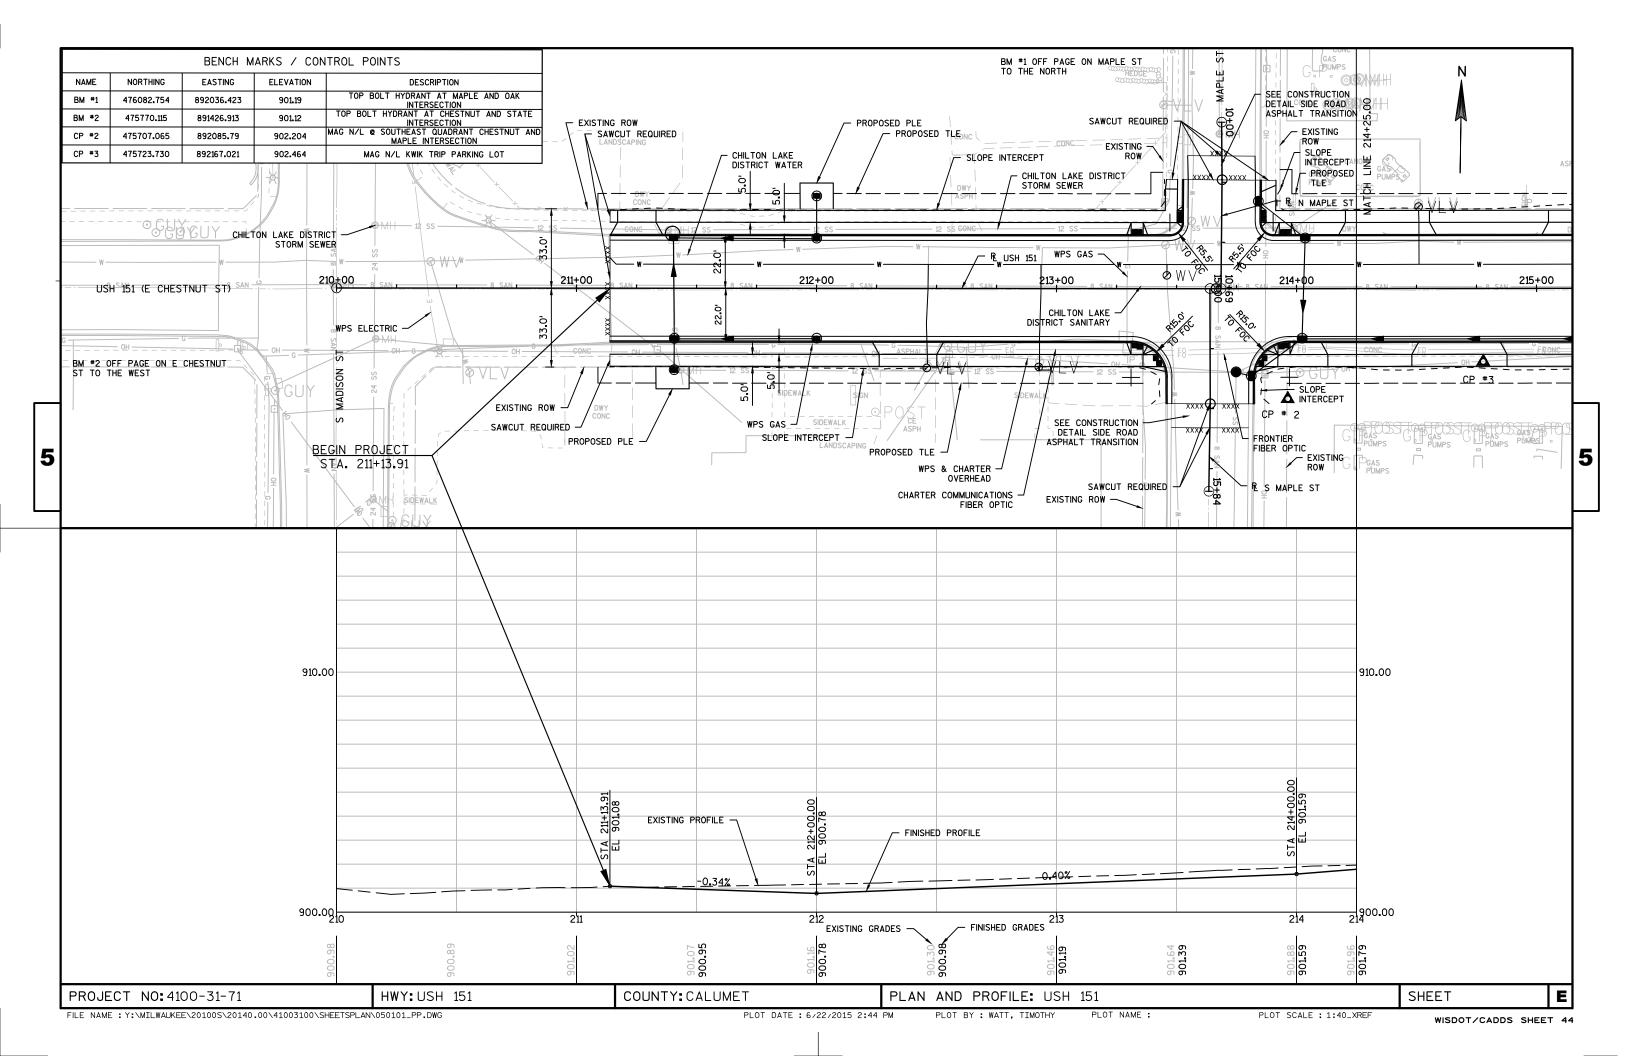


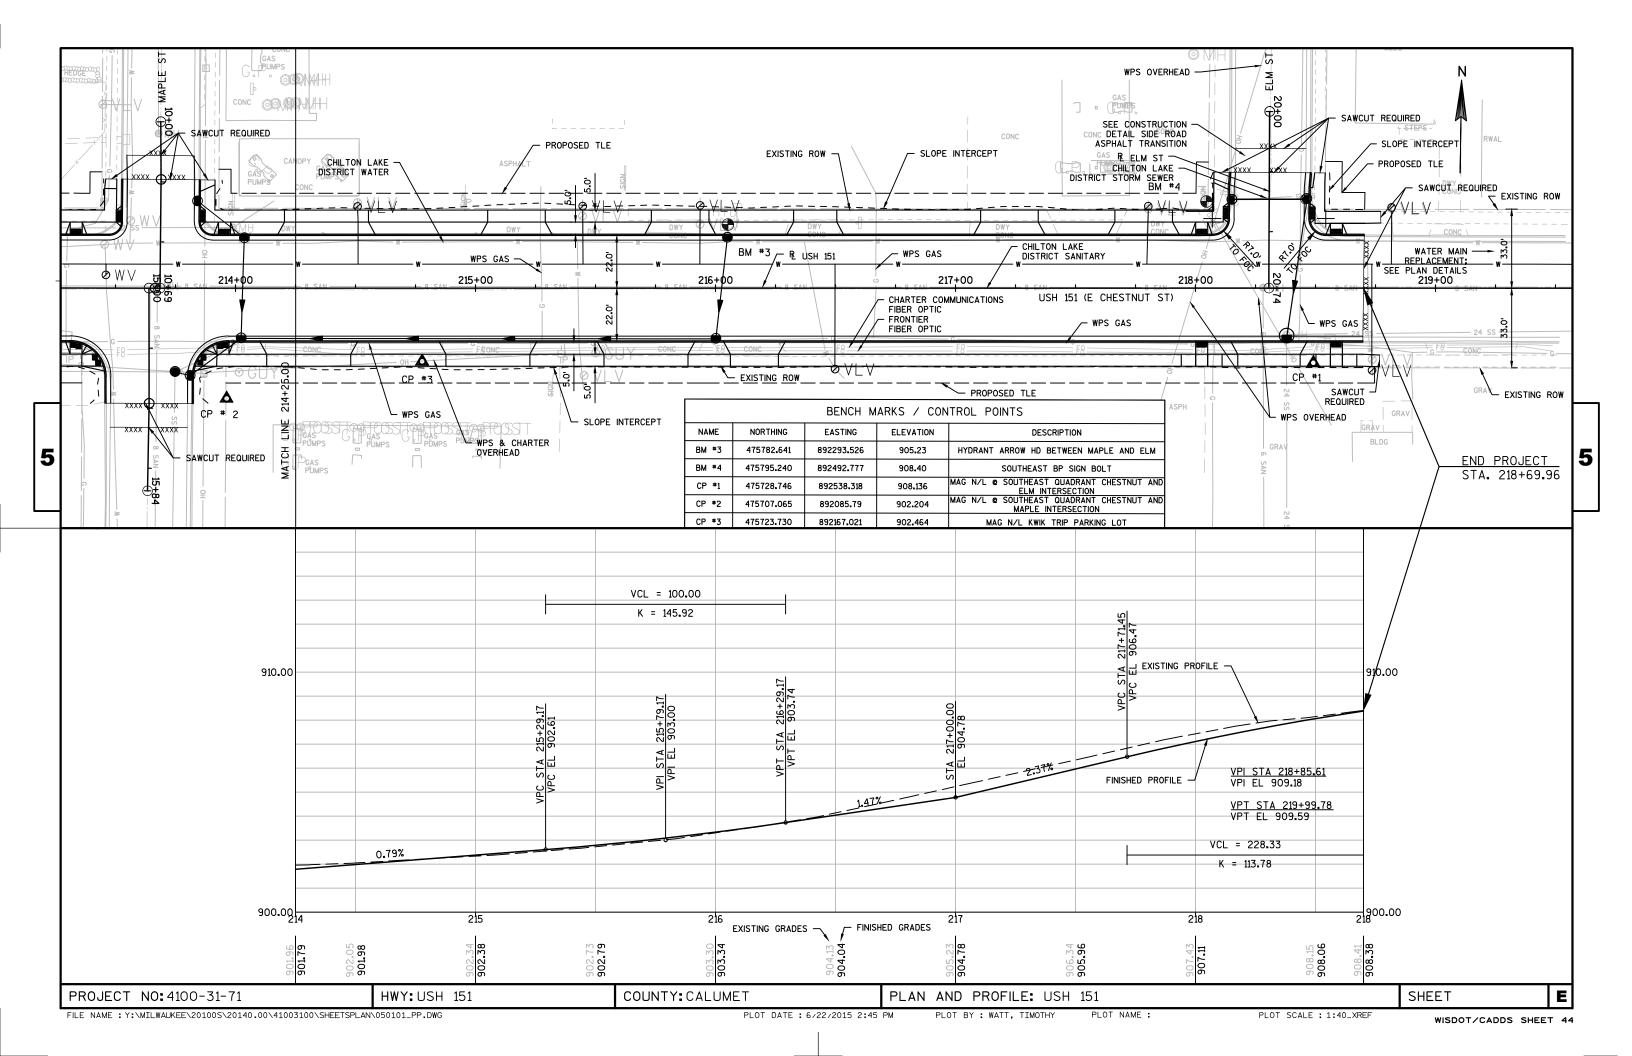


# Standard Detail Drawing List

08A	.05-19B	INLET COVERS TYPE B, B-A, C, MS, MS-A, & WM
	.05-19C	INLET COVERS TYPE F, HM, HM-S, S, T, V, HM-GJ, & HM-GJ-S
08A	.08-01	CATCH BASINS 3-FT, 4-FT, 5-FT AND 6-FT DIAMETER
08D	01-17	CONCRETE CURB, CONCRETE CURB AND GUTTER AND TIES
08D	05-15A	CURB RAMPS TYPES 1 AND 1-A
08D	05-15B	CURB RAMPS TYPES 2 AND 3
08D	05-15C	CURB RAMPS TYPES 4A AND 4A1
08D	05-15D	CURB RAMPS TYPE 4B AND 4B1
08D	05-15E	CURB RAMPS TYPES 5, 6, 7A, 7B & 8
08E	10-02	INLET PROTECTION TYPE A, B, C AND D
08F	04-07	JOINT TIES FOR CONCRETE PIPE AND CONCRETE COLLAR DETAIL
13C	01-17	CONCRETE PAVEMENT LONGITUDINAL JOINTS AND TIES
13C	13-08	URBAN DOWELED CONCRETE PAVEMENT
13C	18-02A	CONCRETE PAVEMENT JOINTING
13C	18-02B	CONCRETE PAVEMENT STEEL REINFORCEMENT
13C	18-02C	
13C	18-02D	CONCRETE PAVEMENT JOINTING AT UTILITY FIXTURES
15C	02-05A	BARRICADES AND SIGNS FOR MAINLINE CLOSURES
15C	02-05B	BARRICADES AND SIGNS FOR MAINLINE CLOSURES
15C	02-05C	DETOUR SIGNING FOR MAINLINE CLOSURES
15C	03-02	BARRI CADES AND SIGNS FOR SIDEROAD CLOSURES
15C	33-01	STOP LINE AND CROSSWALK PAVEMENT MARKING
15D	20-03	TRAFFIC CONTROL, SINGLE LANE CLOSURE, NON-FREEWAY/EXPRESSWAY
	30-02A	TRAFFIC CONTROL, PEDESTRIAN ACCOMMODATION
	30-02B	TRAFFIC CONTROL, TEMPORARY ADA COMPLIANT PEDESTRIAN ACCOMMODATION
15D	30-02C	TRAFFIC CONTROL, PEDESTRIAN ACCOMMODATION

6

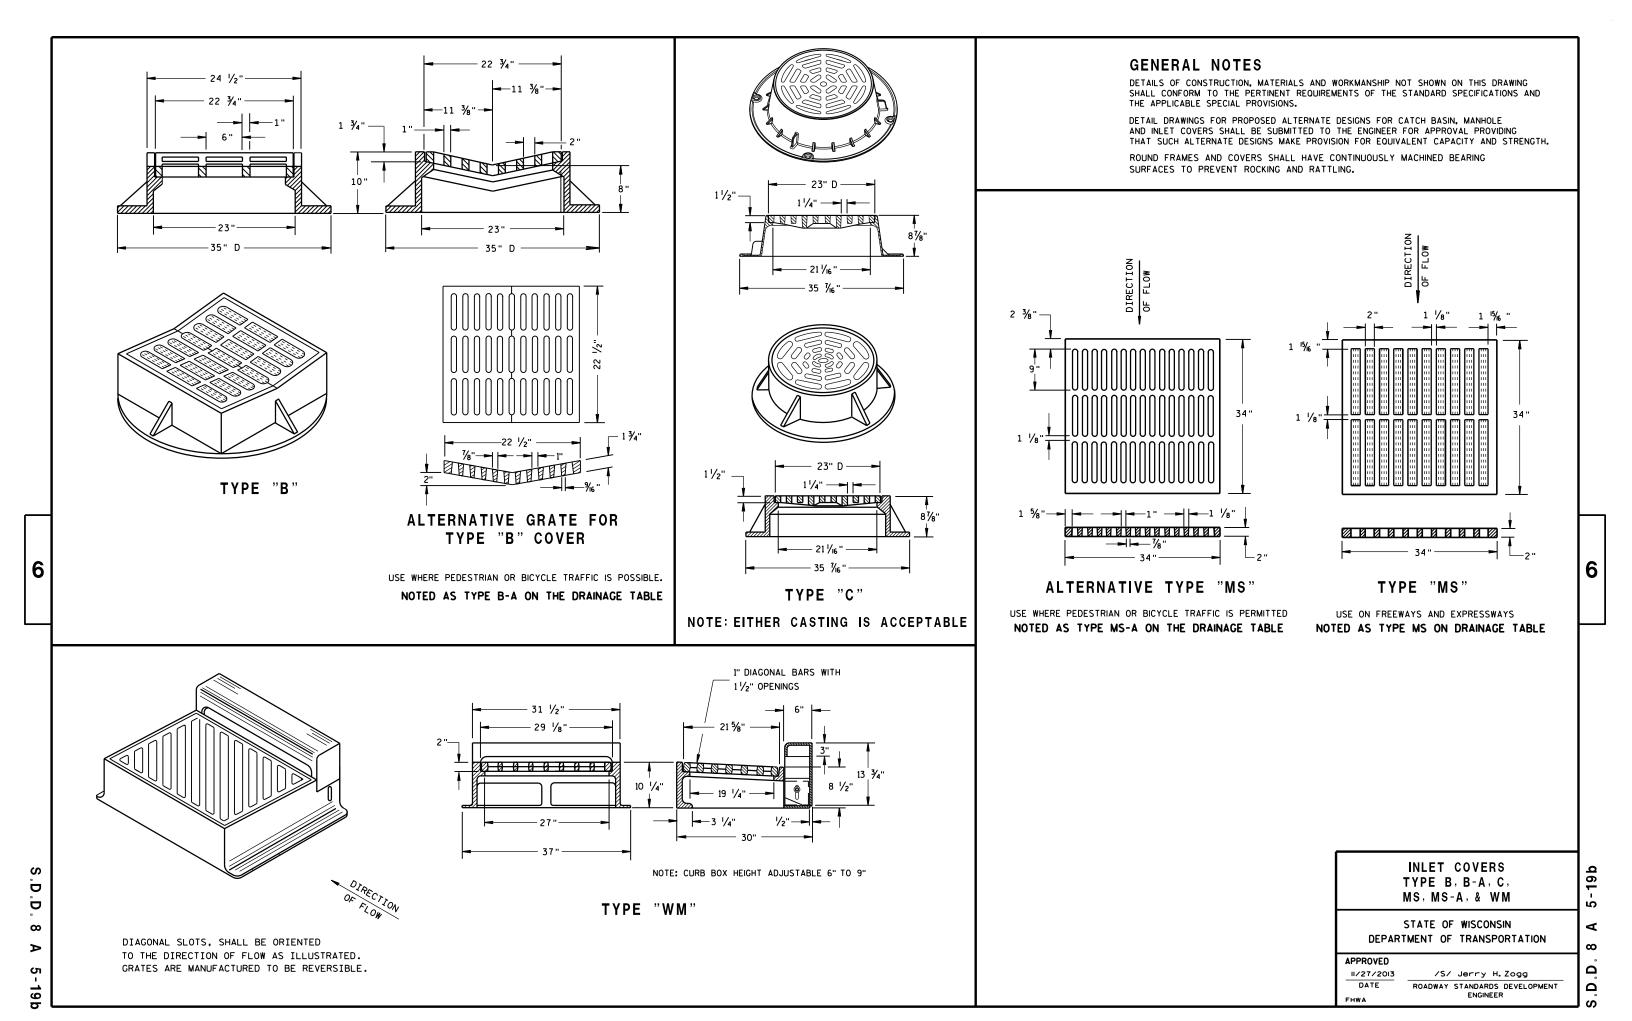


6

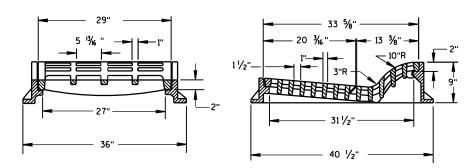

TYPE "F"

USE WITH TYPES A & D CONCRETE CURB & GUTTER, 36 INCH.


# 25 ½" 23 ½" 23 ½" 23 ½" 23 ½" 23 ½" 23 ½" 23 ½" 23 ½" 25 ½" 23 ½" 25 ½" 25 ½" 26 ½" 27 ½" 28 ½" 28 ½" 29 ½" 20 ½"

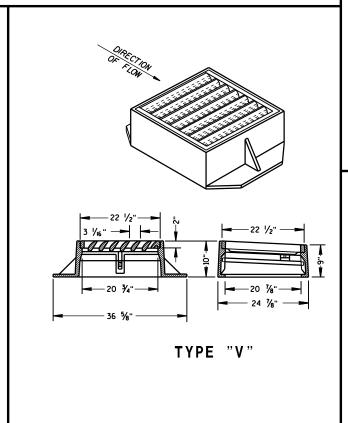

## GENERAL NOTES

DETAILS OF CONSTRUCTION, MATERIALS AND WORKMANSHIP NOT SHOWN ON THIS DRAWING SHALL CONFORM TO THE PERTINENT REQUIREMENTS OF THE STANDARD SPECIFICATIONS AND THE APPLICABLE SPECIAL PROVISIONS.


DETAIL DRAWINGS FOR PROPOSED ALTERNATE DESIGNS FOR INLET COVERS SHALL BE SUBMITTED TO THE ENGINEER FOR APPROVAL PROVIDING THAT SUCH ALTERNATE DESIGNS MAKE PROVISION FOR EQUIVALENT CAPACITY AND STRENGTH.

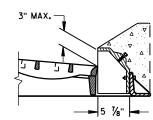

# ALTERNATIVE CURB BOX FOR TYPE "HM" COVER

USE WITH TYPES G & J CONCRETE CURB & GUTTER, 30 INCH NOTED AS TYPE HM-GJ ON DRAINAGE TABLE


NOIE:
SPECIAL GRATE FOR THE
TYPE "H" COVER MAY ALSO BE
USED FOR THE TYPE "HM-GJ" COVER
NOTED AS TYPE HM-GJ-S ON DRAINAGE TABLE

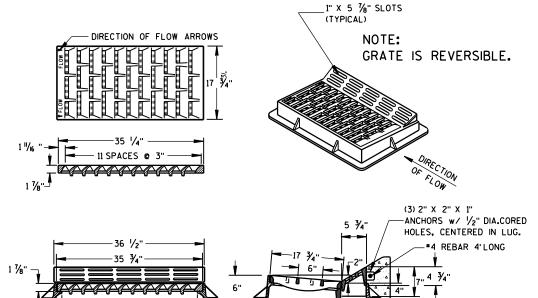

## TYPE "HM"

USE WITH TYPES A & D CONCRETE CURB & GUTTER, 36 INCH.

NOTE:
SPECIAL GRATE FOR THE
TYPE "H" COVER MAY ALSO BE
USED FOR THE TYPE "HM" COVER
NOTED AS TYPE HM-S ON DRAINAGE TABLE

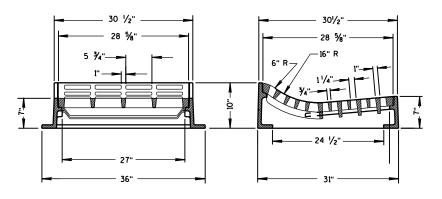

TYPE "T"

USE WITH TYPES R & T CONCRETE CURB & GUTTER, 36 INCH.



STATE OF WISCONSIN
DEPARTMENT OF TRANSPORTATION

APPROVED

II/27/2013
DATE / /S/ Jerry H. Zogg
ROADWAY STANDARDS DEVELOPMENT ENGINEER

A 5-19


D.D. 8






Ω



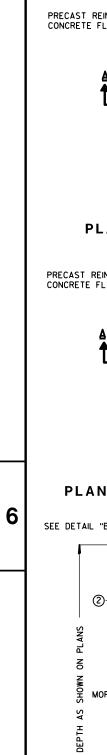



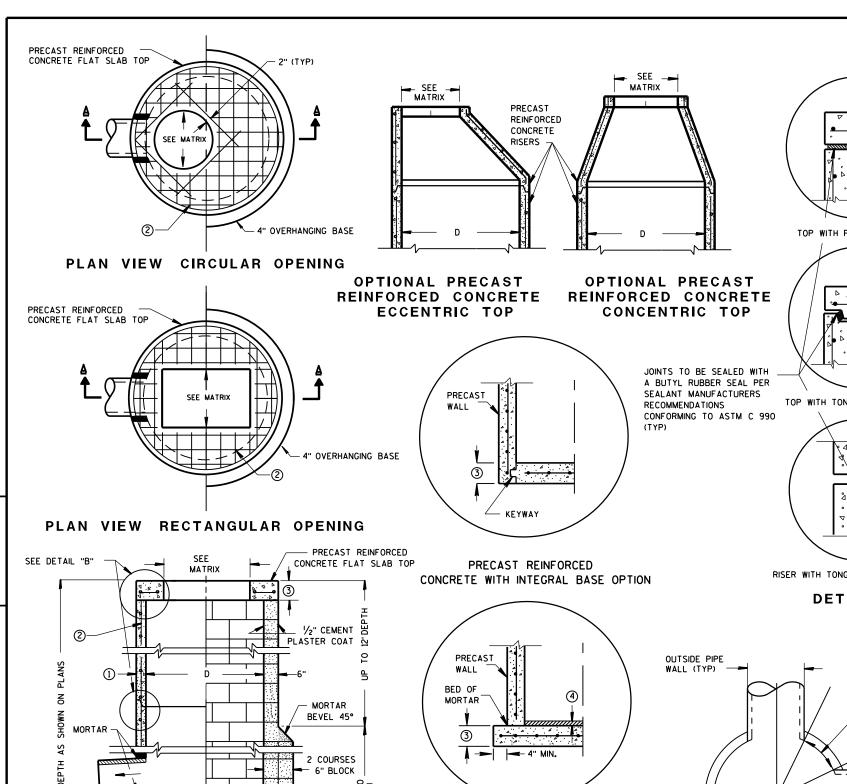

SEPARATE PRECAST REINFORCED CONCRETE BASE OPTION **DETAIL** "A"

CONTRACTOR TO PROVIDE DRAWING(S) STAMPED BY A PROFESSIONAL ENGINEER FOR STEEL REINFORCING DESIGN FOR CAST-IN-PLACE STRUCTURES

SECTION A-A


(4)

PRECAST REINFORCED CONCRETE WITH MONOLITHIC BASE


SEE DETAIL "A"

CONCRETE BLOCK WITH CAST-IN-PLACE OR PRECAST REINFORCED CONCRETE BASE ②


OVER 12' 25' DEP

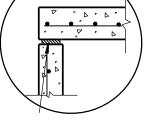

TOP WITH PLAIN END JOINT

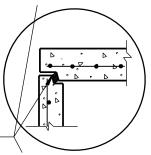


TOP WITH TONGUE AND GROOVE JOINT

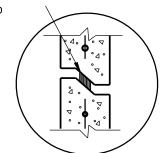

RISER WITH TONGUE AND GROOVE JOINT

DETAIL "B"

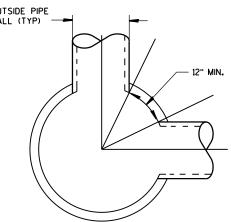

DETAIL "C"

## **GENERAL NOTES**

DETAILS OF CONSTRUCTION, MATERIALS AND WORKMANSHIP NOT SHOWN ON THIS DRAWING SHALL CONFORM TO THE PERTINENT REQUIREMENTS OF THE STANDARD SPECIFICATIONS AND THE APPLICABLE SPECIAL PROVISIONS.

UNLESS OTHERWISE AUTHORIZED IN WRITING BY THE ENGINEER, THE CONTRACTOR SHALL NOT ORDER AND DELIVER PRECAST CATCH BASIN UNITS REQUIRED FOR THE PROJECT UNTIL A LIST OF SIZES IS FURNISHED BY THE ENGINEER.

DETAILED DRAWINGS FOR PROPOSED ALTERNATE DESIGNS FOR UNDERGROUND DRAINAGE STRUCTURES SHALL BE SUBMITTED TO THE ENGINEER FOR APPROVAL PROVIDING THAT SUCH ALTERNATE DESIGNS MAKE PROVISION FOR EQUIVALENT CAPACITY AND STRENGTH.

ALL DRAINAGE STRUCTURES ARE DESIGNATED ON THE PLANS AS "MANHOLES 3X3-L", "CATCH BASINS 4-B", "INLETS 2X3-H", ETC. THE FIRST NUMBERS DESIGNATE THE SIZE OF THE STRUCTURE, AND THE FOLLOWING LETTER DESIGNATES THE TYPE OF COVER TO BE USED TO COMPRISE THE COMPLETE UNIT.

BASES SHALL BE PLACED ON A BED OF MATERIAL AT LEAST 6 INCHES IN DEPTH, WHICH MEETS THE REQUIREMENTS OF GRANULAR BACKFILL. THIS BEDDING SHALL BE COMPACTED AND PROVIDE UNIFORM SUPPORT FOR THE ENTIRE AREA OF THE BASE.

PRECAST REINFORCED CONCRETE CONE TOPS (ECCENTRIC OR CONCENTRIC) OR PRECAST REINFORCED CONCRETE FLAT SLAB TOPS MAY BE USED ON CONCRETE BLOCK STRUCTURES. THE TOPS SHALL BE INSTALLED ON

ECCENTRIC CONE TOPS MAY BE USED ON ALL STRUCTURES, AND CONCENTRIC CONE TOPS SHALL BE USED ONLY ON STRUCTURES 5 FEET OR LESS IN DEPTH, UNLESS OTHERWISE DIRECTED BY THE ENGINEER.

STEPS MEETING AASHTO M199 AND THE FOLLOWING REQUIREMENTS SHALL BE INSTALLED IN ALL STRUCTURES OVER 5 FEET IN DEPTH: 16 INCH C-C MAXIMUM SPACING; PROJECT A MINIMUM CLEAR DISTANCE OF 4 INCHES FROM THE WALL AT THE POINT OF EMBEDMENT; MINIMUM LENGTH OF 10 INCHES; MINIMUM WALL EMBEDMENT OF 3 INCHES, FERROUS METAL STEPS NOT PAINTED OR TREATED TO RESIST CORROSION SHALL HAVE A MINIMUM CROSS SECTIONAL DIMENSION OF 1 INCH.

STEPS OF APPROVED POLYPROPYLENE PLASTIC COATED REINFORCEMENT BAR ARE ACCEPTABLE. REINFORCING BAR MUST BE A MINIMUM OF  $\crit{1/2}$  INCH AND MEET THE REQUIREMENTS OF ASTM A615.

CERTIFICATION SHALL BE PROVIDED THAT INSTALLED STEPS WHEN TESTED IN ACCORDANCE WITH SECTION 10 OF AASHTO T280 CAN WITHSTAND A VERTICAL LOAD OF 800 LBS. AND A HORIZONTAL LOAD OF 400 LBS.

ALL BAR STEEL REINFORCEMENT SHALL BE EMBEDDED 2 INCHES CLEAR UNLESS OTHERWISE SHOWN OR NOTED.

ALL PRECAST INLET UNITS SHALL CONFORM TO THE PERTINENT REQUIREMENTS OF AASHTO DESIGNATION M199.

PRECAST REINFORCED RISERS SHALL HAVE A TONGUE AND GROOVE JOINT WITH TONGUE UP OR DOWN.

CONCRETE BLOCK WILL NOT BE PERMITED FOR STRUCTURES GREATER THAN 4 FEET IN DIAMETER.

4" OVERHANGING BASES ARE REQUIRED FOR ALL CONCRETE BLOCK INSTALLATIONS. 4" OVERHANG IS REQUIRED WHEN SEPARATE PRECAST BASE IS PROVIDED. OVERHANG IS NOT REQUIRED ON PRECAST STRUCTURES WITH AN INTEGRAL OR MONOLITHIC BASE.

FOR ADDITIONAL CONFIGURATIONS, MAINTAIN A MINIMUM OF 12 INCHES AS MEASURED FROM THE INSIDE OF THE STRUCTURE WALL BETWEEN THE OUTSIDE PIPE WALLS OF ADJACENT PIPES. SEE DETAIL "C".

- MINIMUM WALL THICKNESS SHALL BE 4 INCHES FOR 3-FT, 5 INCHES FOR 4-FT, 6 INCHES FOR 5-FT AND 7 INCHES MINIMUM WALL INICINESS STALL DE FOR 6-FT DIAMETER PRECAST CATCH BASINS.
- (2) FOR PRECAST CATCH BASINS PROVIDE REINFORCING STEEL IN ACCORDANCE TO AASHTO M199.
- (3) PRECAST FLAT SLAB TOPS AND BASES WITH A DIAMETER OF 48" AND LESS SHALL HAVE A MINIMUM THICKNESS OF 6". PRECAST FLAT SLAB TOPS AND BASES WITH A DIAMETER LARGER THAN 48" SHALL HAVE A MINIMUM THICKNESS
- 4 1" CONCRETE KEY POURED AFTER INSTALLATION. 2' SUMP MEASURED FROM TOP OF KEY.

## CATCH BASIN COVER OPENING MATRIX

CATCH BASIN	INLET COVER TYPE	ALL A'S	ALL B'S	B₩	С	F	ALL H'S	S	Т	٧	WM	Z
SIZE	OPENING SIZE (FT)											
3-FT	2X2	Х	Х					Х		Х		
	2 DIA.				Х							Х
	2X2	Х	Х					Х		Х		
4-FT-	2X2.5			Х				Х	Х	Х	Х	
6-FT	2 DIA.				Х							Х
	2X3						x					
	2.5X3					Х						

## PIPE MATRIX

CATCH BASIN		MAXIMUM INSIDE PIPE DIAMETER FOR TWO PIPES								
SIZE	180° SEPARATION (IN)	90° SEPARATION (IN)								
3-FT	15	12								
4-FT	24	18								
5-FT	36	24								
6-FT	42	30								


CATCH BASINS 3-FT, 4-FT, 5-FT AND 6-FT DIAMETER


STATE OF WISCONSIN DEPARTMENT OF TRANSPORTATION


PPROVED	


/S/ Jerry H. Zogg 6/5/2012 DATE ROADWAY STANDARDS DEVELOPMENT ENGINEER FHWA


CATCH BASINS 3-FT, 4-FT, 5-FT AND 6-FT DIAMETER

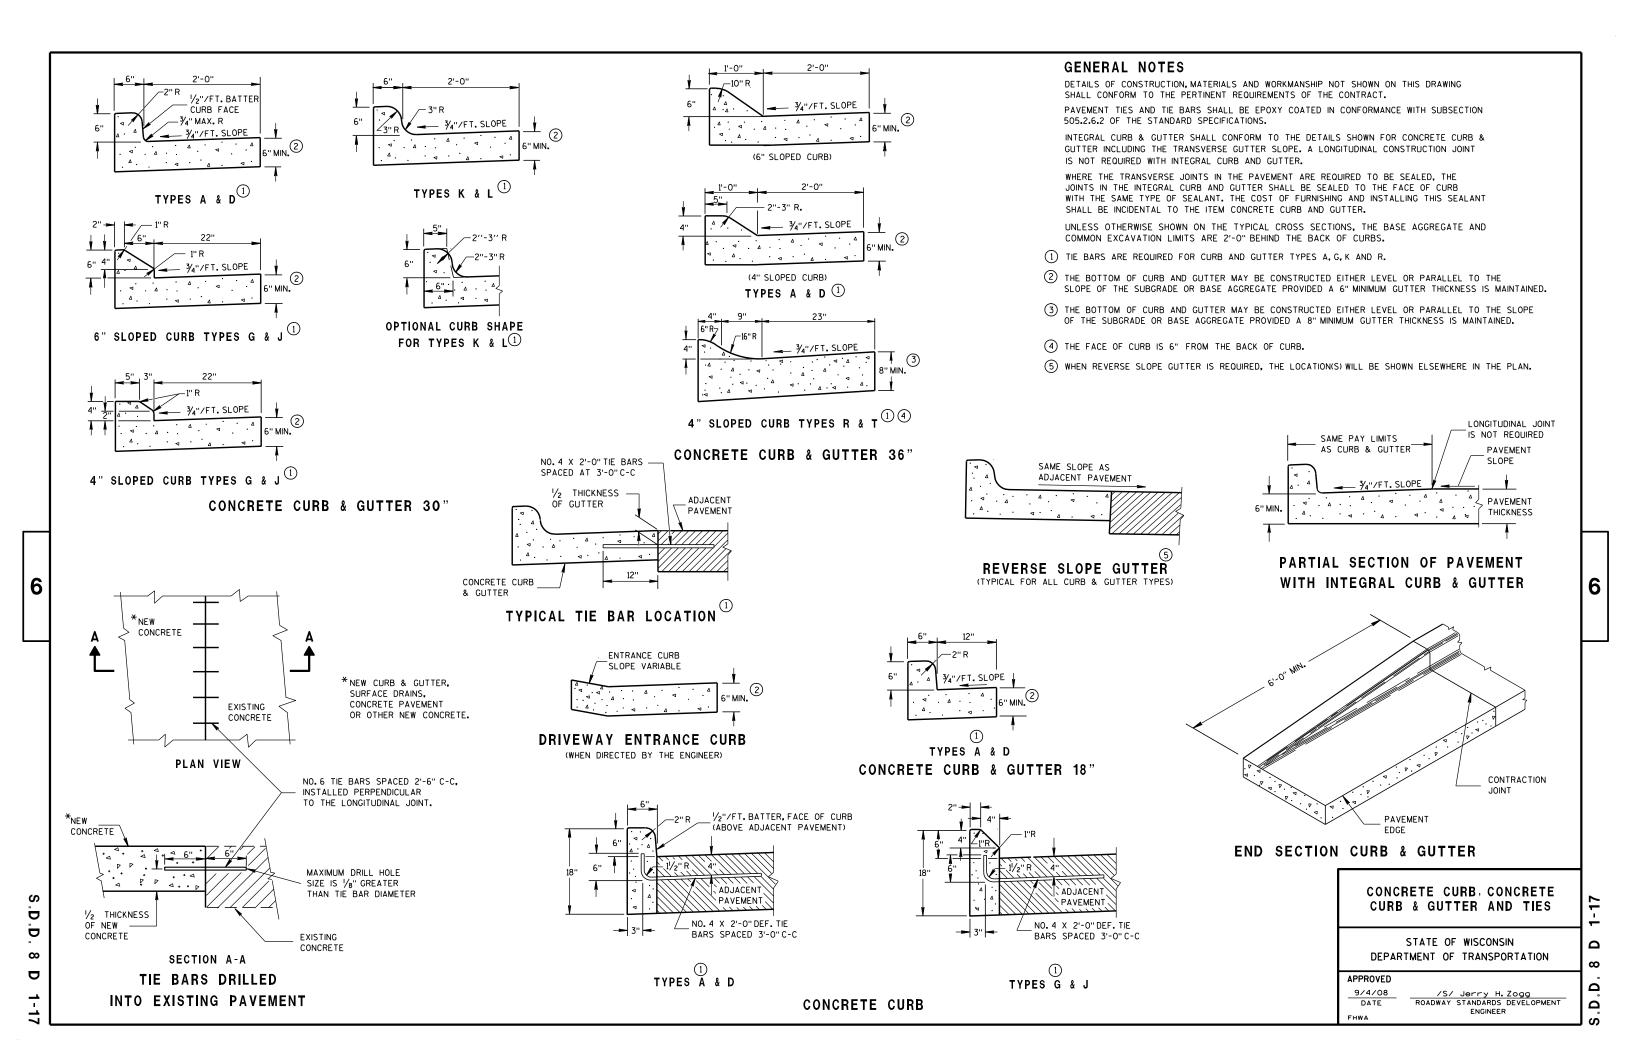

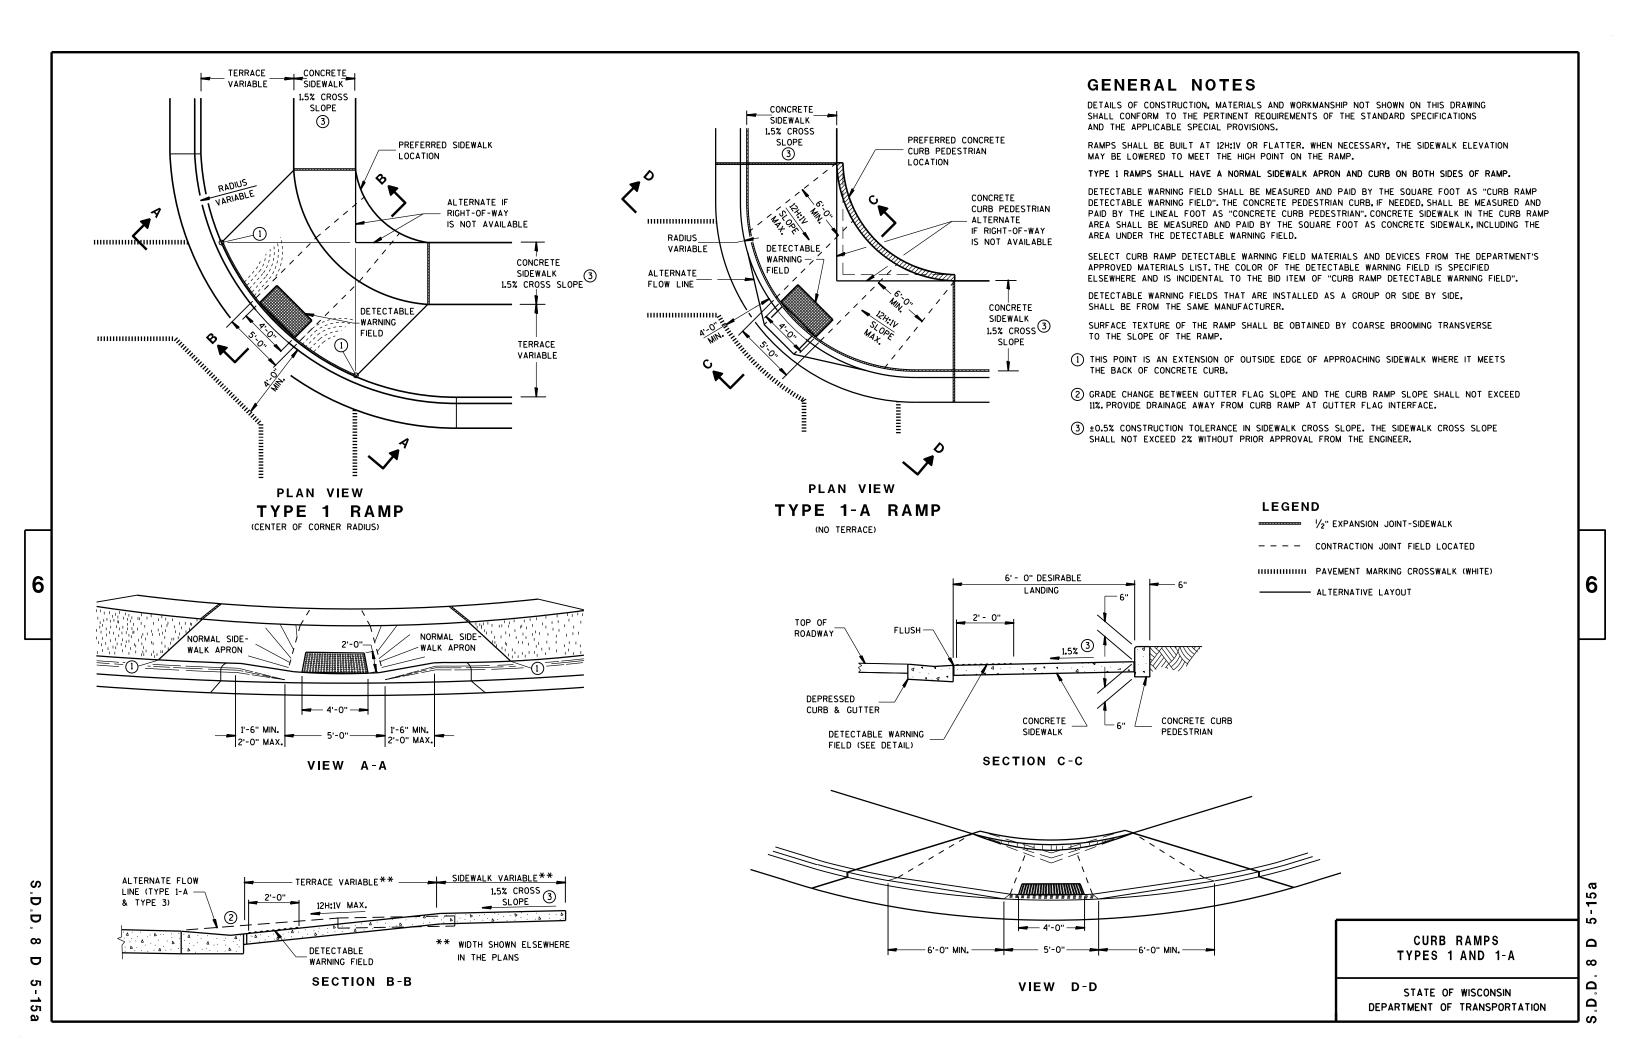

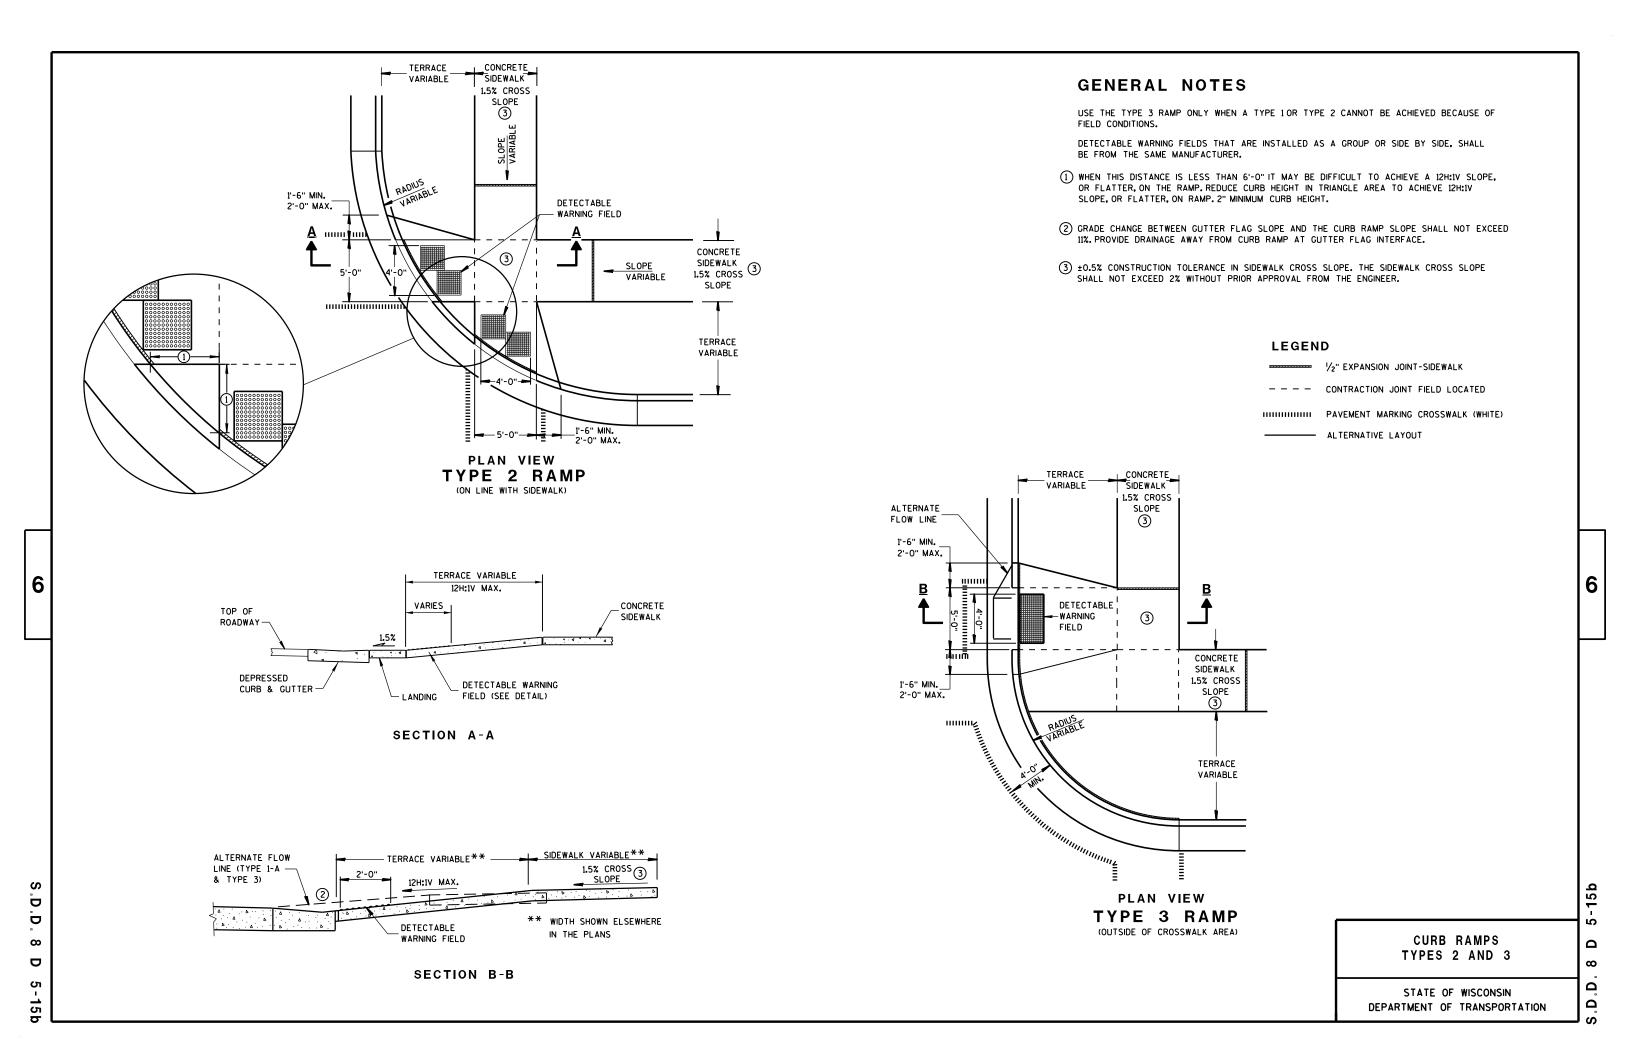

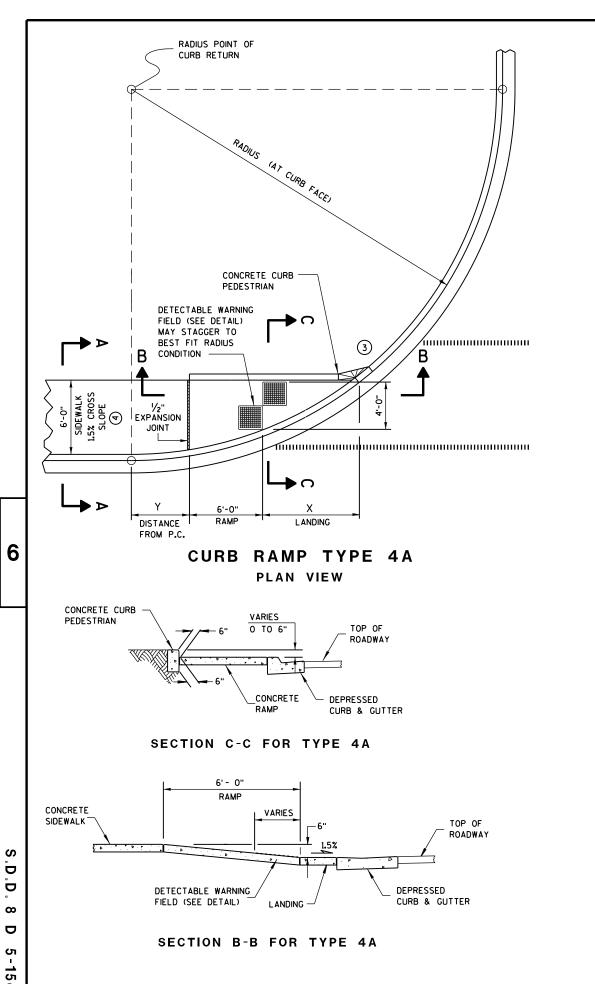

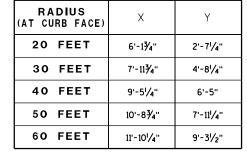

**GENERAL NOTES** 

AVOID PLACING DRAINAGE STRUCTURES, JUNCTION BOXES OR OTHER

DETECTABLE WARNING FIELDS THAT ARE INSTALLED AS A GROUP OR SIDE BY SIDE.

4 ±0.5% CONSTRUCTION TOLERANCE IN SIDEWALK CROSS SLOPE. THE SIDEWALK CROSS

SLOPE SHALL NOT EXCEED 2% WITHOUT PRIOR APPROVAL FROM THE ENGINEER.

ISOMETRIC VIEW FOR TYPE 4A

ISOMETRIC VIEW FOR TYPE 4A1

₩ 1/2" EXPANSION JOINT-SIDEWALK

HIHIHIHIH PAVEMENT MARKING CROSSWALK (WHITE)

CONTRACTION JOINT FIELD LOCATED

CURB RAMPS

TYPES 4A AND 4A1

STATE OF WISCONSIN

DEPARTMENT OF TRANSPORTATION

**LEGEND** 


OBSTRUCTIONS IN FRONT OF RAMP ACCESS AREAS.

RAMP SLOPES SHALL NOT BE STEEPER THAN 12:1.


(3) INSTALL TRANSITION NOSE. (INCIDENTAL TO OTHER PAY ITEMS.) DO NOT MARK TRANSITION NOSE.

SHALL BE FROM THE SAME MANUFACTURER.

INTERMEDIATE RADII CAN BE INTERPOLATED

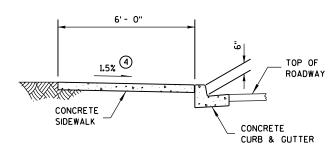

SECTION A-A FOR TYPE 4A

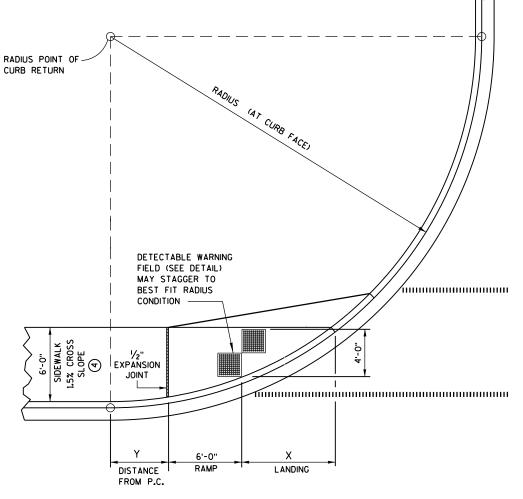



CURB RAMP TYPE 4A1
PLAN VIEW

15c


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SECTION A-A FOR TYPE 4B

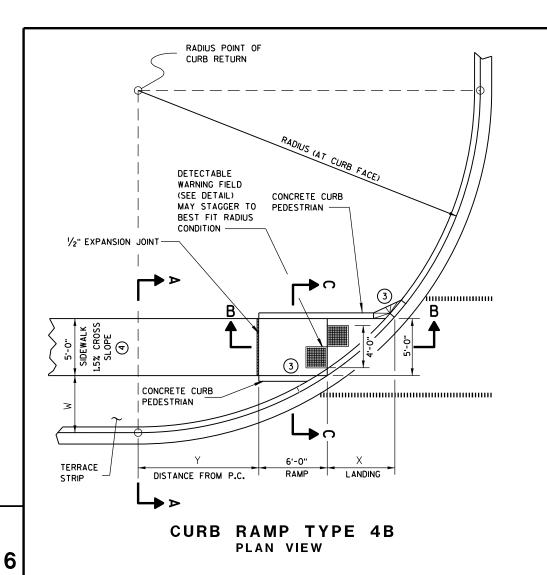

## LEGEND

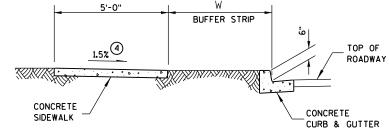
/2" EXPANSION JOINT-SIDEWALK

---- CONTRACTION JOINT FIELD LOCATED

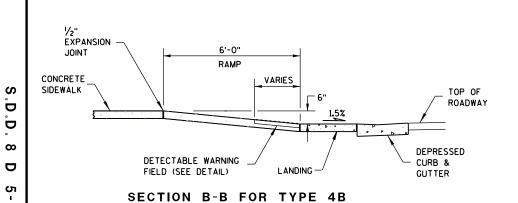
HIHIHIHIH PAVEMENT MARKING CROSSWALK (WHITE)

RADIUS	W = 3' - 0"		W = 4' - Ø"		W = 5' - 0"		W = 6' - 0"		W = 7' - 0"	
(AT CURB FACE)	X	Y	X	Υ	X	Y	X	Y	X	Y
20 FEET	5'-51/2"	4'-61/2"	4'-81/2"	6'-0"	4'-1"	7'-2¾"	3'-7"	8'-31/2"	3'-11/2"	9'-21/2"
30 FEET	7'-3¾"	7'-1"	6'-51/2"	8'-11'/2"	5'-91/4"	10'-7"	5'-21/2"	12'-0"	4'-8¾"	13'-3'/4"
40 FEET	8'-91/2"	9'-21/2"	7'-10"	11'-5'/4"	7'-1"	13'-41/2"	6'-5¾"	15'-¾"	5'-111/2"	16'-7'/4"
50 FEET	10'-¾"	11'-3⁄4''	9'-1/4"	13'-7'/4"	8'-21/2"	15'-91/2"	7'-61/2"	17'-9"	6'-11¾"	19'-6'/4"
60 FEET	11'-21/2"	12'-8¾"	10'-¾"	15'-61/2"	9'-21/4"	17'-11¾"	8'-5¾"	20'-1¾"	7'-101/2"	22'-11/2"

INTERMEDIATE RADII CAN BE INTERPOLATED

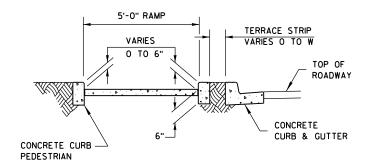

SECTION C-C FOR TYPE 4B

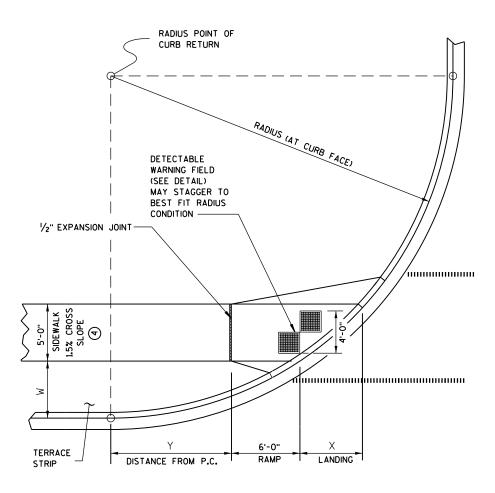

CURB RAMP TYPE 4B1
PLAN VIEW


## **GENERAL NOTES**

AVOID PLACING DRAINAGE STRUCTURES, JUNCTION BOXES OR OTHER OBSTRUCTIONS IN FRONT OF RAMP ACCESS AREAS.


RAMP SLOPES SHALL NOT BE STEEPER THAN 12:1.

DETECTABLE WARNING FIELDS THAT ARE INSTALLED AS A GROUP OR SIDE BY SIDE, SHALL BE FROM THE SAME MANUFACTURER.

- (3) INSTALL TRANSITION NOSE. (INCIDENTAL TO OTHER PAY ITEMS.) DO NOT MARK TRANSITION NOSE.
- (4) ±0.5% CONSTRUCTION TOLERANCE IN SIDEWALK CROSS SLOPE. THE SIDEWALK CROSS SLOPE SHALL NOT EXCEED 2% WITHOUT PRIOR APPROVAL FROM THE ENGINEER.

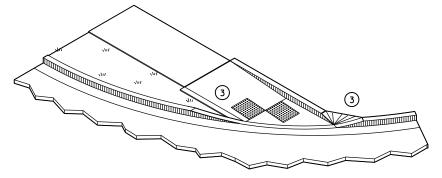

ISOMETRIC VIEW FOR TYPE 4B

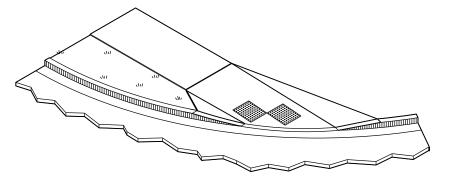


ISOMETRIC VIEW FOR TYPE 4B1


CURB RAMPS Type 4B and 4B1


STATE OF WISCONSIN
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INLET PROTECTION, TYPE A

## **GENERAL NOTES**

INLET PROTECTION DEVICES SHALL BE MAINTAINED OR REPLACED AT THE DIRECTION OF THE ENGINEER.

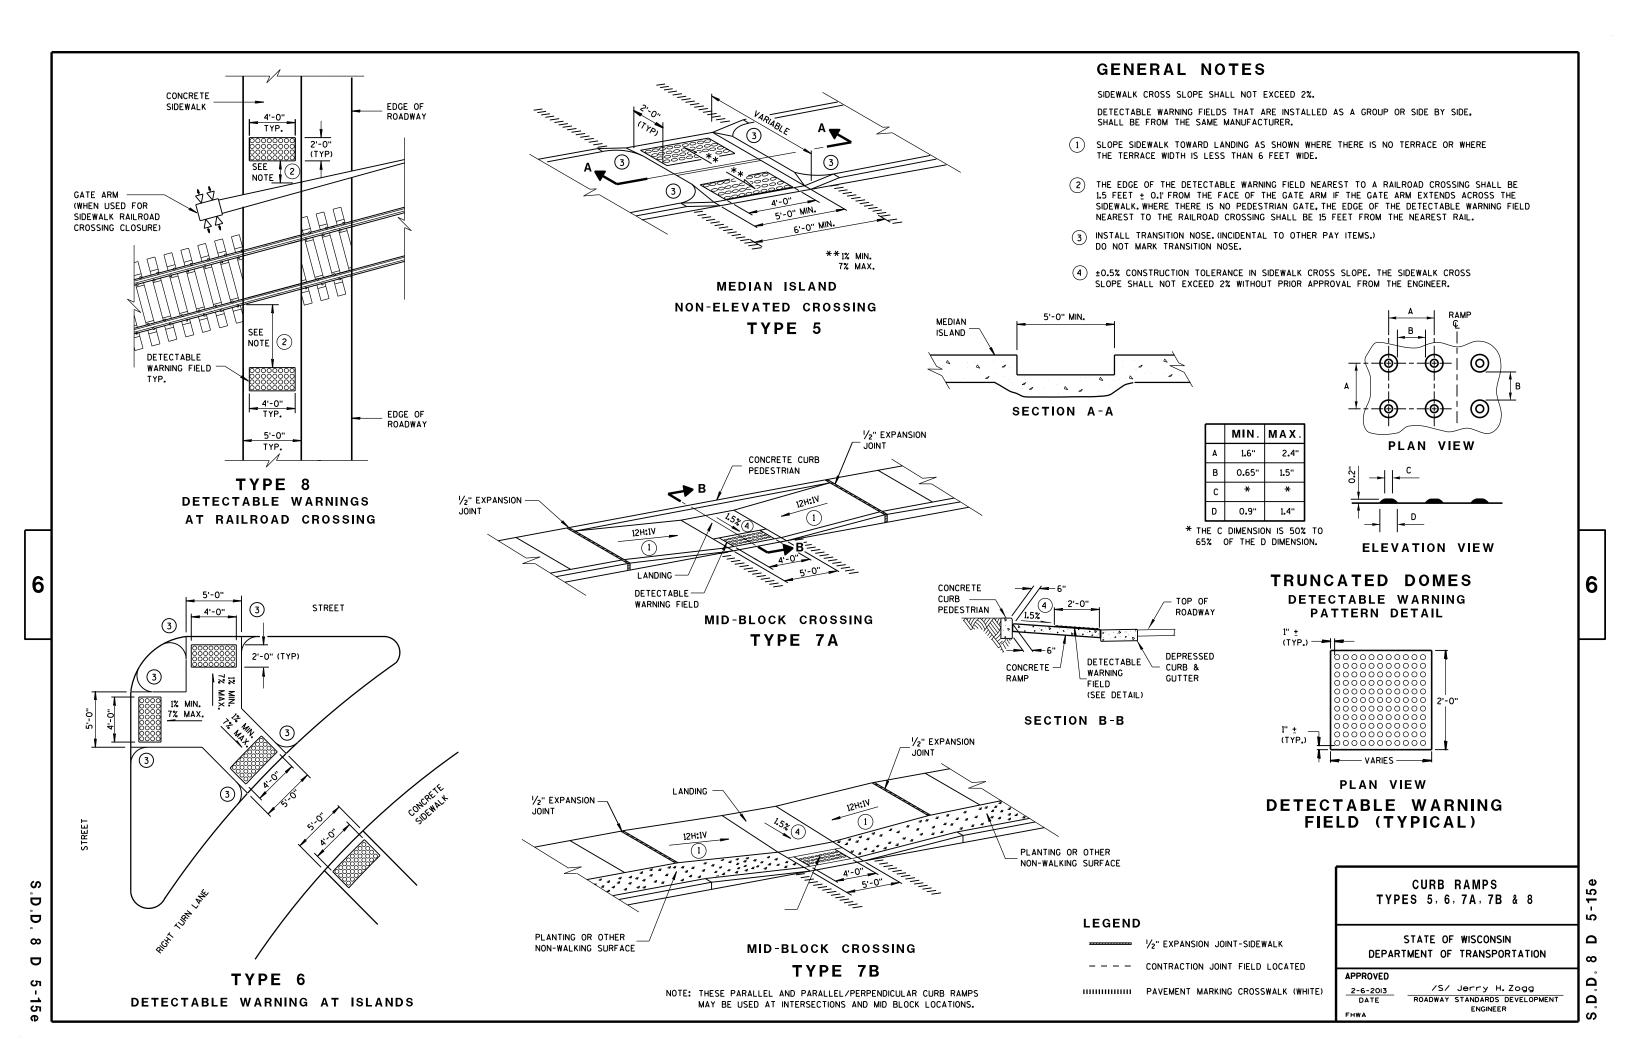MANUFACTURED ALTERNATIVES APPROVED AND LISTED ON THE DEPARTMENT'S EROSION CONTROL PRODUCT ACCEPTABILITY LIST MAY BE

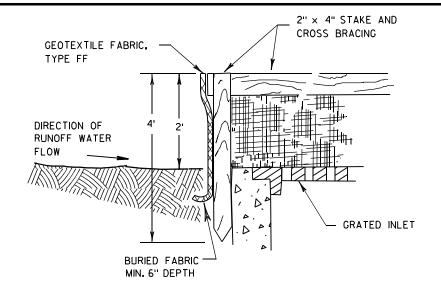WHEN REMOVING OR MAINTAINING INLET PROTECTION, CARE SHALL BE TAKEN SO THAT THE SEDIMENT TRAPPED ON THE GEOTEXTILE FABRIC DOES NOT FALL INTO THE INLET. ANY MATERIAL FALLING INTO THE INLET SHALL BE REMOVED IMMEDIATELY.

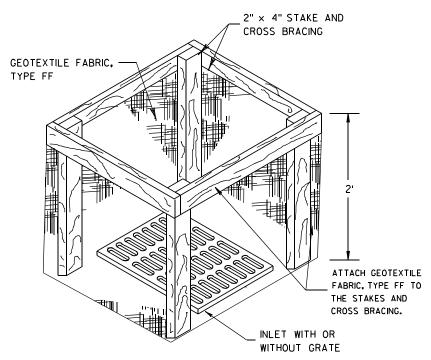- 1) FINISHED SIZE, INCLUDING FLAP POCKETS WHERE REQUIRED, SHALL EXTEND A MINIMUM OF 10" AROUND THE PERIMETER TO FACILITATE MAINTENANCE OR REMOVAL.
- (2) FOR INLET PROTECTION, TYPE C (WITH CURB BOX), AN ADDITIONAL 18" OF FABRIC IS WRAPPED AROUND THE WOOD AND SECURED WITH STAPLES. THE WOOD SHALL NOT BLOCK THE ENTIRE HEIGHT OF THE CURB BOX OPENING.
- (3) FLAP POCKETS SHALL BE LARGE ENOUGH TO ACCEPT WOOD 2X4.



## INLET PROTECTION, TYPE C (WITH CURB BOX)

## **INSTALLATION NOTES**

## TYPE B & C

TRIM EXCESS FABRIC IN THE FLOW LINE TO WITHIN 3" OF THE GRATE.

THE CONTRACTOR SHALL DEMONSTRATE A METHOD OF MAINTENANCE, USING A SEWN FLAP, HAND HOLDS OR OTHER METHOD TO PREVENT ACCUMULATED SEDIMENT FROM ENTERING THE INLET.

## TYPE D

DO NOT INSTALL INLET PROTECTION TYPE D IN INLETS SHALLOWER THAN 30", MEASURED FROM THE BOTTOM OF THE INLET TO THE TOP OF THE GRATE.

TRIM EXCESS FABRIC IN THE FLOW LINE TO WITHIN 3" OF THE GRATE.

THE INSTALLED BAG SHALL HAVE A MINIMUM SIDE CLEARANCE, BETWEEN THE INLET WALLS AND THE BAG, MEASURED AT THE BOTTOM OF THE OVERFLOW HOLES, OF 3". WHERE NECESSARY THE CONTRACTOR SHALL CINCH THE BAG, USING PLASTIC ZIP TIES, TO ACHIEVE THE 3" CLEARANCE, THE TIES SHALL BE PLACED AT A MAXIMUM OF 4" FROM THE BOTTOM OF THE BAG.

## INLET PROTECTION TYPE A, B, C, AND D

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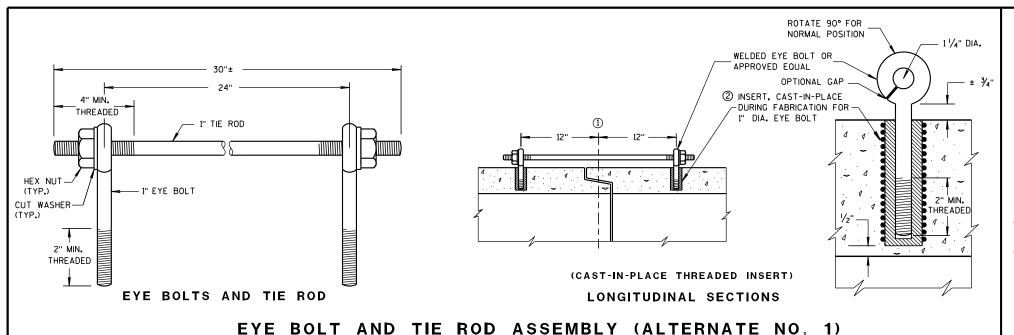
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STATE OF WISCONSIN DEPARTMENT OF TRANSPORTATION

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/S/ Beth Cannestra 10/16/02 CHIEF ROADWAY DEVELOPMENT ENGINEER



## **GENERAL NOTES**


DETAILS OF CONSTRUCTION, MATERIALS, AND WORKMANSHIP NOT SHOWN ON THIS DRAWING SHALL CONFORM TO THE PERTINENT REQUIREMENTS OF THE STANDARD SPECIFICATIONS AND APPLICABLE SPECIAL PROVISIONS.

CONCRETE CULVERT AND STORM SEWER PIPE SHALL BE TIED TOGETHER IN THE MANNER ILLUSTRATED BY THIS DETAIL AT LOCATIONS DESIGNATED IN THE STANDARD SPECIFICATIONS AND THE PLAN. THE CONTRACTOR MAY USE EITHER ALTERNATE 1, 2 OR 3 FOR DRAINAGE STRUCTURES, ONLY ALTERNATE 1 AND 3 MAY BE USED FOR CATTLE PASSES, UNLESS OTHERWISE STATED IN THE CONTRACT. THE MATERIALS, FABRICATION AND WORK NECESSARY TO TIE THE PIPE BY THIS DETAIL WILL BE CONSIDERED INCIDENTAL TO THE PIPE AND APRON ENDWALLS IF REQUIRED.

DETAILED DRAWINGS FOR PROPOSED ALTERNATE DESIGNS FOR JOINT TIES SHALL BE SUBMITTED TO THE ENGINEER FOR APPROVAL.

JOINT TIES TO BE HOT-DIP GALVANIZED PER ASTM A 153.

- (1) & OF TONGUE AND GROOVE OR BELL AND SPIGOT JOINTS.
- THE INSIDE OF THE THREADED INSERTS SHALL BE CLEAN TO ALLOW THE INSERTION OF THREADED EYE
- ${\mathfrak S}$  HOLES SHALL BE CAST-IN-PLACE OR DRILLED 12 INCHES FROM  ${\mathfrak L}$  OF TONGUE AND GROOVE.
- 4 BOLT PROJECTION INSIDE OF PIPE SHALL NOT EXCEED 2 INCHES.
- (5) OPENING TO BE ROD DIAMETER PLUS 1 INCH.
- ⑥ LENGTH ADEQUATE TO EXTEND TO WITHIN  $rac{1}{2}$  INCH OF THE INNER SURFACE OF THE PIPE.

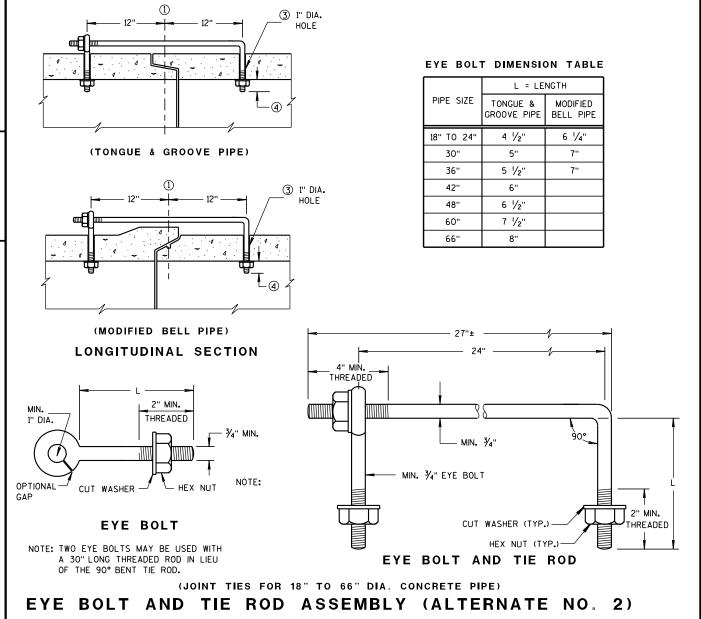


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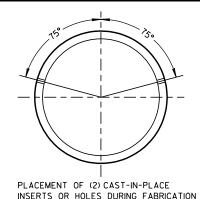
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# ADJUSTABLE TIE ROD TABLE 5/8 5 12-60 3/4 5 1/2 3/4 90-108 DIMENSIONS SHOWN ARE IN INCHES **TAPERED** PLAIN RIGHT AND LEFT THREADS **SLEEVE NUTS** 2 1/2" MIN. THREADED




(JOINT TIES FOR 12" TO 108" DIA. CONCRETE PIPE) ADJUSTABLE TIE ROD (ALTERNATE NO. 3)

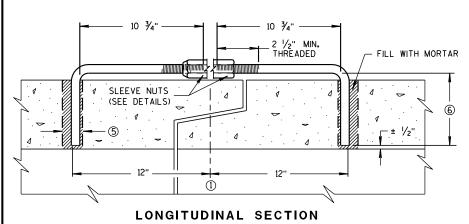

INSERTS OR HOLES DURING FABRICATION FOR PIPE SECTIONS REQUIRING TIE RODS

## TRANSVERSE SECTION

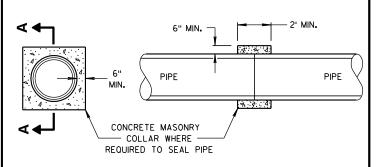

SECTION A-A


## CONCRETE COLLAR DETAIL


JOINT TIES FOR CONCRETE PIPE AND CONCRETE COLLAR DETAIL

STATE OF WISCONSIN DEPARTMENT OF TRANSPORTATION

6/5/2012 /S/ Jerry H. Zogg DATE ROADWAY STANDARDS DEVELOPMENT ENGINEER

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#### PAVEMENT DEPTH, DOWEL BAR SIZE AND JOINT SPACING TABLE

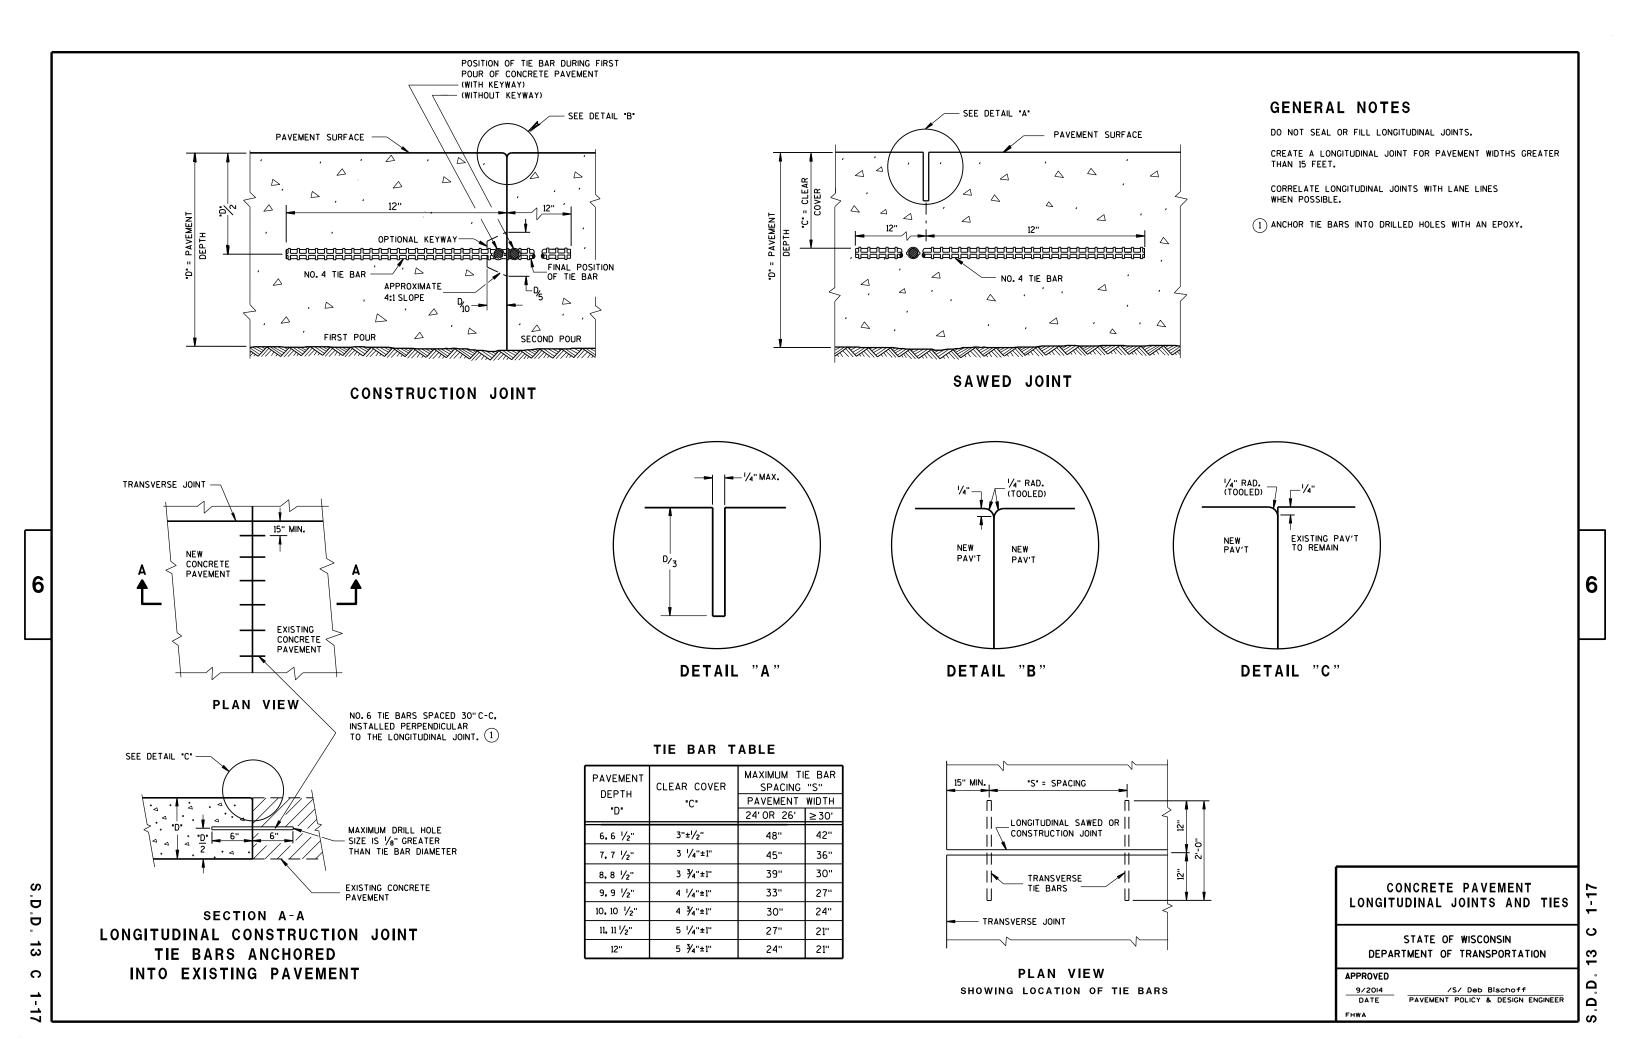PAVEMENT DEPTH (D)	DOWEL BAR DIAMETER	CONTRACTION JOINT SPACING
5 1/2", 6",6 1/2"	NONE	12'
7",7 1/2"	1"	14'
8"•8 1/2"	1 1/4"	15'
9",9 1/2"	1 1/4"	15'
10" & ABOVE	1 1/2"	15'
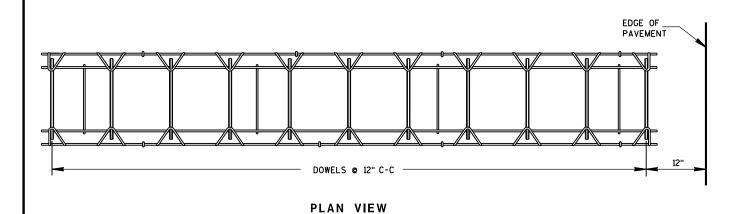
#### **GENERAL NOTES**

#### **CONTRACTION JOINTS**

CONSTRUCT TRANSVERSE CONTRACTION JOINTS NORMAL TO THE CENTERLINE. SHOW THE LOCATION OF CONTRACTION JOINTS THROUGH INTERSECTIONS ON THE PLANS OR AS DIRECTED BY THE ENGINEER.

DO NOT SEAL OR FILL CONTRACTION JOINTS.


INSTALL DOWEL BARS PARALLEL TO THE PAVEMENT CENTERLINE AND PAVEMENT SURFACE.

FOR PAVEMENT SLABS OF VARYING WIDTHS, LOCATE THE OUTER MOST DOWEL BAR SO THAT THE CENTER OF THE BAR IS A MINIMUM OF 6 INCHES AND A MAXIMUM OF 18 INCHES FROM THE LONGITUDINAL JOINT AND THE FREE EDGE


#### CONSTRUCTION JOINTS

LOCATE CONSTRUCTION JOINTS A MINIMUM OF 6 FEET FROM THE NEAREST CONTRACTION JOINT AND ALIGN PARALLEL TO CONTRACTION JOINTS.

- (1) OBTAIN THE ENGINEER'S APPROVAL FOR THE USE OF ALTERNATIVE DESIGNS OF THE DOWEL ASSEMBLY. USE MECHANICAL DOWEL BAR INSERTERS OR DOWEL ASSEMBLIES WHEN CONSTRUCTING CONTRACTION JOINTS.
- 2) SECURE BASKETS WITH ANCHORS TO HOLD DOWEL BARS IN THE CORRECT POSITION AND ALIGNMENT. TYPE, LOCATION, NUMBER AND LENGTH OF ANCHORS ARE DEPENDENT UPON FIELD CONDITIONS.
- (3) FORM OR SAW CONSTRUCTION JOINTS. PROVIDE A 1/4-INCH RADIUS AT FORMED JOINTS.
- 4 PROVIDE A SMOOTH VERTICAL FACE FOR THE ENTIRE DEPTH OF THE PAVEMENT WHEN FORMING CONSTRUCTION JOINTS.
- 5 INSTALL DOWEL BARS AT CONSTRUCTION JOINTS BY FORMING OR DRILLING. INSTALL FORMED DOWEL BARS 12 INCHES C-C AND 12 INCHES FROM PAVEMENT EDGE. REMOVE EXCESS CONCRETE FROM THE FREE END OF THE DOWEL BAR IF DOWEL BARS ARE FORMED THROUGH A HEADER BOARD. INSTALL DRILLED DOWEL BARS ACCORDING TO DRILLED DOWEL BAR CONSTRUCTION JOINT DETAIL.
- 6 APPLY A THIN UNIFORM COATING OF SURFACE TREATMENT TO THE FREE END OF DOWEL BARS TO PREVENT BONDING.
- (7) ANCHOR DOWEL BARS INTO DRILLED HOLES WITH AN EPOXY. MAXIMUM DRILLED HOLE SIZE IS 1/8-INCH GREATER THAN DOWEL BAR DIAMETER. 9 INCHES IN LENGTH.

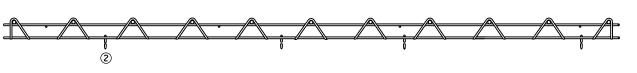

SIDE VIEW CONTRACTION JOINT DOWEL ASSEMBLY

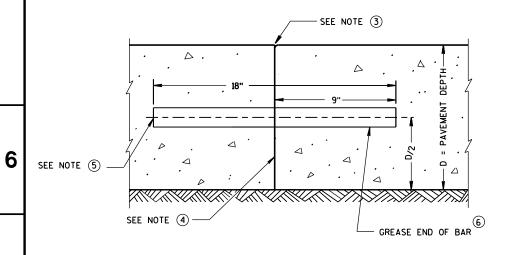


TRANSVERSE CONSTRUCTION JOINT

△ DOWEL BARS © 12" C-C 12" FROM PAVEMENT EDGE-

**DOWELED CONTRACTION JOINT** 


(SEE SIZE TABLE)

SEE JOINT DETAIL

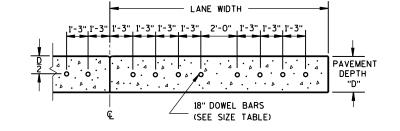

(FOR 11' LANE WIDTH REDUCE CENTER SPACE TO 1'-O")

## DRILLED DOWEL BAR CONSTRUCTION JOINT $^{\scriptsize \bigcirc}$

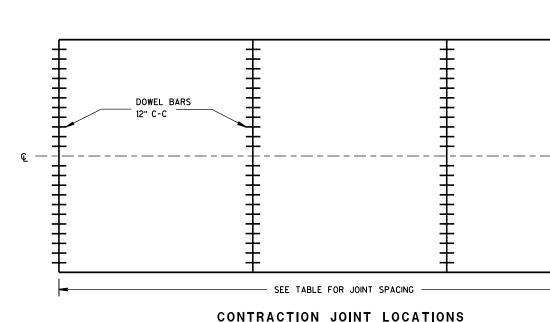

JOINT DETAIL

## **URBAN DOWELED CONCRETE PAVEMENT**

- ¼" MAX.

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**APPROVED** 5/3/2013


FHWA


/S/ Deb Bischoff PAVEMENT POLICY & DESIGN ENGINEER


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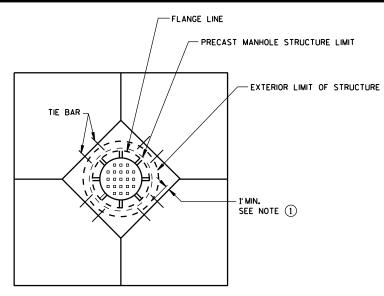
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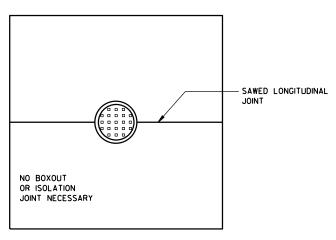







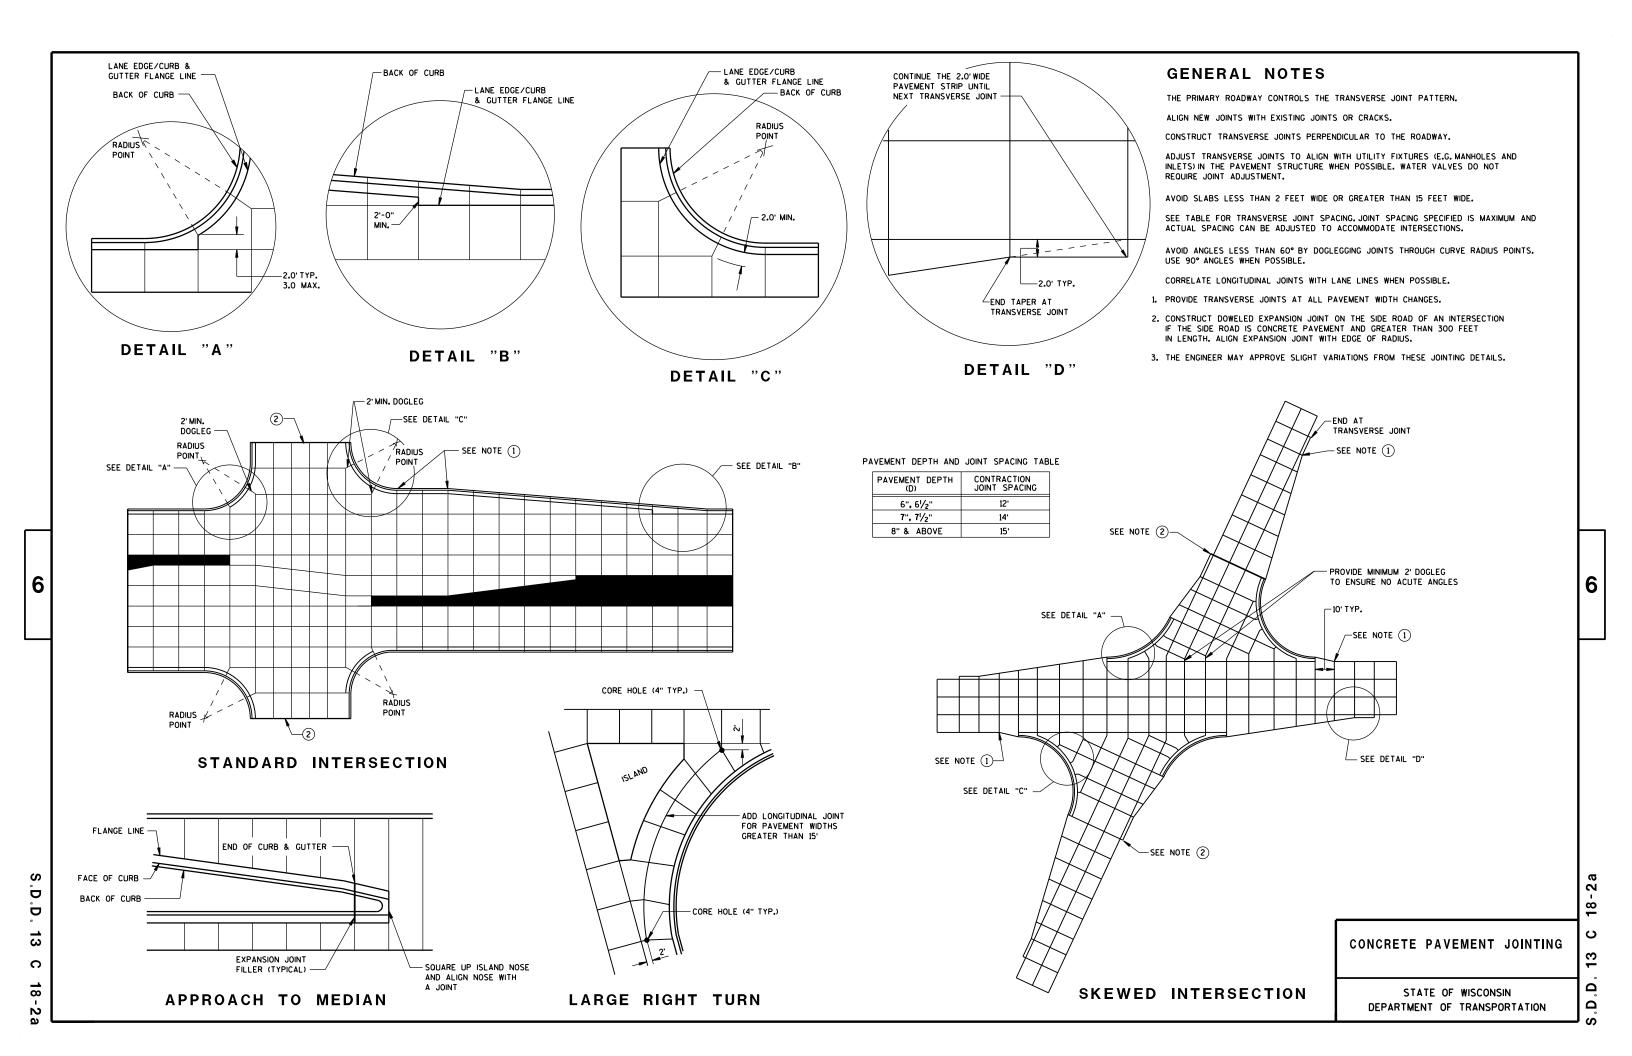

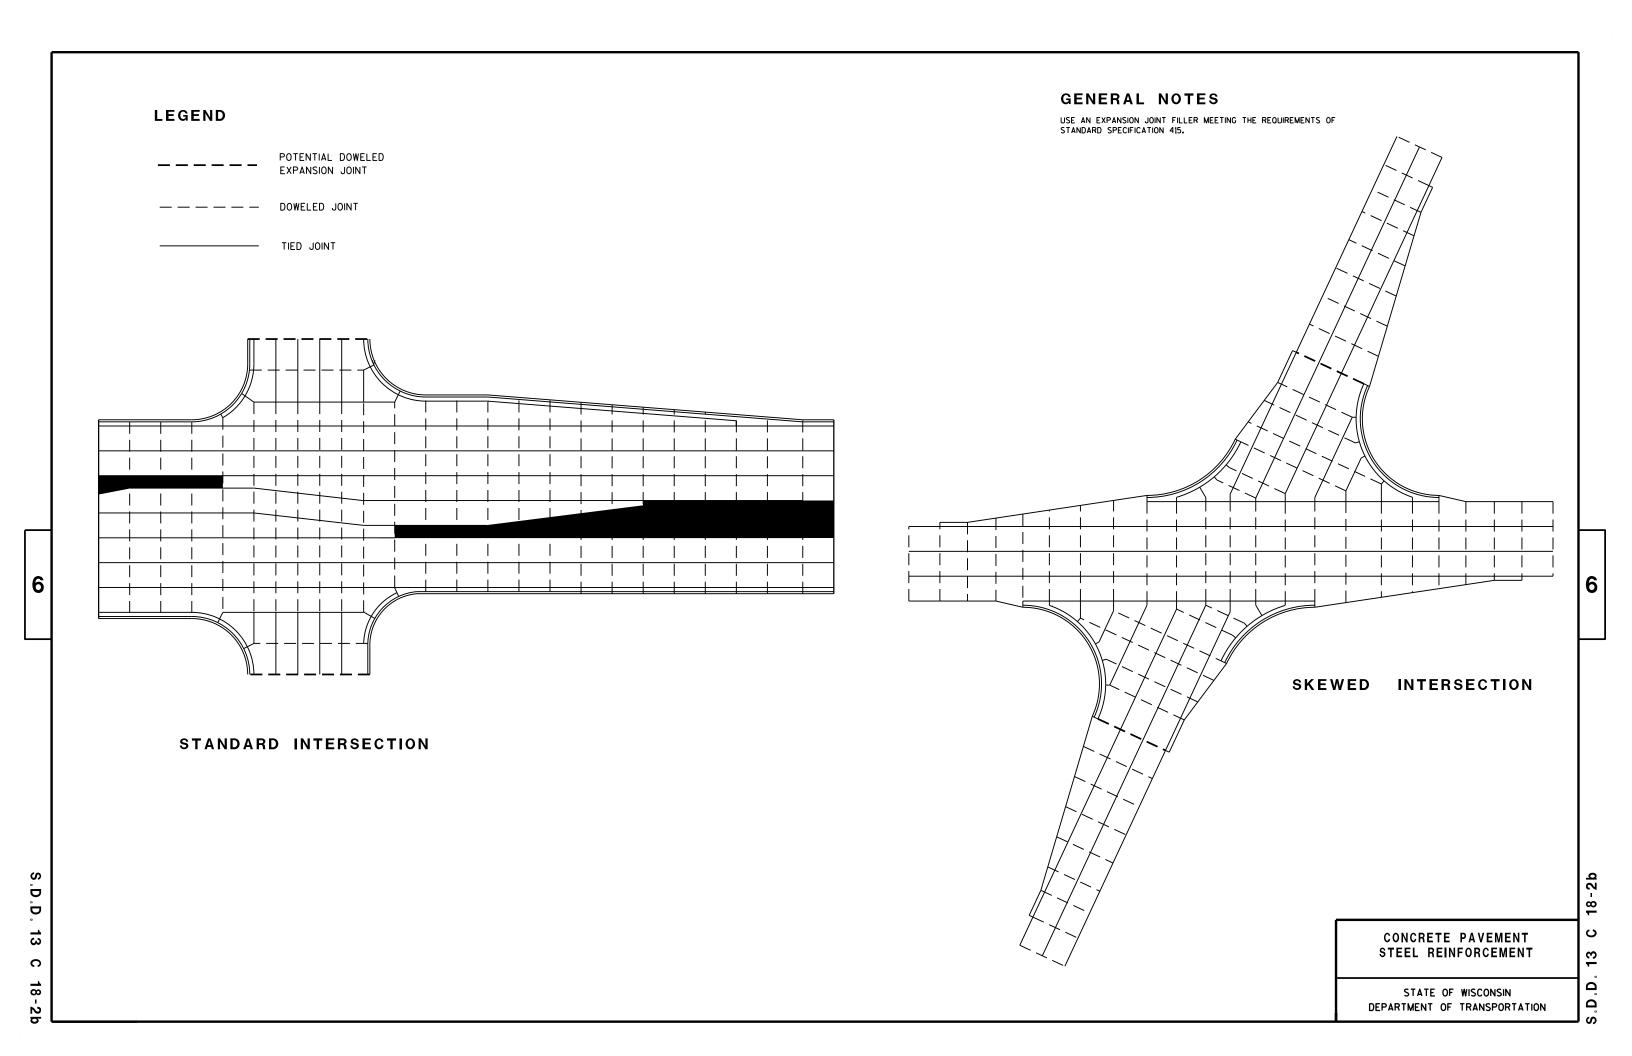
DIAGONAL MANHOLE BOXOUT FOR CONSTRUCTION JOINTS

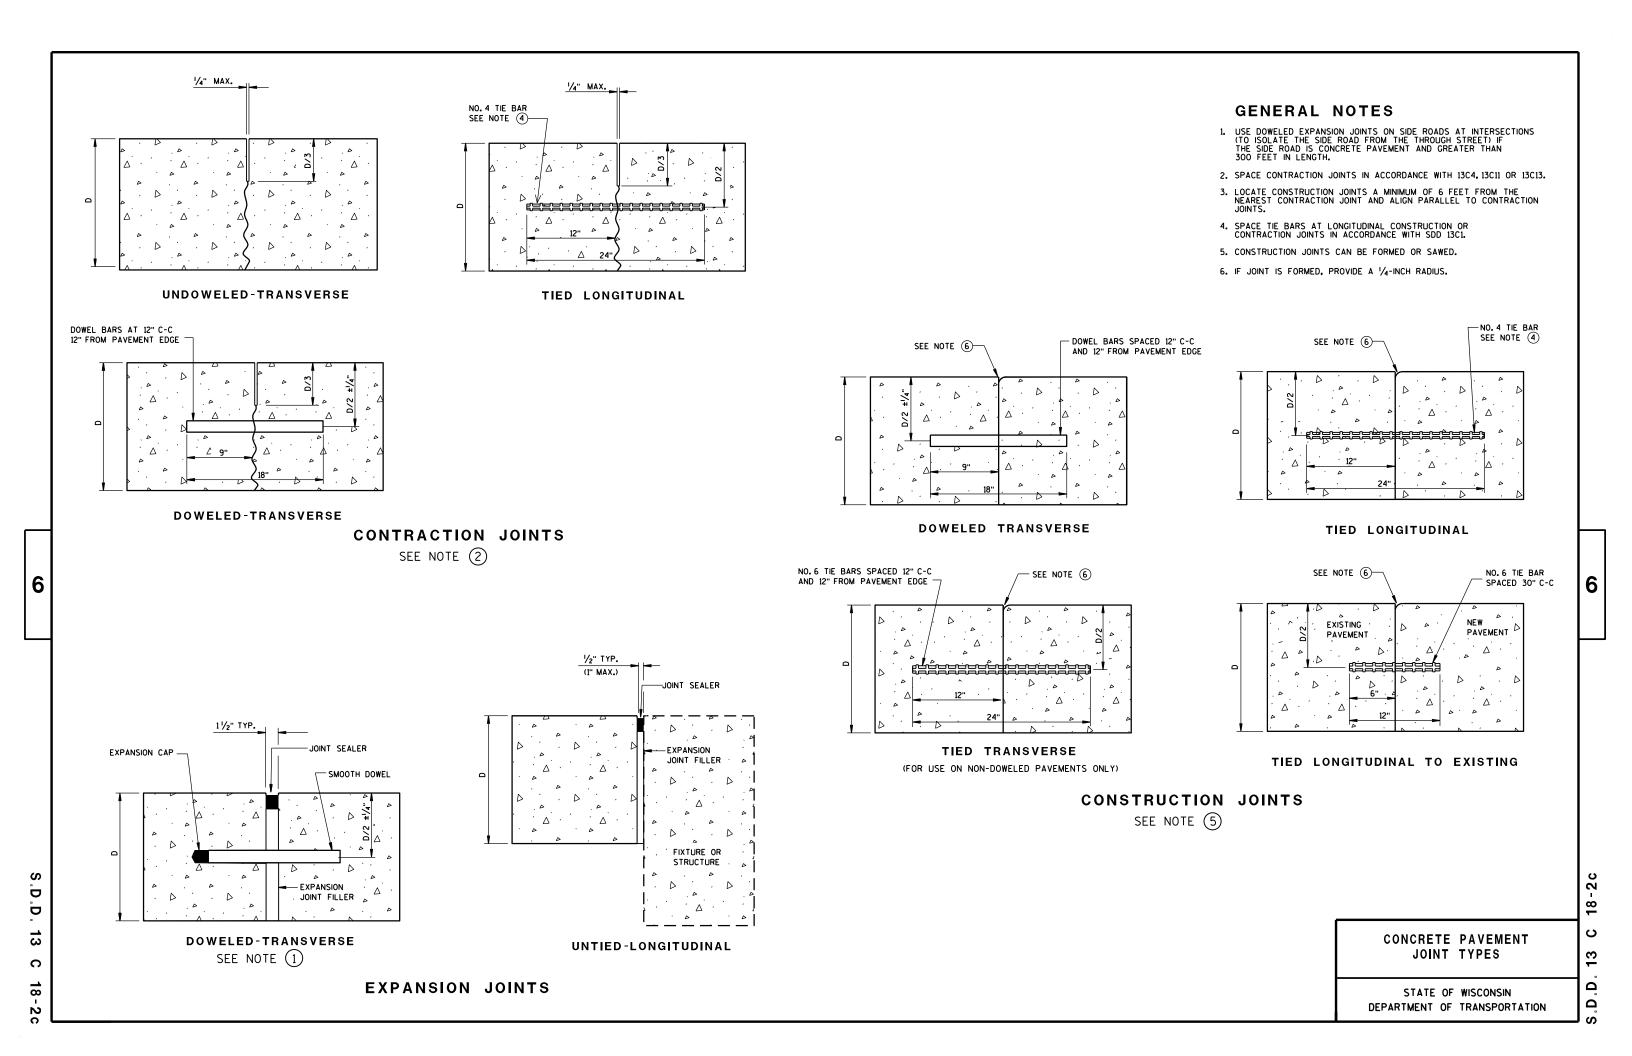


MANHOLE WITH LONGITUDINAL JOINT

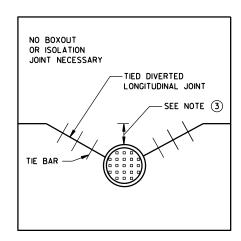


MANHOLE WITH DIVERTED LONGITUDINAL CONTRACTION JOINT

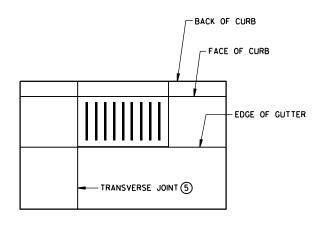

INLET WITH TRANSVERSE JOINT

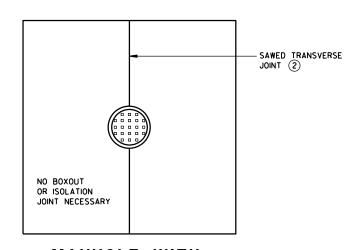

MANHOLE WITH TRANSVERSE JOINT

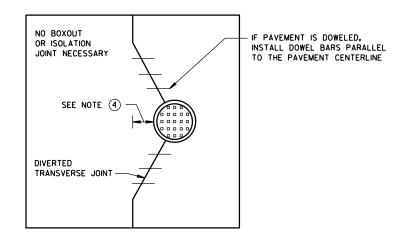

MANHOLE WITH DIVERTED TRANSVERSE CONTRACTION JOINT

## **GENERAL NOTES**

- ① USE BOXOUTS WHEN UTILITY STRUCTURE IS IN THE PATH OF CONSTRUCTION JOINTS. PROVIDE A 1-FOOT MINIMUM CLEARANCE BETWEEN THE EXTERIOR LIMIT OF THE STRUCTURE TO THE DIAMOND BOXOUT.
- 2 ADJUST TRANSVERSE JOINT TO INTERSECT MANHOLE IF POSSIBLE.
- (3) IF DISTANCE BETWEEN THE LONGITUDINAL JOINT AND THE EDGE OF MANHOLE IS 2 FEET OR LESS, DIVERT THE LONGITUDIAL JOINT AT A 2:1 TAPER RATE TO THE CENTER OF THE MANHOLE. IF THE DISTANCE IS GREATER THAN 2 FEET, DO NOT DIVERT THE JOINT AND SAW AS NORMAL. PLACE REBAR REINFORCEMENT AROUND THE MANHOLE.
- (4) IF DISTANCE FROM THE EDGE OF THE MANHOLE TO THE NEAREST TRANSVERSE JOINT IS 4 FEET OR LESS, REDIRECT JOINT TO INTERSECT THE CENTER OF THE MANHOLE. IF DISTANCE IS GREATER THAN 4 FEET, DO NOT DIVERT THE JOINT AND SAW AS NORMAL. PLACE REBAR REINFORCEMENT AROUND THE MANHOLE.
- (5) ALIGN TRANSVERSE JOINT WITH ONE EDGE OF INLET WHEN PRACTICAL.

CONCRETE PAVEMENT
JOINTING AT UTILITY FIXTURES

STATE OF WISCONSIN
DEPARTMENT OF TRANSPORTATION

APPROVED

5-3-2013
DATE

/S/ Deb Bischoff
PAVEMENT POLICY & DESIGN ENGINEER

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## BRIDGE ROAD 1)TWO-WAY **CLOSED** TYPE "A" WARNING LIGHTS REQUIRED OUTSIDE EDGE OF SHOULDER OUTSIDE EDGE OF SHOULDER OR FACE OF CURB OR FACE OF CURB **DETAIL D**

## ROAD CLOSURE BARRICADE DETAIL

APPROACH VIEW



LANE CLOSURE BARRICADE DETAIL

APPROACH VIEW

SEE SDD 15C2-SHEET "a" FOR LEGEND

#### **GENERAL NOTES**

THE EXACT NUMBER, LOCATION, AND SPACING OF ALL SIGNS AND BARRICADES SHALL BE ADJUSTED TO FIT FIELD CONDITIONS AS APPROVED BY THE ENGINEER.

ANY SIGNS TEMPORARY OR EXISTING, WHICH CONFLICT WITH TRAFFIC CONTROL "IN USE" SHALL BE REMOVED OR COVERED AS NEEDED AND AS APPROVED BY THE ENGINEER.

THE SPACING BETWEEN TRAFFIC CONTROL SIGNS SHOULD BE ADJUSTED TO NOT CONFLICT WITH AND SHOULD PROVIDE A DESIRABLE MINIMUM OF 200 FEET CLEARANCE TO EXISTING SIGNS THAT WILL REMAIN IN PLACE.

BARRICADES THAT MUST BE MOVED FOR A WORK OPERATION SHALL BE IMMEDIATELY RE-ESTABLISHED UPON COMPLETION OF THE OPERATION OR, FOR CONTINUING OPERATIONS, AT THE END OF EACH WORKING DAY.

SIGNS THAT WILL BE IN PLACE LESS THAN 7 CONTINUOUS DAYS AND NIGHTS MAY BE MOUNTED ON PORTABLE SUPPORTS.

ALL TYPE III BARRICADES SHALL HAVE RAILS REFLECTORIZED ON BOTH FACES. STRIPES SHALL BE PROPERLY SLOPED DOWN TOWARD THE TRAFFIC SIDE OR AS SHOWN IN THE ROAD CLOSURE BARRICADE DETAIL D FOR FULL ROAD CLOSURES.

TYPE "A" LOW-INTENSITY FLASHING WARNING LIGHTS SHALL BE VISIBLE ON BOTH SIDES OF THE

THE R11-2, R11-3, M4-9, R11-4 AND R10-61 SIGNS PLACED ON BARRICADES SHALL COVER NO MORE THAN THE TOP RAIL. THE SIGNS SHALL NOT COVER ANY PORTION OF THE MIDDLE OR BOTTOM RAILS.

"WO AND "MO" SIGNS ARE THE SAME AS "W" AND "M" SIGNS EXCEPT THE BACKGROUND IS ORANGE.

ALL SIGNS SHALL BE 48" X 48" UNLESS OTHERWISE NOTED BELOW:

R11-2 SHALL BE 48" X 30". R11-3, R11-4 AND R10-61 SHALL BE 60" X 30". M4-9 SHALL BE 30" X 24". M3-X SHALL BE 24" X 12". (36" X 18" IF NEEDED TO MATCH EXISTING SIGNS.) M4-8 SHALL BE 24" X 12". (30" X 15" IF NEEDED TO MATCH EXISTING SIGNS.)

M1-4, M1-5A, AND M1-6 SHALL BE 24" X 24". (36" X 36" IF NEEDED TO MATCH EXISTING SIGNS.) MO5-1 AND MO6-1 SHALL BE 21" X 21". (30" X 30" IF NEEDED TO MATCH EXISTING SIGNS.) D1-X SHALL BE AS SHOWN ON SPECIFIC PROJECT SIGNING DETAIL SHEETS. R1-1 SHALL BE 36" X 36".

- (1) TWO WARNING LIGHTS SHALL BE PROVIDED ON THE CENTER BARRICADE AND A MINIMUM OF ONE WARNING LIGHT SHALL BE PROVIDED ON EACH OF THE OTHER BARRICADES WITHIN THE ROADWAY LIMITS. SPACING OF THE WARNING LIGHTS SHALL BE UNIFORM TO THE EDGE OF ROADWAY AS SHOWN (APPROX. 8-FOOT
- THESE SIGNS AND BARRICADES ARE NOT REQUIRED IF ROAD CLOSURE BEGINS AT INTERSECTION.
- FOR ROAD CLOSURE WITHOUT LOCAL ACCESS TO PROJECT, SEE ROAD CLOSURE BARRICADE DETAIL D.
- FOR ROAD CLOSURE WITH LOCAL ACCESS TO PROJECT, SEE LANE CLOSURE BARRICADE DETAIL E.
- FOR BRIDGE OR CULVERT REPLACEMENTS, SUBSTITUTE "BRIDGE OUT" INSTEAD OF "ROAD CLOSED" ON R11-2 AND R11-3 SIGNS.
- INSTALL DETOUR AND COMMUNITY GUIDE SIGNS AND ARROWS ONLY IF SPECIFIED IN THE CONTRACT. IF THERE ARE EXISTING ROUTE MARKER ASSEMBLIES THAT WILL REMAIN IN PLACE, ADJUST THE LOCATION OF THE DETOUR ROUTE SIGNS TO CORRESPOND WITH THE EXISTING ASSEMBLIES. MODIFY EXISTING SIGNS WHERE POSSIBLE. SEE SPECIFIC PROJECT DETOUR SIGNING DETAIL SHEETS. IF DETOUR SIGNS ARE BEING INSTALLED BY OTHERS. PLACE THE CONTRACTED TRAFFIC CONTROL SIGNS TO ALLOW FOR PLACEMENT OF ALL WARNING, DETOUR AND GUIDE SIGNS AS SHOWN.
- "EAST" CARDINAL DIRECTION MARKERS AND RIGHT TURN ARROWS ARE SHOWN. USE OTHER CARDINAL DIRECTIONS AND ARROWS AS APPROPRIATE.


#### BARRICADES AND SIGNS FOR MAINLINE CLOSURES

STATE OF WISCONSIN DEPARTMENT OF TRANSPORTATION

/S/ Travis Feltes STATE TRAFFIC ENGINEER OF DESIGN

2

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## **GENERAL NOTES**

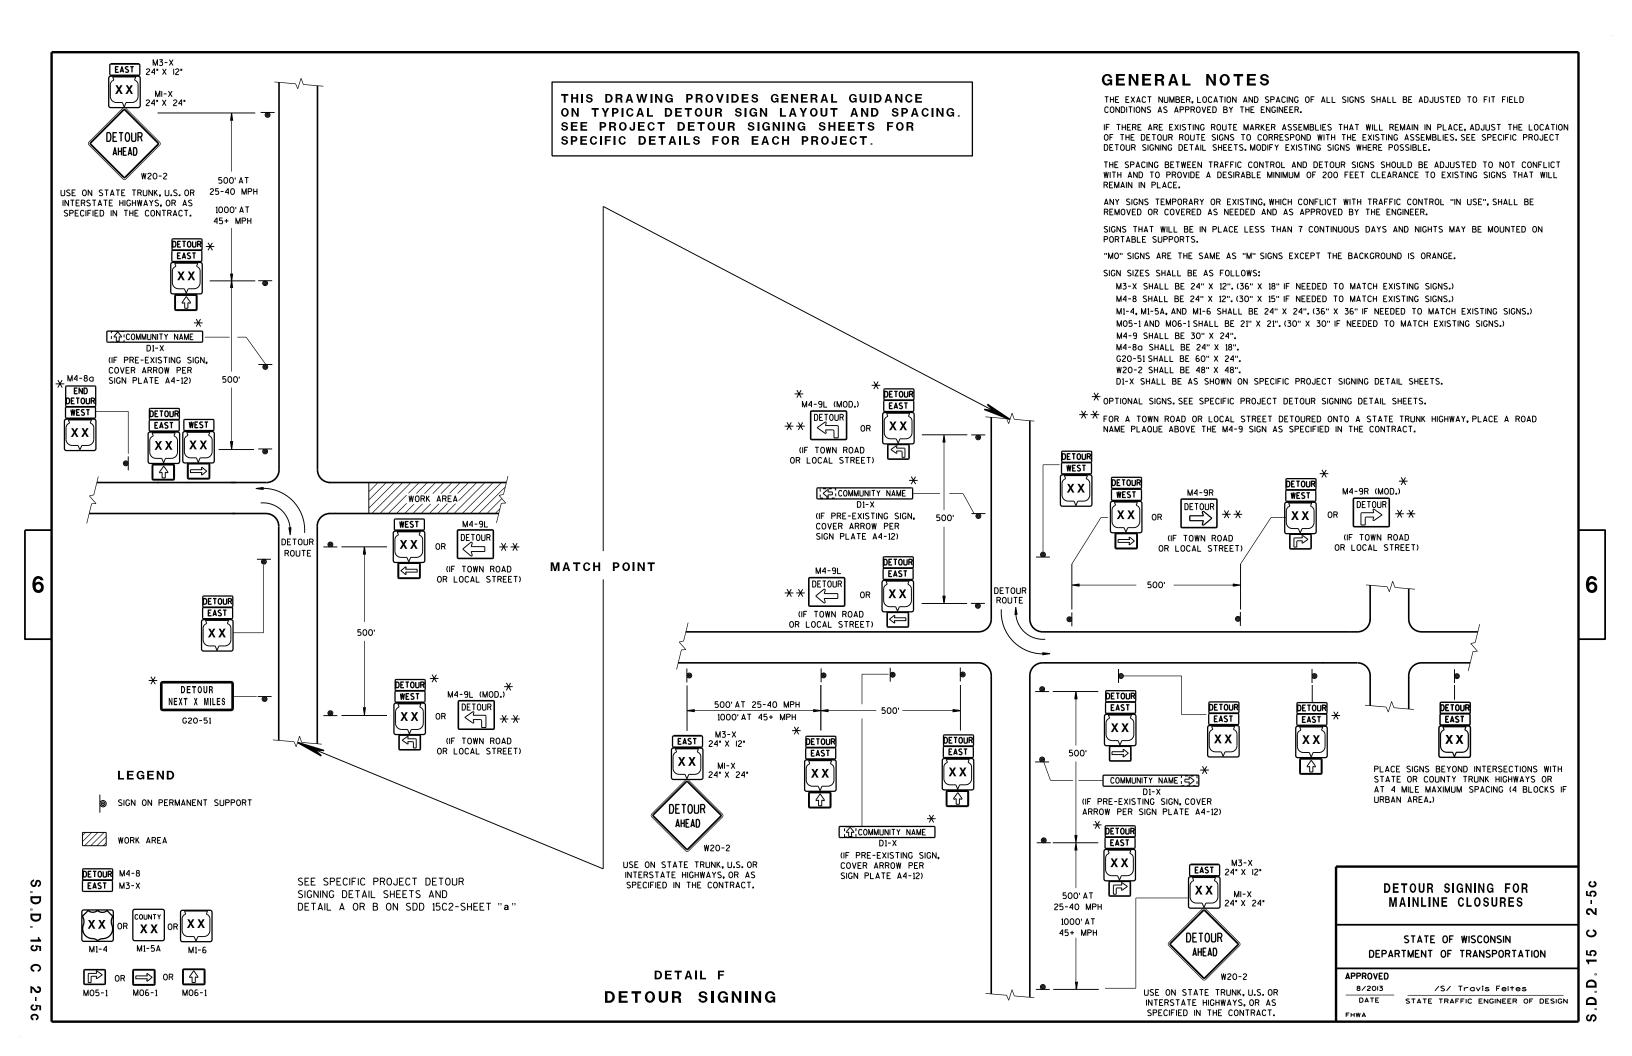THE EXACT NUMBER, LOCATION, AND SPACING OF ALL SIGNS AND BARRICADES SHALL BE ADJUSTED TO FIT FIELD CONDITIONS AS APPROVED BY THE ENGINEER.

ANY SIGNS TEMPORARY OR EXISTING, WHICH CONFLICT WITH TRAFFIC CONTROL "IN USE" SHALL BE REMOVED OR COVERED AS NEEDED AND AS APPROVED BY THE ENGINEER.

THE SPACING BETWEEN TRAFFIC CONTROL SIGNS SHOULD BE ADJUSTED TO NOT CONFLICT WITH AND SHOULD PROVIDE A DESIRABLE MINIMUM OF 200 FEET CLEARANCE TO EXISTING SIGNS THAT WILL REMAIN IN PLACE.

IF A "STOP" SIGN MUST BE REMOVED FOR A WORK OPERATION, A TEMPORARY "STOP" SIGN SHALL BE PLACED PRIOR TO THE SIGN REMOVAL, OR A FLAGGER SHALL BE PROVIDED UNTIL THE SIGN IS RE-ESTABLISHED.

BARRICADES THAT MUST BE MOVED FOR A WORK OPERATION SHALL BE IMMEDIATELY RE-ESTABLISHED UPON COMPLETION OF THE OPERATION OR, FOR CONTINUING OPERATIONS, AT THE END OF EACH WORKING DAY.

SIGNS THAT WILL BE IN PLACE LESS THAN 7 CONTINUOUS DAYS AND NIGHTS MAY BE MOUNTED ON PORTABLE SUPPORTS.

ALL TYPE III BARRICADES SHALL HAVE RAILS REFLECTORIZED ON BOTH FACES. STRIPES SHALL BE PROPERLY SLOPED DOWN TOWARD THE TRAFFIC SIDE OR AS SHOWN IN THE ROAD CLOSURE BARRICADE DETAIL D FOR FULL ROAD CLOSURES.

TYPE "A" LOW-INTENSITY FLASHING WARNING LIGHTS SHALL BE VISIBLE ON BOTH SIDES OF THE BARRICADE.

THE R11-2, R11-3 AND R11-4 SIGNS PLACED ON BARRICADES SHALL COVER NO MORE THAN THE TOP RAIL. THE SIGNS SHALL NOT COVER ANY PORTION OF THE MIDDLE OR BOTTOM RAILS.

ALL SIGNS SHALL BE 48" X 48" UNLESS OTHERWISE NOTED BELOW:
RI1-2 SHALL BE 48" X 30".
RI1-4 AND RI1-3 SHALL BE 60" X 30".

\*OMIT THE "ROAD CLOSED 500 FT." SIGN IF THE LAST INTERSECTION IS 500 FT. OR LESS FROM THE WORK ZONE.

\*\*500' MAX. OR AT LAST INTERSECTION WHICHEVER IS CLOSER.

#### **LEGEND**

SIGN ON PERMANENT SUPPORT

TYPE III BARRICADE

TYPE III BARRICADE WITH
ATTACHED SIGN

(A) TYPE "A" WARNING LIGHT (FLASHING)

//// w

WORK AREA

#### BARRICADES AND SIGNS FOR SIDEROAD CLOSURES


STATE OF WISCONSIN
DEPARTMENT OF TRANSPORTATION


APPROVED

8/2013 /S/ Travis Feltes


DATE STATE TRAFFIC ENGINEER OF DESIGN

S.D.D. 15 C 3-2

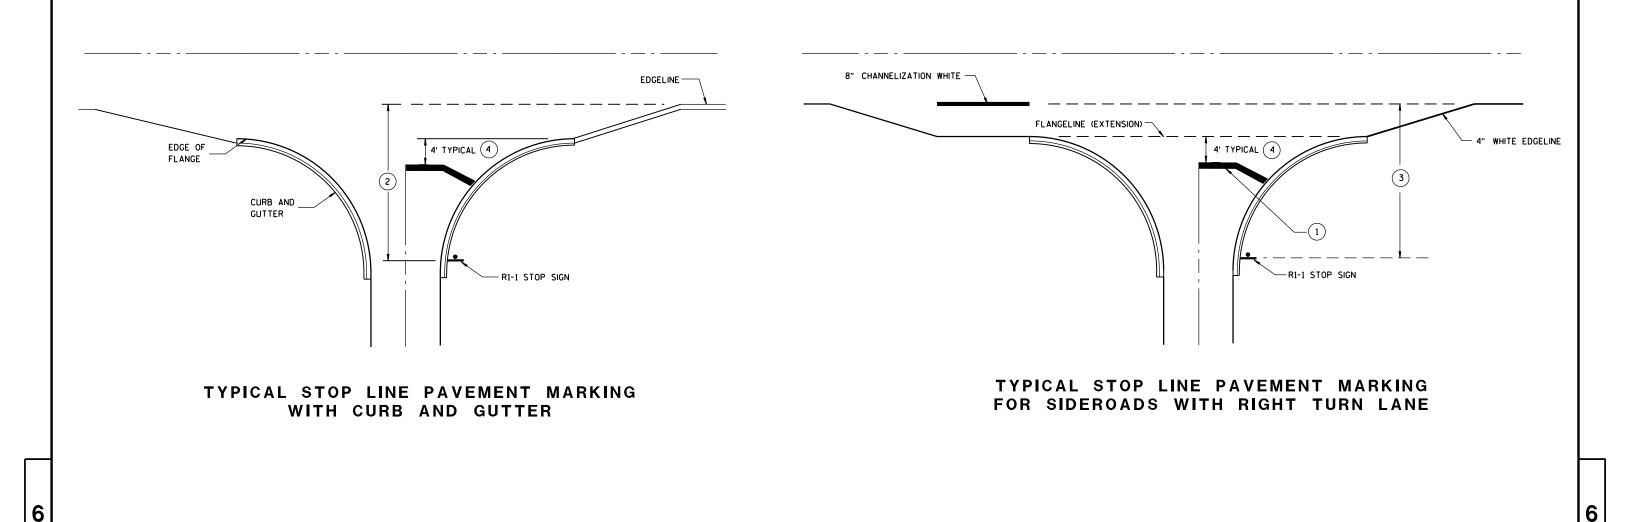

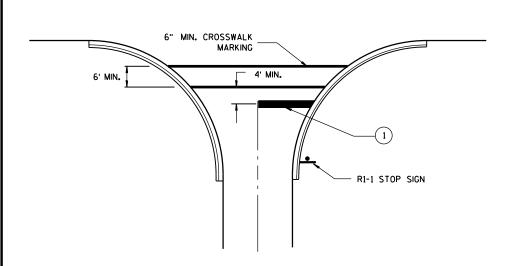

TYPICAL STOP LINE PAVEMENT MARKING FOR SIDEROADS WITH CROSSWALK MARKING

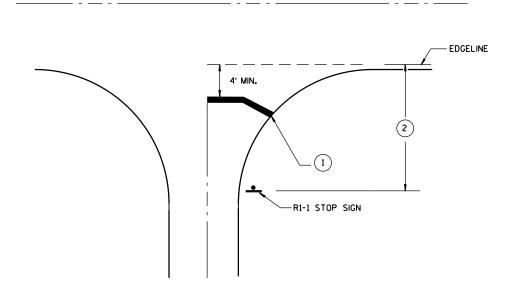

TYPICAL STOP LINE PAVEMENT MARKING WITHOUT CURB AND GUTTER

## GENERAL NOTES

- 1 18-INCH STOP LINES MAY BE DELETED OR ADDED BY THE PROJECT ENGINEER BASED ON VISIBILITY AND SIGHT LINES.
- 2 IF STOP SIGN IS LESS THAN OR EQUAL TO 40 FEET FROM THE EDGELINE THAN NO STOP LINE IS REQUIRED.
- (3) IF STOP SIGN IS LESS THAN OR EQUAL TO 30 FEET FROM THE FLANGELINE EXTENSION THAN NO STOP LINE IS REQUIRED.
- MOVE CLOSER TO EDGE OF TRAVEL LANE AS NEEDED FOR VISIBILITY AND SIGHT LINES.

# STOP LINE AND CROSSWALK PAVEMENT MARKING


STATE OF WISCONSIN
DEPARTMENT OF TRANSPORTATION

APPROVED	
4/30/2013	/S/ Travis Feltes
DATE	STATE TRAFFIC ENGINEER
FHWA	

.D.D. 15 C 33-1

S.D.D.



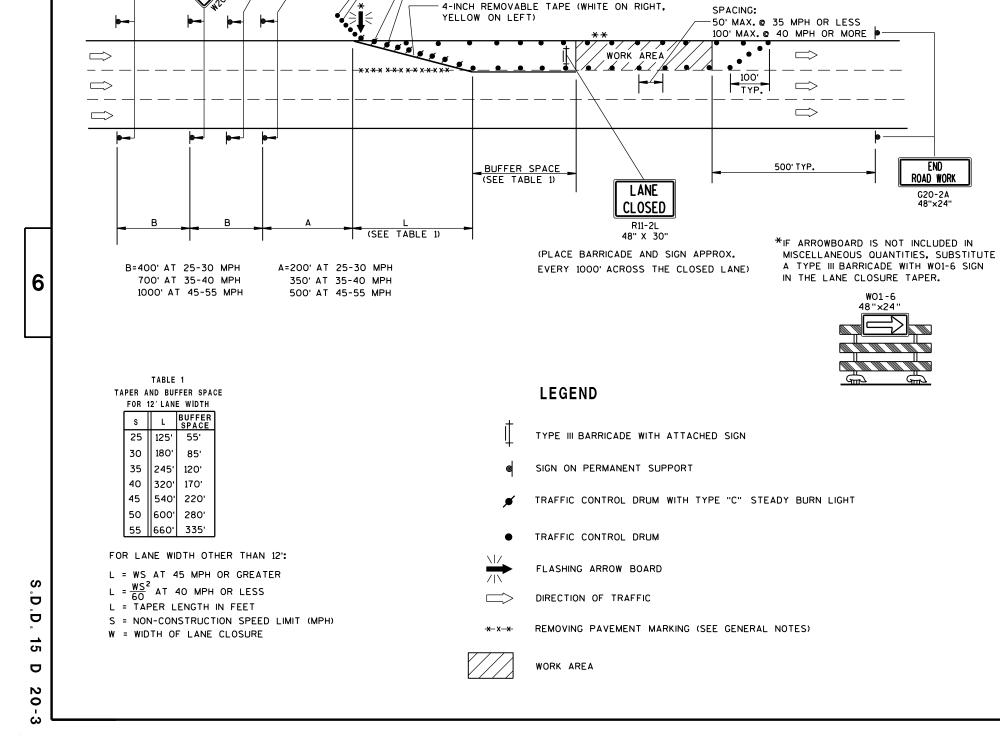

(5) DRUMS SPACED @ 10'

INTERVALS AS NEEDED IN

FRONT OF ARROW BOARD

25'@ 35 MPH OR LESS

50'@ 40 MPH OR MORE

TEMPORARY PAVEMENT MARKING.

SPACING:

ROAD WORK

NEXT\_\_\_MILES

G20-1

60" X 24"

CLOSED

AHEAD

AHEAD

## **GENERAL NOTES**

\*\*THE LINE OF DRUMS SHOWN ALONG THE MEDIAN/CENTERLINE

ADJACENT TO THE WORK AREA. FOR THIS CONDITION INSTALL

W20-1 "ROAD WORK AHEAD" SIGN FOR OPPOSING DIRECTION OF

IS REQUIRED ONLY WHERE THERE IS OPPOSING TRAFFIC

TRAFFIC, IN ADVANCE OF THE WORK AREA.

THIS LANE CLOSURE DETAIL IS TYPICAL FOR CLOSING THE LEFT LANE. FOR A RIGHT LANE CLOSURE, REVERSE THE TRAFFIC CONTROL.

THIS DETAIL MAY BE USED FOR ROADWAYS WITH EITHER TWO OR THREE LANES IN EACH DIRECTION.

THE EXACT NUMBER, LOCATION, AND SPACING OF ALL SIGNS AND DEVICES SHALL BE ADJUSTED TO FIT FIELD CONDITIONS AS APPROVED BY THE ENGINEER.

THE SPACING BETWEEN TRAFFIC CONTROL SIGNS SHOULD BE ADJUSTED TO NOT CONFLICT WITH AND SHOULD PROVIDE A DESIRABLE MINIMUM OF 200 FEET CLEARANCE TO EXISTING SIGNS THAT WILL REMAIN IN PLACE.

ALL SIGNS ARE 48"×48" UNLESS OTHERWISE NOTED. IF NECESSARY DUE TO SPACE CONSTRAINTS IN URBAN AREAS, 36" X 36" SIGNS MAY BE USED IF APPROVED BY DISTRICT TRAFFIC UNIT.

"WO" SIGNS ARE THE SAME AS "W" SIGNS EXCEPT THE BACKGROUND IS ORANGE.

SIGNS THAT WILL BE IN PLACE LESS THAN 7 CONTINUOUS DAYS AND NIGHTS, OR THAT WILL BE PLACED IN A CLOSED LANE, MAY BE MOUNTED ON PORTABLE SUPPORTS.

ANY SIGNS TEMPORARY OR EXISTING, WHICH CONFLICT WITH TRAFFIC CONTROL "IN USE" SHALL BE REMOVED OR COVERED AS NEEDED AND AS APPROVED BY THE ENGINEER.

REMOVE PAVEMENT MARKINGS AND PLACE TEMPORARY PAVEMENT MARKING, REMOVABLE TAPE IF LANE CLOSURE IS TO BE IN PLACE FOR 4 OR MORE CONTINUOUS DAYS AND NIGHTS.

ON UNDIVIDED ROADWAYS, OMIT THE SIGNS SHOWN ON LEFT SIDE OF ROAD.

W2O-1, G2O-1 AND G2O-2A SIGNS ARE NOT REQUIRED IF THE LANE CLOSURE IS WITHIN A LARGER WORK ZONE WHERE THESE SIGNS ARE ALREADY PRESENT.

OMIT G20-1 SIGNS IF LENGTH OF WORK AREA IS 2 MILES OR LESS.

CONSIDER GEOMETRICS WHEN LOCATING SIGNS AND ARROWBOARDS SO THE APPROACHING DRIVER HAS A CLEAR VIEW OF THE ARROWBOARDS AND LANE CLOSURE DRUMS.

PLACE THE ARROWBOARD AS CLOSE AS POSSIBLE TO THE BEGINNING OF THE LANE CLOSURE TAPER, PREFERABLY ON THE SHOULDER OR TERRACE.

CHANNELIZING DEVICES PLACED ADJACENT TO WORK AREA SHALL BE PULLED BACK FROM THE TRAVEL LANE WHEN WORK IS NOT IN PROGRESS.

BARRICADES IN A CLOSED LANE THAT MUST BE MOVED FOR A WORK OPERATION SHALL BE IMMEDIATELY RE-ESTABLISHED UPON COMPLETION OF THE OPERATION OR, FOR CONTINUING OPERATIONS, AT THE END OF EACH WORKING DAY.


WARNING LIGHTS ARE NOT REQUIRED IF THE LANE CLOSURE IS A DAYTIME ONLY OPERATION.

TRAFFIC CONTROL, SINGLE LANE CLOSURE, NON-FREEWAY/EXPRESSWAY

STATE OF WISCONSIN
DEPARTMENT OF TRANSPORTATION

APPROVED
Feb. 2015
DATE
STATE TRAFFIC ENGINEER OF DESIGN

S.D.D. 15 D 2

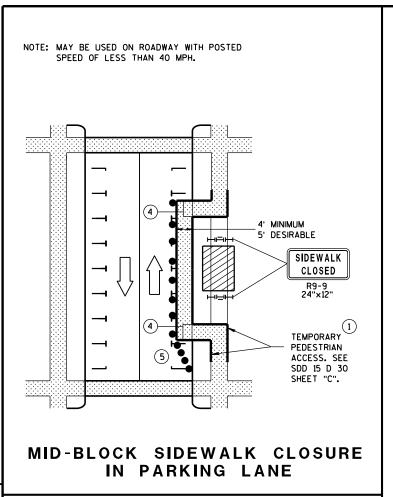

NOTE: LAYOUT SAME AS ABOVE. 4' MINIMUM 5' DESIRABLE SIDEWALK CLOSED RQ-Q TEMPORARY PEDESTRIAN ACCESS. SEE SDD 15 D 30 SHEET "C". SIDEWALK DIVERSION


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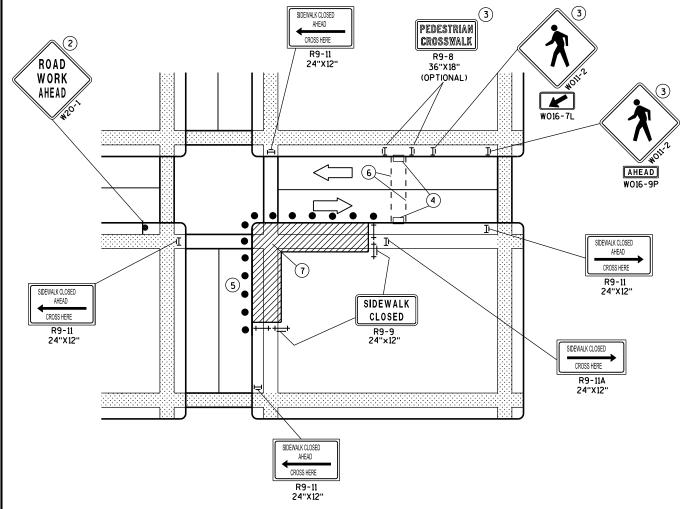
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MID-BLOCK SIDEWALK CLOSURE



CORNER SIDEWALK CLOSURE WITH TEMPORARY CROSSWALK

## **GENERAL NOTES**

WHEN CLOSING OR RELOCATING CROSSWALKS OR SIDEWALKS, PROVIDE DETECABLE TEMPORARY FACILITIES AND INCLUDE ACCESSIBILITY FEATURES CONSISTENT WITH EXISTING PEDESTRIAN FACILITIES.

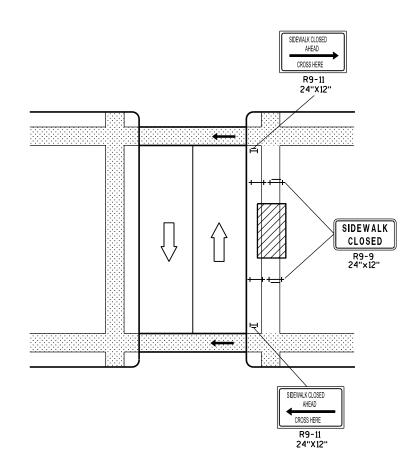TEMPORARY TRAFFIC CONTROL DEVICES FOR PEDESTRIANS ARE SHOWN. OTHER DEVICES MAY BE NECESSARY TO CONTROL VEHICULAR TRAFFIC. STAGE WORK, AS NECESSARY, TO PROVIDE A TEMPORARY PEDESTRIAN ACCESS ROUTE AT ALL TIMES. FOR ROADWAYS WITH NO AVAILABLE DETOURS, MAINTAIN ONE OPEN SIDEWALK AT ALL TIMES.

"WO" SIGN IS THE SAME AS "W" SIGN EXCEPT THE BACKGROUND IS ORANGE.

FOR NIGHTTIME CLOSURE USE TYPE "A" FLASHING WARNING LIGHTS ON BARRICADES, SUPPORTING SIGNS AND CLOSING SIDEWALK. USE TYPE "C" STEADY BURN LIGHTS ON CHANNELIZING DEVICES SEPARATING THE WORK AREA FROM VEHICULAR TRAFFIC.

PEDESTRIAN TRAFFIC SIGNAL DISPLAY CONTROLLING CLOSED CROSSWALK SHALL BE COVERED OR DEACTIVATED.

POST MOUNTED SIGNS LOCATED ADJACENT TO A SIDEWALK SHALL HAVE A 7 FOOT MINIMUM CLEARANCE FROM THE BOTTOM OF THE SIGN TO THE SIDEWALK SURFACE.

ALTERNATE SIDEWALK WORK BETWEEN LEFT AND RIGHT SIDE OF ROADWAY TO MAINTAIN PEDESTRIAN ACCESS.

- 1) IF SIDEWALK CLOSURE AFFECTS AN ACCESSIBLE AND DETECTABLE FACILITY, MAINTAIN ACCESSIBILITY AND DETECTABILITY ALONG THE ALTERNATE PEDESTRIAN ROUTE.
- 2) "ROAD WORK AHEAD" SIGNS ARE NOT REQUIRED IF THE SIDEWALK CLOSURE OCCURS WITHIN A LARGER WORK ZONE WHERE ADVANCE WARNING SIGNS ARE ALREADY PRESENT, OR IF THE WORK AREA AND EQUIPMENT ARE MORE THAN 2 FEET BEHIND THE CURB.
- (3) IF TEMPORARY PEDESTRIAN CROSSWALK IS NOT PROVIDED, OMIT R9-8 AND WO11-2 SIGN ASSEMBLIES. IF PROVIDED INCLUDE ON BOTH SIDES OF THE CROSSWALK.
- (4) TEMPORARY CURB RAMPS. SEE SDD 15 D 30 SHEET "B".
- (5) DRUMS OR BARRICADES AT 25 FOOT SPACING. STREET PARKING SHALL BE PROHIBITED FOR AT LEAST 50 FEET IN ADVANCE OF THE MID-BLOCK CROSSWALK.
- (6) TEMPORARY PAVEMENT MARKING FOR CROSSWALK LINES.
- (7) LIMIT WORK TO ONE QUADRANT AT A TIME TO MINIMIZE PEDESTRIAN

#### **LEGEND**

SIGN ON PERMANENT SUPPORT

UNDER PEDESTRIAN TRAFFIC

TRAFFIC TRAFFIC CONTOL DRUM

DIRECTION OF

WORK AREA

PEDESTRIAN CHANNELIZATION DEVICE

TYPE II BARRICADE WITH/WITHOUT SIGN (ALL WITH ONE WARNING LIGHT, TYPE A. LOW-INTENSITY FLASHING)

TYPE III BARRICADE WITH/WITHOUT SIGN (ALL WITH ONE WARNING LIGHT, TYPE A, LOW-INTENSITY FLASHING)

## TRAFFIC CONTROL, PEDESTRIAN ACCOMMODATION

STATE OF WISCONSIN DEPARTMENT OF TRANSPORTATION S 0 က Ω Ω

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PARALLEL TO CURB

TEMPORARY BUS STOP PAD

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#### GENERAL NOTES


NOTIFY THE BUS COMPANY 7 DAYS IN ADVANCE OF THE BUS STOP RELOCATION. ALTERNATE SIDEWALK WORK BETWEEN LEFT AND RIGHT SIDE OF ROADWAY TO MAINTAIN PEDESTRIAN ACCESS.


- (1) CURB RAMPS SHALL BE 48" MIN. WIDTH WITH A FIRM, STABLE AND SLIP RESISTANT SURFACE. INSTALL CONTRASTING DETECTABLE WARNING FIELD AT PEDESTRIAN STREET CROSSINGS. REFER TO SDD 8D5 SHEET "E".
- ② PROTECTIVE EDGING WITH A 2" MIN. HEIGHT SHALL BE INSTALLED WHEN A CURB RAMP OR LANDING PLATFORM HAS A VERTICAL DROP OF 6" OR GREATER OR HAS A SIDE APRON SLOPE STEEPER THAN 1:3 (33%). PROTECTIVE EDGING SHOULD BE CONSIDERED WHEN CURB RAMPS OR LANDING PLATFORMS HAVE A VERTICAL DROP OF 3" OR MORE.
- (3) DETECTABLE EDGING WITH 6" MIN. HEIGHT AND CONTRASTING COLOR SHALL BE INSTALLED ON ALL CURB RAMP LANDINGS WHERE THE WALKWAY CHANGES DIRECTION (TURNS).
- (4) CURB RAMPS AND LANDINGS SHALL HAVE A 1:50 (2%) MAX. CROSS-SLOPE.
- 5 CLEAR SPACE OF 48"X48" MIN. SHALL BE PROVIDED ABOVE AND BELOW THE CURB RAMP.
- (6) THE CURB RAMP WALKWAY EDGE SHALL BE MARKED WITH A YELLOW COLOR, 4" WIDE MARKING, UNLESS A CONTRASTING DETECTABLE WARNING FIELD IS PROVIDED.
- 7 DO NOT RESTRICT WATER FLOW IN THE GUTTER SYSTEM.
- (8) LATERAL JOINTS OR GAPS BETWEEN SURFACES SHALL BE LESS THAN 1/2" WIDTH.
- (9) CHANGES BETWEEN SURFACE HEIGHTS SHALL NOT EXCEED 1/2". LATERAL EDGES SHALL BE VERTICAL UP TO 1/4" HIGH, AND BEVELED AT 1:2 BETWEEN 1/4" AND 1/2".
- 5' WIDE MIN. WITH PEDSETRIAN SAFETY FENCE, 10' WIDE MIN. WITHOUT PEDESTRIAN SAFETY FENCE.

DEPARTMENT OF TRANSPORTATION

 $\frac{\text{March 2015}}{\text{DATE}} \quad \frac{\text{/S/ Trav1s Feltes}}{\text{STATE TRAFFIC ENGINEER OF DESIGN}}$ 


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1. Signs are Type II - Type H Reflective - reference WIS DOT Standard

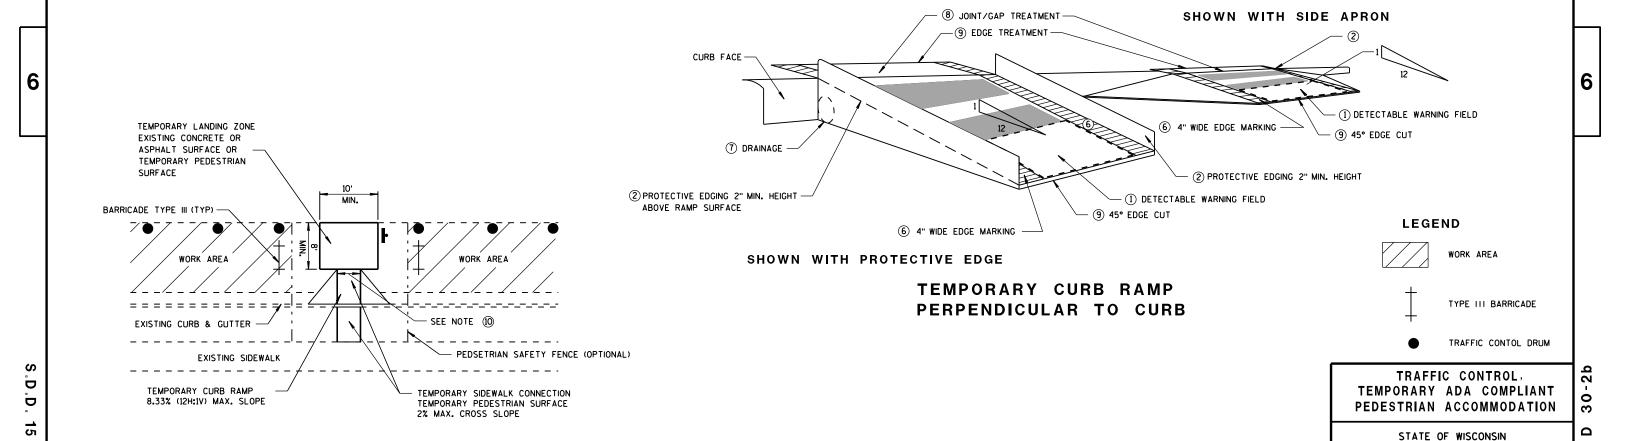areater than 48 inches (both vertical and horizontal) shall have one horizontal splice between the arrows and route shields. Vertical splices shall not be used on route assemblies with a horizontal dimension of 144 inches or less. The contractor shall not use more than one vertical joint per sign and the joint shall be between route shields.

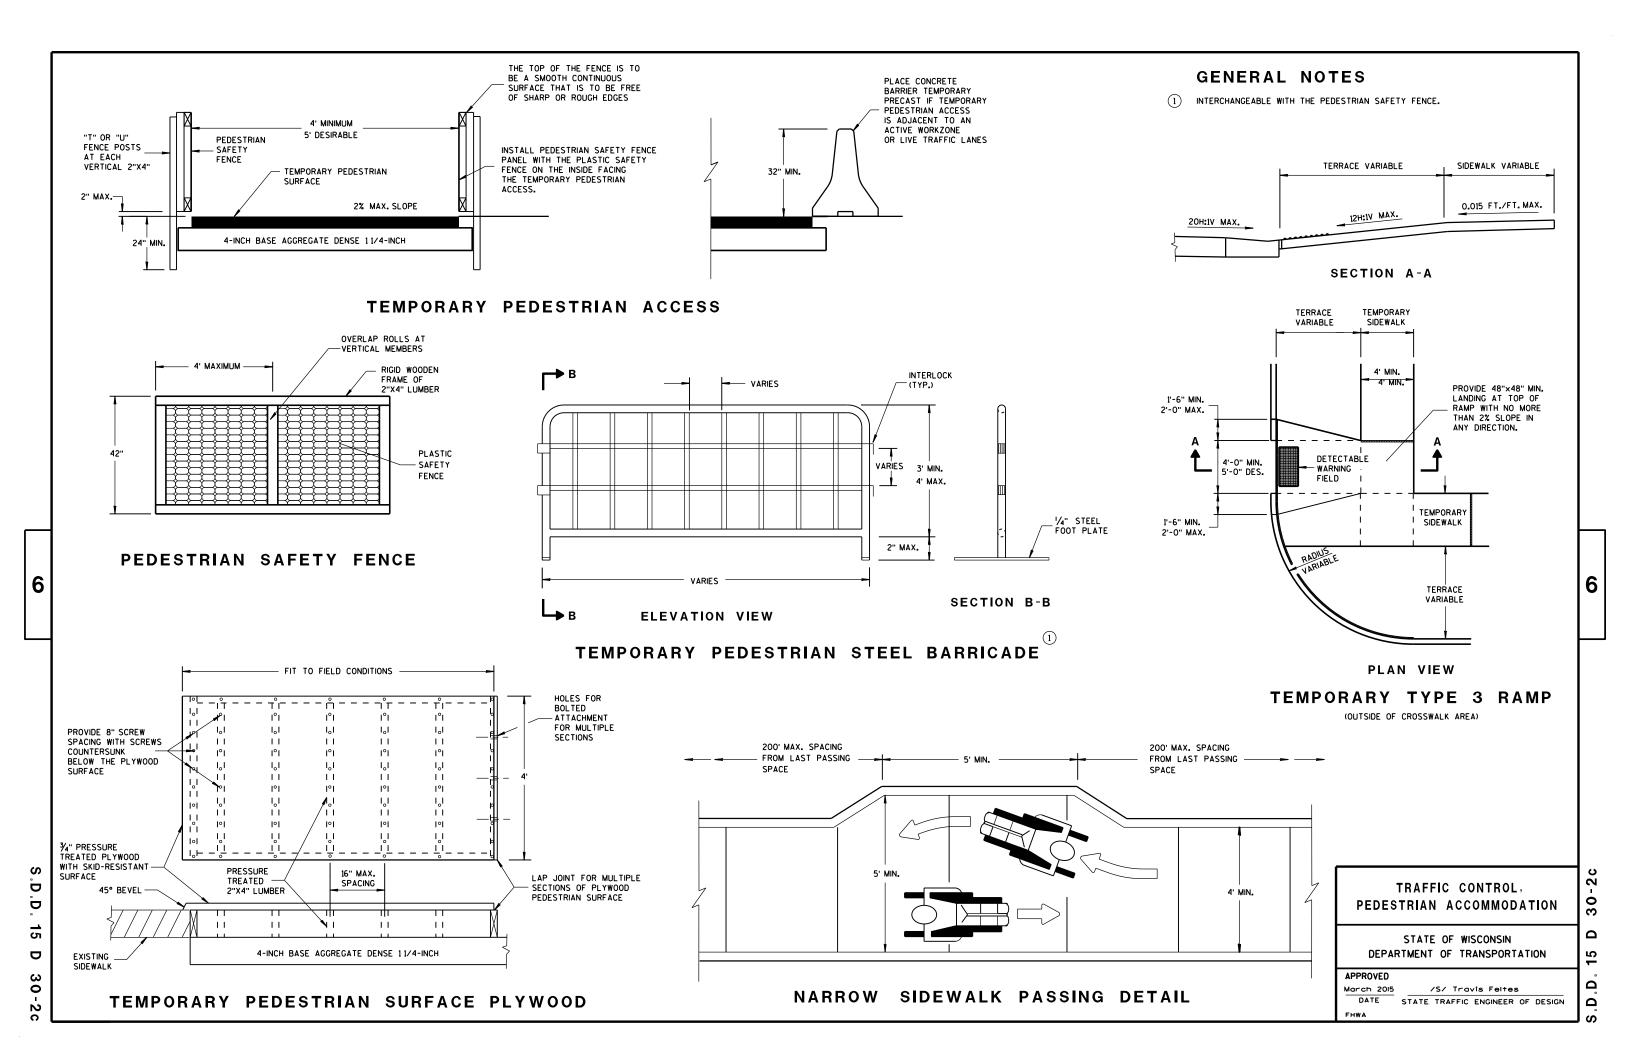

PROJECT NO:

J32-1

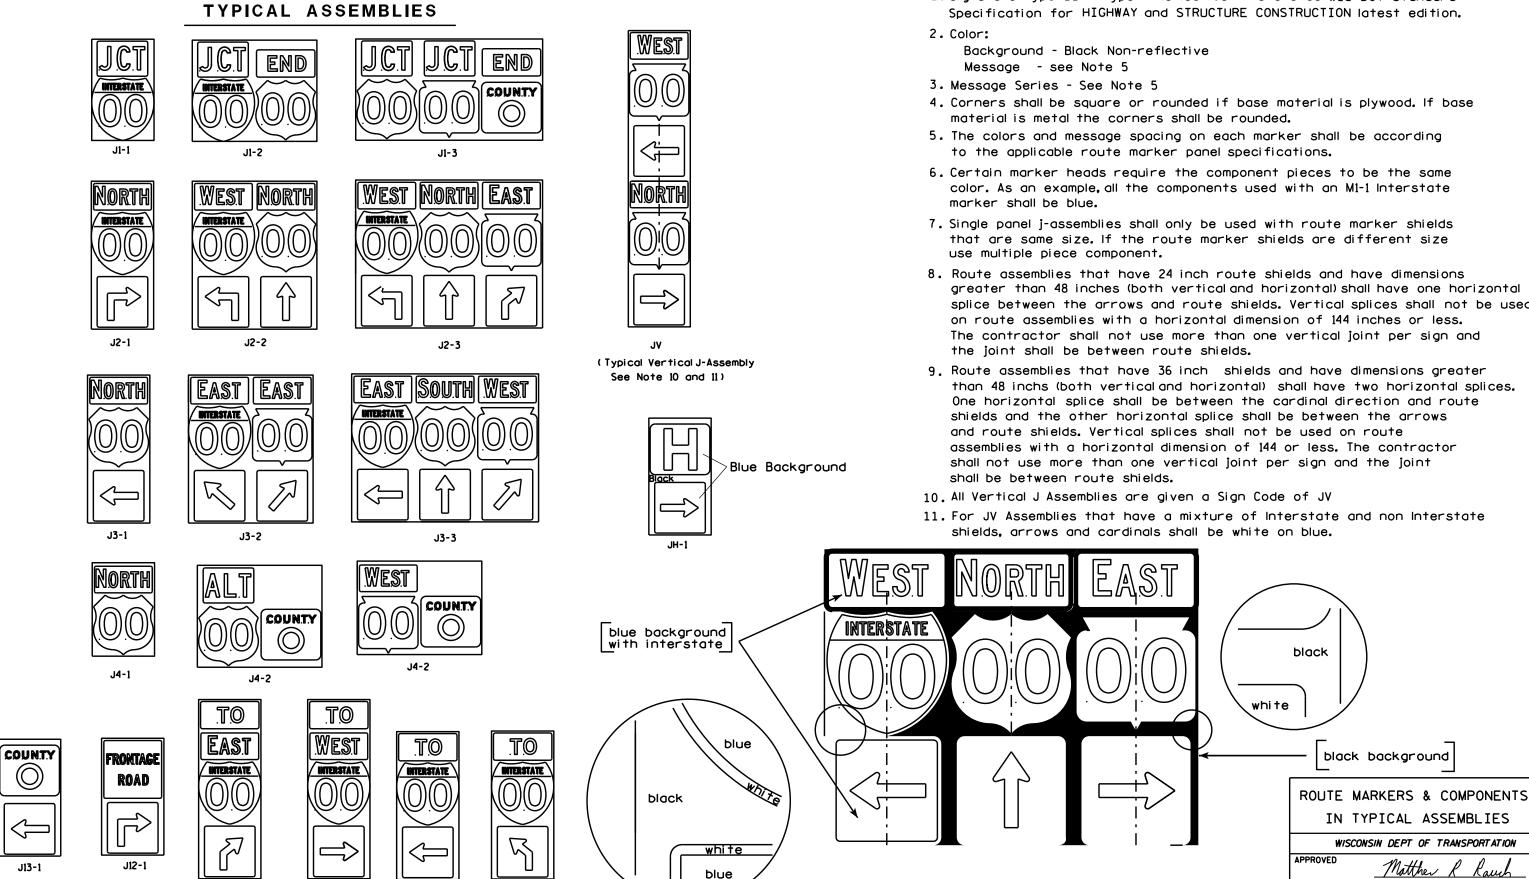J22-1

J23-1

J33-1

PLOT BY: mscsja

PLATE NO. \_\_A2-15.8


DATE 2/06/14

SHEET NO:


## URBAN ARFA

2' Min - 4' Max (See Note 6) 7'-3"(士) \*\* Curb Flowline. White Edgeline Location

RURAL AREA (See Note 2)

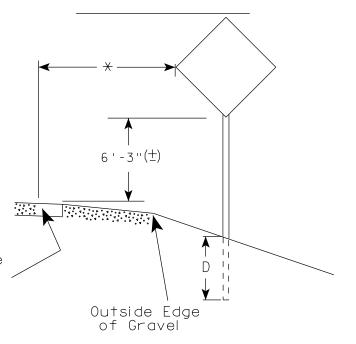

2' Min - 4' Max (See Note 6)

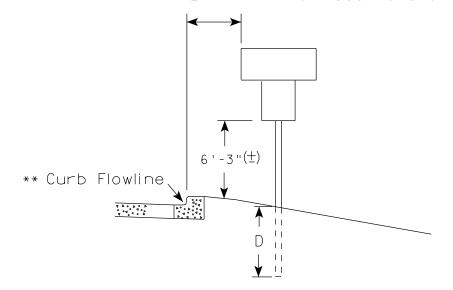

5'-3"(生)  $D^{-1}$ Outside Edae of Gravel

White Edgeline Location

\*\* The existence of curb and gutter does not in itself mandate the vertical clearance illustrated.

HWY:

That height is typically measured where there is sidewalk adjacent to the roadway or parking is permitted. In the absence of sidewalk vertical clearance is measured from the top of the curb. Offset of signs is measured from the flow line.

\* 6 feet from edge of a paved shoulder or 12 feet from the edge of pavement (edge line location) or 2 feet from outside edge of gravel, whichever is greater unless directed by project engineer.

PLOT DATE: 12-NOV-2014 14:03

## GENERAL NOTES

- 1. Signs wider than 4 feet, 20 sq.ft or larger, shall be mounted on multiple posts. Refer to plate A4-4.
- 2. If signs are mounted on barrier wall, see A4-10 sign plate.
- 3. For expressways and freeways, mounting height is  $7'-3''(\pm)$  or 6'-3" (±) depending upon existence of a sub-sign.
- 4. Minimum mounting height for J assemblies (A2-1S) is  $7'-3''(\pm)$  or  $6'-3''(\pm)$ per urban or rural detail respectively.
- 5. Minimum mounting height for signs mounted on traffic signal poles is 5' - 3'' ( $\pm$ ).
- 6. Offset distance shall be consistent with existing signs or consistent throughout length of project.
- 7. The (+) tolerance for mounting height is 3 inches.
- 8. Folding signs shall be mounted at a height of 5'-3'' ( $\pm$ ) or as directd by the Engineer.
- 9. The Double Arrow sign (W12-1) shall be mounted at a height of 2'-3"  $(\pm)$ . The Chevron sign (W1-8), Roundabout Chevron panel (R6-4B), Enhanced Reference Markers, Clearance Markers (W5-52), Mile Markers (D10 series), In Road Object Markers (W5-54) & End of Road Markers (W5-56) shall be mounted at a height of 4'-3'' ( $\pm$ ).

#### POST EMBEDMENT DEPTH

D
(Min)
4'
5'

TYPICAL INSTALLATION OF PERMANENT TYPE II SIGNS ON SINGLE POSTS

WISCONSIN DEPT OF TRANSPORTATION

SHEET NO:

APPROVED

for State Traffic Engineer

DATE 11/12/14

PROJECT NO: FILE NAME : C:\CAEFiles\Projects\tr\_stdplate\A43.DGN COUNTY:

PLOT BY: mscsja

PLOT NAME :

WISDOT/CADDS SHEET 42

PLOT SCALE: 99.237937:1.000000



NOTES: 1. ALL MATERIAL TO BE APPROVED

BY ENGINEER PRIOR TO INSTALLATION

- 2. SEE SIGN PLATE A4-8 FOR SIGN HARDWARE REQUIREMENTS
- 3. 18 INCH X 18 INCH SQUARE BOX-OUTS MAY BE USED FOR INSTALLATIONS IN EXISTING CONCRETE OR ASPHALT LOCATIONS.



## ELEVATION VIEW

DETAIL OF STEEL 2 X 2 SIGN POST IN BOX-OUT



DETAIL OF WOOD 4 X 6 SIGN POST IN BOX-OUT

HWY:



#### PLAN VIEW

COUNTY:

FOR NEW CONCRETE/ASPHALT INSTALLATIONS

SIGN POST BOX-OUTS A4-3B

WISCONSIN DEPT OF TRANSPORTATION

For State Traffic Engineer

DATE 1/27/14 PLATE NO. A4-3B.1

SHEET NO:

FILE NAME : C:\CAEFiles\Projects\tr\_stdplate\A43B.DGN

PROJECT NO:

PLOT DATE: 27-JAN-2014 09:48

PLOT NAME :

PLOT BY: mscsja

PLOT SCALE: 13.659812:1.000000

APPROVED

WISDOT/CADDS SHEET 42


## GENERAL NOTES

- 1. For 3 or 4 post installations, individual post spacing shall be greater than 3'-6".
- 2. See tables below for required number of posts.
- 3. For expressways and freeways. mounting height is 7'-3'' (±) or 6'-3'' (±) depending upon existence of sub-sign.
- 4. The (±) tolerance for mounting height is 3 inches.
- 5. Minimum mounting height for J assemblies (A2-1S) is 7'-3'' (±) or 6'-3'' (±) per urban or rural detail respectively.
- 6. Offset distance shall be consistent with existing signs or consistent throughout length of project.
- 7. Folding signs shall be mounted at a height of 5'-3" (±) or as directed by the engineer.
- 8. The Double Arrow sign (W12-1) shall be mounted at a height of 2'-3" (±). The Chevron sign (W1-8). Roundabout Chevron panel (R6-4B), Clearance Markers (W5-52), Mile Markers (D10 series), In Road Object Markers (W5-54) & End of Road Markers (W5-56) shall be mounted at a height of 4"-3" (±).
- \* 6 feet from edge of a paved shoulder or 12 feet from the edge of pavement (edge line location) or 2 feet from outside edge of gravel, whichever is greater unless directed by project engineer.
- \*\* The existence of curb and gutter does not in itself mandate the vertical clearance illustrated. That height is typically measured where there is sidewalk adjacent to the roadway or parking is permitted. In the absence of sidewalk vertical clearance is measured from the top of the curb. Offset of signs is measured from the flow line.
- \*\*\* See A4-3 sign plate for signs 4' or less in width or less than 20 S.F. in area.

#### URBAN AREA RURAL AREA (See Note 3) 2'Min - 4'Max (See Note 6) ₩E# FF# 6'-3"(±) 6'-3"(±) 7'-3"(±) \*\* Curb \*\*\*\*\ Flowline D **7000** White Edgeline

# 2' Min - 4' Max (See Note 6) 6'-3"(±) Curb Flowline. 48" DIAMOND WARNING SIGN

D 11

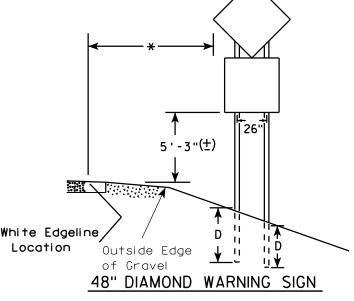

COUNTY:

Outside Edge

of Gravel

	SIGN SHAPE OTHER THAN DIAMOND (TWO POSTS REQUIRED)									
	L	E								
<del>* * *</del>	Greater than 48" Less than 60"	12"								
	60" to 120"	L/5								

SIGN SHAPE OTHER THAN DIAMOND (THREE POSTS REQUIRED)								
L	E							
Greater than 120" less than 168"	12"							

HWY:

White Edgeline,

Location

SIGN SHAPE OTHER THAN DIAMOND (FOUR POSTS REQUIRED)								
L	E							
168" and greater	12"							

Location

Outside Edae

of Gravel

## POST EMBEDMENT DEPTH

Area of Sign	
Installation	D
( Sq. Ft.)	(Min)
20 or Less	4'
Greater than 20	5'

TYPICAL INSTALLATION OF TYPE II SIGNS ON MULTIPLE POSTS

Matther

PLATE NO. A4-4.13

FILE NAME : C:\CAEFiles\Projects\tr\_stdplate\A44.DGN

PROJECT NO:

PLOT DATE: 12-NOV-2014 14:01

PLOT NAME :

PLOT BY: mscsja

PLOT SCALE: 107.021305:1.000000

WISDOT/CADDS SHEET 42

SHEET NO:

WISCONSIN DEPT OF TRANSPORTATION

APPROVED

For State Traffic Engineer

DATE 11/12/14






PROJECT NO: HWY: COUNTY: SHEET NO: FILE NAME : C:\CAEFiles\Projects\tr\_stdplate\A49.DGN PLOT DATE: 05-FEB-2015 17:09 PLOT BY: mscsja PLOT NAME : PLOT SCALE: 13.659812:1.000000


DATE 2/05/15

PLATE NO. <u>A4-9.9</u>


For State Traffic Engineer



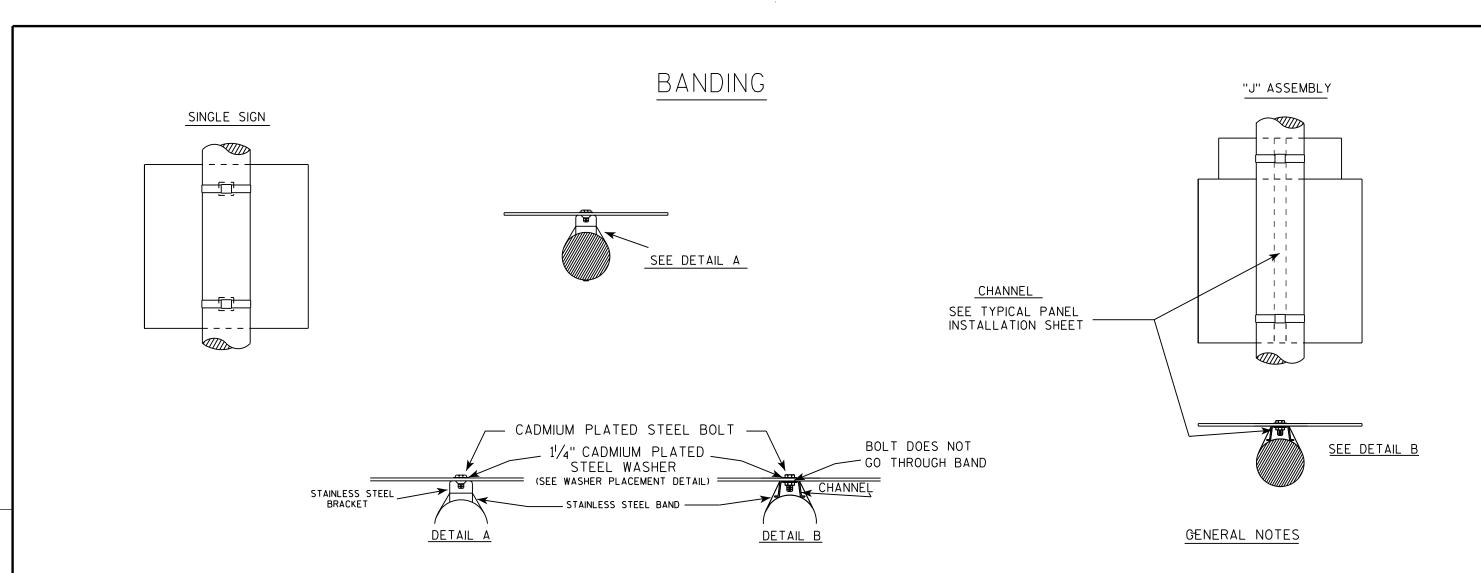

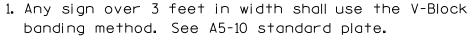

- 2. Signs 3 feet or greater in height shall have three bracket bands installed. Signs less than 3 feet in height shall have two bracket bands installed.
- 3. Banding and assembly bracket shall be stainless steel. All bands shall be  $\frac{3}{4}$ " in width and 0.025" thickness.

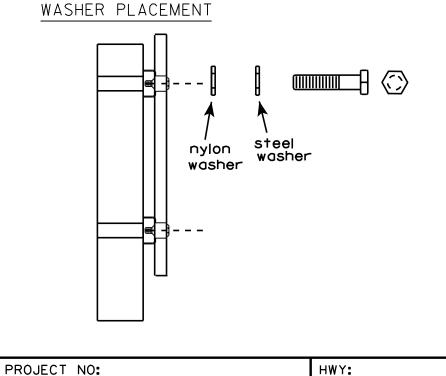

WASHERS (ALL POSTS) -

COUNTY:

1-1/4" O.D. X3/8" I.D. X1/16" STEEL 1-1/4" O.D. X3/8" I.D. X .080 NYLON FOR ALL TYPE H SIGNS

STANDARD SIGN SIGN BANDING DETAILS

WISCONSIN DEPT OF TRANSPORTATION

APPROVED

State Traffic Engineer DATE 8/16/13

SHEET NO:

FILE NAME : C:\CAEFiles\Projects\tr\_stdplate\A59.DGN

PLOT DATE: 16-AUG-2013 13:27


PLOT BY: mscsja

PLOT NAME :

PLOT SCALE: 33.740899:1.000000

WISDOT/CADDS SHEET 42

PLATE NO. A5-9.3

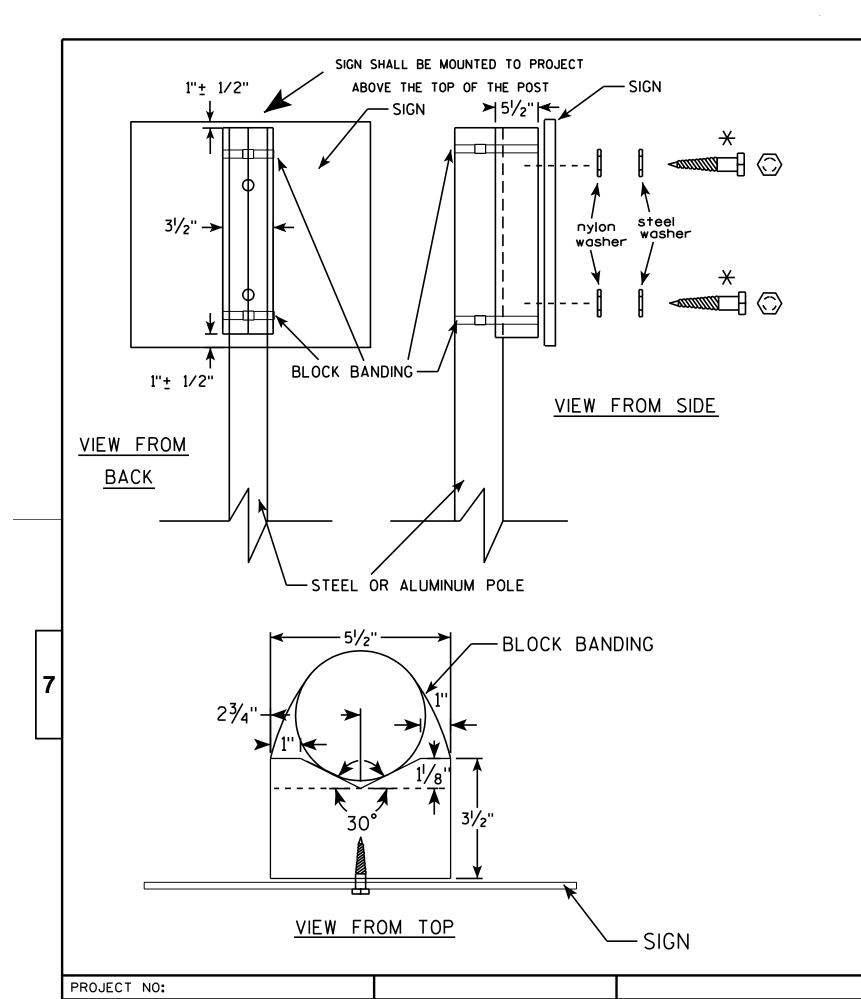

## GENERAL NOTES

- 1. WOOD 4"X6" POST MATERIAL SHALL CONFORM TO 507.2.2 OF THE WISDOT STANDARD SPECIFICATIONS
- 2. BLOCK BANDING AND CLIPS SHALL BE STAINLESS STEEL, 3/4" WIDTH AND 0.025" THICKNESS
- 3. SIGNS 3' OR GREATER IN HEIGHT SHALL UTILIZE 3 BLOCK BANDS. SIGNS UNDER 3' IN HEIGHT SHALL UTILIZE 2 BLOCK BANDS
- 4. ACTUAL NUMBER OF FASTENERS PER SIGN VARIES WITH THE SIGN AREA, BUT NORNALLY THERE ARE TWO. FOR SIGNS GREATER THAN 9 S.F. 3 FASTENERS SHALL BE USED.
- 5. ALL SIGN MOUNTING BOLTS AND WASHERS SHALL BE EITHER:
  - a. Hot dip or mechanically galvanized in accordance with ASTM Designation: A 153, Class D, or
  - b. Cadmium plated in accordance with ASTM Designation: B 766 TYPE 3, Class 12, or
  - c. Electro-galvanized in accordance with ASTM Designation: B 633, TYPE III, SC 3.
- 6. ALL BOLTS SHALL HAVE HEXAGONAL HEADS.
- 7. STEEL WASHERS SHALL BE 11/4" O.D. X 3/8" I.D. X 1/16"
- 8. NYLON WASHERS SHALL BE  $1^{1}/_{4}$ " O.D. X  $\frac{3}{8}$ " I.D. X .080 FOR TYPE H OR TYPE F FACE SIGN

X LAG BOLTS SHALL BE 3/8" X 21/2"

BLOCK BANDING DETAIL ( V-BLOCK OPTION ) WISCONSIN DEPT OF TRANSPORTATION APPROVED For State Traffic Engineer PLATE NO. <u>A5-10.1</u>

DATE 7/12/07


SHEET NO:

1. Sign is Type II - Type F Reflective - reference WIS DOT Standard Specification for HIGHWAY and STRUCTURE CONSTRUCTION latest edition.

2. Color:

Background - Orange Message - Black

- 3. Message Series C
- 4. Corners may be square or rounded when base material is plywood but borders shall be rounded as shown. When base material is metal, the corners and borders shall be rounded.

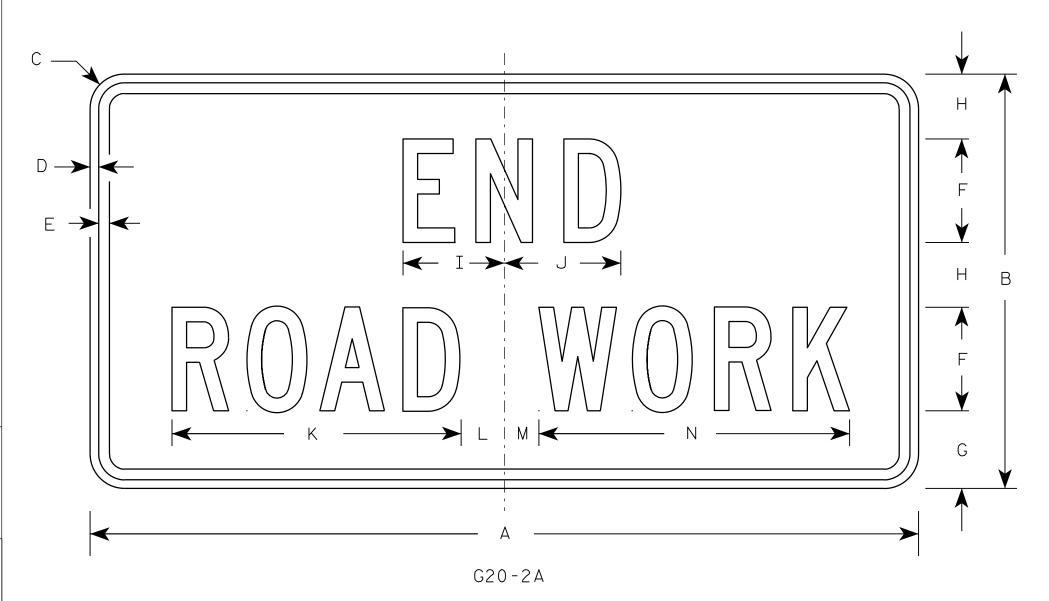

Metric equivalent for this sign is:

SIZE	Α	В	С	D	E	F	G	Н	I	J	К	L	М	N	0	Р	Q	R	S	Т	U	٧	W	Х	Y	Z	Area sq. ft.	Area m2
1	36	18	1 1/8	3/8	1/2	4	3 3/4	2 1/2	4 1/8	4 1/8	11 1/8	2	1	12 1/8													4.5	0.41
2	48	24	1 1/2	1/2	5/8	6	4 1/2	3 3/4	5 %	6 3/4	16 ¾	2 1/2	1 3/4	18 ½													8.0	0.72
3	48	24	1 1/2	1/2	5/8	6	4 1/2	3 3/4	5 %	6 3/4	16 ¾	2 1/2	1 3/4	18 ½													8.0	0.72
4	48	24	1 1/2	1/2	5/8	6	4 1/2	3 3/4	5 %	6 3/4	16 ¾	2 1/2	1 3/4	18 ½													8.0	0.72
5	48	24	1 1/2	1/2	5/8	6	4 1/2	3 3/4	5 1/8	6 3/4	16 ¾	2 1/2	1 3/4	18 ½													8.0	0.72

COUNTY:

STANDARD SIGN G20-2A

WISCONSIN DEPT OF TRANSPORTATION

APPROVED AND UN A O N

Matther R Lauch

For State Traffic Engineer

DATE 9/30/09 PLATE NO. G20-2A.8

SHEET NO:

FILE NAME : C:\Users\PROJECTS\tr\_stdplate\G202A.DGN

HWY:

PROJECT NO:


PLOT DATE: 30-SEP-2009 09:31

PLOT BY: ditjph

PLOT NAME :

PLOT SCALE: 5.561773:1.000000

WISDOT/CADDS SHEET 42

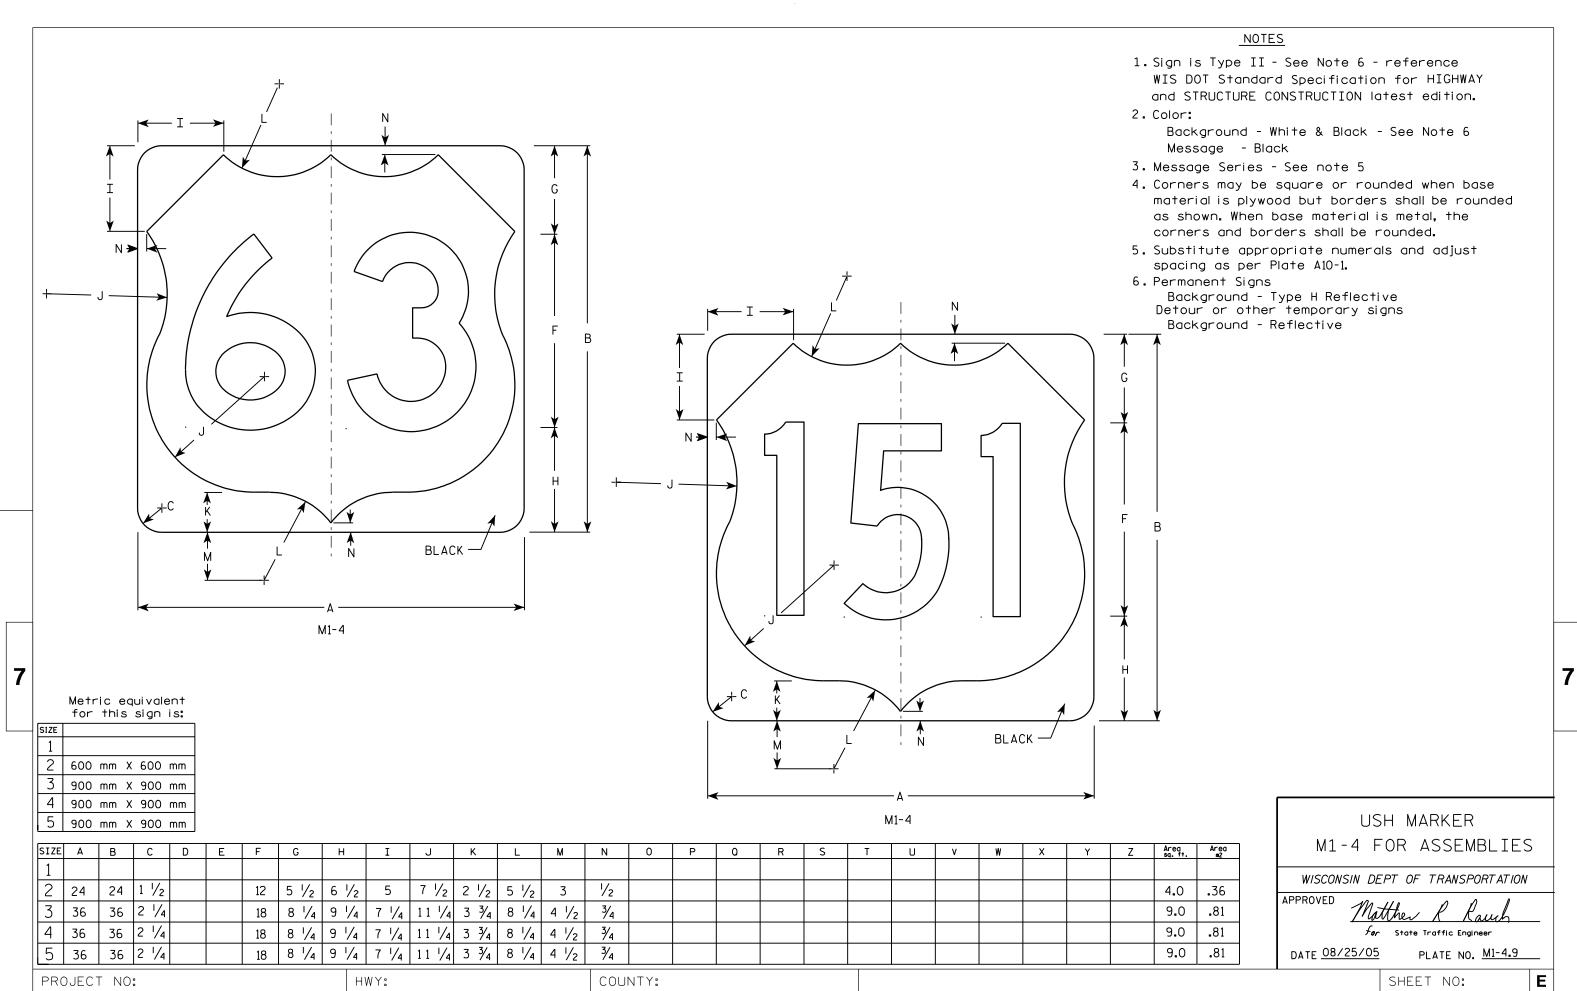

FILE NAME : C:\Users\Projects\tr\_stdplate\M14.DGN

PLOT DATE: 13-OCT-2005 14:52

PLOT NAME :

PLOT BY : DITJPH

PLOT SCALE: 5.960833:1.000000

- Sign is Type II see Note 7 reference WIS DOT Standard Specification for HIGHWAY and STRUCTURE CONSTRUCTION latest edition.
- 2. Color:


Background - White & Black - See Note 7 Message - Black


- 3. Message Series see Note 5
- 4. Corners may be square or rounded when base material is plywood but borders shall be rounded as shown. When base material is metal, the corners and borders shall be rounded.
- 5. Message Series E for 1 letter.


  Message Series D for 2 letters unless
  message is too big then Series C.

  Message Series C for 3 letters unless
  message is too big then Series B.
- 6. Substitute appropriate letters & optically center to achieve proper balance.
- 7. Permanent Signs

Background - Type H Reflective Detour or temporary Signs Background - Reflective

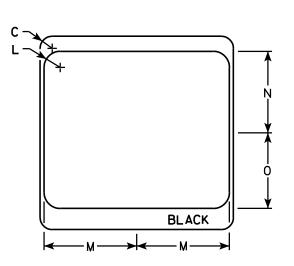

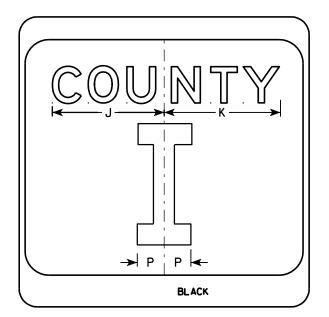

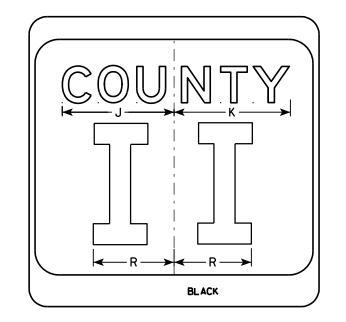

PLOT NAME :

SIZE	Α	В	С	D	E	F	G	Н	I	J	К	L	М	N	0	Р	0	R	S	Т	U	V	W	Х	Y	Z	Area sq. ft.
1																											
2	24		1 1/2			10	3	5 1/8	4 1/8	9 1/4	9 5/8	2	11 1/2	10 1/8	9 3/8	2 1/4		6 %									4.0
3	36		2 1/4			16	4	7 %	5 %	12 1/4	12 1/8	3	17 1/8	15 1/4	14	3 3/8		10									9.0
4	36		2 1/4			16	4	7 %	5 %	12 1/4	12 1/8	3	17 1/8	15 1/4	14	3 %		10									9.0
5	36		2 1/4			16	4	7 5/8	5 %	12 1/4	12 1/8	3	17 1/8	15 1/4	14	3 3/8		10									9.0
DDO	IECT	NO.					111	/V.					COUN	TV.													
FRU	JECT	NO.					HV	V I .						I I .					I								

CTH MARKER
M1-5A FOR ASSEMBLIES

WISCONSIN DEPT OF TRANSPORTATION

APPROVED

PROVED

Matthew Rauch

Forstate Traffic Engineer

MATE 9/27/11 PLATE NO. M1-5A.8

DATE 9/27/11

SHEET NO:

**BLACK** 

M1-5A

- 1. Sign is Type II See Note 6 reference WIS DOT Standard Specification for HIGHWAY and STRUCTURE CONSTRUCTION latest edition.
- 2. Color:

Background - White & Black - See Note 6 Message - Black

- 3. Message Series See note 5
- 4. Corners may be square or rounded when base material is plywood but borders shall be rounded as shown. When base material is metal, the corners and borders shall be rounded.
- 5. Substitute appropriate Series numerals and adjust spacing as per plate A10-1.
- 6. Permanent Signs
  Background Type H Reflective
  Detour or temporary Signs
  Background Reflective

BLACK	<b>↑</b> G <b>→ ↑</b> F <b>→ → ↑ → → → → → → → → → →</b>
Metric equivalent for this sign is:	

HWY:

900 mm X 900 mm

5 900 mm X 900 mm

PROJECT NO:

SIZE	Α	В	С	D	E	F	G	Н	I	J	К	L	М	N	0	Р	Q	R	S	Т	U	٧	W	Х	Y	Z	Area sq. ft.	Area m2
1																												
2	24		1 1/2			12	5 1/2	6 1/2	10 1/4	2 1/2	8 %	11 1/2	1	1 1/8	11 1/4	21 1/8											4.0	<b>.</b> 36
3	36		2 1/4			18	8 3/4	9 1/4	15 3/8	5 3/8	12 5/8	17 1/8	1 1/2	2 1/8	16 1/8	33											9.0	<b>.</b> 81
4	36		2 1/4			18	8 3/4	9 1/4	15 3/8	5 3/8	12 5/8	17 1/8	1 1/2	2 1/8	16 1/8	33											9.0	.81
5	36		2 1/4			18	8 3/4	9 1/4	15 3/8	5 3/8	12 5/8	17 1/8	1 1/2	2 1/8	16 1/8	33											9.0	.81
ט ן	26		2 /4			10	0 74	J /4	12 78	3 78	12 78	11 /8	1 /2	<sup>2</sup> /8	10 /8	33		<u> </u>										9.0

COUNTY:

STATE ROUTE MARKER
M1-6 FOR ASSEMBLIES

WISCONSIN DEPT OF TRANSPORTATION

APPROVED

The state Traffic Engineer

DATE 3/20/02 PLATE NO. M1-6.9

SHEET NO:

\_\_\_\_


PLOT NAME :

- 1. Sign is Type II Type H reference WIS DOT Standard Specification for HIGHWAY and STRUCTURE CONSTRUCTION latest edition.
- 2. Color:

Background - White & Black Message - Black Arrow - Type H Reflective Red

- 3. Message Series D
- 4. Corners may be square or rounded when base material is plywood but borders shall be rounded as shown. When base material is metal, the corners and borders shall be rounded.

32nd DIVISION ARROW ACTUAL SIZE

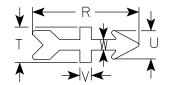

Metric equivalent for this sign is:

SIZE					
1					
2	600	mm	Χ	600	mm
3	900	mm	Χ	900	mm
4	900	mm	Χ	900	mm
5	900	mm	Х	900	mm

SIZE	A	В	С	D	E	F	G	Н	I	7	K	L	М	N	0	Р	0	R	S	T	U	٧	W	Х	Y	Z	Area sq. ft.	Area m2
1																												
2	24		1 1/2			12	5 1/2	6 1/2	10 1/4	2 1/2	8 %	11 ½	1	1 1/8	11 1/4	21 7/8		5 1/8	3/4	1 1/8	1 1/2	5/8	5/8	9	1/2	10 ½	4.0	<b>.</b> 36
3	36		2 1/4			18	8 3/4	9 1/4	15 ¾	5	12 %	17 1/8	1 1/2	2 1/8	16 1/8	33		7 1/2	1 1/2	2 1/2	2	7/8	3/4	13 ½	3/4	15 ½	9.0	<b>.</b> 81
4	36		2 1/4			18	8 3/4	9 1/4	15 3/8	5 3/8	12 %	17 1/8	1 1/2	2 1/8	16 1/8	33		7 1/2	1 1/2	2 1/2	2	7/8	3/4	13 ½	3/4	15 1/2	9.0	.81
5	36		2 1/4			18	8 3/4	9 1/4	15 3/8	5	12 %	17 1/8	1 1/2	2 1/8	16 1/8	33		7 1/2	1 1/2	2 1/2	2	7/8	3/4	13 ½	3/4	15 ½	9.0	<b>.</b> 81

COUNTY:

BLACK

M1-6B

HWY:

STATE ROUTE MARKER"32" M1-6B FOR ASSEMBLIES


WISCONSIN DEPT OF TRANSPORTATION

For State Traffic Engineer

DATE 12/5/05 PLATE NO. M1-6B.2

SHEET NO:

PLOT NAME :

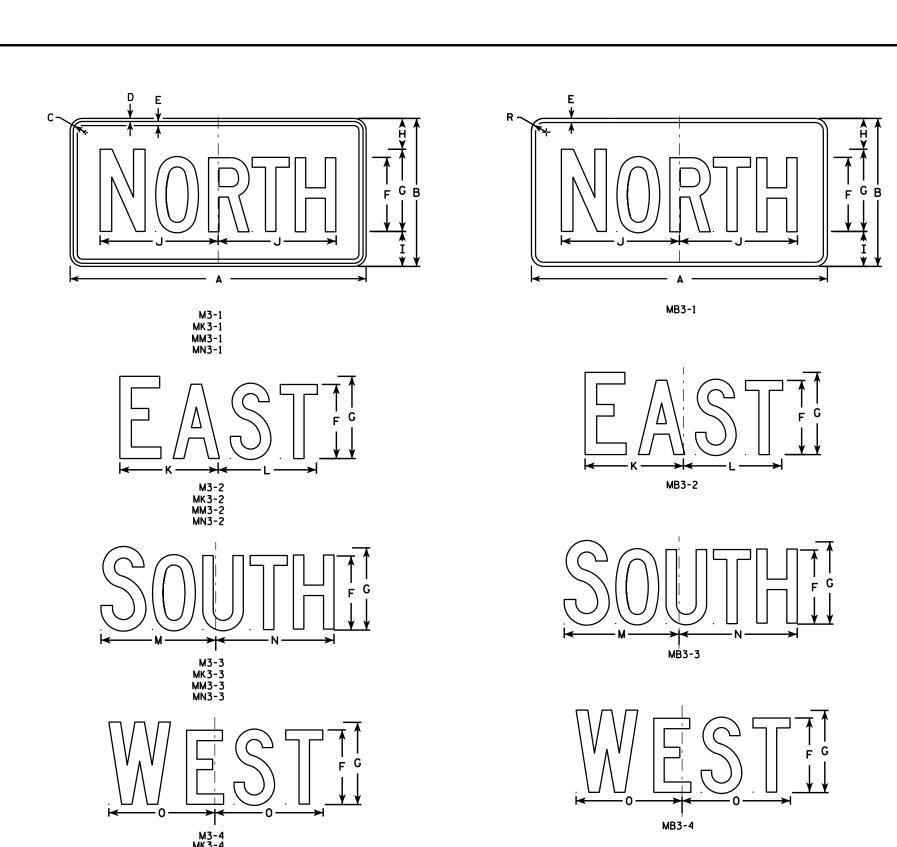

- 1. All Signs Type II Type H
- 2. Color:

Background - See note 5 Message - See note 5

- 3. Message Series C
- 4. Corners may be square or rounded when base material is plywood but borders shall be rounded as shown. When base material is metal, the corners and borders shall be rounded.
- 5. M3-1 thru M3-4 Background White

Message - Black

MB3-1 thru MB3-4 Background - Blue

Message - White

MK3-1 thru MK3-4 Background - Green

Message - White

MM3-1 thru MM3-4 Background - White

Message - Green

MN3-1 thru MN3-4 Background - Brown

Message - White

6. Note the first letter of each direction is larger than the remainder of the message.

					MN3-4																					
SIZE	Α	В	С	D	E	F	G	Н	I	J K	L	М	N	0	Р	0	R	S	T	U	v	W	Х	Y	Z	Areq sq. ft.
SIZE 1																										
2	24	12	1 1/8	3/8	3/8	6	7	2 1/4	2 3/4	10 1/4 7 1/8	8 3/8	10 1/4	9 3/4	8 3/4			1 1/2									2.00
3	36	18	1 1/8	3/8	1/2	9	10	3 3/4	4 1/4	14 3/8 12	12 1/8	14	14 1/8	13			1 1/2									4.5
4	36	18	1 1/8	3/8	1/2	9	10	3 3/4	4 1/4	14 3/8 12	12 1/8	14	14 1/8	13			1 1/2									4.5
5	36	18	1 1/8	3/8	1/2	9	10	3 3/4	4 1/4	14 3/8 12	12 1/8	14	14 1/8	13			1 1/2									4.5

COUNTY:

STANDARD SIGNS M3-1 thur M3-4 SERIES

WISCONSIN DEPT OF TRANSPORTATION

APPROVED

Matther & Rauch

For State Traffic Engineer

DATE 6/30/14 PLATE NO. M3-1.13

SHEET NO:

07.001/5...14.675054.4.000000

FILE NAME : C:\CAEFiles\Projects\tr\_stdplate\M31.DGN

HWY:

PROJECT NO:

PLOT DATE: 30-JUN-2014 12:53

PLOT NAME :

PLOT BY: mscsja

PLOT SCALE: 11.675051:1.000000

- 1. Sign is Type II Type F Reflective reference WIS DOT Standard Specification for HIGHWAY and STRUCTURE CONSTRUCTION latest edition.
- 2. Color:

Background - Orange Message - Black

- 3. Message Series B
- 4. Corners may be square or rounded when base material is plywood but borders shall be rounded as shown. When base material is metal, the corners and borders shall be rounded.

	G A
	F B
H	G V
M4 - 8	

Α С E F G H I J S Х Z D 0 10 10 1/4 1 1/8 3/8 3/8 24 2.0 3 36 1 1/8 3/8 1/2 4 1/2 14 5/8 14 1/2 4.5 4 5

COUNTY:

STANDARD SIGN M4-8

WISCONSIN DEPT OF TRANSPORTATION

APPROVED

For State Traffic Engineer

DATE 11/10/10 PLATE NO. M4-8.2

SHEET NO:

PROJECT NO:

HWY:

PLOT NAME :

1. Sign is Type II - Type F Reflective - reference WIS DOT Standard Specification for HIGHWAY and STRUCTURE CONSTRUCTION latest edition.

2. Color:

Background - Orange Message - Black

- 3. Message Series B
- 4. Corners may be square or rounded when base material is plywood but borders shall be rounded as shown. When base material is metal, the corners and borders shall be rounded.

 $D \longrightarrow$ Н M4-8A

SIZE	Α	В	С	D	E	F	G	Н	I	J	K	L	М	N	0	Р	0	R	S	Т	U	٧	w	Х	Y	Z	Area sq. ft.
1																											
2	24	18	1 1/8	3/8	1/2	6	2	2	4 3/4	9 ¾																	3.0
3	30	24	1 1/8	3/8	1/2	8	2 1/2	3	6 3/4	13																	5.0
4																											
5																											

COUNTY:

STANDARD SIGN M4-8A

WISCONSIN DEPT OF TRANSPORTATION

APPROVED

Matther For State Traffic Engineer

SHEET NO:

DATE 3/9/11

PLATE NO. M4-8A.2

PLOT SCALE: 3.972696:1.000000

WISDOT/CADDS SHEET 42

FILE NAME : C:\Users\PROJECTS\tr\_stdplate\M48A.DGN

HWY:

PROJECT NO:

PLOT DATE: 09-MAR-2011 10:29


PLOT BY: mscj9h

PLOT NAME :

- 1. Sign is Type II Type F Reflective reference WIS DOT Standard Specification for HIGHWAY and STRUCTURE CONSTRUCTION latest edition.
- 2. Color:

Background - Orange Message - Black

- 3. Message Series D
- 4. Corners may be square or rounded when base material is plywood but borders shall be rounded as shown. When base material is metal, the corners and borders shall be rounded.
- 5. M4-9L is the same as M4-9R except the arrow is reversed.

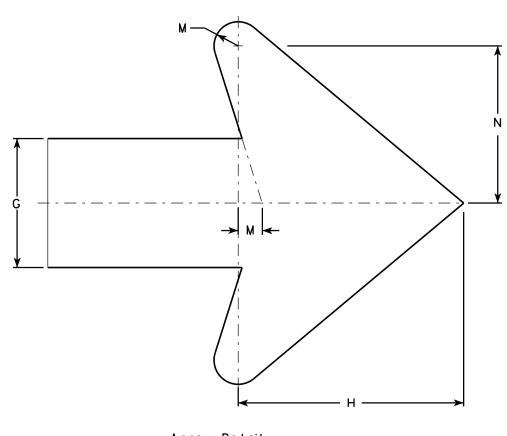

Arrow Detail

SIZE	Α	В	С	D	Ε	F	G	Н	I	J	K	L	M	N	0	Р	0	R	S	T	U	٧	W	X	Y	Z	Area sq. ft.
1																											1
2	30	24	1 1/8	3/8	1/2	5	4	7	8	11 1/2	12	9	3/4	4 1/8													5.00
3	30	24	1 1/8	3∕8	1/2	5	4	7	8	11 1/2	12	9	3/4	4 1/8													5.00
4	48	36	1 3/8	1/2	5/8	8	6	10 1/2	11 %	20 %	20 1/2	13 1/4	1 1/8	6 %													12.0
5	48	36	1 3/8	1/2	5/8	8	6	10 1/2	11 5/8	20 %	20 1/2	13 1/4	1 1/8	6 %													12.0

COUNTY:

M4-9R

M4-9 R & L WISCONSIN DEPT OF TRANSPORTATION

STANDARD SIGN

APPROVED

Matthew R *for* State Traffic Engineer

PLATE NO. M4-9R.4 DATE 3/9/11

SHEET NO:

FILE NAME : C:\Users\PROJECTS\tr\_stdplate\M49R.DCN

PROJECT NO:

HWY:

PLOT DATE: 09-MAR-2011 11:17

PLOT NAME :

PLOT BY: mscj9h

PLOT SCALE: 5.959043:1.000000

WISDOT/CADDS SHEET 42

- Signs are Type II See Note 4 reference WIS DOT Standard Specification for HIGHWAY and STRUCTURE CONSTRUCTION latest edition.
- 2. Color:

Background - See note 4 Message - See note 4

- 3. Corners may be square or rounded when base material is plywood but borders shall be rounded as shown. When base material is metal, the corners and borders shall be rounded.
- 4. M5-1 and M5-2 Background White Type H Reflective Message Black
  - MB5-1 and MB5-2 Background Blue

    Message White Type H Reflective
  - MG5-1 and MG5-2 Background Green

    Message White Type H Reflective
  - MK5-1 and MK5-2 Background Green
    - Message White Type H Reflective
  - MM5-1 and MM5-2 Background White Type H Reflective Message Green
- MN5-1 and MN5-2 Background Brown


Message - White - Type H Reflective

- M05-1 and M05-2 Background Orange Type F Reflective Message - Black
- MP5-1 and MP5-2 Background White Type H Reflective Message Blue
- MR5-1 and MR5-2 Background Brown
  - Message Yellow Type H Reflective
- 5. M5-1R same as M5-1L except arrow points right.
- 6. M5-2R same as M5-2L except arrow tilts right.

c —	
D → E →	
Į.	<b>←</b>
·	M5-2L
	MK5-2L


MK5-1L MM5-1L MO5-1L MP5-1L MR5-1L

M5-1L

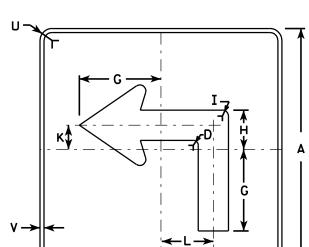

MB5-1L MG5-1L MN5-1L

HWY:

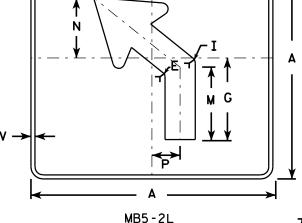

MG5-2L

MN5-2L

MM5-2L

M05-2L

MP5-2L

MR5-2L

T A S

SIZE	Α	В	С	D	E	F	G	Н	I	J	K	L	M	N	0	Р	0	R	S	T	U	٧	₩	Х	Y	Z	Areo sq. fi
1																											
2	21		1 1/8	3%	3/8		7	3 3/8	5/8		2 1/8	4 1/2	6 %	5 1/4	5	2 1/2		1/2	2 %	3	1 1/2	1/2					3.06
3	30		1 3/8	1/2	5/8		10 1/8	4 1/8	<b>7</b> /8		3	6 1/2	9 1/8	7 1/2	7 1/4	3 1/2		3/4	3 3/4	4 1/4	1 1/8	1/2					6.25
4	30		1 3/8	1/2	5/8		10 1/8	4 1/8	<b>7</b> /8		3	6 1/2	9 1/8	7 1/2	7 1/4	3 1/2		3/4	3 3/4	4 1/4	1 1/8	1/2					6.25
5	30		1 3/8	1/2	5/8		10 1/8	4 1/8	<b>½</b>		3	6 1/2	9 1/8	7 1/2	7 1/4	3 1/2		3/4	3 3/4	4 1/4	1 1/8	1/2					6.25

COUNTY:

STANDARD SIGN M5-1 & M5-2

WISCONSIN DEPT OF TRANSPORTATION

APPROVED

For State Traffic Engineer
DATE 7/29/13 PLATE NO. M5-1.12

SHEET NO:

PROJECT NO:

PLOT NAME :

- 1. Signs are Type II Type H except as Shown
- 2. Color:

Background - See note 4 Message - See note 4

- 3. Corners may be square or rounded when base material is plywood but borders shall be rounded as shown. When base material is metal, the corners and borders shall be rounded.
- 4. M6-1 and M6-2 Background White

Message - Black

MB6-1 and MB6-2 Background - Blue

Message - White

MG6-1 and MG6-2 Background - Green

Message - White

MK6-1 and MK6-2 Background - Green

Message - White

MM6-1 and MM6-2 Background - White

Message - Green

MN6-1 and MN6-2 Background - Brown

Message - White

M06-1 and M06-2 Background - Orange - Type F Reflective

Message - Black

MP6-1 and MP6-2 Background - White

Message - Blue


MR6-1 and MR6-2 Background - Brown

Message - Yellow

c —	
D ->	
	A
	M6 - 2
	MK 6 - 2



- MM6-2 MN6 - 2
- MO6-2
- MP6-2
- MR6-2

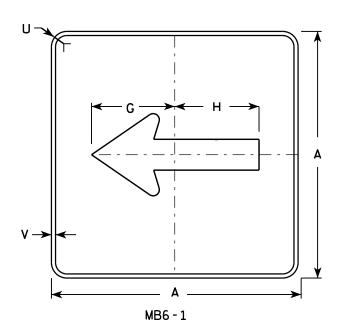

HWY:

M6 - 1

MK6-1


MM6 - 1


MN6-1

MO6 - 1

MP6-1

MR6-1

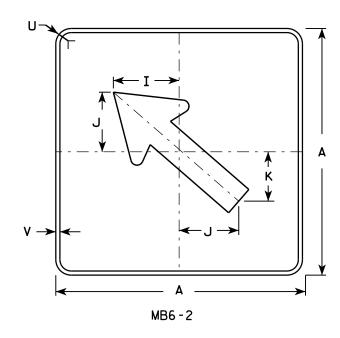

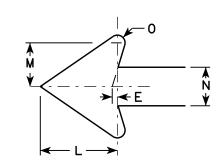

SIZE	Α	В	С	D	Е	F	G	Н	I	J	K	L	М	N	0	Р	0	R	S	Т	U	٧	₩	X	Y	Z	Area sq. ft.
1																											
2	21		1 1/8	3/8	3/8		7 1/2	7 1/8	5 %	5	4 1/4	5 1/4	3	2 %	1/2						1 1/2	1/2					3.06
3	30		1 3/8	1/2	5/8		10 3/4	10 1/4	8	7 1/4	6	7 1/2	4 1/4	3 3/4	3/4						1 1/8	1/2					6.25
4	30		1 3/8	1/2	5/8		10 3/4	10 1/4	8	7 1/4	6	7 1/2	4 1/4	3 3/4	3/4						1 1/8	1/2					6.25
5	30		1 3/8	1/2	5/8		10 3/4	10 1/4	8	7 1/4	6	7 1/2	4 1/4	3 3/4	3/4						1 1/8	1/2					6.25

COUNTY:

STANDARD SIGN M6-1 & M6-2**SERIES** 

WISCONSIN DEPT OF TRANSPORTATION

APPROVED

DATE 7/03/14 PLATE NO. M6-1.14

SHEET NO:

FILE NAME : C:\CAEFiles\Projects\tr\_stdplate\M61.DGN


PROJECT NO:

PLOT DATE: 03-JUL-2014 14:28


PLOT NAME :

PLOT BY: mscsja

PLOT SCALE: 11.675051:1.000000

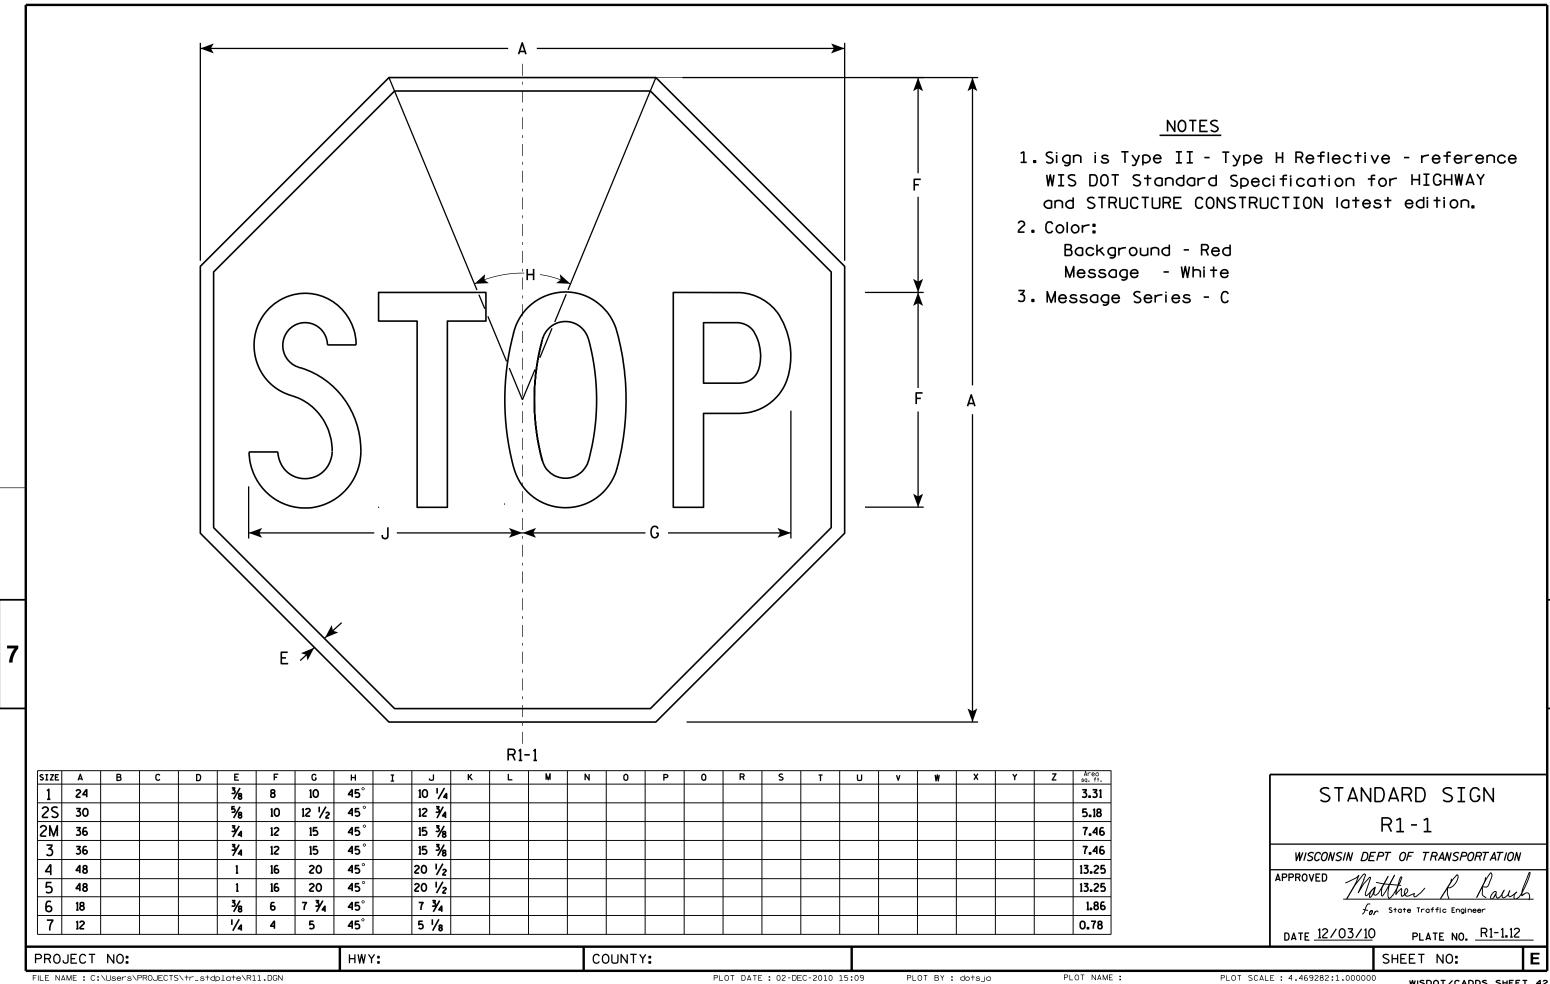

WISDOT/CADDS SHEET 42

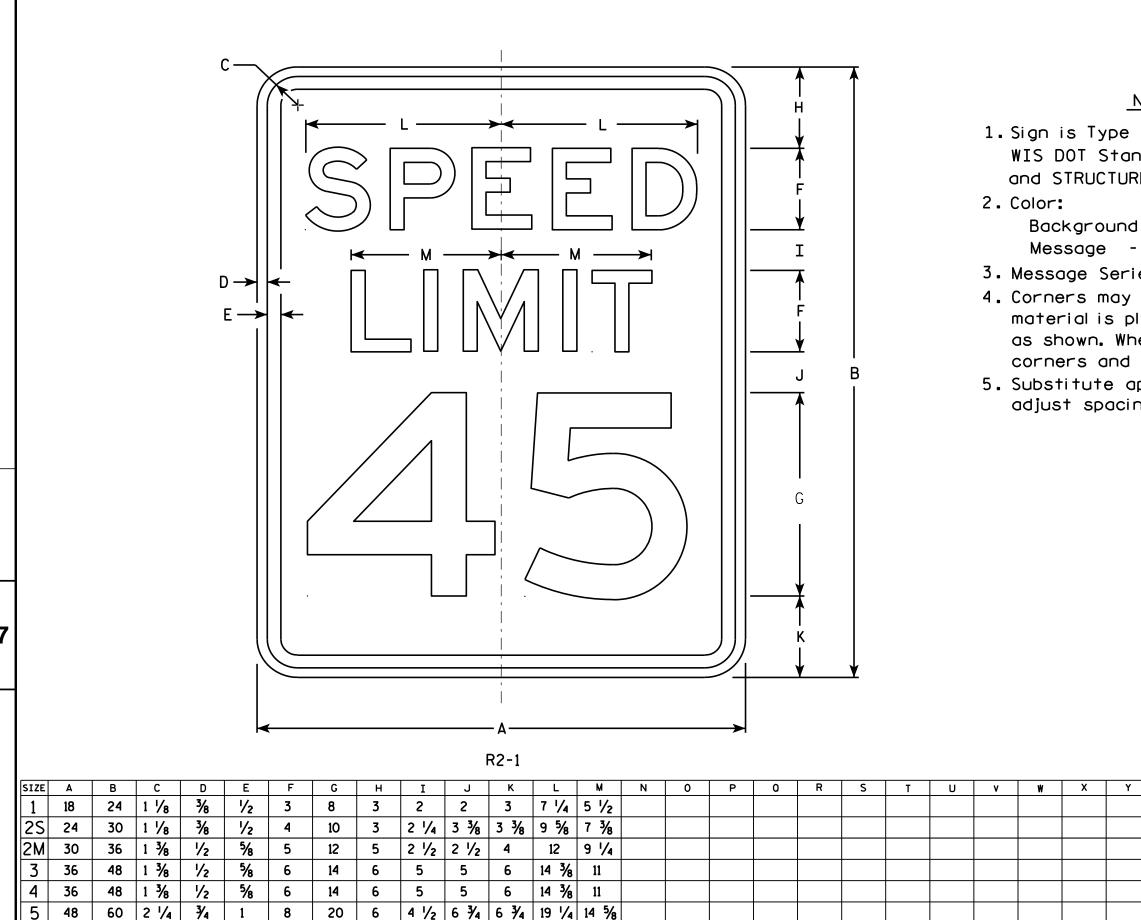

COUNTY:

## NOTES

1. Sign is Type II - Type H Reflective - reference WIS DOT Standard Specification for HIGHWAY and STRUCTURE CONSTRUCTION latest edition.

Background - White Message - Black

- 3. Message Series E
- 4. Corners may be square or rounded when base material is plywood but borders shall be rounded as shown. When base material is metal. the corners and borders shall be rounded.
- 5. Substitute appropriate numerals and optically adjust spacing to achieve proper balance.

3.0

5.0

7.5

12.0

12.0

20.0

STANDARD SIGN R2-1

WISCONSIN DEPT OF TRANSPORTATION

APPROVED Matther R Raus

For State Traffic Engineer DATE <u>5/26/1</u>0 PLATE NO. R2-1.13

SHEET NO:

FILE NAME : C:\Users\PROJECTS\tr\_stdplate\R21.DGN

PROJECT NO:

HWY:

PLOT DATE: 28-MAY-2010 08:32

PLOT BY : ditjph

PLOT NAME :

PLOT SCALE: 4.717577:1.000000

WISDOT/CADDS SHEET 42



- 1. Sign is Type II Type H Reflective reference WIS DOT Standard Specification for HIGHWAY and STRUCTURE CONSTRUCTION latest edition.
- 2. Color:


Background - White Message - Red

- 3. Message Series See Note 5
- 4. Corners may be square or rounded when base material is plywood but borders shall be rounded as shown. When base material is metal, the corners and borders shall be rounded.
- 5. Lines 1, 3 and 4 are series C, line 2 is series B.
- 6. R7-1D (double arrow)

R7-1L (left arrow)

R7-1R (right arrow)

PLOT NAME :

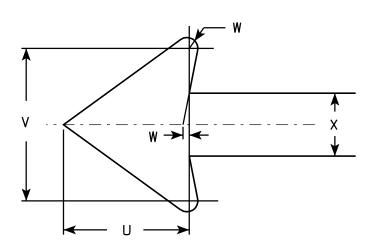

R7-1

SIZE	Α	В	С	D	Ε	F	G	Н	I	J	K	L	M	N	0	Р	0	R	S	Т	U	٧	W	X	Y	Z	Areg sq. ft.
1	12	18	1 1/8	3/8	3/8	3	1 %	2	%	5/8	1 1/2	2 1/2	2	2	4 %	4 %	2 1/4	2 1/8	2 1/2	3 %	1 1/2	1 3/4	1/8	3/4			1.5
2S	18	24	1 1/8	3/8	1/2	4	2 1/2	2 1/2	1 1/4	1	2	3 1/4	2 3/4	2 %	7 1/8	7	2 3/4	2 5/8	3 1/8	5 %	2 1/4	2 %	1/4	1 1/8			3.0
2M	24	30	1 1/8	3/8	1/2	5	3	3	2	1 1/4	2 1/2	4	3 1/4	3 3/8	9 1/4	9 1/4	3 1/4	3 1/4	3 3/4	7 3/4	3	3 ½	1/4	1 1/2			5.0
3	24	30	1 1/8	3/8	1/2	5	3	3	2	1 1/4	2 1/2	4	3 1/4	3 3/8	9 1/4	9 1/4	3 1/4	3 1/4	3 3/4	7 3/4	3	3 ½	1/4	1 1/2			5.0
4																											
5																			·				·				

COUNTY:

STANDARD SIGN R7-1

WISCONSIN DEPT OF TRANSPORTATION

APPROVED

OVED

Matthew R Rauch


For State Traffic Engineer

DATE 3/31/2011

SHEET NO:

HWY:

PROJECT NO:

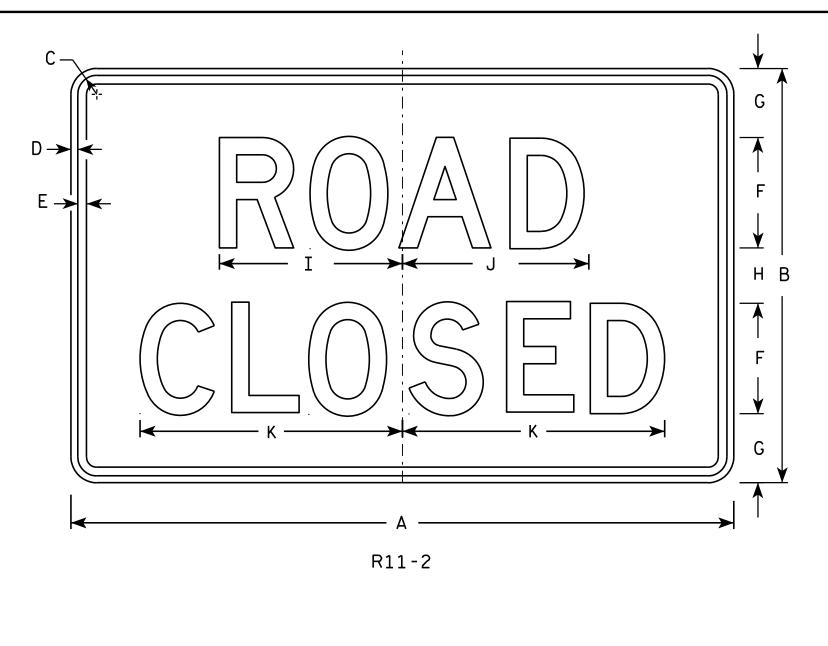



# <u>NOTES</u>

- 1. Sign is Type II Type H Reflective reference WIS DOT Standard Specification for HIGHWAY and STRUCTURE CONSTRUCTION latest edition.
- 2. Color:

Background - White Message - Black

- 3. Message Series D
- 4. Corners may be square or rounded when base material is plywood but borders shall be rounded as shown. When base material is metal, the corners and borders shall be rounded.
- 5. Modify the message as required.

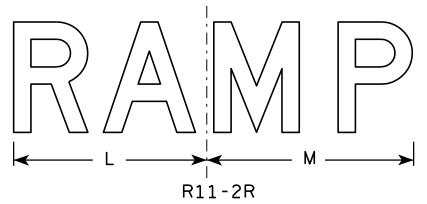

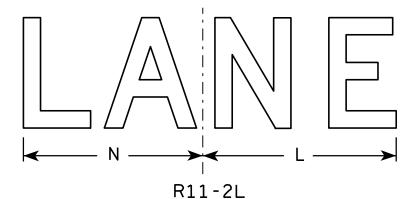

SIZE	A	В	С	D	E	F	G	Н	I	J	K	L	M	N	0	Ρ	0	R	S	T	U	V	W	X	Y	Z	Area sq. ft.
1																											
2S	48	30	1 3/8	1/2	5/8	8	5	4	13 1/4	13 1/2	19	14	15	13													10.0
2M	48	30	1 3/8	1/2	5/8	8	5	4	13 1/4	13 1/2	19	14	15	13													10.0
3	48	30	1 3/8	1/2	5/8	8	5	4	13 1/4	13 1/2	19	14	15	13													10.0
4	48	30	1 3/8	1/2	5/8	8	5	4	13 1/4	13 1/2	19	14	15	13													10.0
5	48	30	1 3/8	1/2	5/8	8	5	4	13 1/4	13 1/2	19	14	15	13													10.0
PRO	DJECT	NO:						HWY:					С	OUNTY	<b>':</b>												


STANDARD SIGN R11-2

WISCONSIN DEPT OF TRANSPORTATION

DATE 4/1/11 PLATE NO. R11-2.10

SHEET NO:

PLOT BY: mscj9h

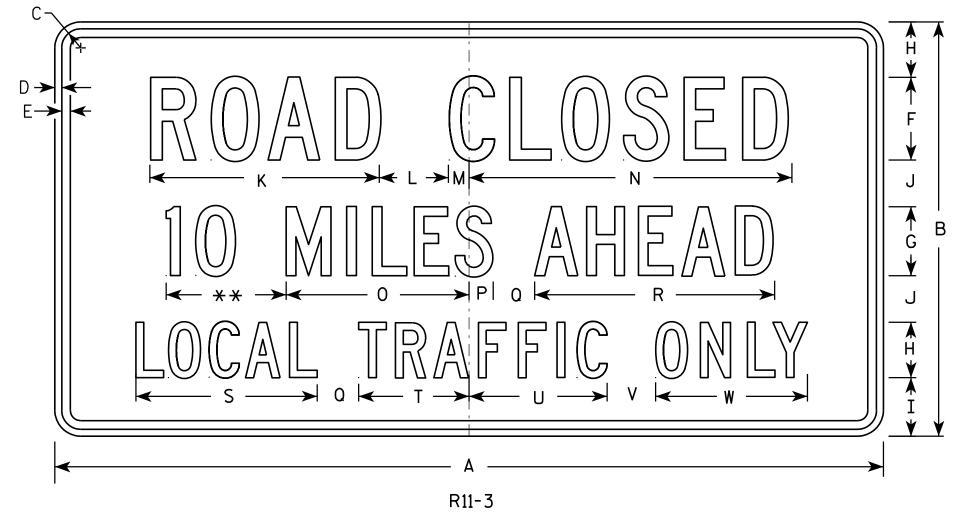

- 1. Sign is Type II Type H Reflective reference WIS DOT Standard Specification for HIGHWAY and STRUCTURE CONSTRUCTION latest edition.
- 2. Color:

Background - White Message - Black

- 3. Message Series C
- 4. Corners may be square or rounded when base material is plywood but borders shall be rounded as shown. When base material is metal, the corners and borders shall be rounded.
- 5. Substitute appropriate numerals and optically adjust spacing to achieve proper balance.

\*\* See Note 5

SIZE	Α	В	С	D	E	F	G	Н	I	J	К	L	М	N	0	Ρ	0	R	S	Т	U	٧	₩	X	Y	Z	Area sq. ft.
1	36	18	1 3/8	1/2	5/8	4	3	2 1/2	2	2	11 1/8	3	1 1/8	15 1/4	8	1 1/2	2	10 ¾	8 %	4 3/4	6 1/2	2	6 3/4				4.5
2S	60	30	1 3/8	1/2	5/8	6	5	4	4 1/4	3 3/8	16 5/8	5	1 1/2	23	13 1/4	1 3/4	3	17 3/8	13 1/8	8	10	3 1/2	11				12.5
2M	60	30	1 3/8	1/2	5/8	6	5	4	4 1/4	3 %	16 %	5	1 1/2	23	13 1/4	1 3/4	3	17 3/8	13 1/8	8	10	3 1/2	11				12.5
3																											
4																											
5																											

COUNTY:

STANDARD SIGN R11-3

WISCONSIN DEPT OF TRANSPORTATION

APPROVED Matthew & Rauch

DATE 4/1/11 PLATE NO. R11-3.6

SHEET NO:

FILE NAME : C:\Users\PROJECTS\tr\_stdplate\R113.DGN

HWY:

PROJECT NO:


PLOT DATE: 01-APR-2011 14:20


PLOT NAME :

PLOT BY: mscj9h


PLOT SCALE: 6.952216:1.000000


WISDOT/CADDS SHEET 42

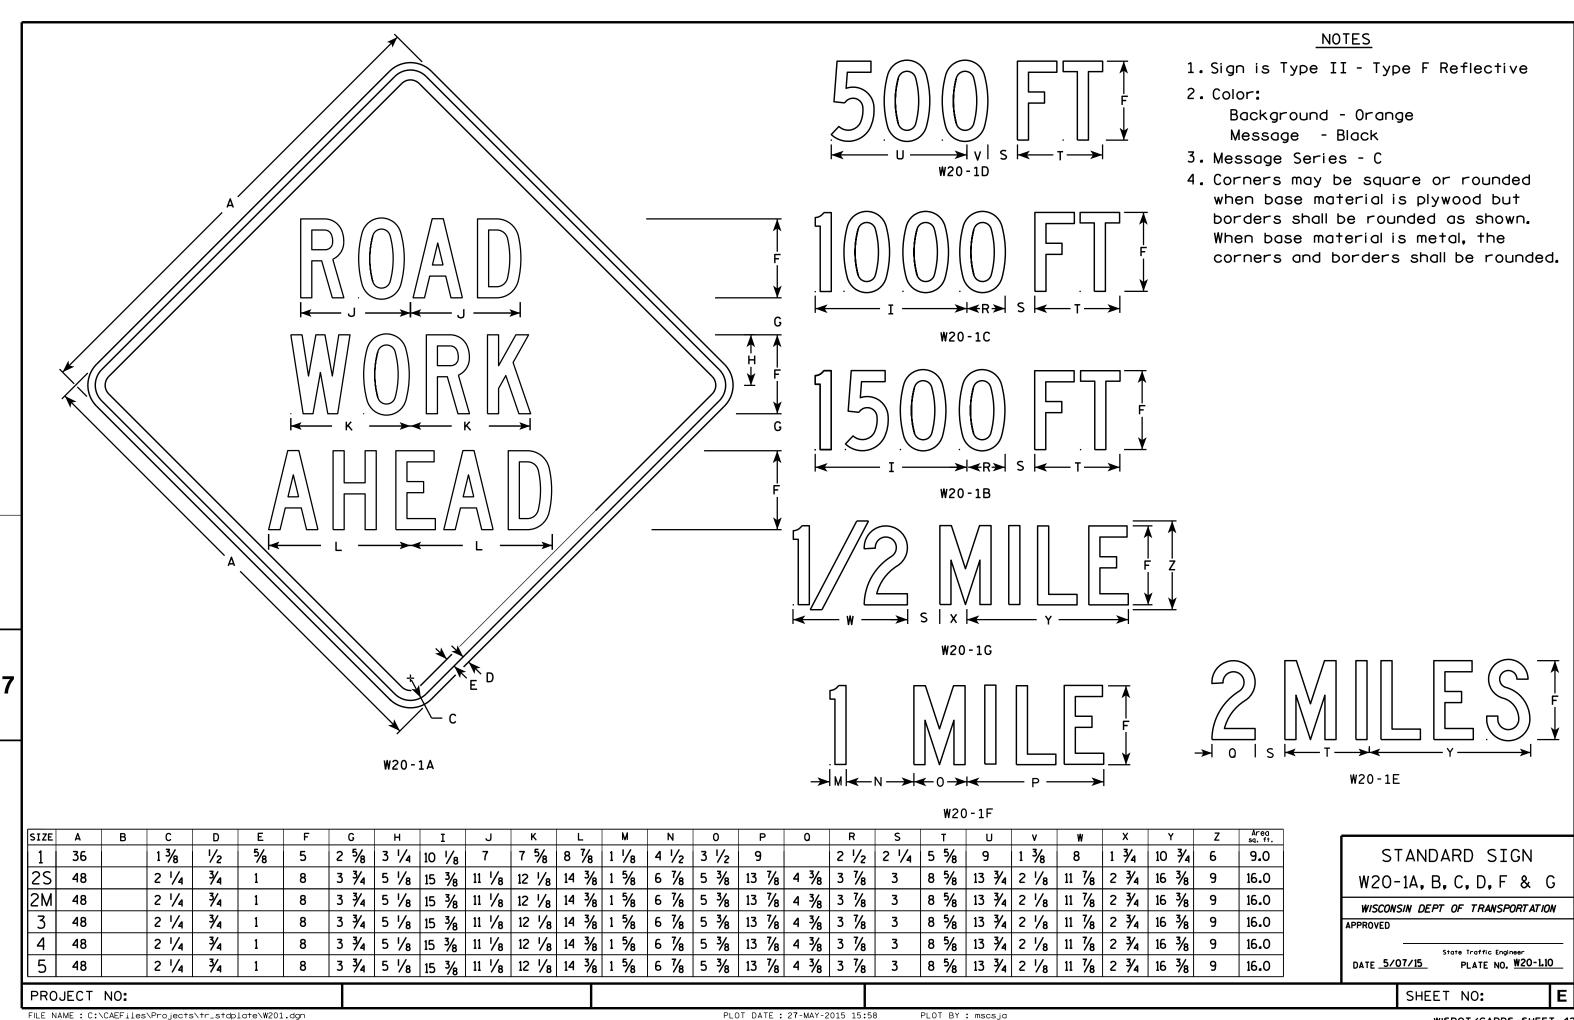


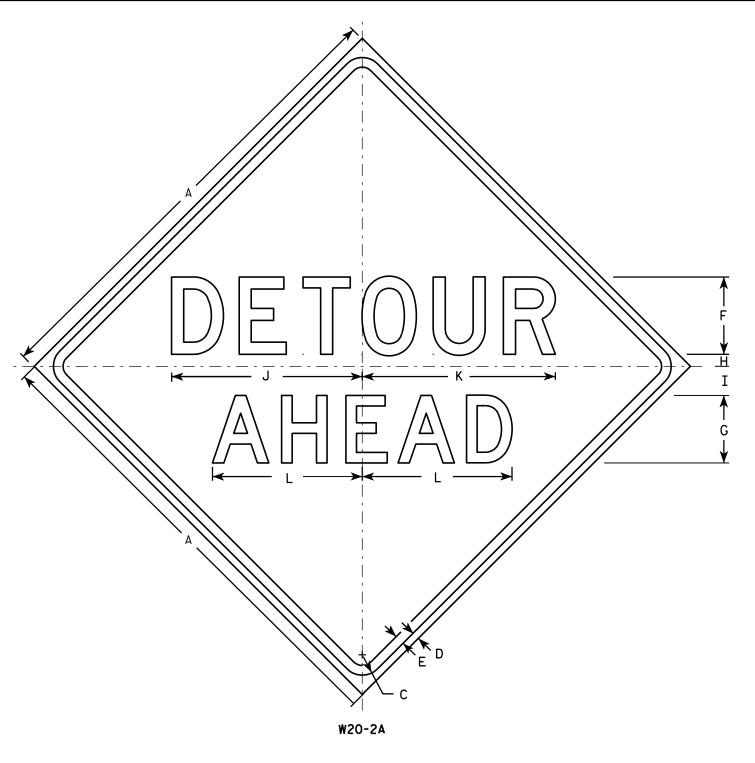



HWY:

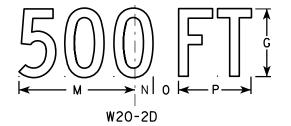

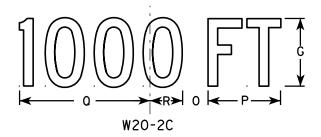

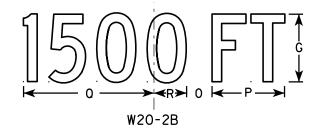

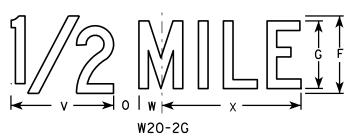

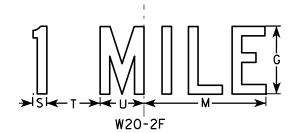

PLOT BY: mscj9h

## <u>NOTES</u>

- Sign is Type II Type F Reflective reference WIS DOT Standard Specification for HIGHWAY and STRUCTURE CONSTRUCTION latest edition.
- 2. Color:

Background - Orange Message - Black

- 3. Message Series See note 5
- 4. Corners may be square or rounded when base material is plywood but borders shall be rounded as shown. When base material is metal, the corners and borders shall be rounded.
- 5. Line 1 is Series D.
  Line 2 is Series D for AHEAD and
  Series C for all other distances.

SIZE	Α	В	С	D	E	F	G	н	I	J	K	L	М	N	0	Р	0	R	S	T	U	٧	W	X	Y	Z	Area sq. ft.
1	36		1 1/8	5/8	₹4	6	5	1	2 1/4	14 3/4	15	11 %	9	1 3/8	1 %	5 %	10 1/8	2 1/2	1 1/8	4 1/2	3 1/2	8	1 3/4	10 3/4			9.0
2S	48		2 1/4	3/4	1	8	7	1 1/4	3	19 ¾	20	15 1/2	12	1 1/8	2 5/8	7 1/2	13 1/2	3 3/8	1 1/2	6	4 5/8	10 %	2 3/8	14 3/8			16.0
2M	48		2 1/4	3/4	1	8	7	1 1/4	3	19 ¾	20	15 1/2	12	1 1/8	2 %	7 1/2	13 1/2	3 %	1 1/2	6	4 %	10 %	2 3/8	14 3/8			16.0
3	48		2 1/4	3∕4	1	8	7	1 1/4	3	19 ¾	20	15 1/2	12	1 1/8	2 %	7 1/2	13 1/2	3 %	1 1/2	6	4 %	10 %	2 3/8	14 3/8			16.0
4	48		2 1/4	¾	1	8	7	1 1/4	3	19 ¾	20	15 1/2	12	1 1/8	2 %	7 1/2	13 1/2	3 %	1 1/2	6	4 %	10 %	2 3/8	14 3/8			16.0
5	48		2 1/4	3/4	1	8	7	1 1/4	3	19 ¾	20	15 1/2	12	1 1/8	2 %	7 1/2	13 1/2	3 3/8	1 1/2	6	4 %	10 %	2 3/8	14 3/8			16.0

COUNTY:

STANDARD SIGN W20-2A,B,C,D,F & G


WISCONSIN DEPT OF TRANSPORTATION

For State Traffic Engineer

DATE 3/18/11 PLATE NO. W20-2.6

SHEET NO:

PROJECT NO:

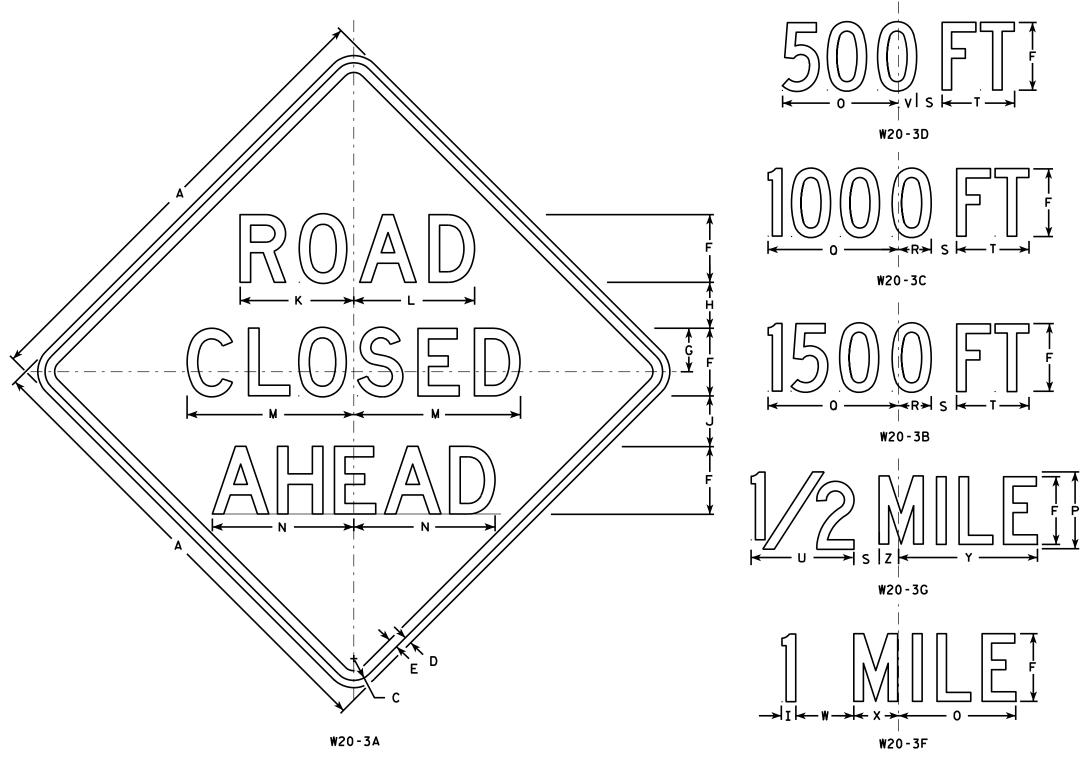

- 1. Sign is Type II Type F Reflective reference WIS DOT Standard Specification for HIGHWAY and STRUCTURE CONSTRUCTION latest edition.
- 2. Color:

Background - Orange Message - Black

- 3. Message Series see note 5
- 4. Corners may be square or rounded when base material is plywood but borders shall be rounded as shown. When base material is metal, the corners and borders shall be rounded.
- 5. Lines 1 and 2 are Series D. Line 3 is Series D for AHEAD and Series C for all other distances.

SIZE	Α	В	С	D	E	F	G	н	I	J	К	L	М	N	0	Р	0	R	S	Т	U	٧	w	х	Y	Z	Areo sq. ft.
1	36		1 %	5/8	₹4	5	3 3/8	3 ½	1 1/8	4	8 3%	8 %	12 1/2	11	9	6	10 1/8	2 1/2	1 %	5 %	8	1 3/8	4 1/2	3 1/2	10 ¾	1 3/4	9.0
2S	48		2 1/4	3/4	1	7	4 1/2	4 3/4	1 1/2	5 1/4	11 3/4	12 1/2	17 1/4	14 %	12	8	13 1/2	3 %	2 %	7 1/2	10 %	1 1/8	6	4 %	14 3/8	2 3/8	16.0
2M	48		2 1/4	3/4	1	7	4 1/2	4 3/4	1 1/2	5 1/4	11 ¾	12 1/2	17 1/4	14 %	12	8	13 1/2	3 %	2 %	7 1/2	10 %	1 1/8	6	4 %	14 3/8	2 3/8	16.0
3	48		2 1/4	3/4	1	7	4 1/2	4 3/4	1 1/2	5 1/4	11 ¾	12 1/2	17 1/4	14 %	12	8	13 1/2	3 %	2 %	7 1/2	10 %	1 1/8	6	4 %	14 3/8	2 3/8	16.0
4	48		2 1/4	3/4	1	7	4 1/2	4 3/4	1 1/2	5 1/4	11 3/4	12 1/2	17 1/4	14 %	12	8	13 1/2	3 %	2 %	7 1/2	10 %	1 1/8	6	4 %	14 3/8	2 3/8	16.0
5	48		2 1/4	3/4	1	7	4 1/2	4 3/4	1 1/2	5 1/4	11 3/4	12 1/2	17 1/4	14 %	12	8	13 1/2	3 %	2 5/8	7 1/2	10 %	1 1/8	6	4 %	14 3/8	2 3/8	16.0
ت			- /-	/ -			1 / 2	- / -	- /2	· /-	/ -	/2	7,4	- 70			10 /2	- 70	- 78	. , 2	78	- 78		- 70	- 70	- 78	

STANDARD SIGN W20-3A, B, C, D, F & G

WISCONSIN DEPT OF TRANSPORTATION

DATE 3/18/11

For State Traffic Engineer
PLATE NO. W20-3.7

SHEET NO:

HWY:

COUNTY:

PLOT NAME :

PLOT SCALE: 9.931739:1.000000

PROJECT NO:

# <u>NOTES</u>

- 1. Sign is Type II Type F Reflective reference WIS DOT Standard Specification for HIGHWAY and STRUCTURE CONSTRUCTION latest edition.
- 2. Color:

Background - Orange Message - Black

- 3. Message Series See Note 5
- 4. Corners may be square or rounded when base material is plywood but borders shall be rounded as shown. When base material is metal, the corners and borders shall be rounded.
- 5. " LANE" is Series B. Allother copy is Series C.

500 FT

W20-5C

1500 FT



PLOT BY: mscj9h



									W20-	5A																	W 4	20-3F
SI	ZE	Α	В	С	D	E	F	G	Н	I	J	K	L	M	N	0	Р	0	R	S	T	U	V	W	Х	Y	Z	Area sq. ft.
	1	36	6	1 5/8	5/8	₹4	5	<b>1</b> /8	2 1/2	13 1/8	10 ¾	9 1/2	14 1/4	13 %	12	12	1 3/8	1 1/8	4 1/2	3 1/2	9	1 1/8	5 %	10 1/8	2 1/2	1 3/4	8	9.0
2	?S	48	8	2 1/4	3/4	1	7	1 1/4	3 1/4	17 1/2	14 3/8	12 5/8	19	18 3/8	16	14 1/4	1 1/8	1 1/2	6	4 %	12	2 %	7 1/2	13 1/2	3 3/8	2 3/8	10 %	16.0
2	M	48	8	2 1/4	3/4	1	7	1 1/4	3 1/4	17 1/2	14 3/8	12 5/8	19	18 3/8	16	14 1/4	1 1/8	1 1/2	6	4 %	12	2 %	7 1/2	13 1/2	3 3/8	2 3/8	10 %	16.0
	3	48	8	2 1/4	3/4	1	7	1 1/4	3 1/4	17 1/2	14 3/8	12 5/8	19	18 3/8	16	14 1/4	1 1/8	1 1/2	6	4 %	12	2 %	7 1/2	13 1/2	3 3/8	2 3/8	10 %	16.0
	4	48	8	2 1/4	3/4	1	7	1 1/4	3 1/4	17 1/2	14 3/8	12 %	19	18 3/8	16	14 1/4	1 %	1 1/2	6	4 5/8	12	2 %	7 1/2	13 ½	3 %	2 3/8	10 %	16.0
	5	48	8	2 1/4	3/4	1	7	1 1/4	3 1/4	17 1/2	14 3/8	12 %	19	18 3/8	16	14 1/4	1 1/8	1 1/2	6	4 %	12	2 %	7 1/2	13 1/2	3 3/8	2 3/8	10 %	16.0

COUNTY:

STANDARD SIGN W20-5A, B, C, D, F & G

WISCONSIN DEPT OF TRANSPORTATION

APPROVED

Matthew & Rauch

For State Traffic Engineer

DATE 3/18/11 PLATE NO. W20-5.11

SHEET NO:

PROJECT NO:

HWY:


W20-56A

W20-55A

- 1. Sign is Type II Type F Reflective reference WIS DOT Standard Specification for HIGHWAY and STRUCTURE CONSTRUCTION latest edition.
- 2. Color:

Background - Orange Message - Black

- 3. Corners may be square or rounded when base material is plywood but borders shall be rounded as shown. When base material is metal, the corners and borders shall be rounded.
- 4. W04-2L is the same as W04-2R except the symbolis reversed along the vertical centerline.

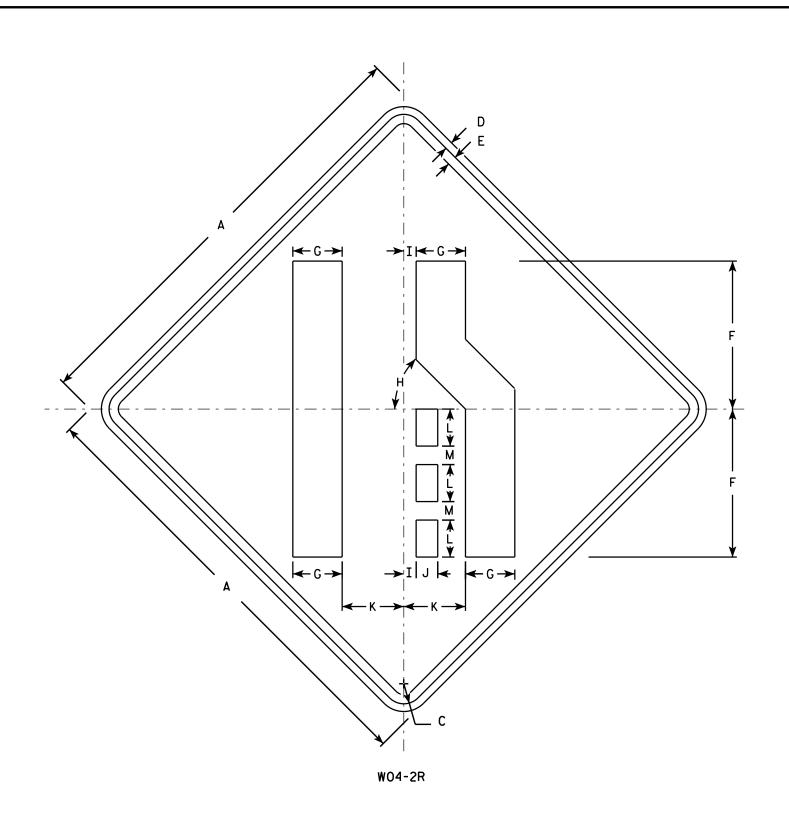

SIZE 1 % 5/8 3/4 12 45° 1 3/4 5 1 1/2 4 36 3 9.0 2S 2 1/4 5 3/8 45° 1 ¼ 2 ¾ 6 ¾ 3/4 48 16.0 45° 1 ¼ 2 ¾ 6 ¾ 3/4 5 3/8 48 2 1/4 2 16.0 2 1/4 3 48 3/4 5 % 45° | 1 1/4 | 2 3/8 | 6 3/4 2 16.0 2 1/4 3/4 5 3/8 45° | 1 1/4 | 2 3/8 | 6 3/4 48 2 16.0 5 2 1/4 3/4 5 3/8 45° | 1 1/4 | 2 3/8 | 6 3/4 48 2 16.0

STANDARD SIGN W04 - 2

WISCONSIN DEPT OF TRANSPORTATION

APPROVED

ForState Traffic Engineer

DATE 11/20/13 PLATE NO. <u>WO4-2.1</u>

SHEET NO:

FILE NAME : C:\CAEFiles\Projects\tr\_stdplate\W042.DGN

PROJECT NO:

PLOT DATE: 20-NOV-2013 11:43

WISDOT/CADDS SHEET 42

				AREA (SF)			JSH 151 (E. CHESTNUT STREET) EAI Incremental Vol (	(CY) (Unadjusted)			Cumulativ	e Vol (CY)	
STATION	Real Station	Distance	Cut	Salvaged/Unusable Pavement Material	Fill	EBS	Cut	Salvaged/Unusable Pavement Material	Fill	EBS	Cut 1.00	Expanded Fill	Mass Ordina
211+13.94	21113.94	0.00	127.91	48.33	0.70	0.00	0	0	0	0	0	0	0.00
211+25	21125.00	11.06	128.02	48.33	0.24	0.00	52	20	0	0	52	0	32.37
211+50	21150.00	25.00	130.35	48.33	0.69	0.00	120	45	0	0	172	1	106.66
211+75	21175.00	25.00	137.43	48.33	0.20	0.00	124	45	0	0	296	1	185.34
212+00	21200.00	25.00	145.76	48.33	0.00	0.00	131	45	0	0	427	1	271.57
212+25	21225.00	25.00	143.19	48.33	0.01	0.00	134	45 45	0	0	561	2	360.58
212+50 212+75	21250.00 21275.00	25.00 25.00	135.79 135.05	48.33 48.33	0.11 0.15	0.00	129 125	45 45	0 0	0	690 815	2 2	444.91 525.39
212+75	21300.00	25.00	138.66	48.33	0.13	0.00	125	45 45	0	0	942	2	607.12
13+20.54	21320.54	20.54	135.68	48.33	0.23	0.00	104	37	0	0	1,047	2	674.49
213+25	21325.00	4.46	135.29	48.33	0.33	0.00	22	8	0	Ö	1,069	2	688.84
213+30	21330.00	5.00	138.23	48.33	0.34	0.00	25	9	0	0	1,094	2	705.13
213+35	21335.00	5.00	130.15	48.33	0.30	0.00	25	9	0	0	1,119	2	720.95
213+40	21340.00	5.00	139.72	48.33	0.82	0.00	25	9	0	0	1,144	3	736.85
213+45	21345.00	5.00	145.34	48.33	0.32	0.00	26	9	0	0	1,170	3	754.16
213+50	21350.00	5.00	141.88	48.33	0.00	0.00	27	9	0	0	1,197	3	771.76
213+55	21355.00	5.00	130.90	48.33	0.00	0.00	25	9	0	0	1,222	3	788.07
213+60	21360.00	5.00	120.21	48.33	0.00	0.00	23	9	0	0	1,246	3	802.37
213+65	21365.00	5.00	113.89	48.33	0.00	0.00	22	9	0	0	1,267	3	815.09
13+66.46	21366.46	1.46	114.49	48.33	0.00	0.00	6	3	0	0	1,273	3	818.65
213+70	21370.00	3.54	117.63	48.33	0.00	0.00	15	6	0	0	1,289	3	827.53
213+75	21375.00	5.00	127.28	48.33	0.00	0.00	23	9	0	0	1,311	3	841.26
213+80	21380.00	5.00	138.00	48.33	0.00		25	9	0	0	1,336	3	856.87
213+85	21385.00	5.00	147.95	48.33	0.00	0.00	26	9	0	0	1,362	3	874.40
213+90	21390.00	5.00	135.75	48.33	0.47	0.00	26	9	0	0	1,389	3	891.66
213+95	21395.00	5.00	132.58	48.33	0.15	0.00	25	9	0	0	1,413	3	907.48
214+00	21400.00	5.00	130.70	48.33	0.57	0.00	24	9	0	0	1,438	3	922.81
214+05	21405.00	5.00	133.12	48.33	0.54	0.00	24	9	0	0	1,462	3	938.15
214+10	21410.00	5.00	130.01	48.33	0.67	0.00	24	9	0	0	1,487	3	953.42
214+15 14+15.83	21415.00 21415.83	5.00 0.83	131.53	48.33 48.33	0.64 0.54	0.00	24 4	1	0 0	0	1,511	3 3	968.52 971.04
214+15.83	21415.83	0.83 9.17	131.41 133.17	48.33	0.54	0.00	45	16	0	0	1,515	3 4	971.04 999.45
214+25	21450.00	9.17 25.00	133.17	48.33	0.01	0.00	123	45	0	0	1,560 1,683	4	1077.54
214+36	21475.00	25.00	128.68	48.33	1.28	0.00	121	45	1	0	1,803	4	1152.77
215+00	21500.00	25.00	124.02	48.33	1.22	0.00	117	45	1	0	1,920	6	1223.47
215+25	21525.00	25.00	121.62	48.33	0.73		114	45	1	0	2,034	7	1291.24
215+50	21550.00	25.00	115.51	48.33	2.88	0.00	110	45	2	0	2,144	9	1354.05
215+75	21575.00	25.00	120.39	48.33	0.25	0.00	109	45	1	0	2,253	11	1416.58
216+00	21600.00	25.00	122.15	48.33	1.58	0.00	112	45	1	0	2,365	12	1482.99
216+25	21625.00	25.00	117.76	48.33	1.24	0.00	111	45	1	0	2,477	14	1547.57
216+50	21650.00	25.00	128.18	48.33	0.55	0.00	114	45	1	0	2,590	15	1615.57
216+75	21675.00	25.00	136.38	48.33	0.77	0.00	122	45	1	0	2,713	16	1692.49
217+00	21700.00	25.00	146.00	48.33	0.00	0.00	131	45	0	0	2,844	17	1778.00
217+25	21725.00	25.00	144.67	48.33	0.00	0.00	135	45	0	0	2,978	17	1867.81
217+50	21750.00	25.00	140.74	48.33		0.00	132	45	0	0	3,110	17	1955.10
217+75	21775.00	25.00	143.36	48.33		0.00	132	45	0	0	3,242	17	2041.58
17+89.09	21789.09	14.09	144.01	48.33		0.00	75 -	25	0	0	3,317	17	2091.08
217+90	21790.00	0.91	144.13	48.33		0.00	5	2	0	0	3,322	17	2094.28
217+95	21795.00	5.00	140.41	48.33		0.00	26	9	0	0	3,348	17	2111.53
218+00	21800.00	5.00	144.08	48.33		0.00	26	9	0	0	3,374	17	2128.78
218+05	21805.00	5.00	140.62	48.33		0.00	26	9	0	0	3,401	18	2146.10
218+10	21810.00	5.00	139.28	48.33		0.00	26 27	9	0	0	3,427	18	2162.96
218+15	21815.00	5.00	150.62 145.75	48.33		0.00	27 27	9	0	0	3,454	18 10	2180.77
218+20 218+25	21820.00 21825.00	5.00 5.00	145.75 137.45	48.33 48.33		0.00	27 26	9	0	0 0	3,481 3,507	18 10	2199.25 2216.52
218+25 218+30	21825.00	5.00	137.45	48.33 48.33		0.00	26 25	9	0	0	3,507	18 18	2216.52
218+35 218+35	21835.00	5.00	132.07	48.33		0.00	24	9	0	0	3,556	18	2247.55
218+40	21840.00	5.00	137.99	48.33		0.00	25	9	0	0	3,581	18	2247.33
218+45	21845.00	5.00	142.08	48.33		0.00	26	9	0	0	3,607	18	2280.59
218+50	21850.00	5.00	134.46	48.33		0.00	26	9	0	0	3,633	18	2297.14
218+55	21855.00	5.00	129.56	48.33		0.00	24	9	0	0	3,657	18	2312.36
218+60	21860.00	5.00	134.53	48.33		0.00	24	9	0	0	3,682	18	2327.60
218+65	21865.00	5.00	132.50	48.33		0.00	25	9	0	0	3,706	19	2343.23
18+69.69	21869.69	4.69	129.67	48.33		0.00	23	8	0	0	3,729	19	2357.50
		-		* *				*			•		
				Column Tota			3,729	1,353	14	0			

COUNTY: CALUMET EARTH QUANTITIES USH 151 SHEET:

PLOT DATE: 4/22/2015 PLOT BY: \_\_\_\_\_ PLOT NAME: \_\_\_\_ PLOT SCALE: 1:1

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FILE NAME : 20140.00/41003100/Design/Quantities/090101\_ew.ppt

PROJECT NO: 4100-31-71

HWY: USH 151

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#### S MAPLE STREET EARTHWORK

				AREA (SF)			Incremental Vol	(CY) (Unadjusted)			Cumulative	Vol (CY)	
STATION	Real Station	Distance	Cut	Unusable Pavement Material	Fill	EBS	Cut	Unusable Pavement Material	Fill	EBS	Cut 1.00	Expanded Fill 1.33	Mass Ordinate
15+20.01	1520.01	0.00	0.14	37.00	0.00	0.00	0	0	0	0	0	0	0.00
15+25.00	1525.00	4.99	45.75	37.00	0.00	0.00	4	7	0	0	4	0	-2.60
15+30.00	1530.00	5.00	96.77	37.00	0.00	0.00	13	7	0	0	17	0	3.75
15+35.00	1535.00	5.00	103.45	37.00	0.01	0.00	19	7	0	0	36	0	15.44
15+40.00	1540.00	5.00	109.48	37.00	0.09	0.00	20	7	0	0	56	0	28.29
15+42.30	1542.30	2.30	106.18	37.00	0.11	0.00	9	3	0	0	65	0	34.30
15+45.00	1545.00	2.70	104.04	37.00	0.11	0.00	11	4	0	0	75	0	41.10
15+47.91	1547.91	2.91	103.90	37.00	0.10	0.00	11	4	0	0	87	0	48.32
				Column Tot	als		87	38	0	0			

#### N MAPLE STREET EARTHWORK

				AREA (SF)		Incremental Vol	(CY) (Unadjusted)			Cumulative	Vol (CY)	
STATION	Real Station	Distance	Cut	Unusable Pavement Material	Fill EBS	Cut	Unusable Pavement Material	Fill	EBS	Cut 1.00	Expanded Fill 1.33	Mass Ordinate
10+24.03	1024.03	0.00	101.20	36.67	0.00 0.00	0	0	0	0	0	0	0.00
10+25.00	1025.00	0.97	101.80	36.67	0.00 0.00	4	1	0	0	4	0	2.32
10+30.00	1030.00	5.00	98.22	36.67	0.01 0.00	19	7	0	0	22	0	14.05
10+34.99	1034.99	4.99	103.24	36.67	0.01 0.00	19	7	0	0	41	0	25.89
10+35.00	1035.00	0.01	103.25	36.67	0.01 0.00	0	0	0	0	41	0	25.91
10+40.00	1040.00	5.00	105.80	36.67	0.03 0.00	19	7	0	0	60	0	38.47
10+45.00	1045.00	5.00	72.84	36.67	0.00 0.00	17	7	0	0	77	0	48.22
10+49.25	1049.25	4.25	0.26	36.67	0.00 0.00	6	6	0	0	82	0	48.20
				Column Tota	ls	82	34	0	0			

ELM STREET EARTHWORK

				AREA (SF)		Incremental Vo	ol (CY) (Unadjusted)			Cumulative \	Vol (CY)	
STATION	Real Station	Distance	Cut	Salvaged/Unusable Pavement Material	Fill EBS	Cut	Salvaged/Unusable Pavement Material	Fill	EBS	Cut 1.00	Expanded Fill 1.33	Mass Ordinate
20+25.36	2025.36	0.00	91.89	38.25	1.05 0.00	0	0	0	0	0	0	0.00
20+29.34	2029.34	3.99	103.42	38.25	0.00 0.00	14	6	0	0	14	0	8.67
20+30.00	2030.00	0.66	101.60	38.25	0.00 0.00	2	1	0	0	17	0	10.23
20+35.00	2035.00	5.00	104.86	38.25	0.01 0.00	19	7	0	0	36	0	22.26
20+40.00	2040.00	5.00	91.36	38.25	0.19 0.00	18	7	0	0	54	0	33.32
20+45.00	2045.00	5.00	68.80	38.25	0.00 0.00	15	7	0	0	69	0	41.04
20+50.00	2050.00	5.00	28.09	38.25	0.00 0.00	9	7	0	0	78	0	42.93
20+53.54	2053.54	3.54	0.01	38.25	0.00 0.00	2	5	0	0	80	0	39.76
				Column Tota	ls	80	40	0	0			

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PROJECT NO: 4100-31-71


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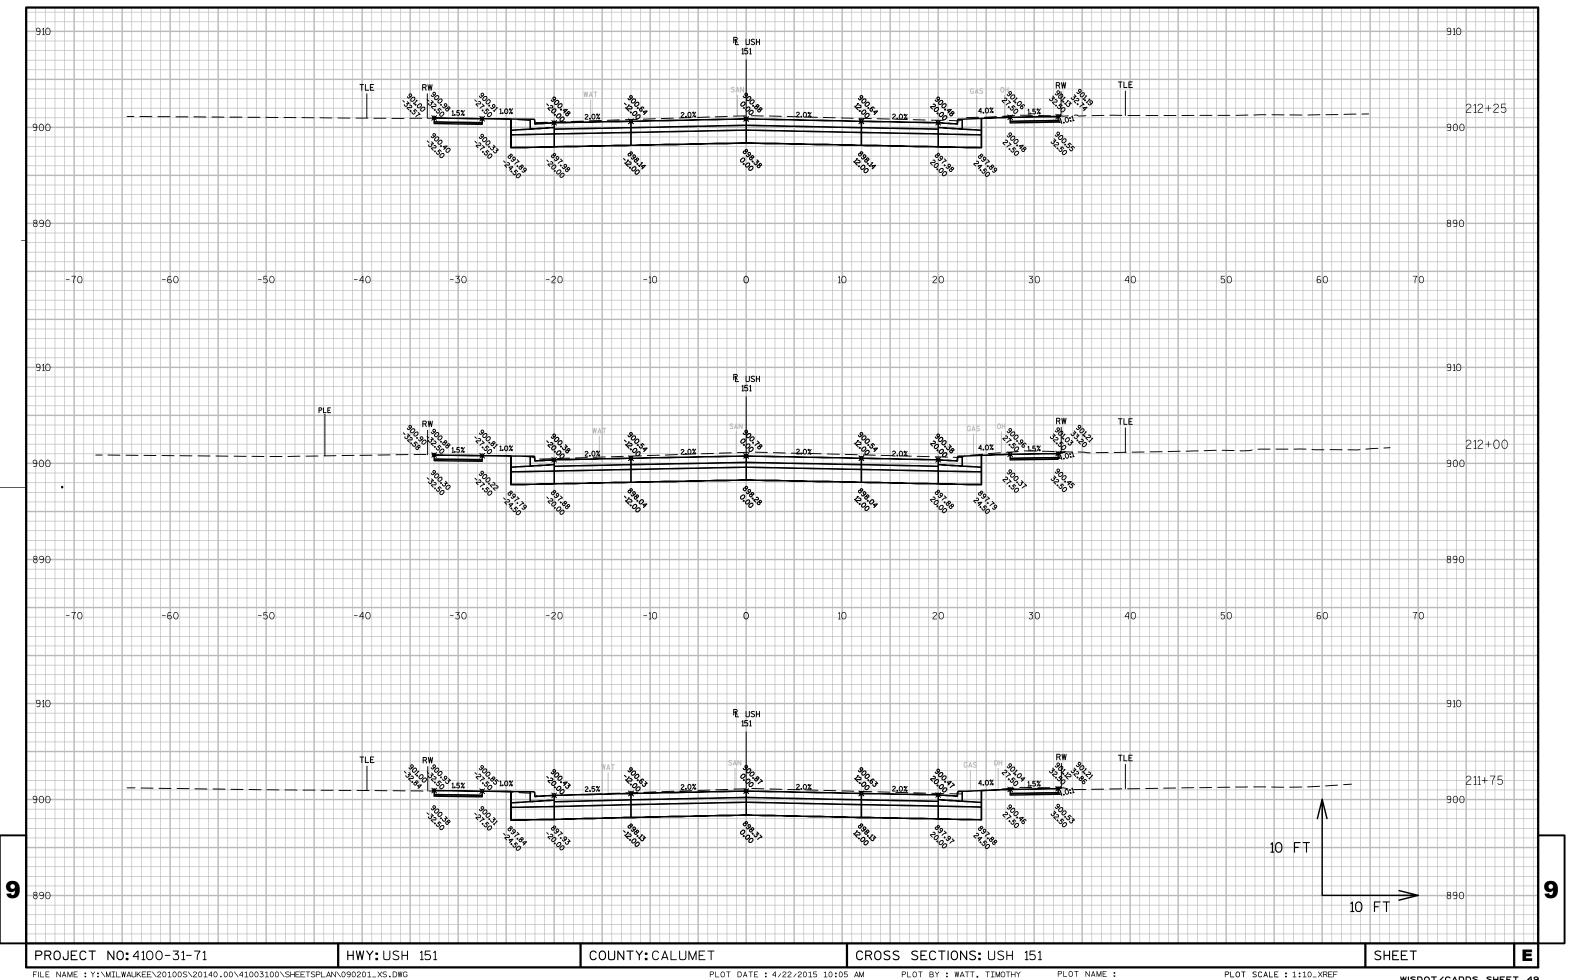
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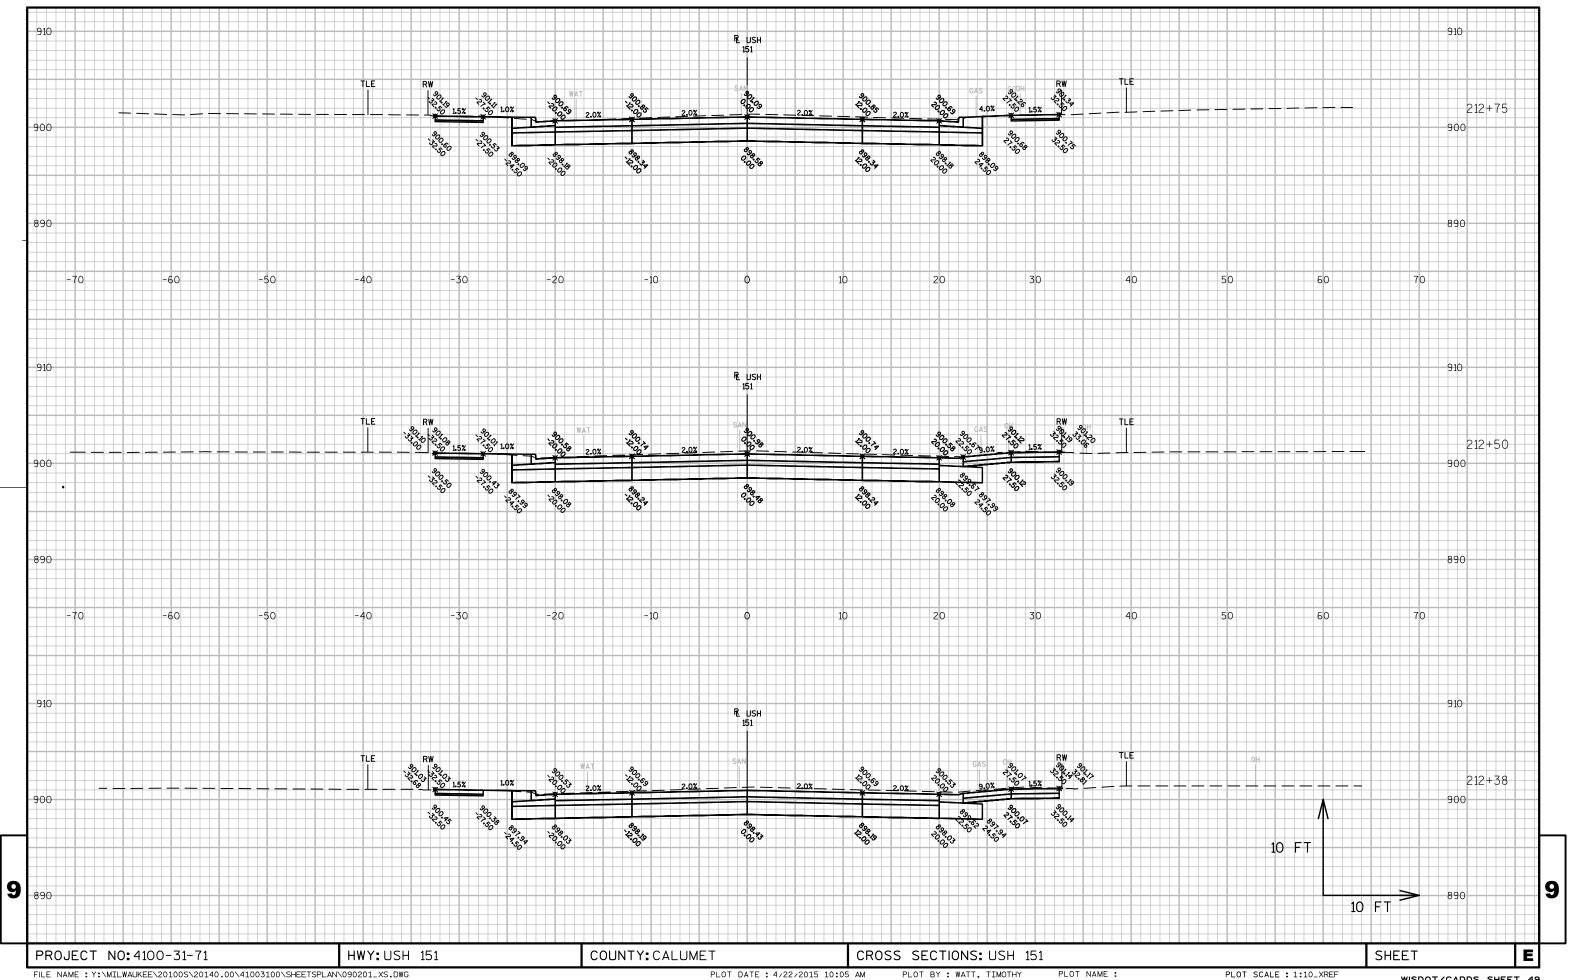
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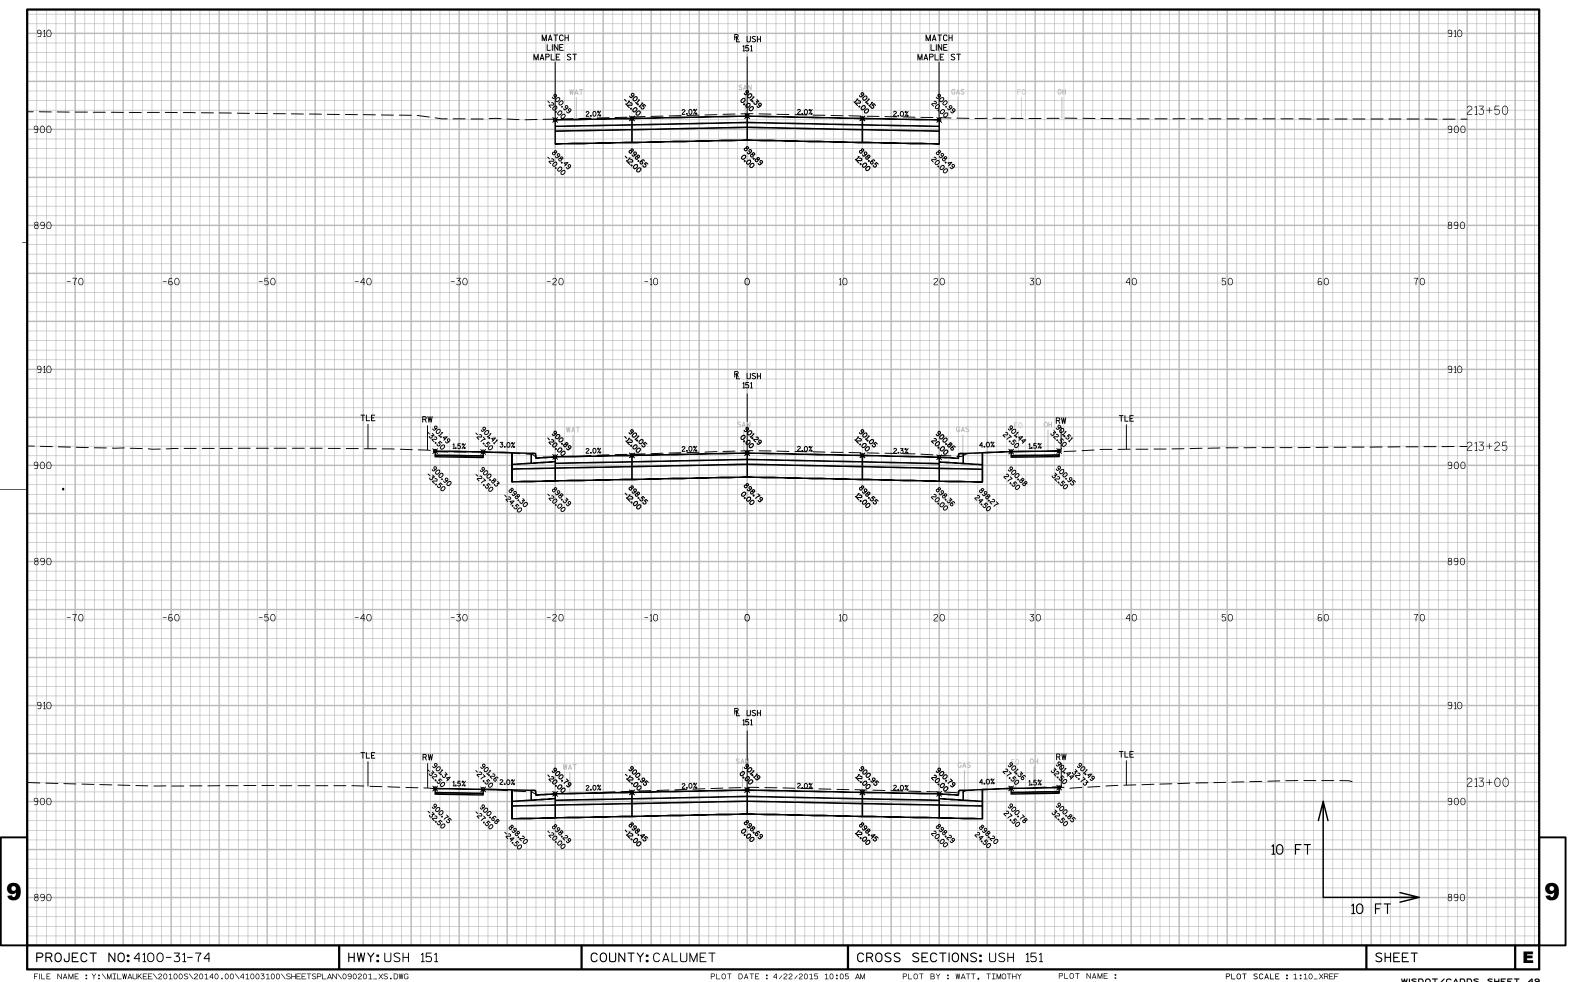
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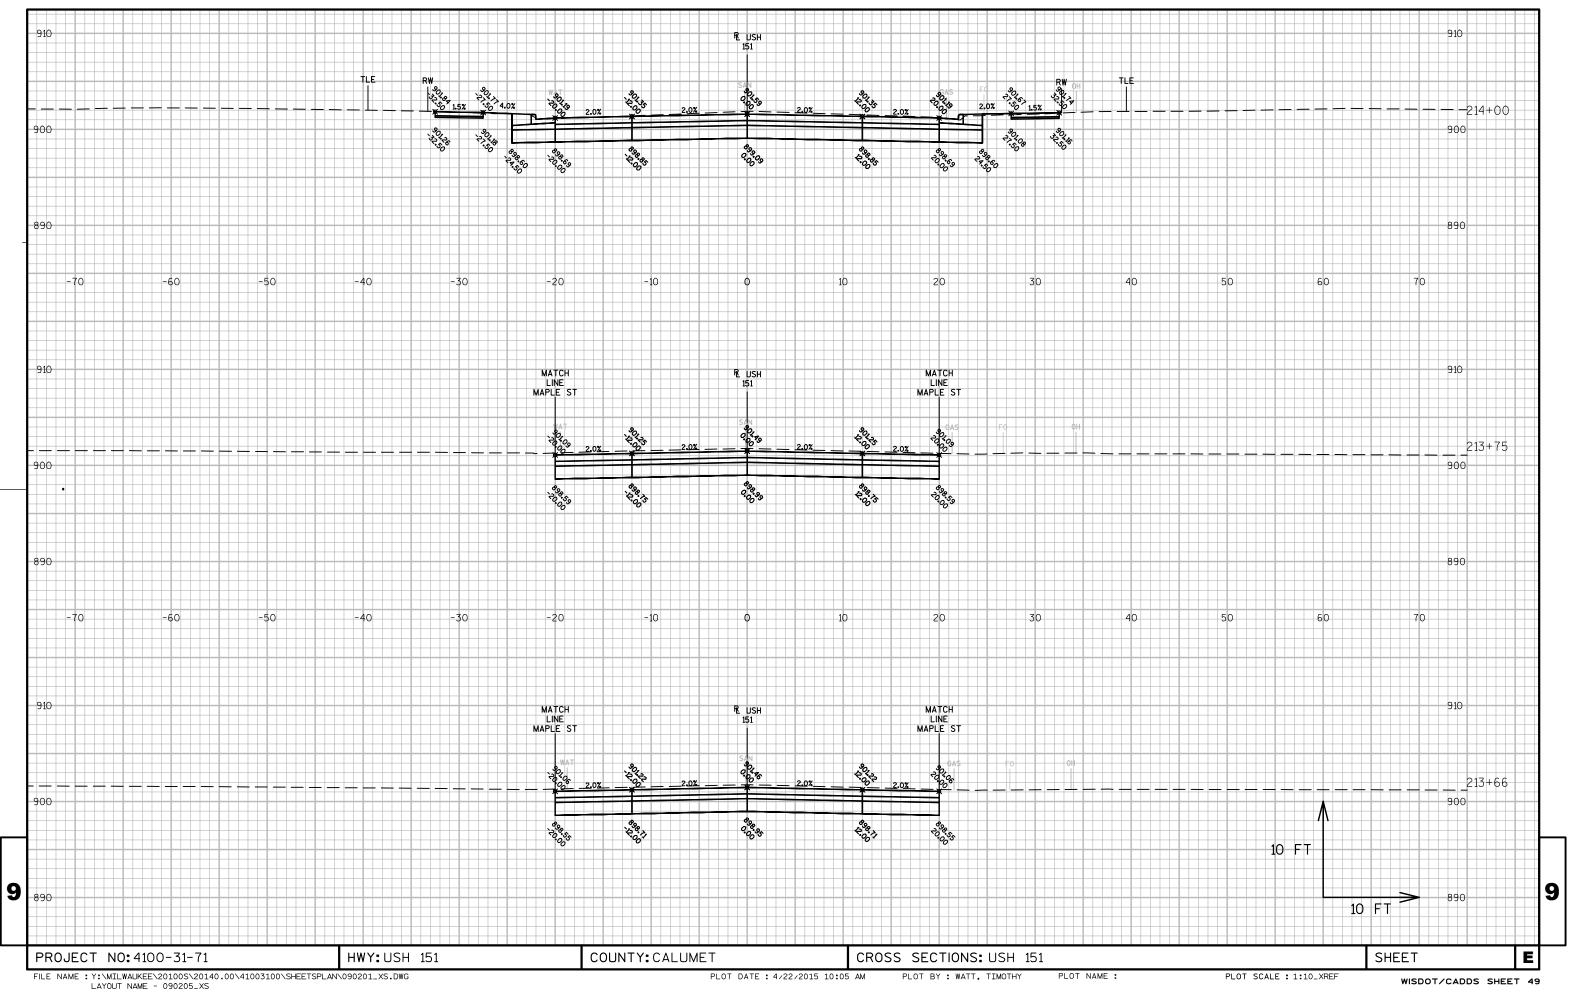
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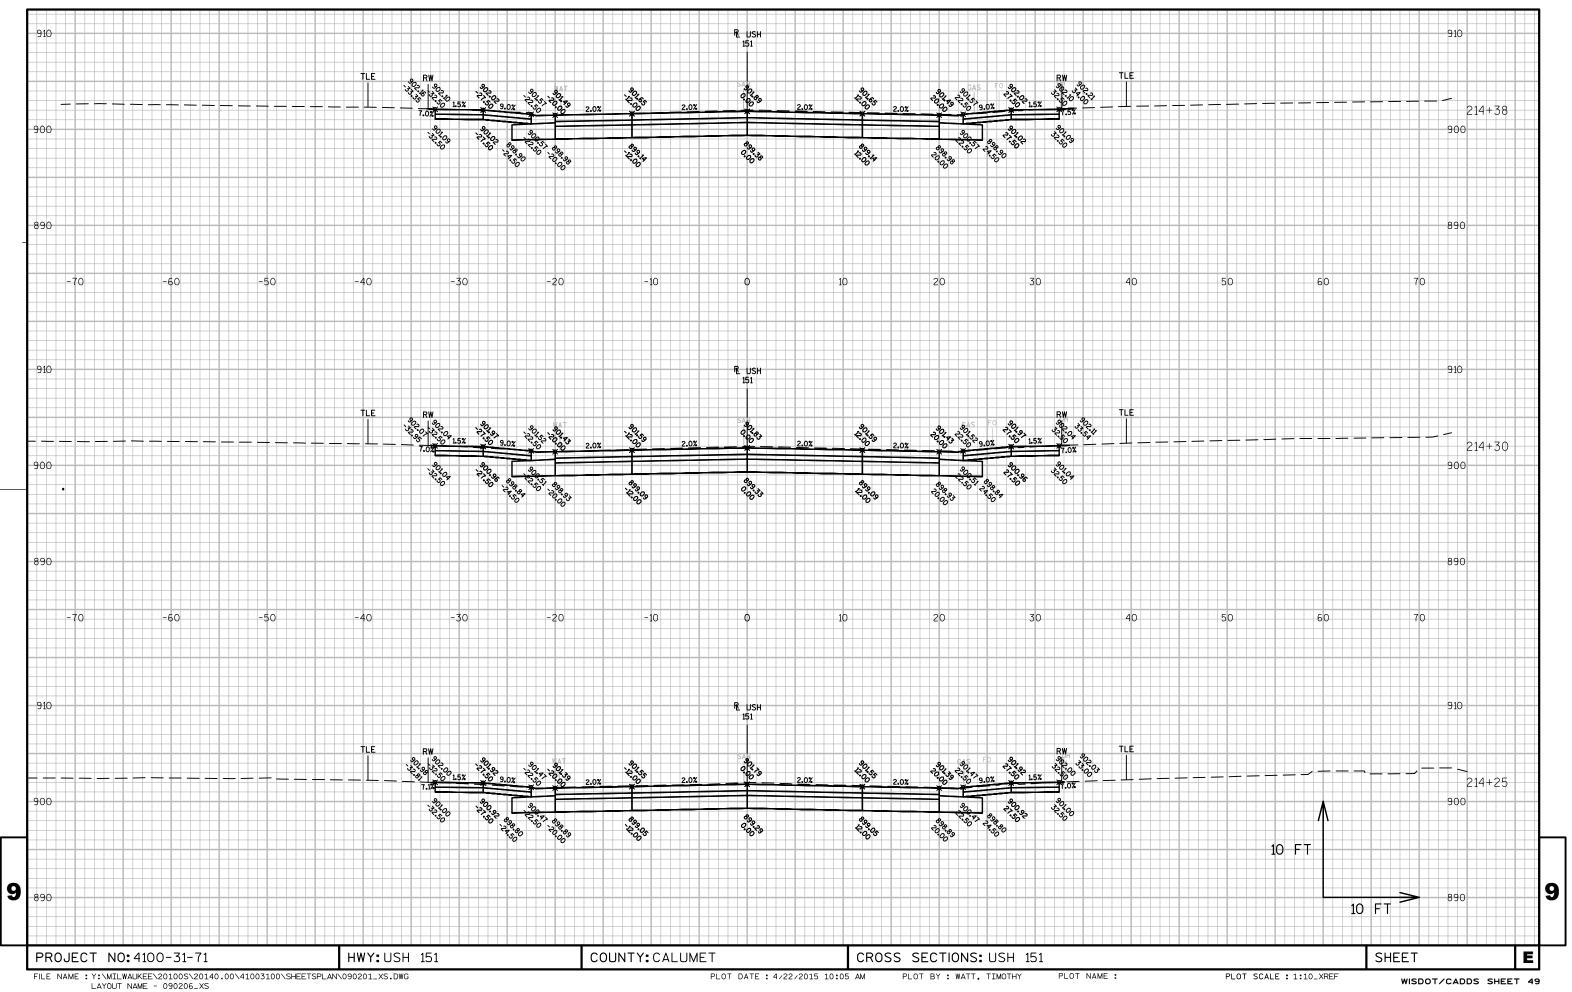














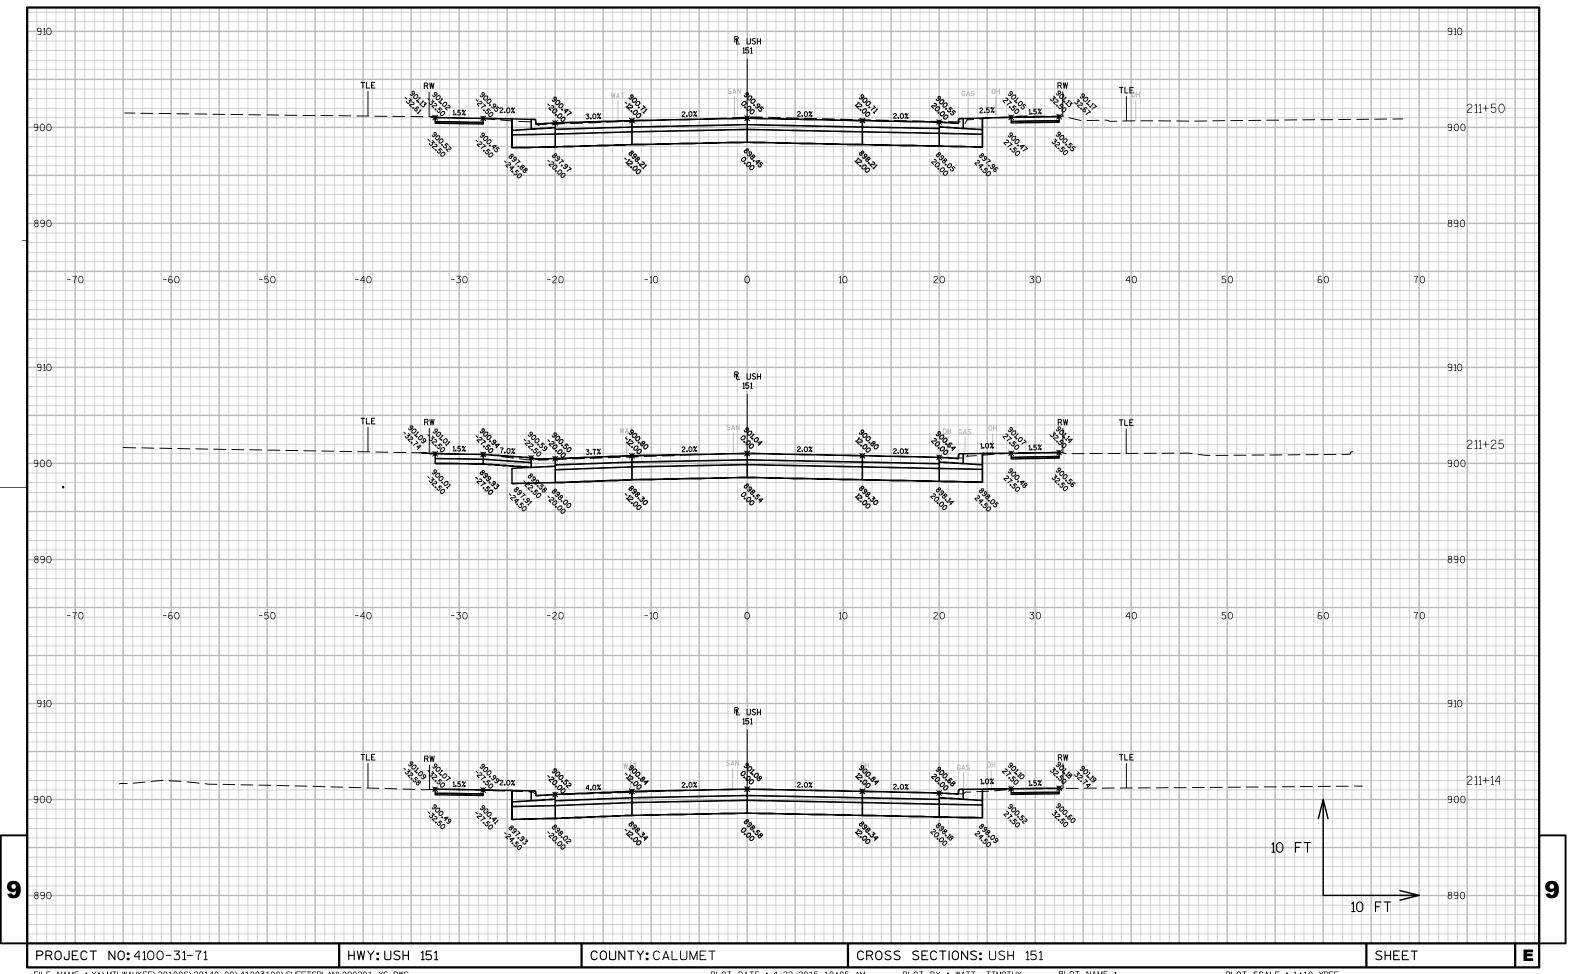


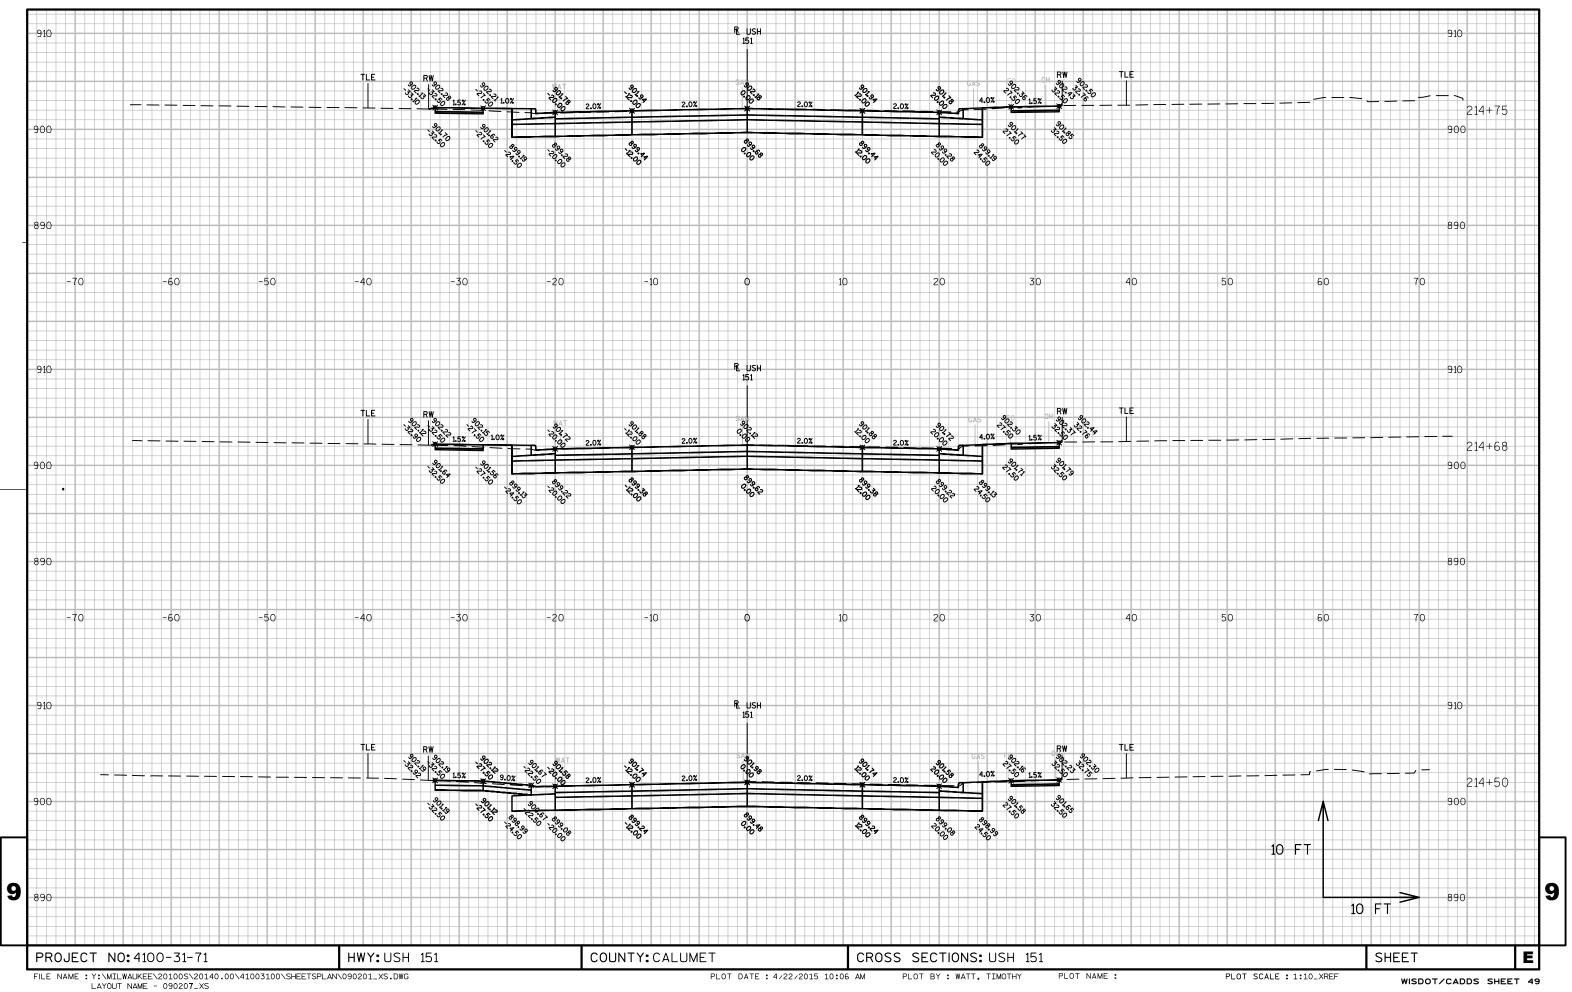


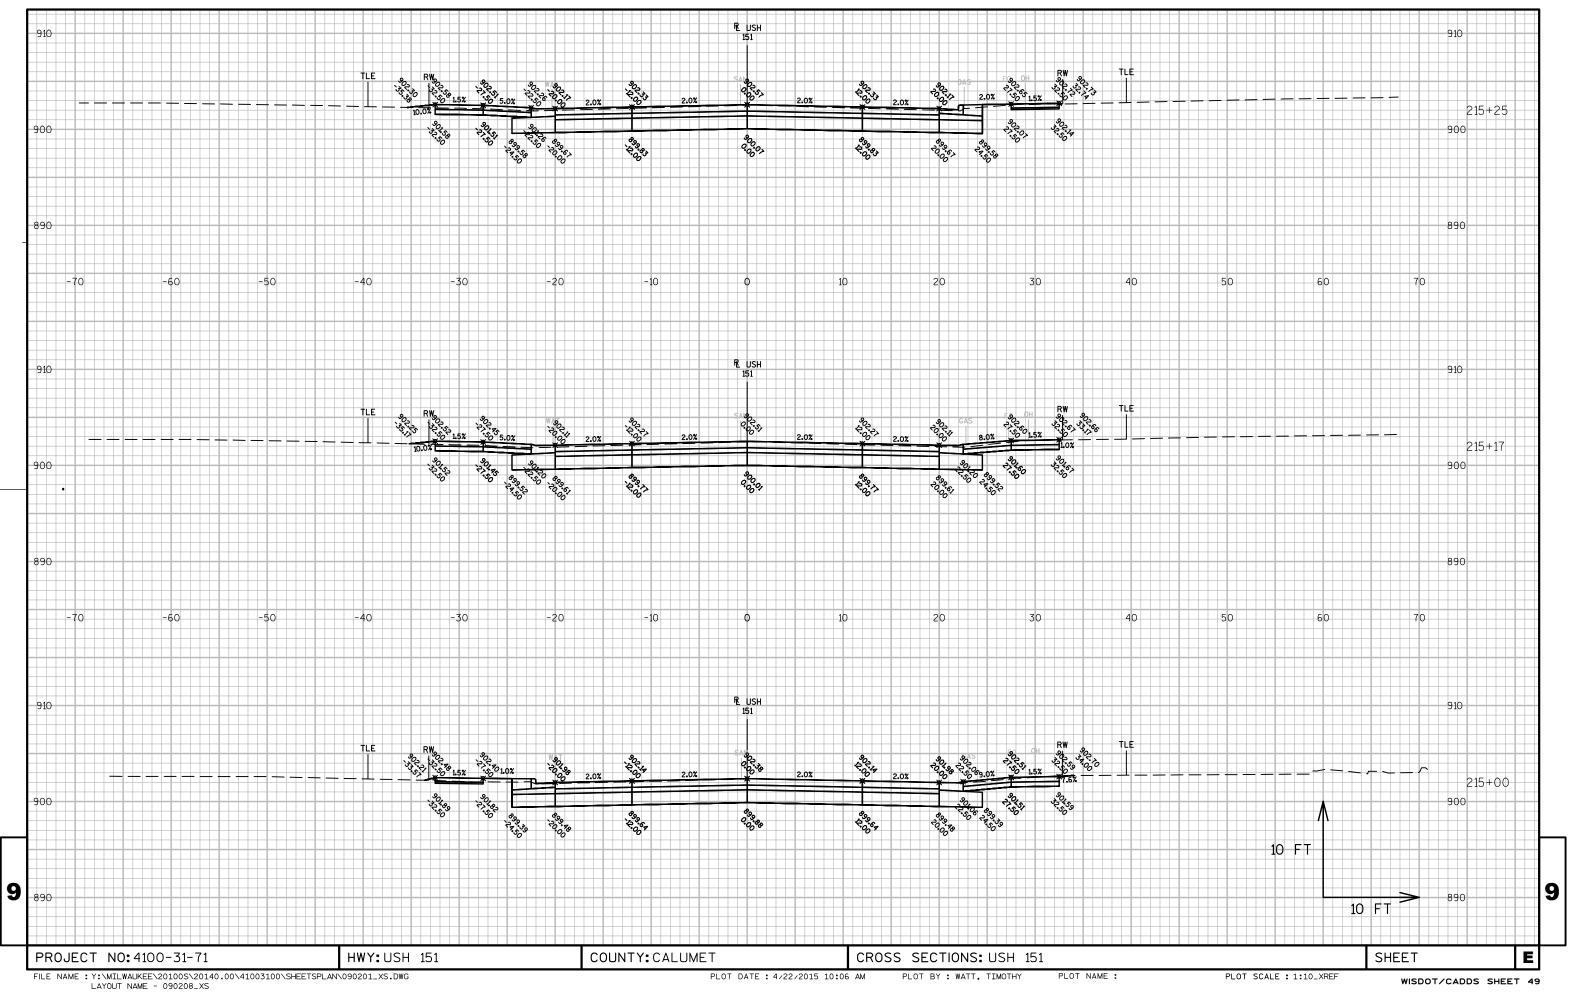


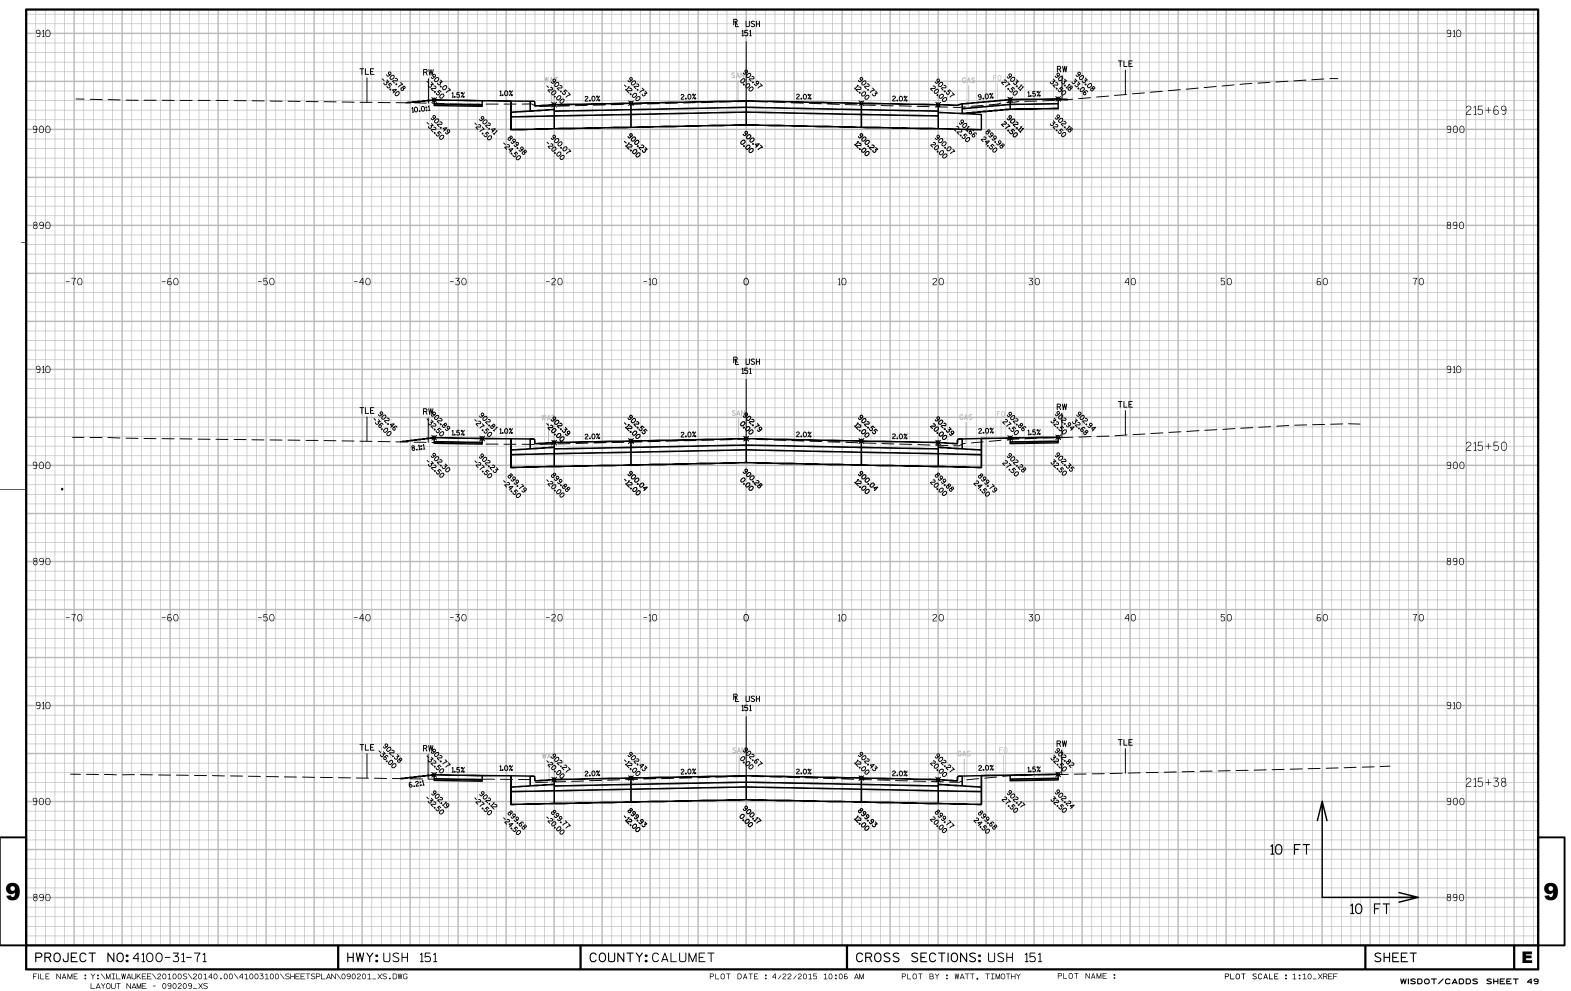


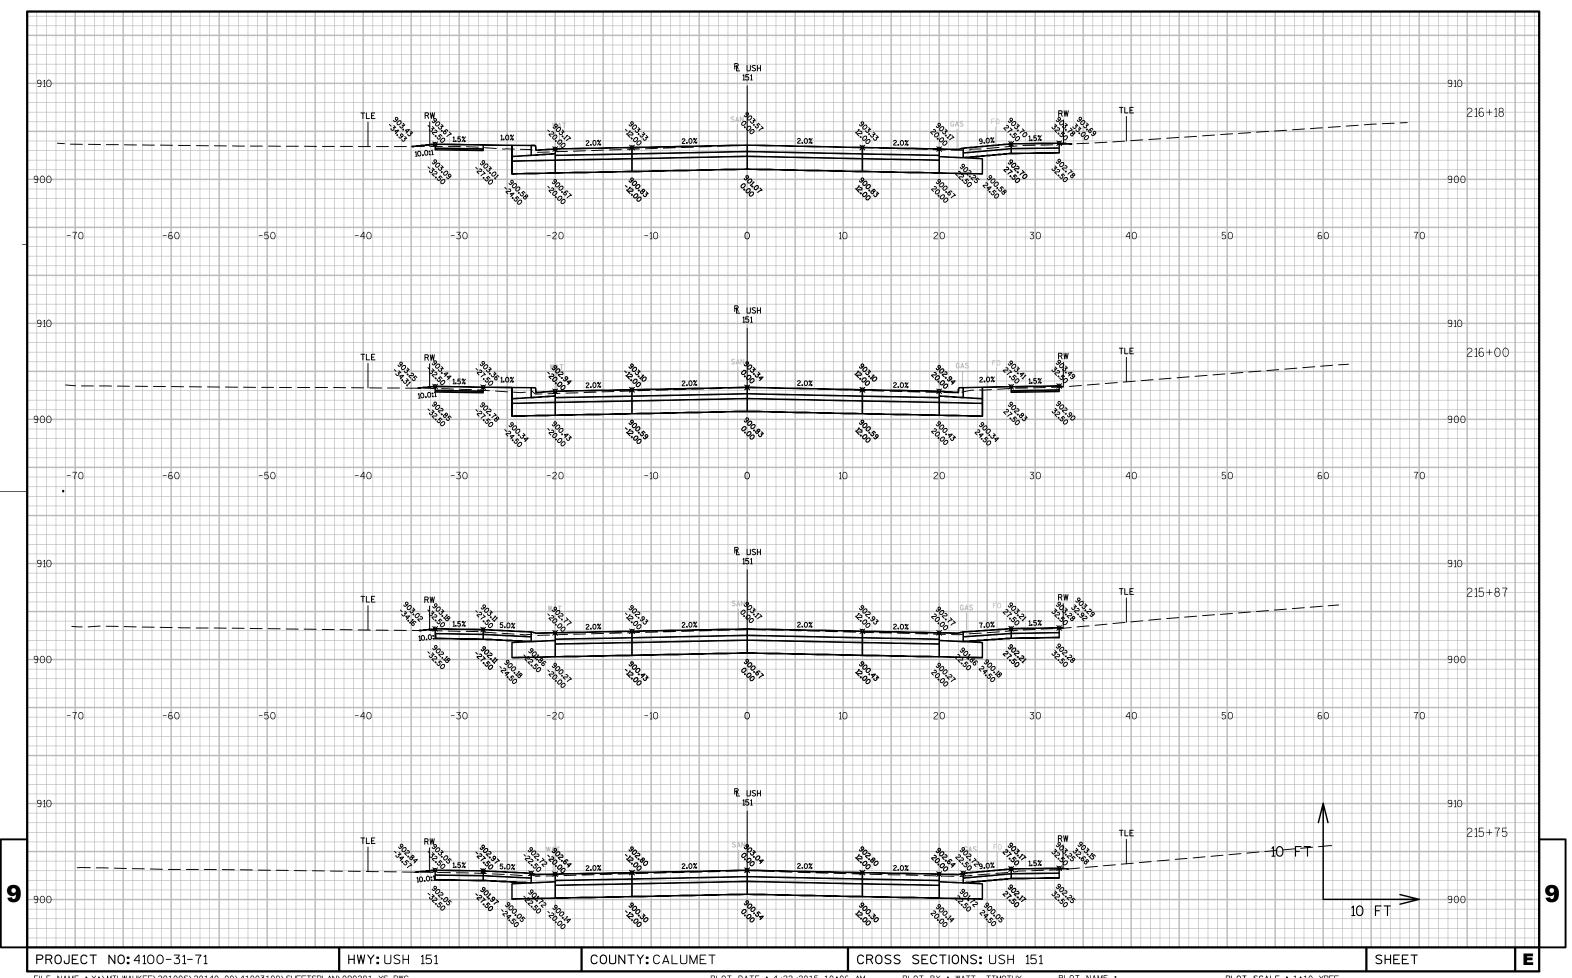


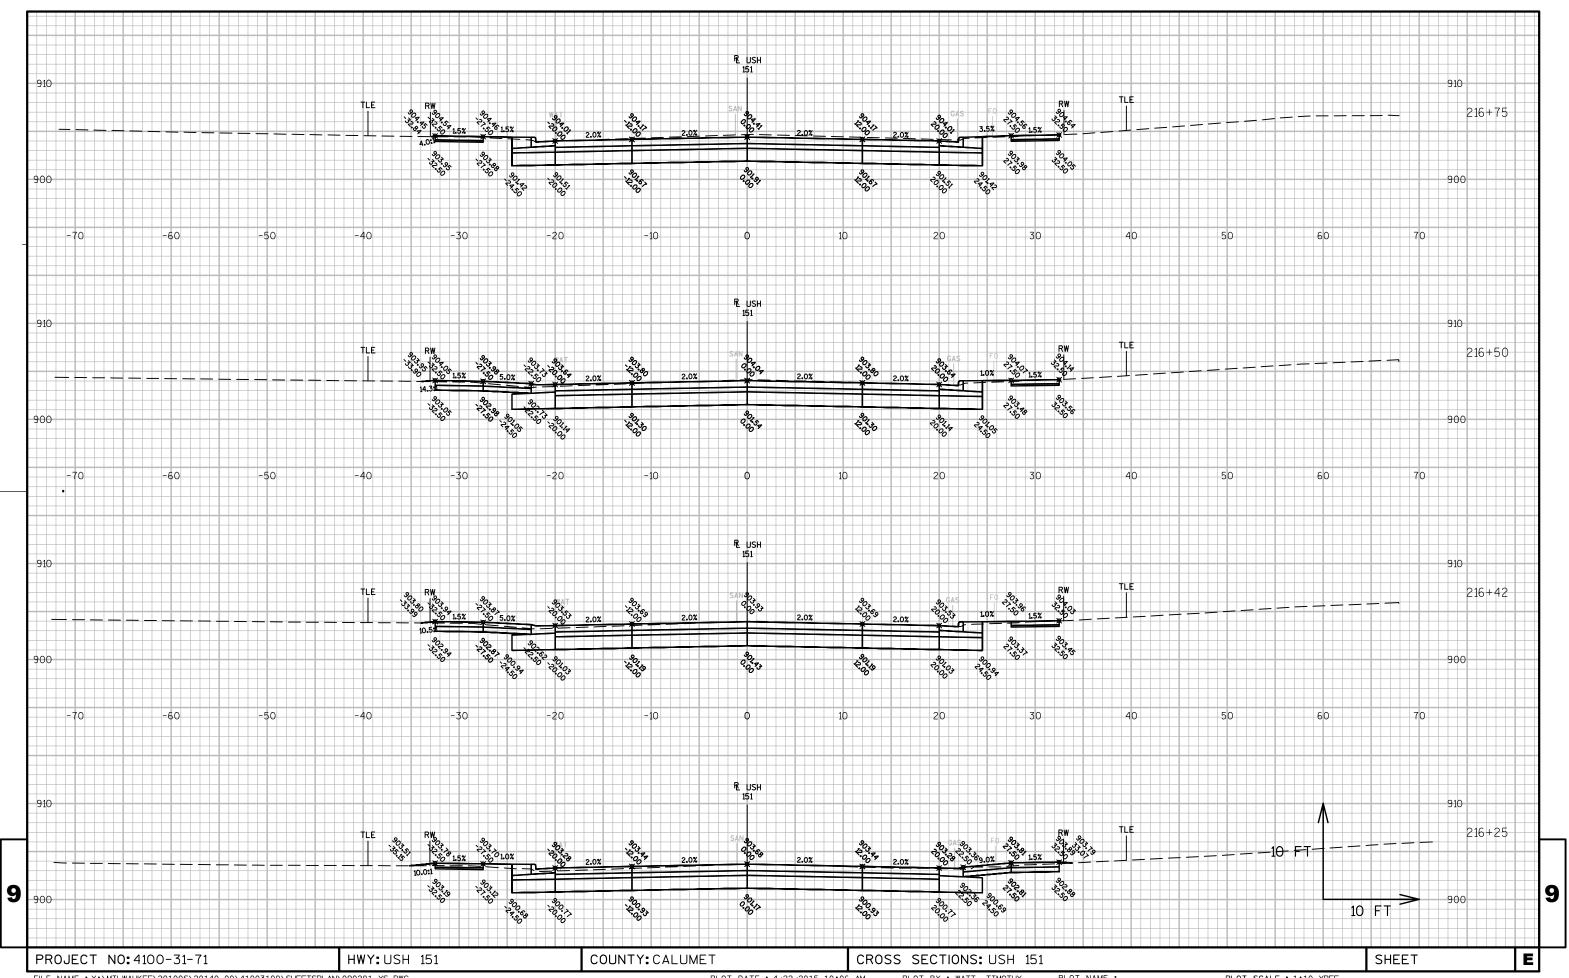


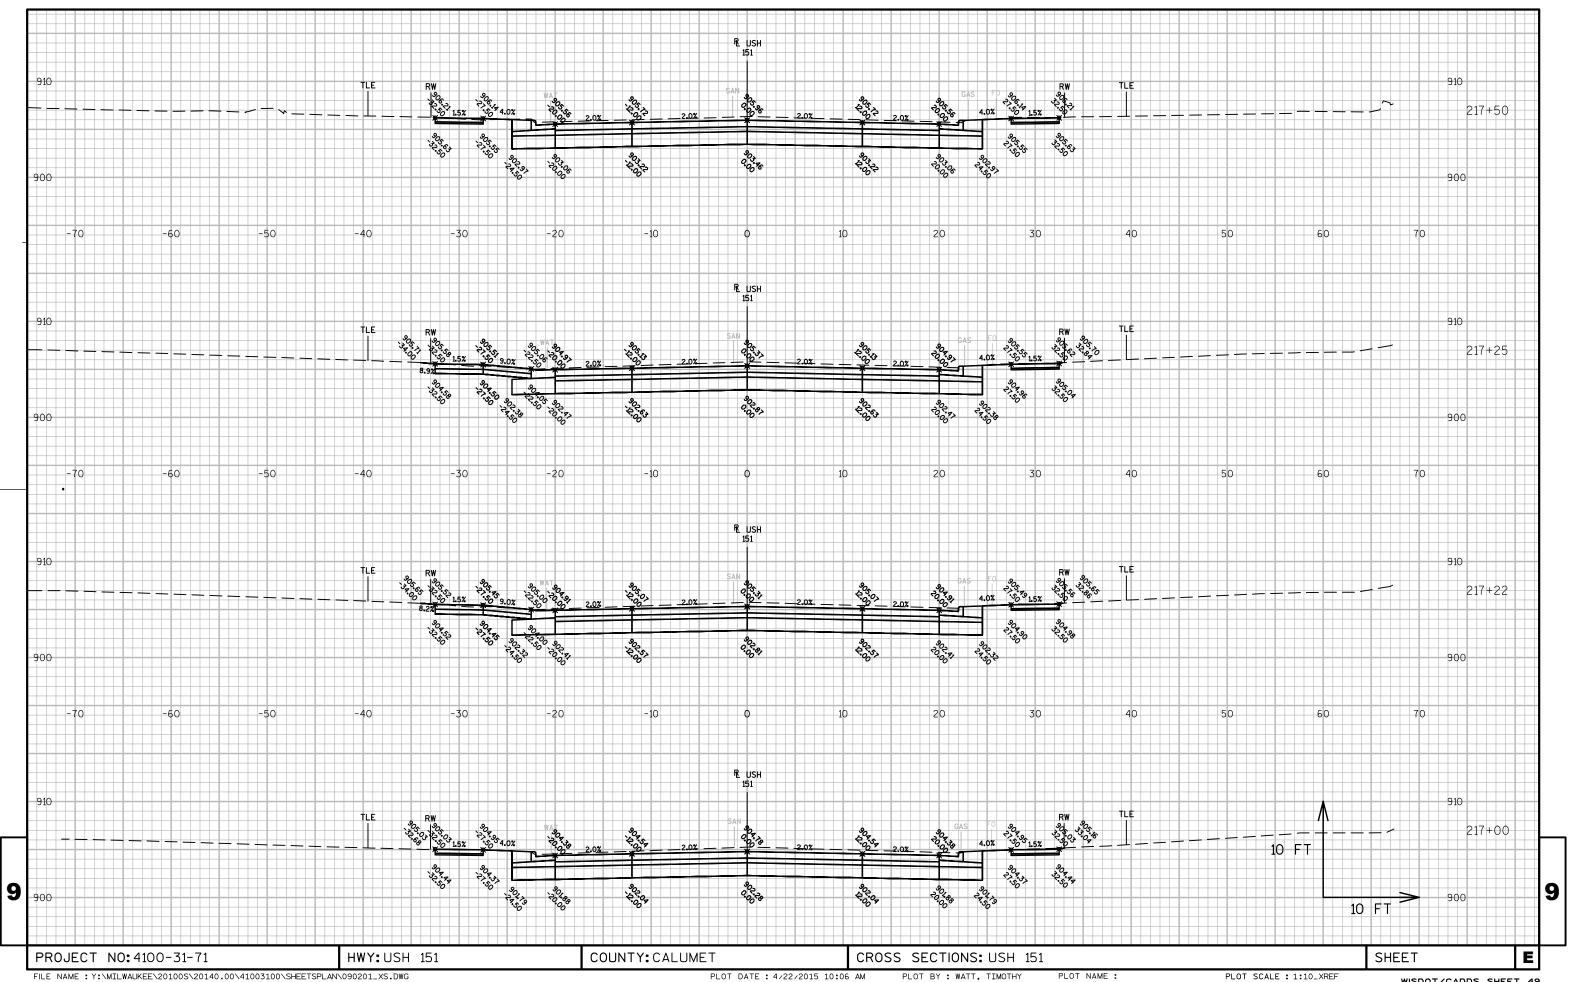


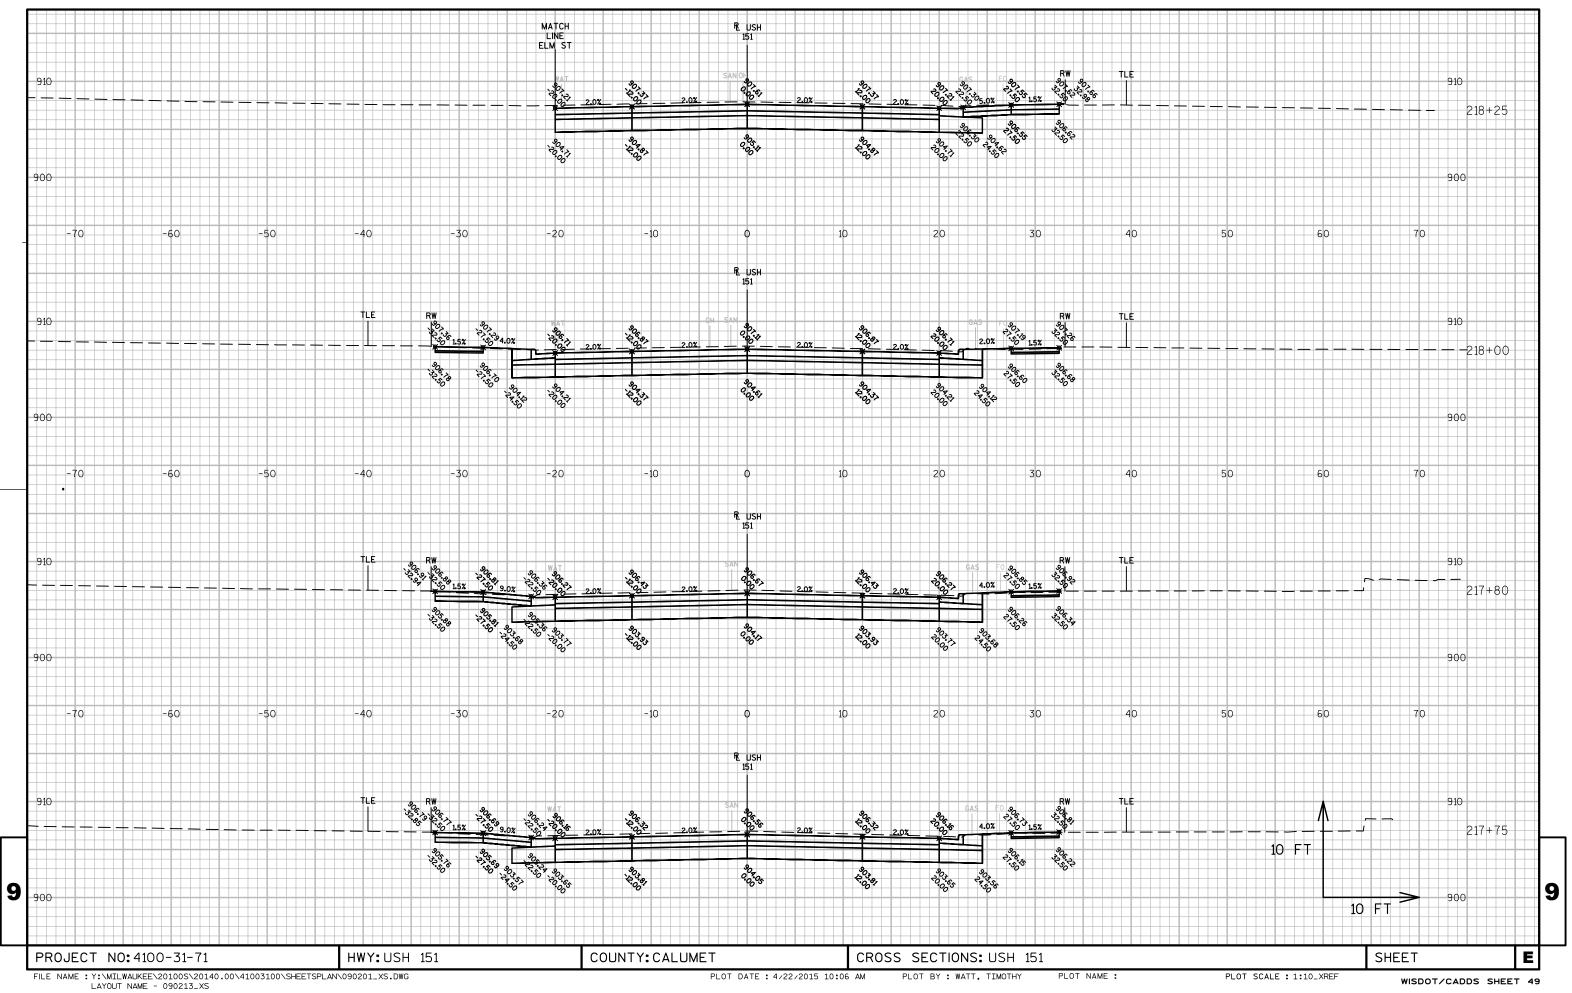


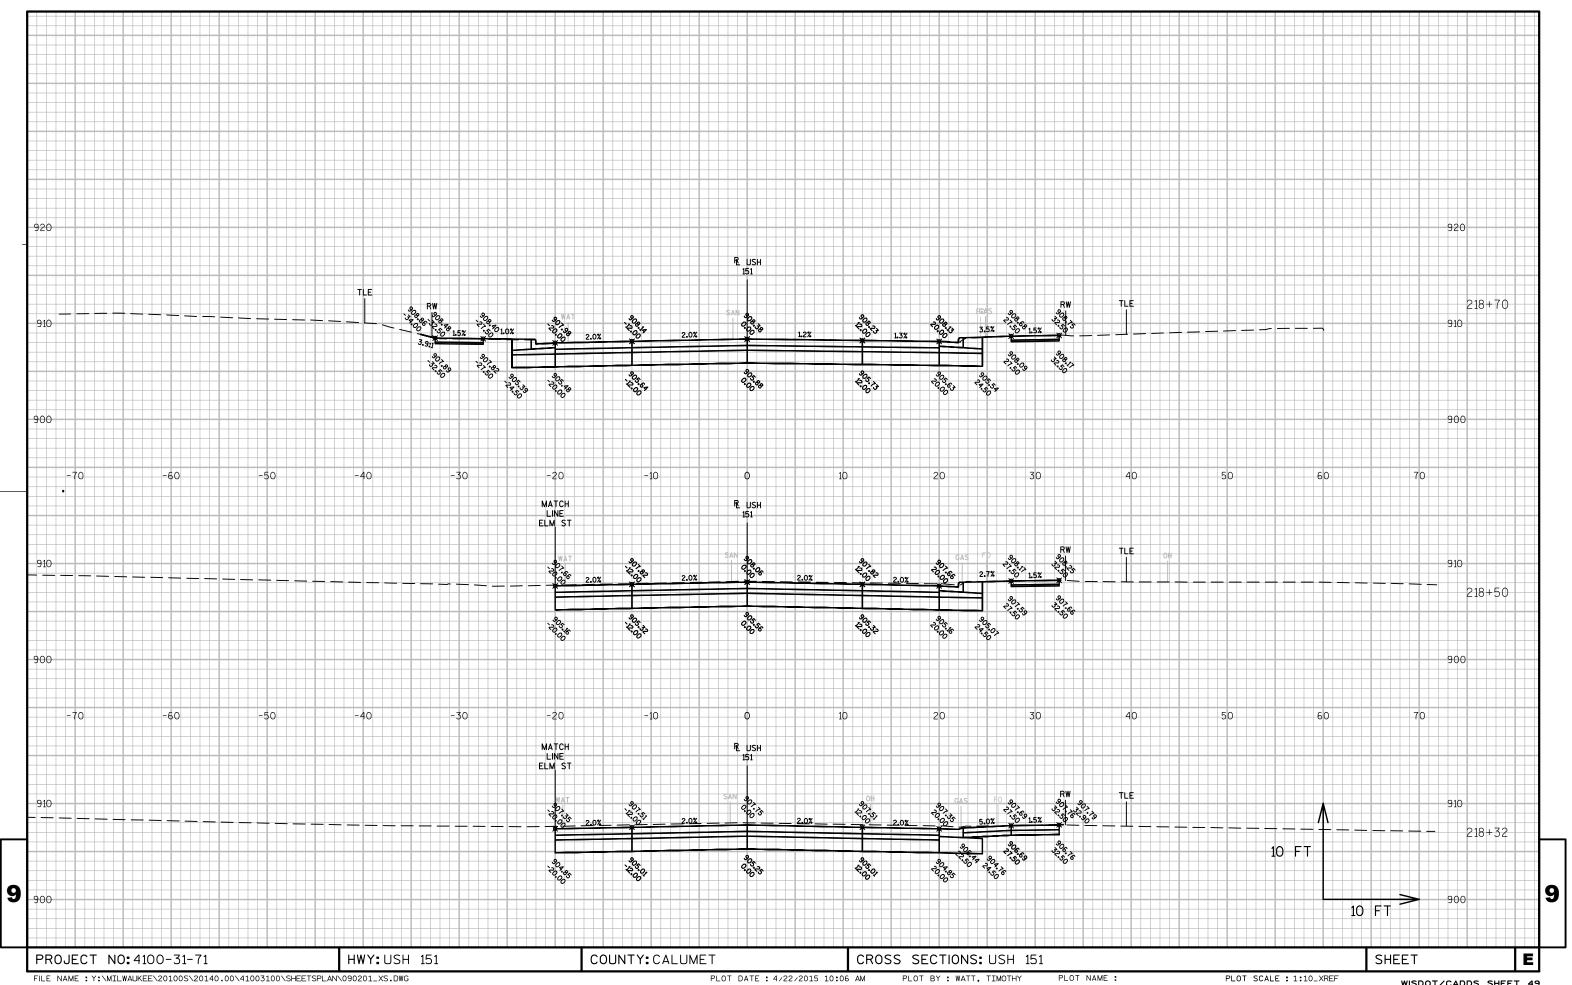

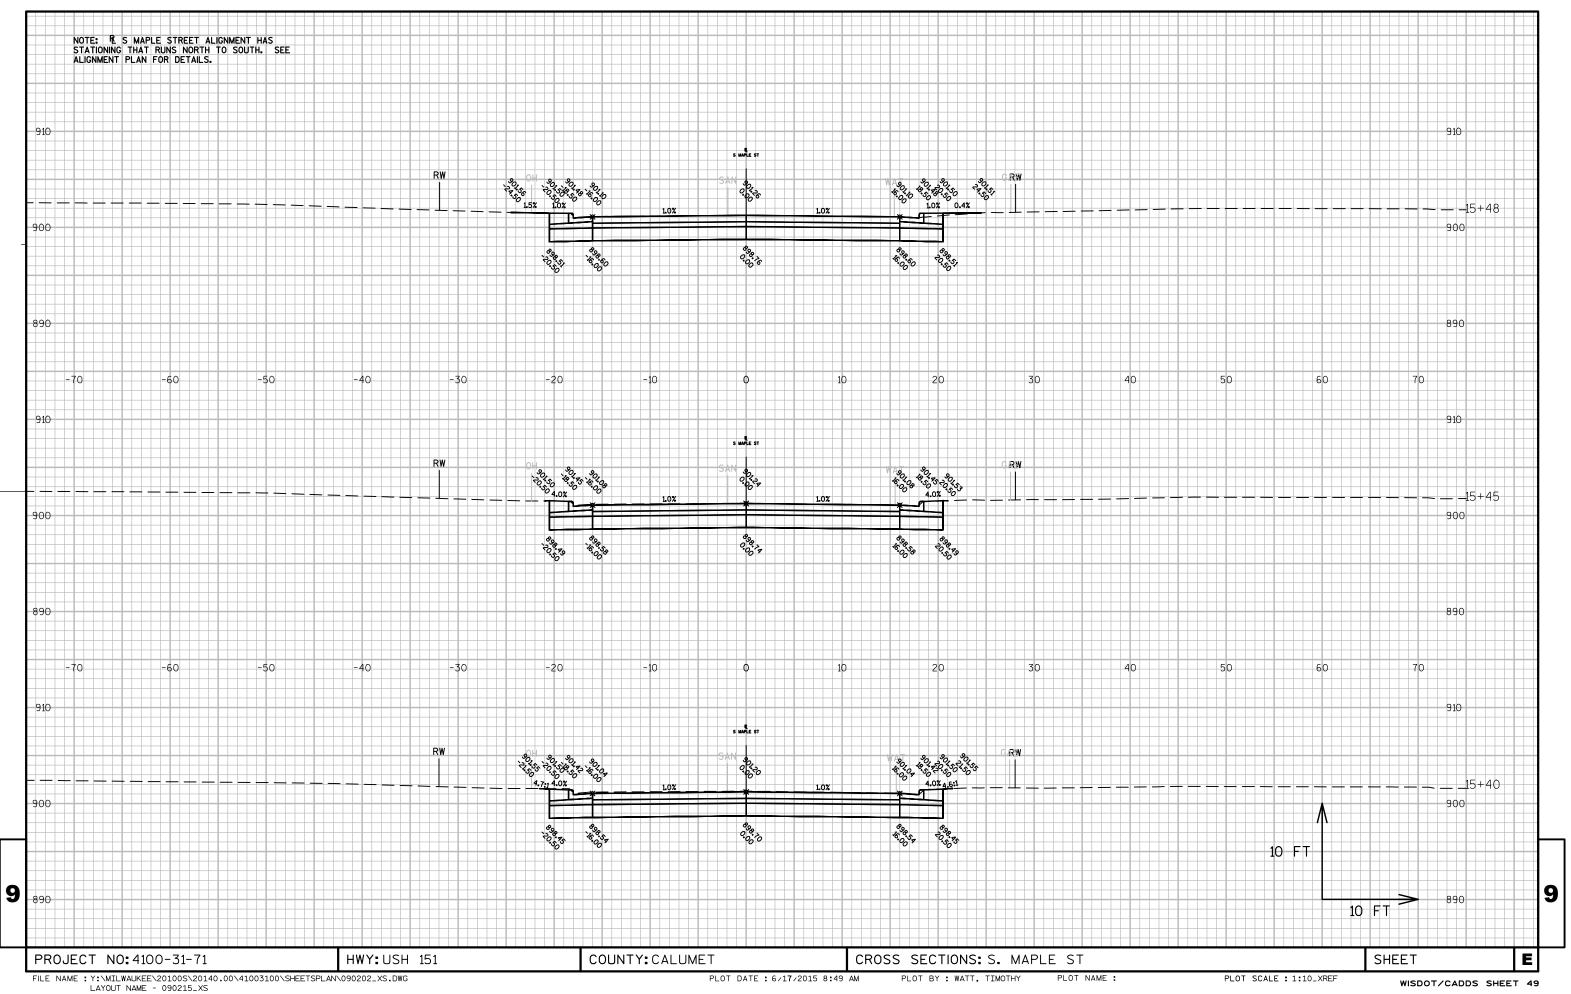

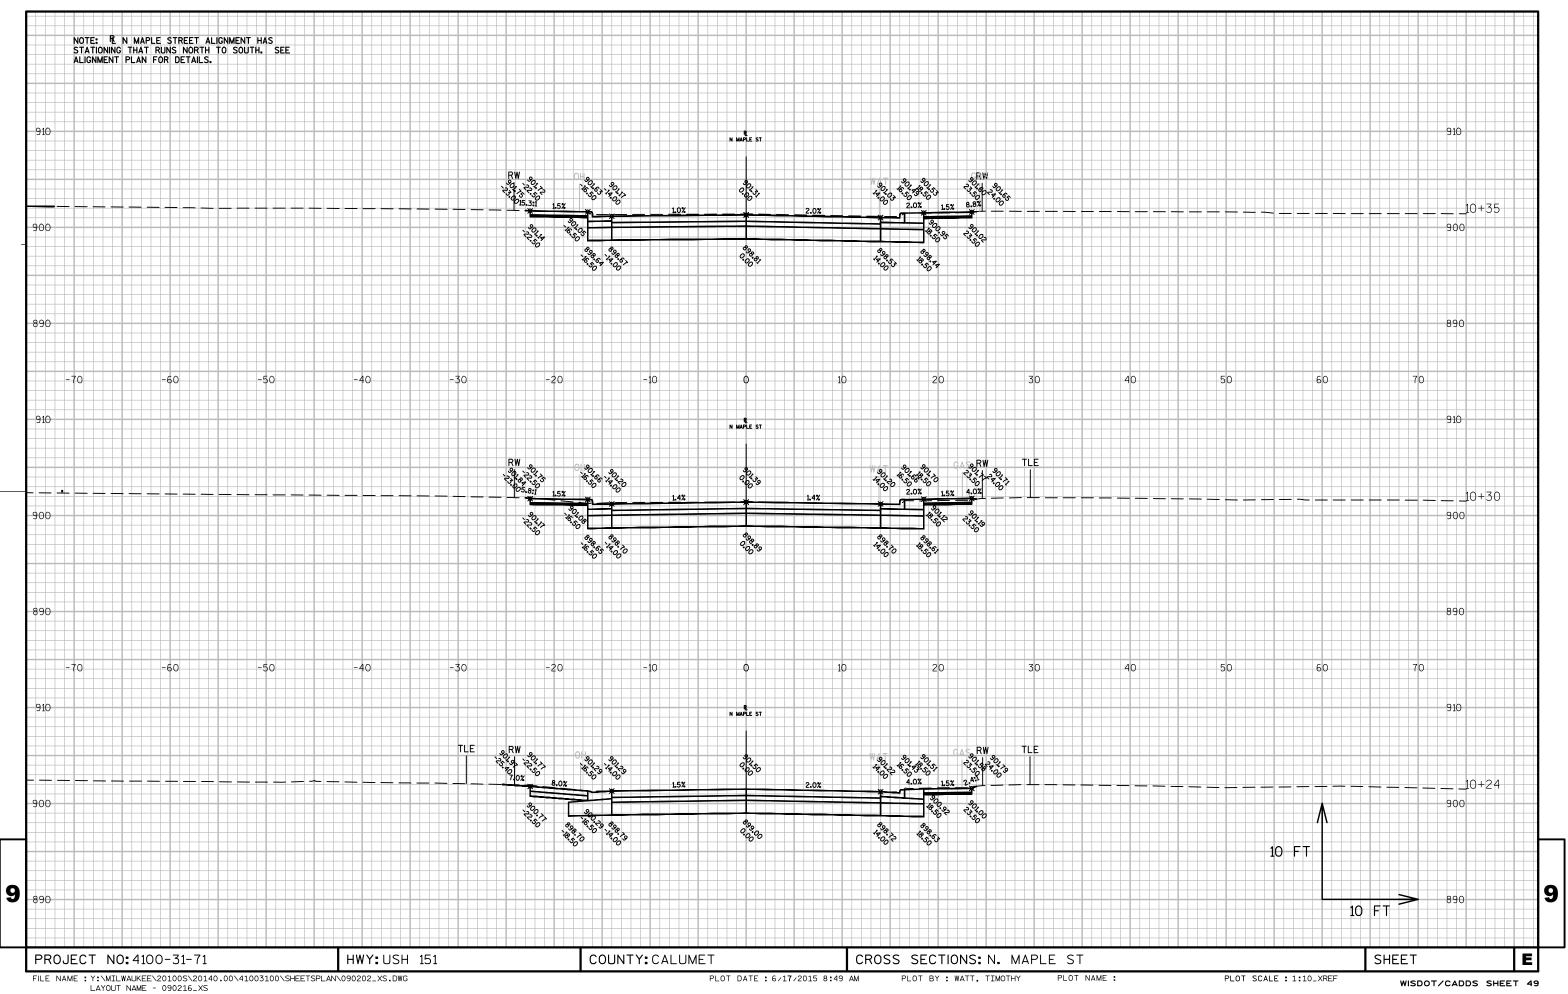

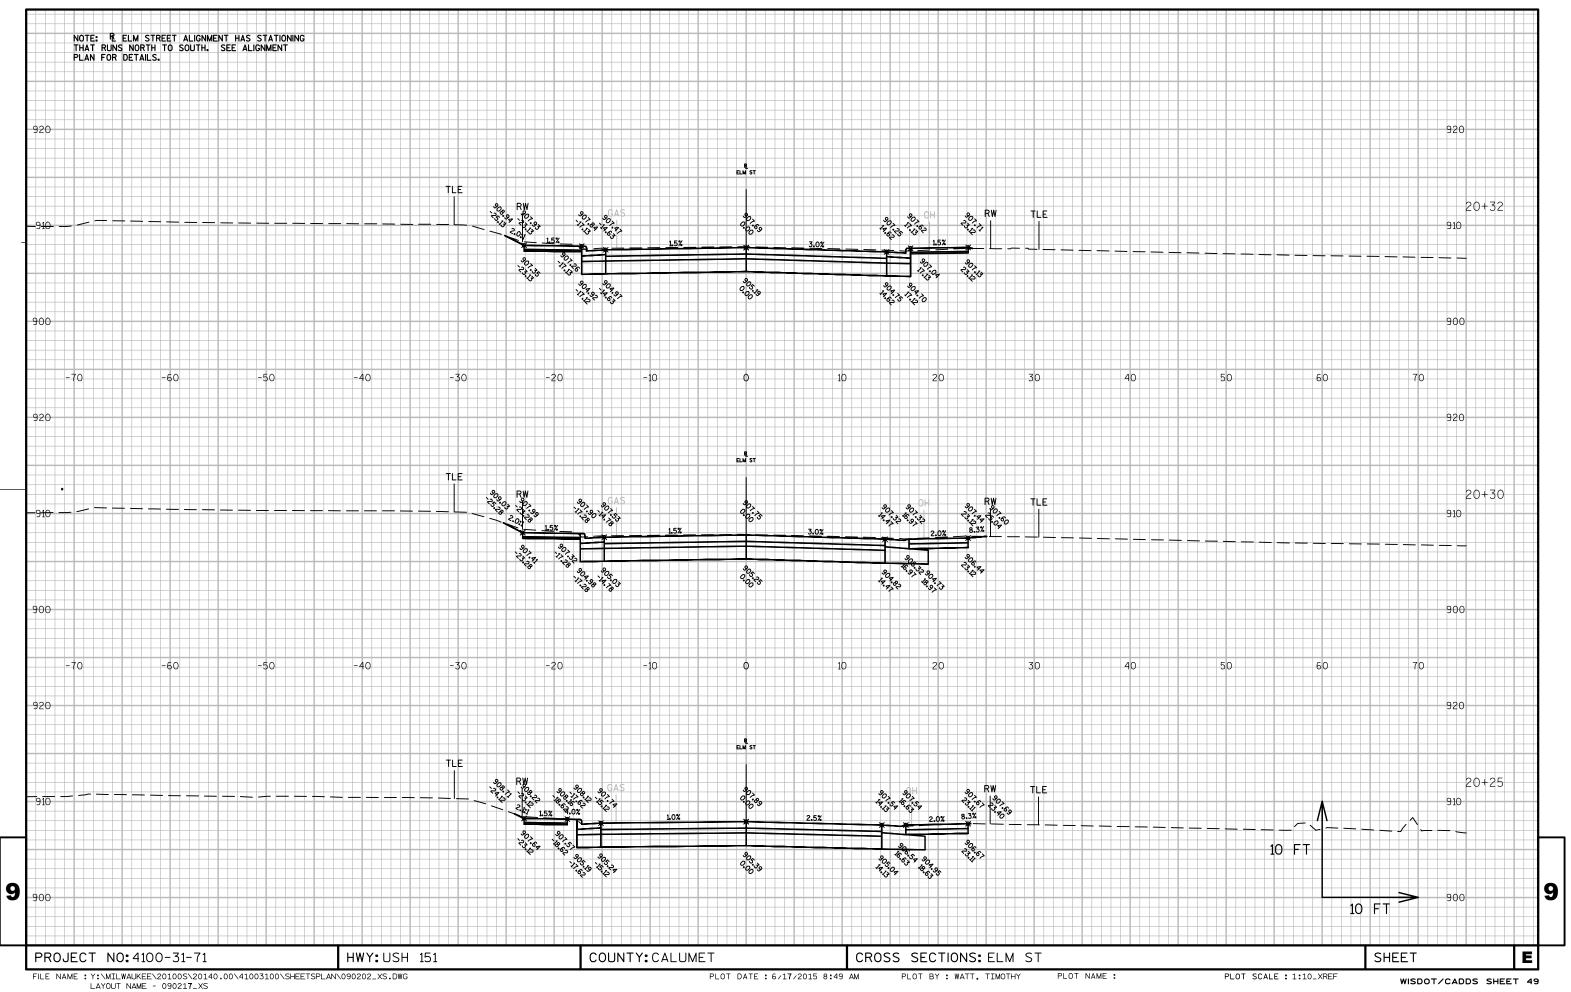

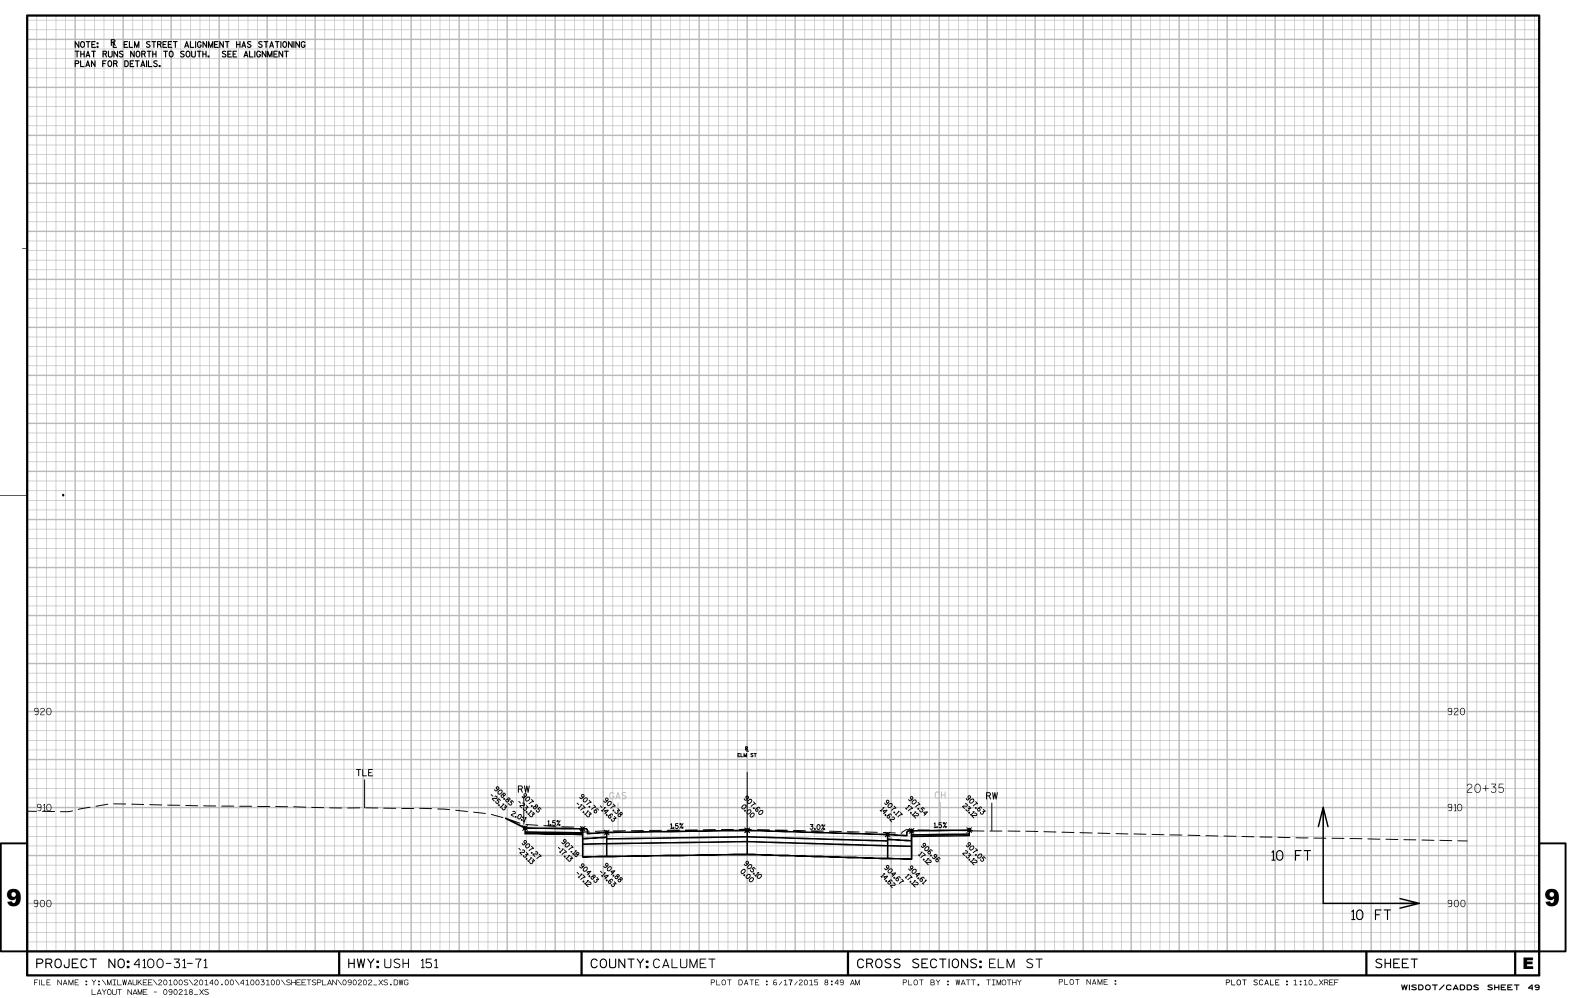



# Wisconsin Department of Transportation

Dedicated people creating transportation solutions through innovation and exceptional service.

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