GRE JUL 2015 -07 -8 WINNE PLAN B \triangleright G

ORDER OF SHEETS

Title Section No. 1 Typical Sections and Details Estimate of Ouantities Wiscellaneous Ouantities Section No. 4 Right of Way Plat Section No. 6 Standard Detail Drawings

TOTAL SHEETS = 44

DESIGN DESIGNATION

A.A.D.T. A.A.D.T. = N/A = N/A D.H.V. = N/A = N/A DESIGN SPEED = N/A **ESALS** = N/A

CONVENTIONAL SYMBOLS

MARSH AREA

WOODED OR SHRUB AREA

CORPORATE LIMITS PROPERTY LINE I OT LINE LIMITED HIGHWAY EASEMENT EXISTING RIGHT OF WAY PROPOSED OR NEW R/W LINE SLOPE INTERCEPT REFERENCE LINE EXISTING CULVERT PROPOSED CULVERT (Box or Pipe) COMBUSTIBLE FLUIDS

PROFILE

GRADE LINE ORIGINAL GROUND SPECIAL DITCH GRADE ELEVATION UTILITIES SANITARY SEWER STORM SEWER WATER

MARSH OR ROCK PROFILE (To be noted as such) CULVERT (Profile View) COMMUNICATION OVERHEAD COMMUNICATION UNDERGROUND ELECTRIC OVERHEAD ELECTRIC UNDERGROUND

LITILITY PEDESTAL

POWER POLE TELEPHONE POLE

Town of Greenville

STATE OF WISCONSIN DEPARTMENT OF TRANSPORTATION PLAN OF PROPOSED IMPROVEMENT


USH 10 - USH 10/STH 441

CTH CB - ONEIDA ST NON HIGHWAY

WINNEBAGO

TOWN OF NEENAH WETLAND MITIGATION SITE

STATE PROJECT NUMBER 517-07-83

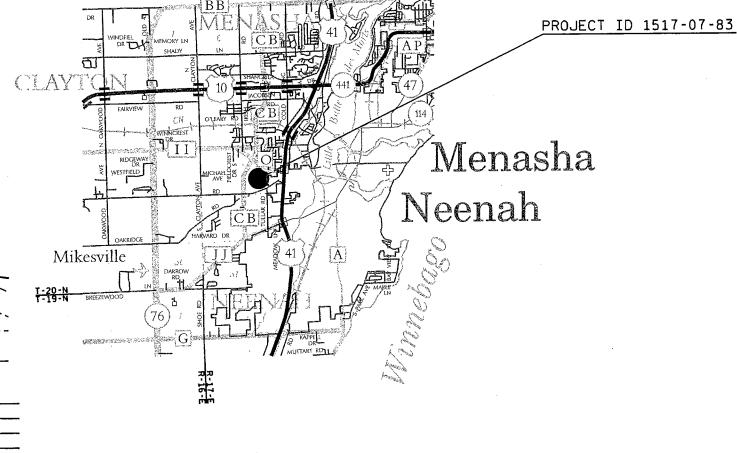

Town of Grand Chute

-"COORDINATES ON THIS PLAN ARE REFERENCED TO THE WISCONSIN COUNTY COORDINATE SYSTEM (WCCS), WINNEBAGO COUNTY, NAD 83 (1997)." -"ELEVATIONS SHOWN ON THIS PLAN ARE REFERENCED TO THE NORTH AMERICAN VERTICAL DATUM OF 1988, NAVD 88 (12)."

PLOT NAME :

FEDERAL PROJECT STATE PROJECT PROJECT CONTRACT 1517-07-83 WISC 2015427

> ENGINEERING, INC Consultant Services ANDREW W. BLOCK E-41224-6 **APPLETON** STATE OF WISCONSIN DEPARTMENT OF TRANSPORTATION

PREPARED BY

NE REGION JT ENGINEERING, INC. Designer Project Monoger SCOTT EBEL Regional Examined Regional Supervisor ____CHAD_DEGRAVE

C.O. Examiner

LAYOUT

TOTAL NET LENGTH OF CENTERLINE = 0.000 MI.

THE CONTRACTOR SHALL CONTACT THE UTILITES AND DIGGERS HOTLINE TO LOCATE AND FIELD VERIFY UTILITIES PRIOR TO THE START OF WORK. THE LOCATIONS OF EXISTING AND PROPOSED UTILITY INSTALLATIONS AS SHOWN ON THE PLANS ARE APPROXIMATE. THERE MAY BE OTHER UTITLITY INSTALLATIONS WITHIN THE PROJECT AREA THAT ARE NOT SHOWN. ANY LOCAL, MUNICIPAL, OR OTHER UTILITY THAT IS NOT A MEMBER OF DIGGERS HOTLINE SHALL BE CONTACTED SEPARATELY.

EXISTING SURFACE ELEVATIONS USED TO CALCULATE PROPOSED EARTHWORK QUANTITIES ARE BASED UPON FIELD SURVEY DATA COLLECTED IN JULY 2014.

NO TREES OR SHRUBS ARE TO BE REMOVED WITHOUT APPROVAL OF THE ENGINEER.

THE CONTRACTOR SHALL BE RESPONSIBLE FOR RESHAPING AND SEEDING ANY PREVIOUSLY GRASSED AREAS WHICH ARE DISTURBED BY ANY OPERATION OUTSIDE OF THE NORMAL CONSTRUCTION LIMITS AT THE CONTRACTOR'S EXPENSE.

PLACE SALVAGED TOPSOIL, TO THE DEPTH SPECIFIED IN THE PLANS AND SPECIFICATIONS, IN ALL GRADED AREAS AS DESIGNATED BY THE ENGINEER IMMEDIATELY AFTER GRADING HAS BEEN COMPLETED. SEED AND PLACE EROSION MAT OR MULCH. IF REQUIRED BY THE ENGINEER OR SHOWN IN THE EROSION CONTROL PLANS, OVER ALL AREAS WITHIN 5 DAYS AFTER PLACEMENT OF SALVAGED TOPSOIL.

EROSION BALES ARE TO ONLY BE USED FOR REINFORCEMENT OF PROPOSED SILT FENCE LOCATIONS ALONG WETLANDS, ANY OTHER USE OF EROSION BALES IS PROHIBITED.

TEMPORARY STORAGE OF ANY EXCAVATED MATERIAL WILL NOT BE PREMITTED IN WETLANDS, FLOODWAY OR FLOODPLAIN OF ANY WATERWAY.

FERTILIZER SHALL NOT BE USED NEAR NAVIGABLE WATERWAYS OR WETLANDS.

THE EROSION CONTROL FEATURES AS SHOWN ON THE PLANS ARE AT SUGGESTED LOCATIONS. EXACT LOCATION WILL BE DETERMINED BY THE ENGINEER.

EROSION CONTROL DEVICES SHALL BE PLACED IN SEQUENCE WITH CONSTRUCTION OPERATIONS OR AS DETERMINED BY THE ENGINEER.

THE FACTOR USED FOR EXPANDING THE FILLS TO COMPUTE THE VOLUME OF MATERIAL REQUIRED IS 1.20.

TRAFFIC CONTROL DEVICES SHALL BE ADJUSTED TO FIT FIELD CONDITIONS AS DIRECTED BY THE ENGINEER.

BENCHMARK LOCATIONS SHOWN ON PLAN ARE APPROXIMATE AND SHOULD BE VERIFIED.

THE DRAIN TILE LOCATIONS SHOWN IN THE PLAN ARE APPROXIMATE.

CAPPING OF THE EXISTING DRAIN TILE IN THE LOCATION NOTED IN THE PLANS SHALL BE CONSIDERED INCIDENTAL TO THE DRAIN TILE EXPLORATION BID ITEM.

ANY DRAIN TILE NOT NOTED TO REMAIN FUNCTIONAL IN THE PLANS THAT IS ENCOUNTERED DURING EXCAVATION OR EXPLORATION OPERATIONS SHALL BE REMOVED OR OTHERWISE DISABLED TO RENDER IT INOPERABLE AS APPROVED BY THE ENGINEER. ITS REMOVAL OR DISABLEMENT SHALL BE CONSIDERED INCIDENTAL TO THE BID ITEM EXCAVATION COMMON OR DRAIN TILE EXPLORATION.

ORDER OF SECTION 2 DETAIL SHEETS

GENERAL NOTES PROJECT OVERVIEW CONSTRUCTION DETAILS **EXISTING CONDITIONS MAP** GRADING PLAN **EROSION CONTROL PLAN** PLANTING PLAN ALIGNMENT PLAN





Dial or (800) 242-8511

www.DiggersHotline.com

UTILITY CONTACTS

AT&T WISCONSIN

MR. GARY LAABS 221 WEST WASHINGTON STREET 4TH FLOOR APPLETON, WI 54911 (920) 735-3063 GL1784@ATT.COM

TIME WARNER CABLE

MR. VINCE ALBIN 3545 PLANK ROAD APPLETON, WI 54915 (920) 831-9249 MOBILE: (920) 378-0444 VINCE ALBIN@TWCABLE.COM

TOWN OF MENASHA UTILITY DISTRICT SANITARY

MR. STEVEN LAABS 2340 AMERICAN DRIVE NEENAH. WI 54956 (920) 739-5120 STEVENL@TOWN-MENASHA.COM

TOWN OF MENASHA UTILITY DISTRICT WATER

MR. JEFF ROTH 2340 AMERICAN DRIVE **NEENAH. WI 54956** (920)720-7175 JEFFR@TOWN-MENASHA.COM

WE ENERGIES ELECTRIC AND GAS

MR. LATROY BRUMFIELD 333 W EVERTT ST A299 MILWAUKEE, WI 53203 (414) 221-5617 MOBILE: (414) 975-9053 LATROY.BRUMFIELD@WE-ENERGIES.COM

WE ENERGIES

ELECTRIC MR. CHRIS SCHULZ 500 S 116TH ST WEST ALLIS, WI 53214 (414) 944-5553 MOBILE: (414) 550-8289 CHRIS.SCHULZ@WE-ENERGIES.COM

WE ENERGIES

LISA MAYNE 1921 8TH ST SOUTH WISCONSIN RAPIDS, WI 54494 (715) 421-7227 LISA.MAYNE@WE-ENERGIES.COM

WINNEBAGO COUNTY HIGHWAY COMMISSIONER

MR. ERNIE WINTERS 901 WEST COUNTY ROAD Y P.O. BOX 2764 OSHKOSH, WI 54903 (920) 232-1700

COUNTY SURVEYOR

MR. JERRY BOUGIE WINNEBAGO COUNTY COURT HOUSE 445 ALGOMA BLVD OSHKOSH, WI 54903 (920) 236-4839

DNR AREA LIAISON

MR. JAY SCHIEFELBEIN DEPARTMENT OF NATURAL RESOURCES 2984 SHAWANO AVENUE GREEN BAY, WI 54313 (920) 360-3784

US ARMY CORP OF ENGINEERS

MR. TODD VESPERMAN **OLD FORT SQUARE** 211 N. BROADWAY, STE 221 GREEN BAY, WI 54303 (651) 290-5857 TODD.VESPERMAN@USACE.ARMY.MIL

HWY: STH 441/USH 10 **COUNTY: WINNEBAGO GENERAL NOTES** SHEET: PROJECT NO: 1517-07-83

PLOT DATE : PLOT BY PLOT NAME: PLOT SCALE: 1:1

ALIGNMENT IDENTIFIERS S MAIN CHANNEL TRAIL NORTH BOUNDARY HWY: STH 441/USH 10 SHEET: COUNTY: WINNEBAGO GENERAL NOTES PROJECT NO: 1517-07-83 PLOT DATE : ___ PLOT BY : ___ PLOT NAME : ____ PLOT SCALE : 1:1

2

2

RUNOFF COEFFICENT TABLE

	HYDROLOGIC SOIL GROUP												
		Α			В			С			D		
	SLOPE	RANGE (PE	RCENT)	SLOPE	RANGE (PE	RCENT)	SLOPE	SLOPE RANGE (PERCENT)			SLOPE RANGE (PERCENT)		
LAND USE:	0-2	2-6	6 & OVER	0-2	2-6	6 & OVER	0-2	2-6	6 & OVER	0-2	2-6	6 & OVER	
ROW CROPS	0.08	0.16	0.22	0.12	0.20	0.27	0.15	0.24	0.33	0.19	0.28	0.38	
	0.22	0.30	0.38	0.26	0.34	0.44	0.30	0.37	0.50	0.34	0.41	0.56	
MEDIAN STRIP-	0.19	0.20	0.24	0.19	0.22	0.26	0.20	0.23	0.30	0.20	0.25	0.30	
TURF	0.24	0.26	0.30	0.25	0.28	0.33	0.26	0.30	0.37	0.27	0.32	0.40	
SIDE SLOPE- TURF			0.25			0.27			0.28			0.30	
TURF			0.32			0.34			0.36			0.38	
PAVEMENT:													
ASPHALT						.7095							
CONCRETE						.8095							
BRICK						.7080							
DRIVES, WALKS						.7585							
ROOFS						.7595							
GRAVEL ROADS,	SHOULDER	RS				.4060							

<u>1517-07-83</u>


TOTAL PROJECT AREA = 35.37 ACRES

TOTAL AREA EXPECTED TO BE DISTURBED BY CONSTRUCTION ACTIVITIES = 28.80 ACRES

PROJECT NO: 1517-07-83 HWY: STH 441/USH 10 COUNTY: WINNEBAGO GENERAL NOTES SHEET: E

FILE NAME : _____ PLOT DATE : ____ PLOT BY : ____ PLOT NAME : ____ PLOT SCALE : 1:1




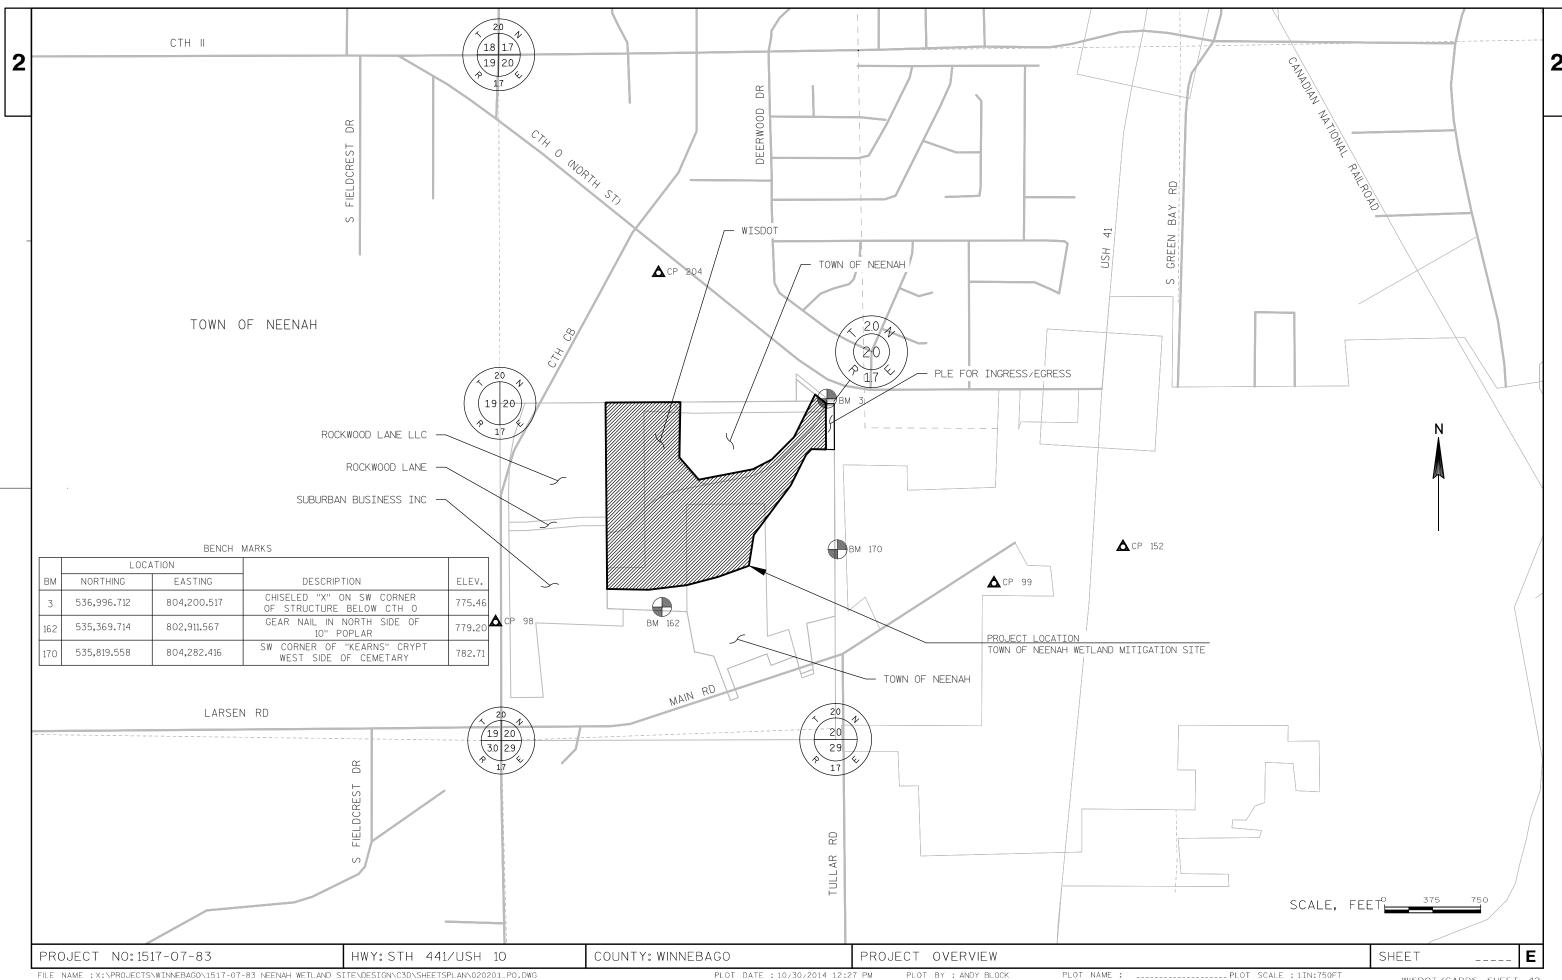


PLOT DATE: 10/30/2014 12:27 PM

PLOT NAME : _____PLOT SCALE : 1IN:750FT



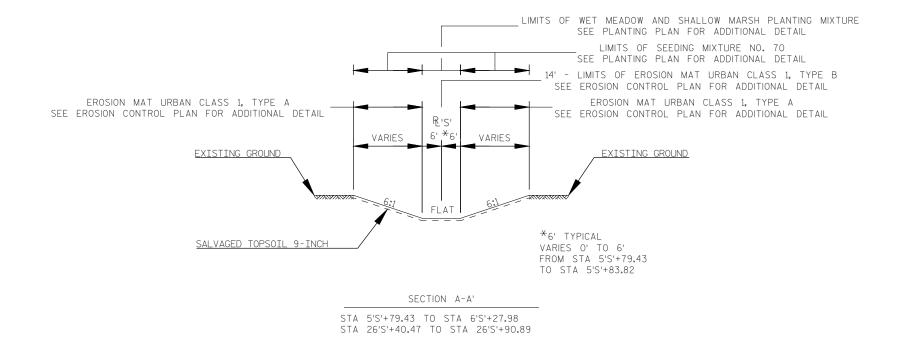

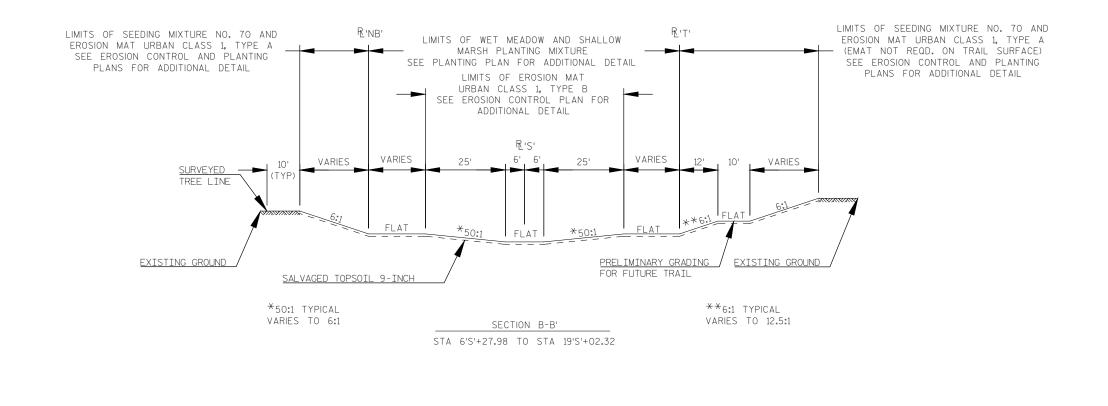

CONSTRUCTION DETAILS

FILE NAME :X:\PROJECTS\WINNEBAGO\1517-07-83 NEENAH WETLAND SITE\DESIGN\C3D\SHEETSPLAN\021001_CD.DWG PLOT DATE :1/22/2015 11:41 AM F

COUNTY: WINNEBAGO


HWY: STH 441/USH 10


PROJECT NO: 1517-07-83

PLOT BY : CHAD KWIATKOWSKI PLOT NAME : _____PLOT SCALE : ########

SHEET



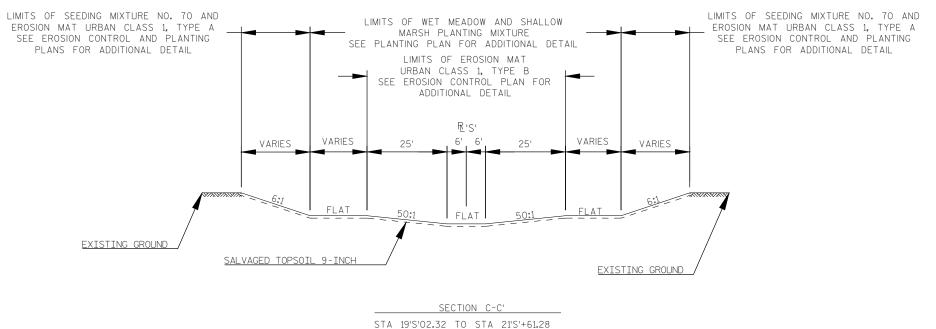

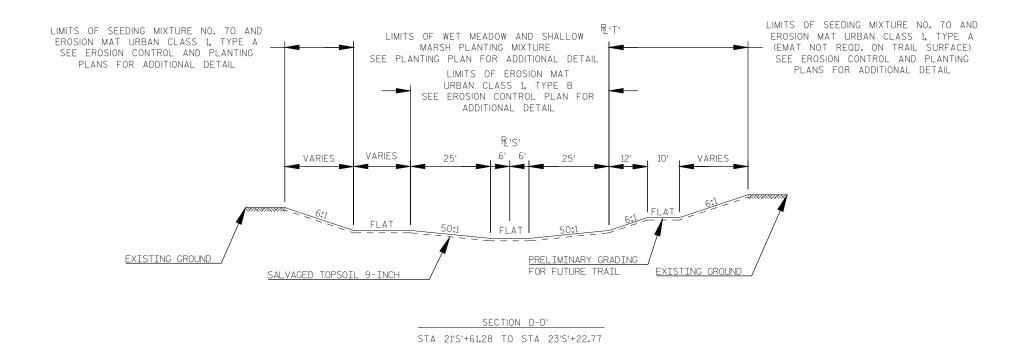

PROJECT NO: 1517-07-83

PLOT DATE : 1/22/2015 11:41 AM

COUNTY: WINNEBAGO


CONSTRUCTION DETAILS

PLOT BY : CHAD KWIATKOWSKI PLOT NAME : _____PLOT SCALE : 1IN:30FT


WISDOT/CADDS SHEET 42

SHEET


HWY: STH 441/USH 10

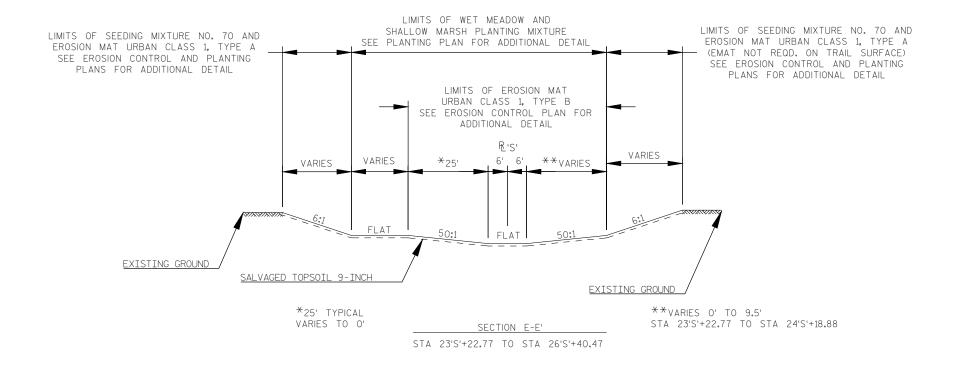


COUNTY: WINNEBAGO PROJECT NO: 1517-07-83 SHEET HWY: STH 441/USH 41 CONSTRUCTION DETAILS

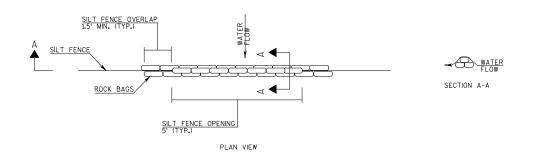


SILT FENCE RELIEF WITH ROCK BAGS

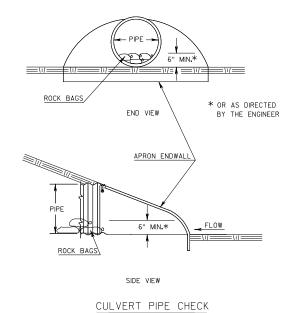


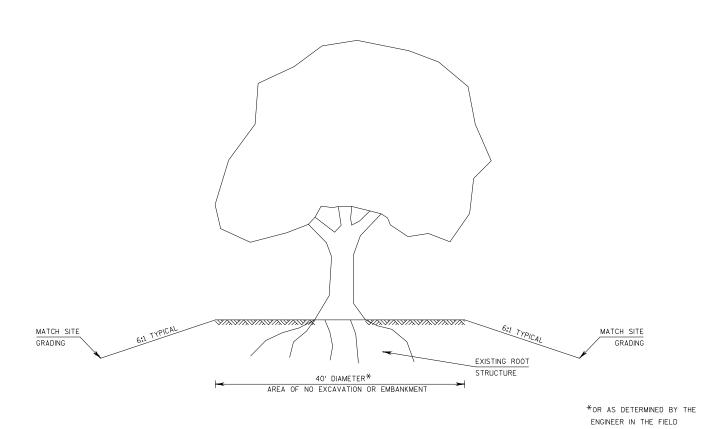



GRADING DETAIL AROUND TREES TO REMAIN


PROJECT NO:1517-07-83 HWY: STH 441/USH 10 COUNTY: WINNEBAGO CONSTRUCTION DETAILS

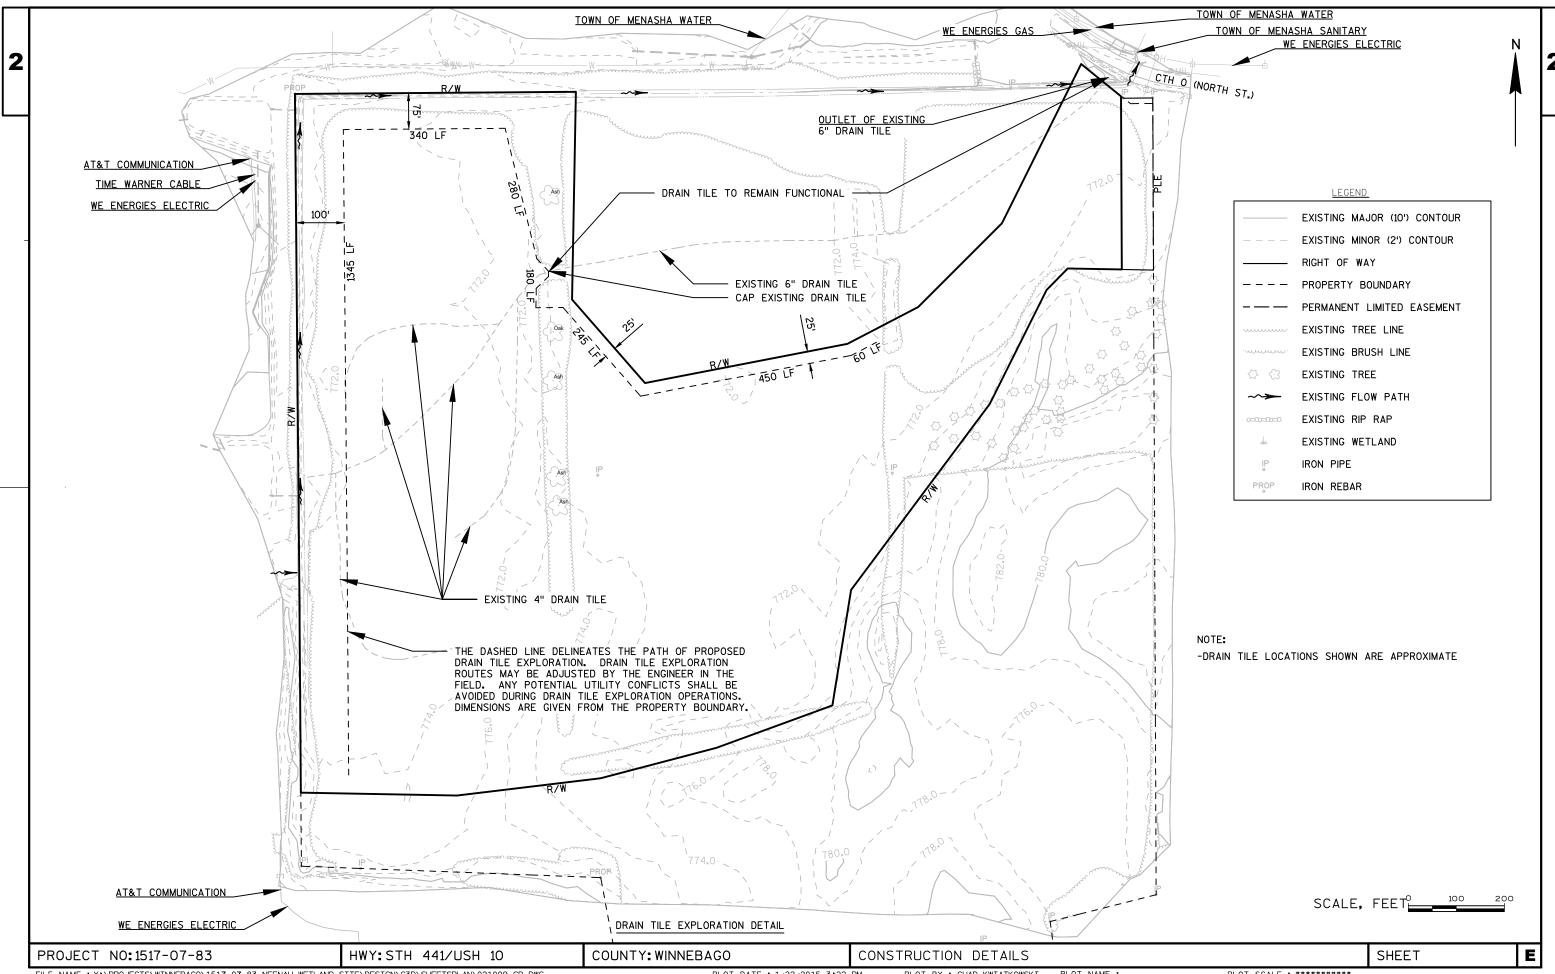


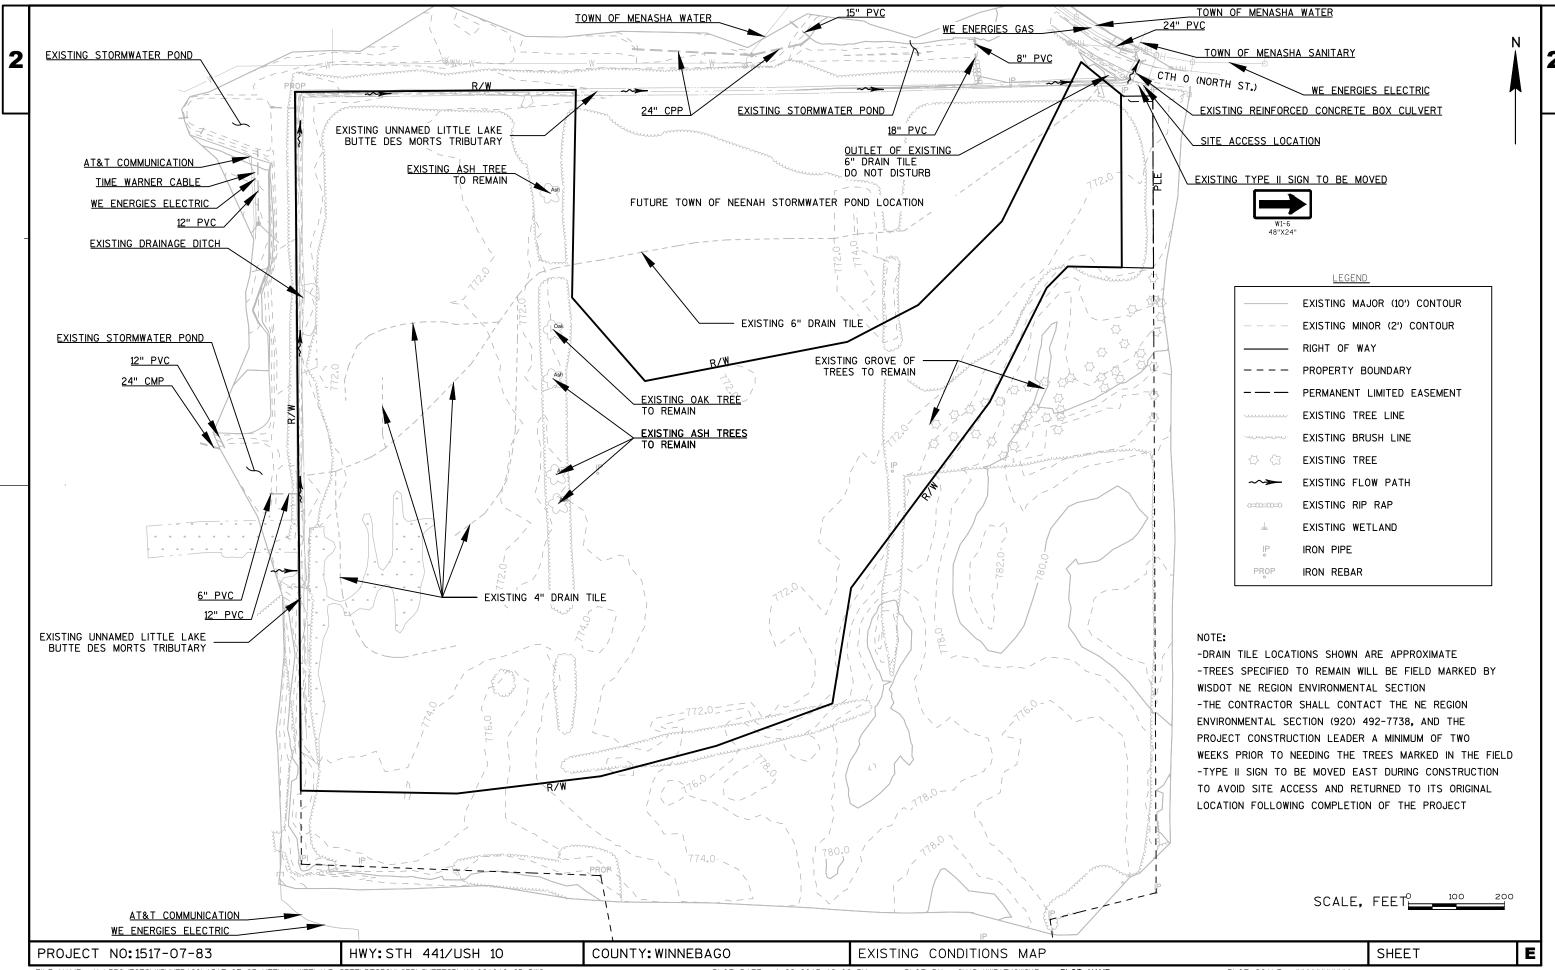


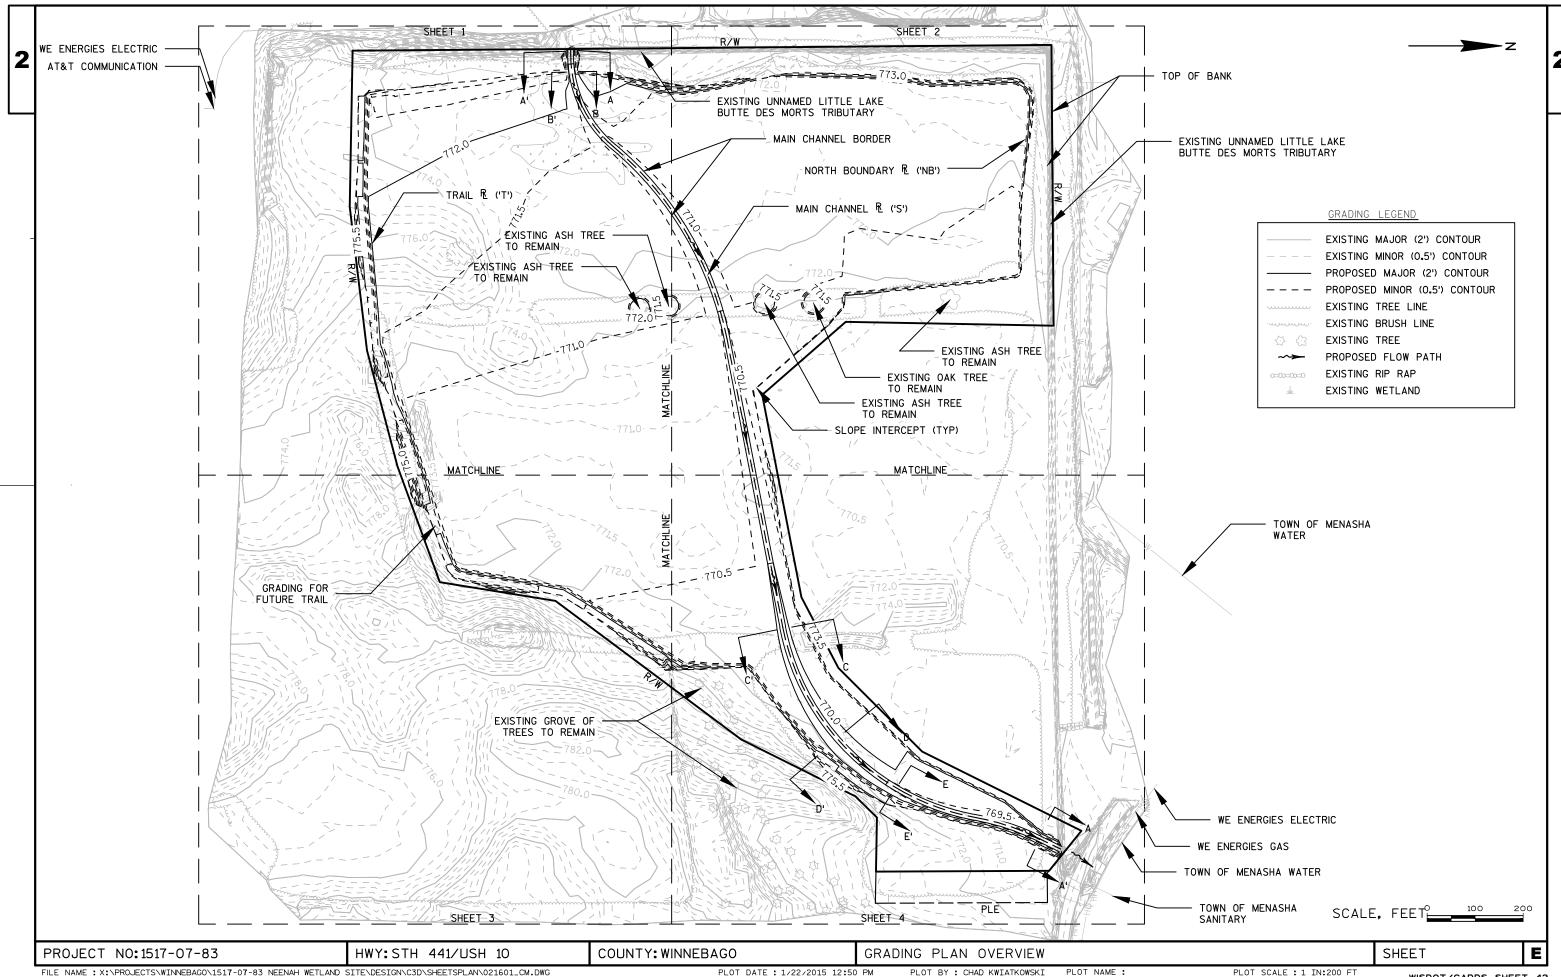


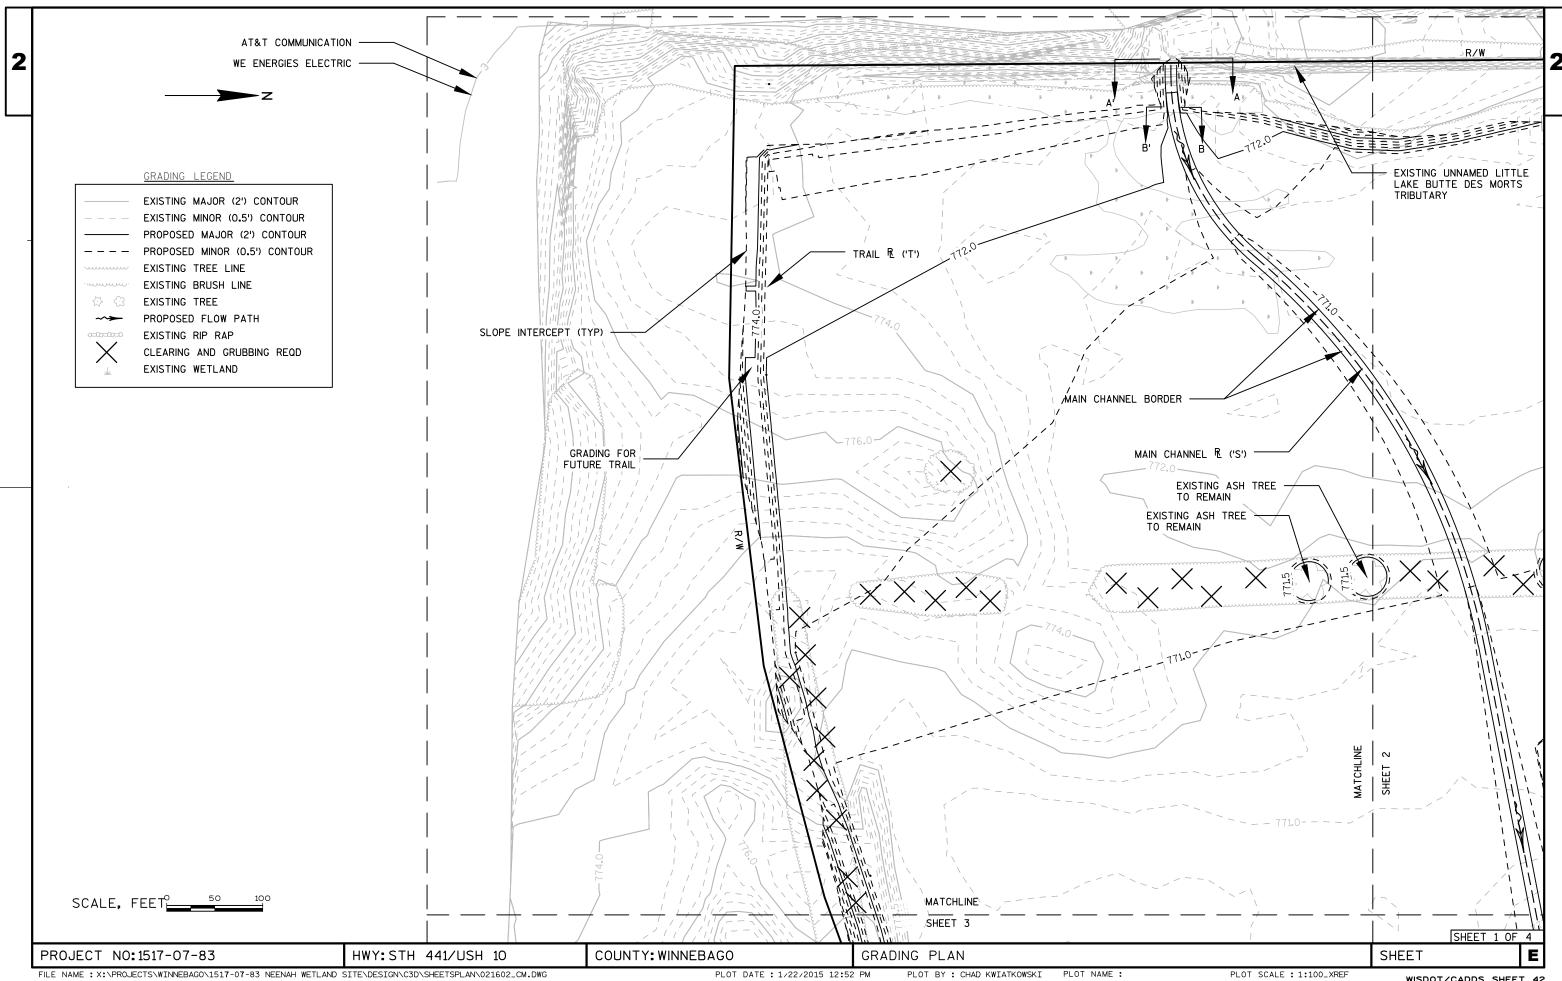


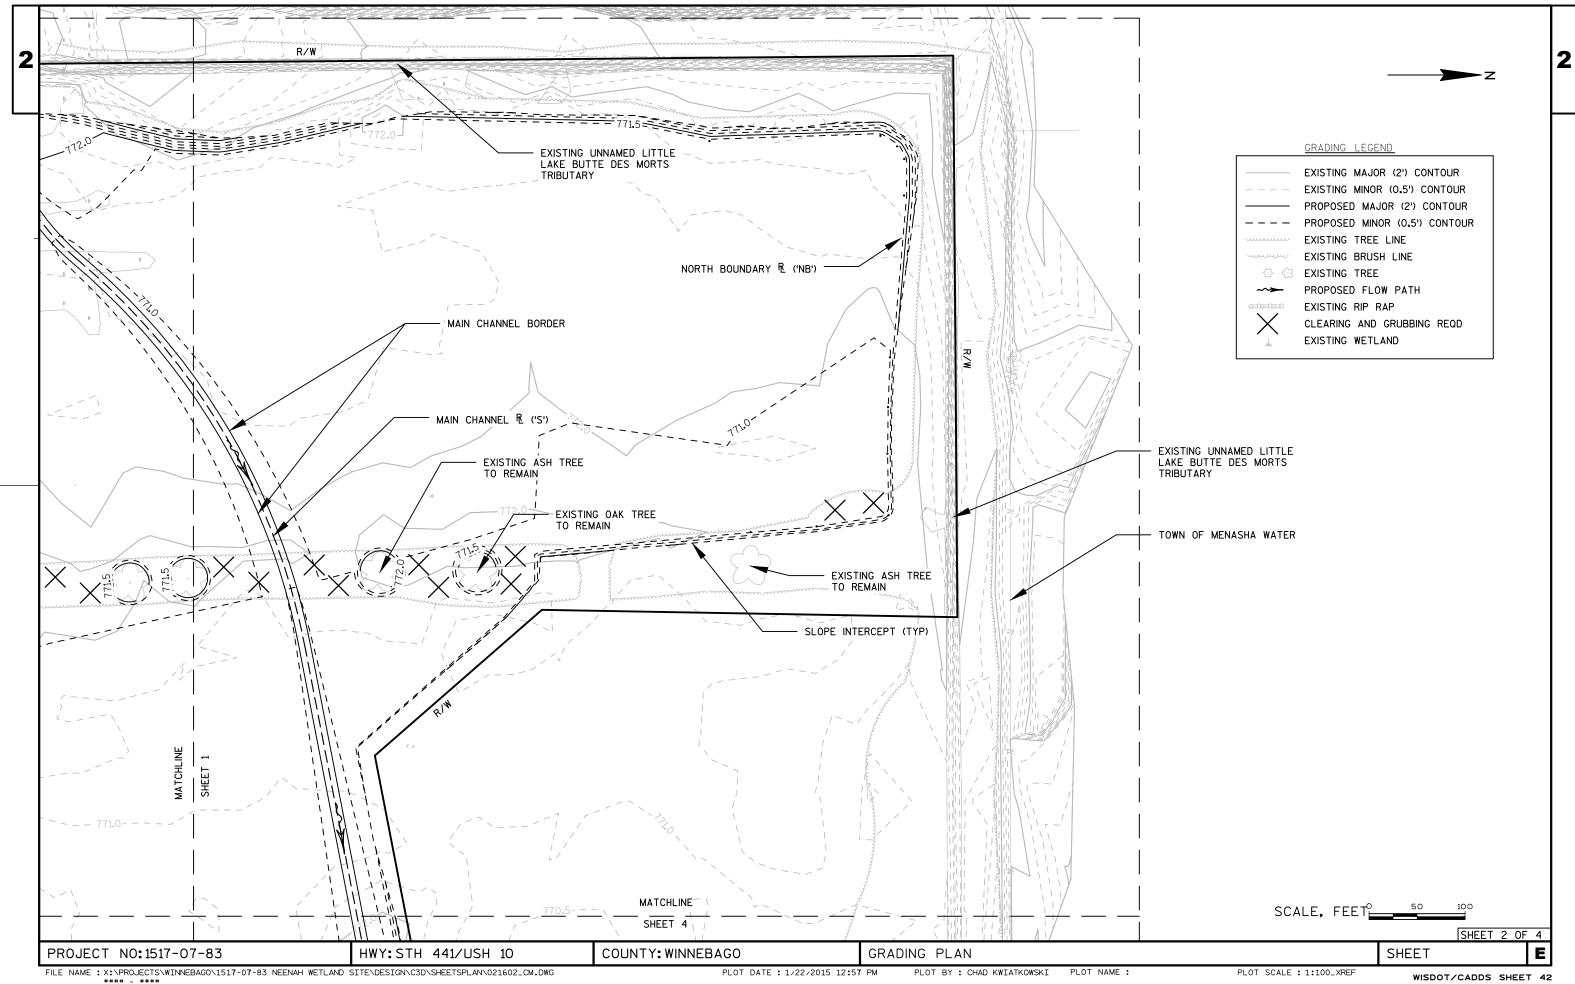


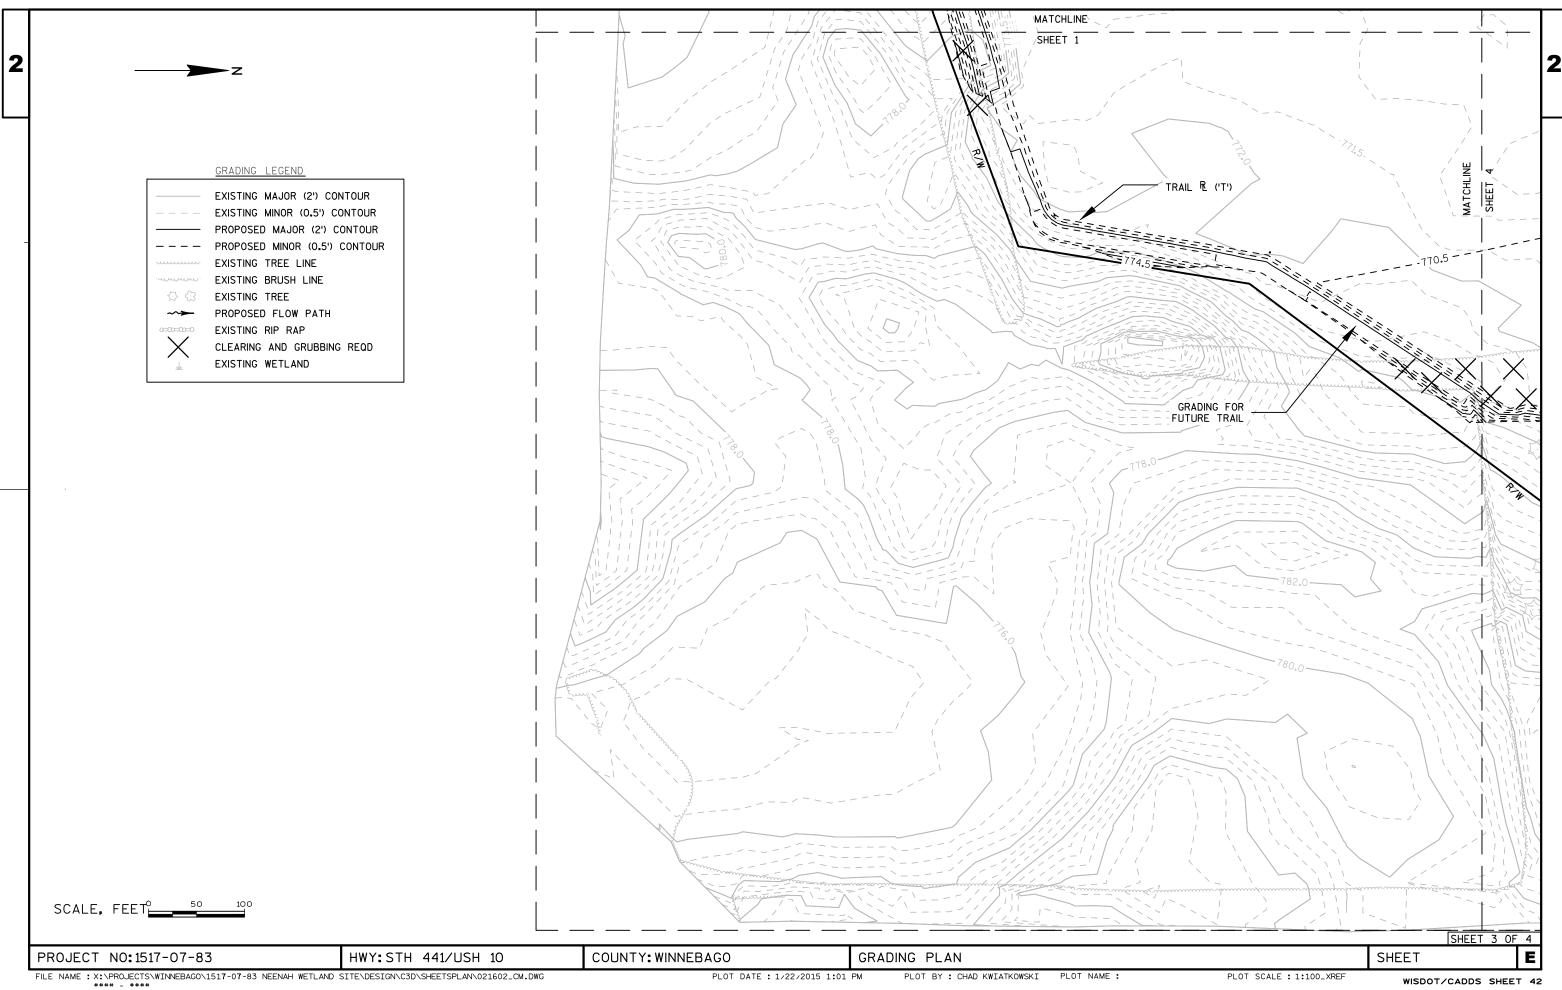


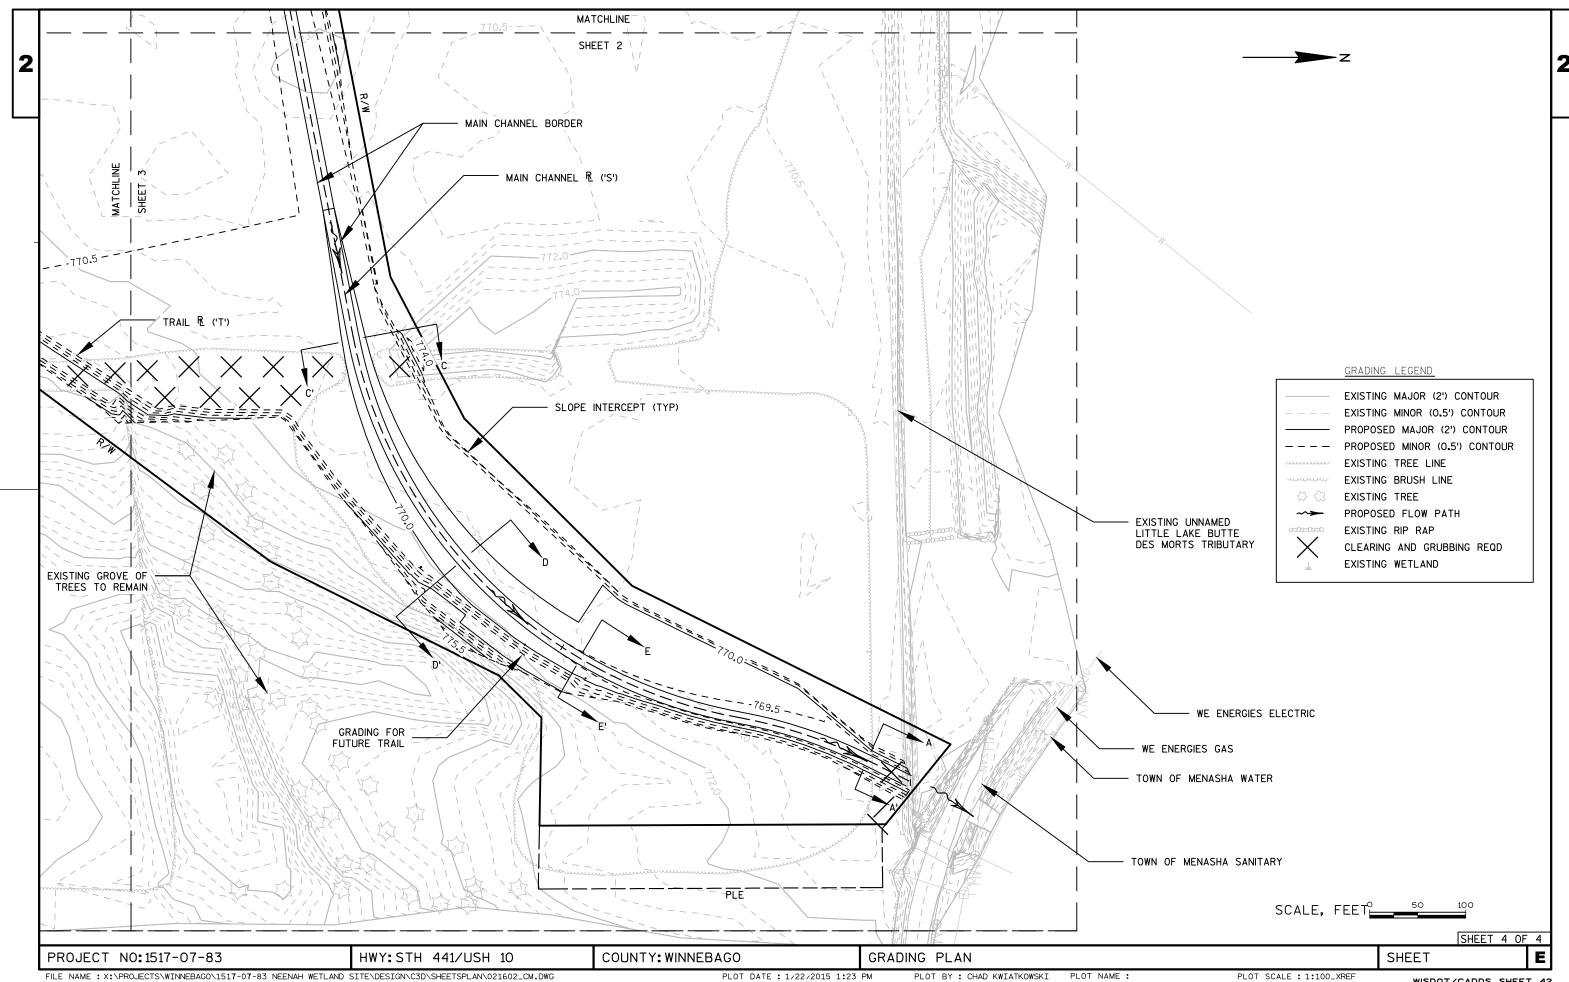


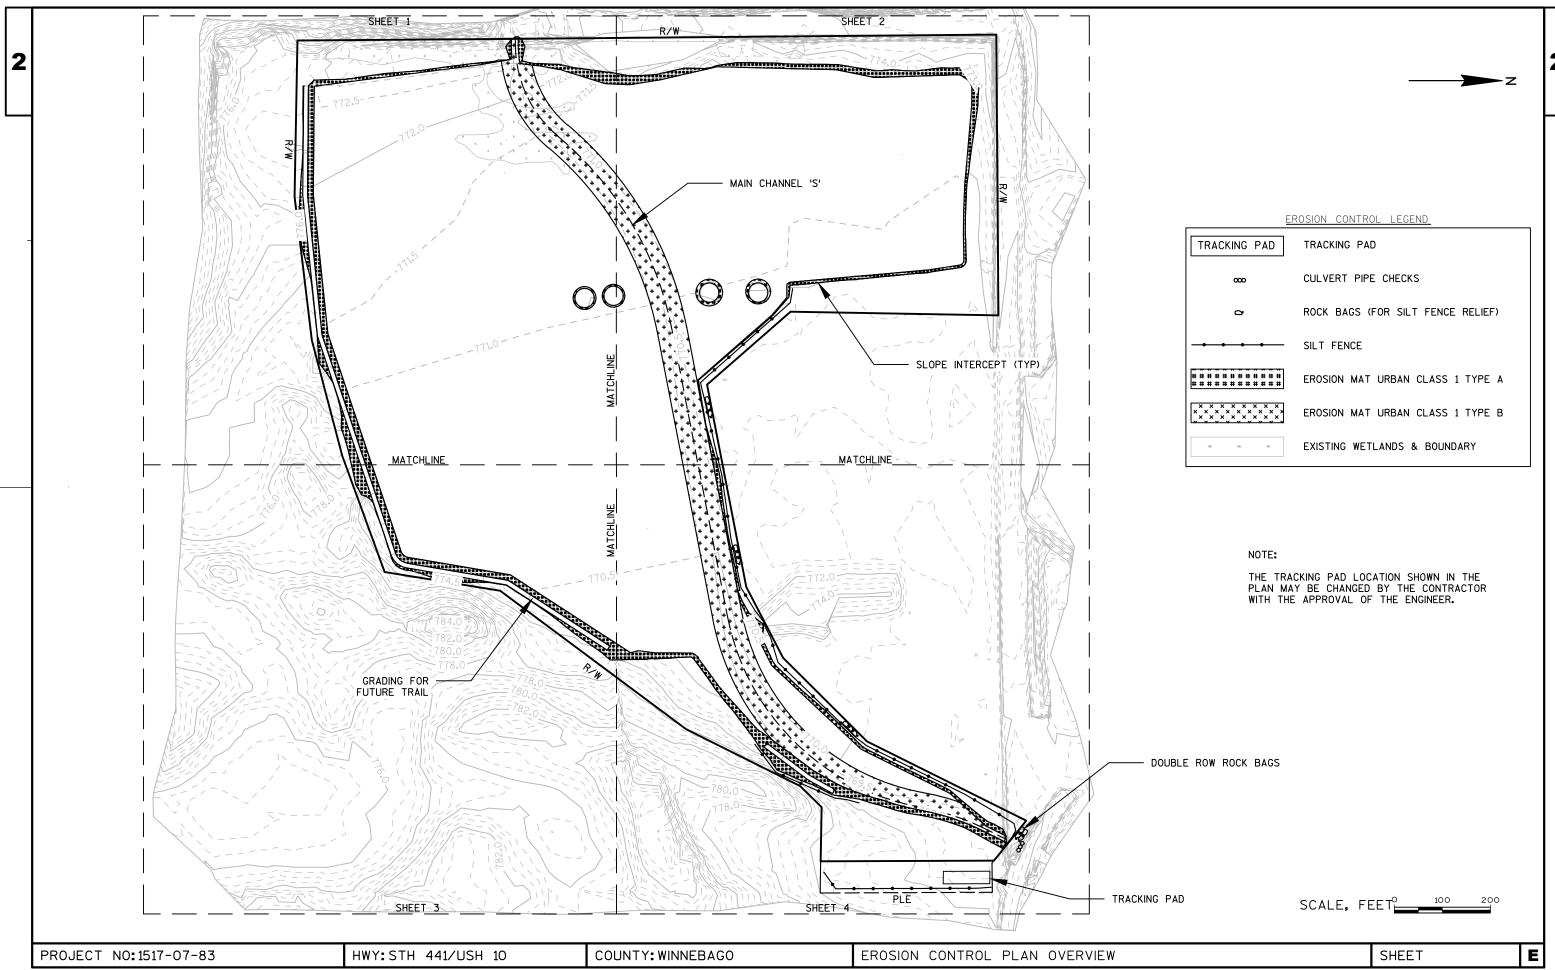


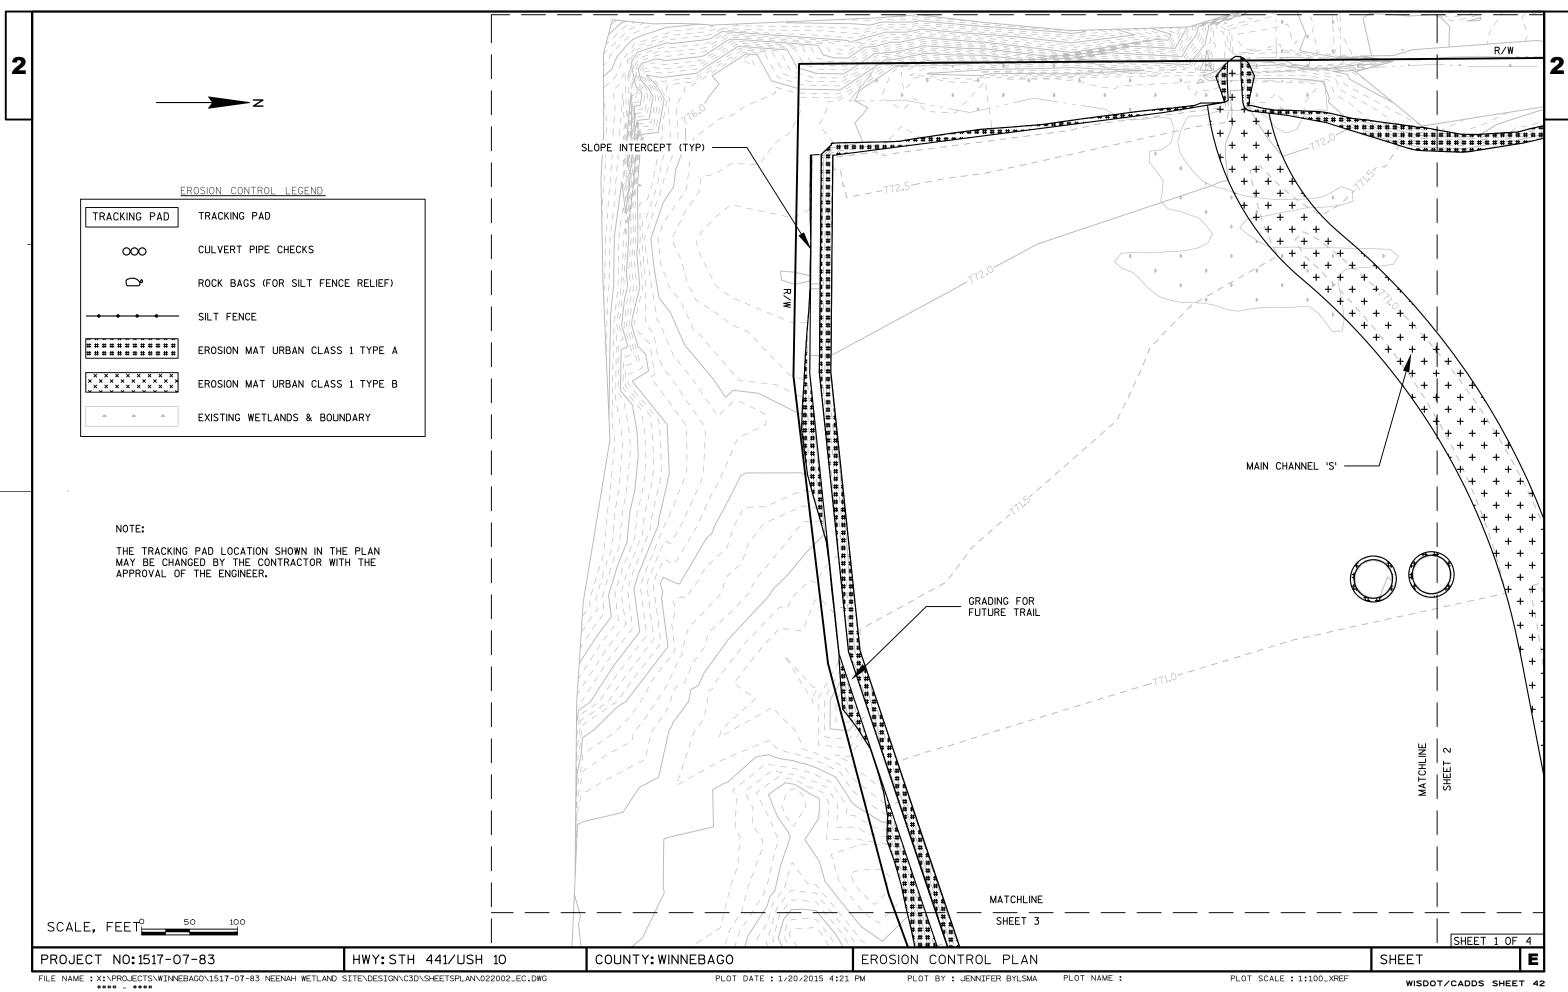


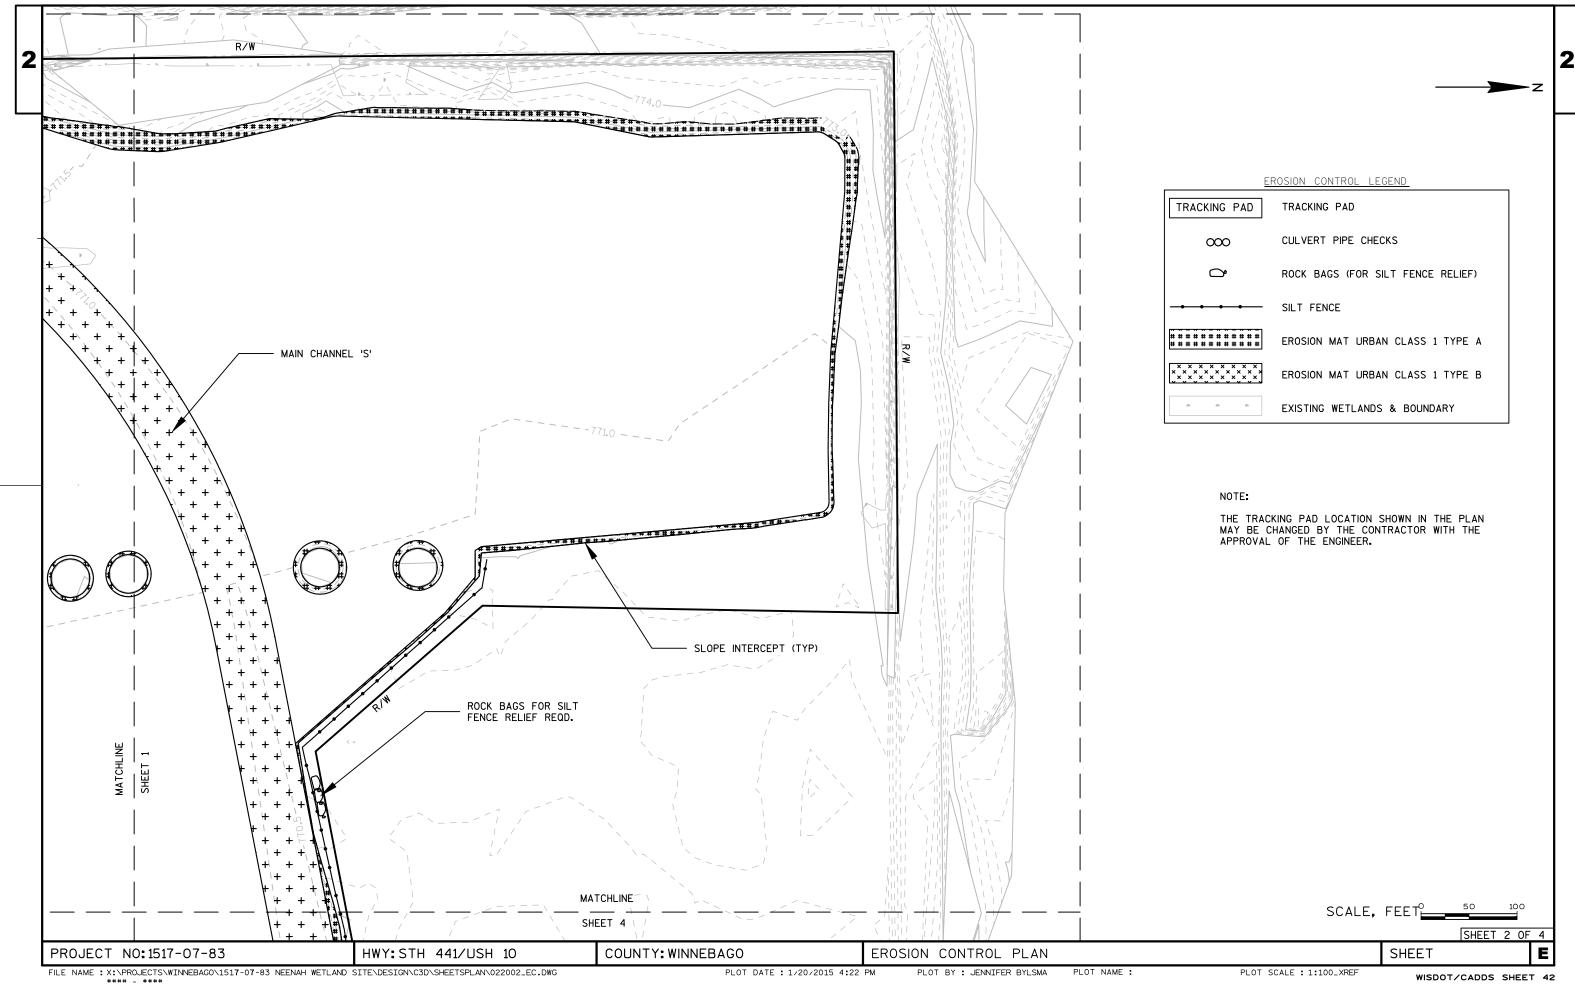


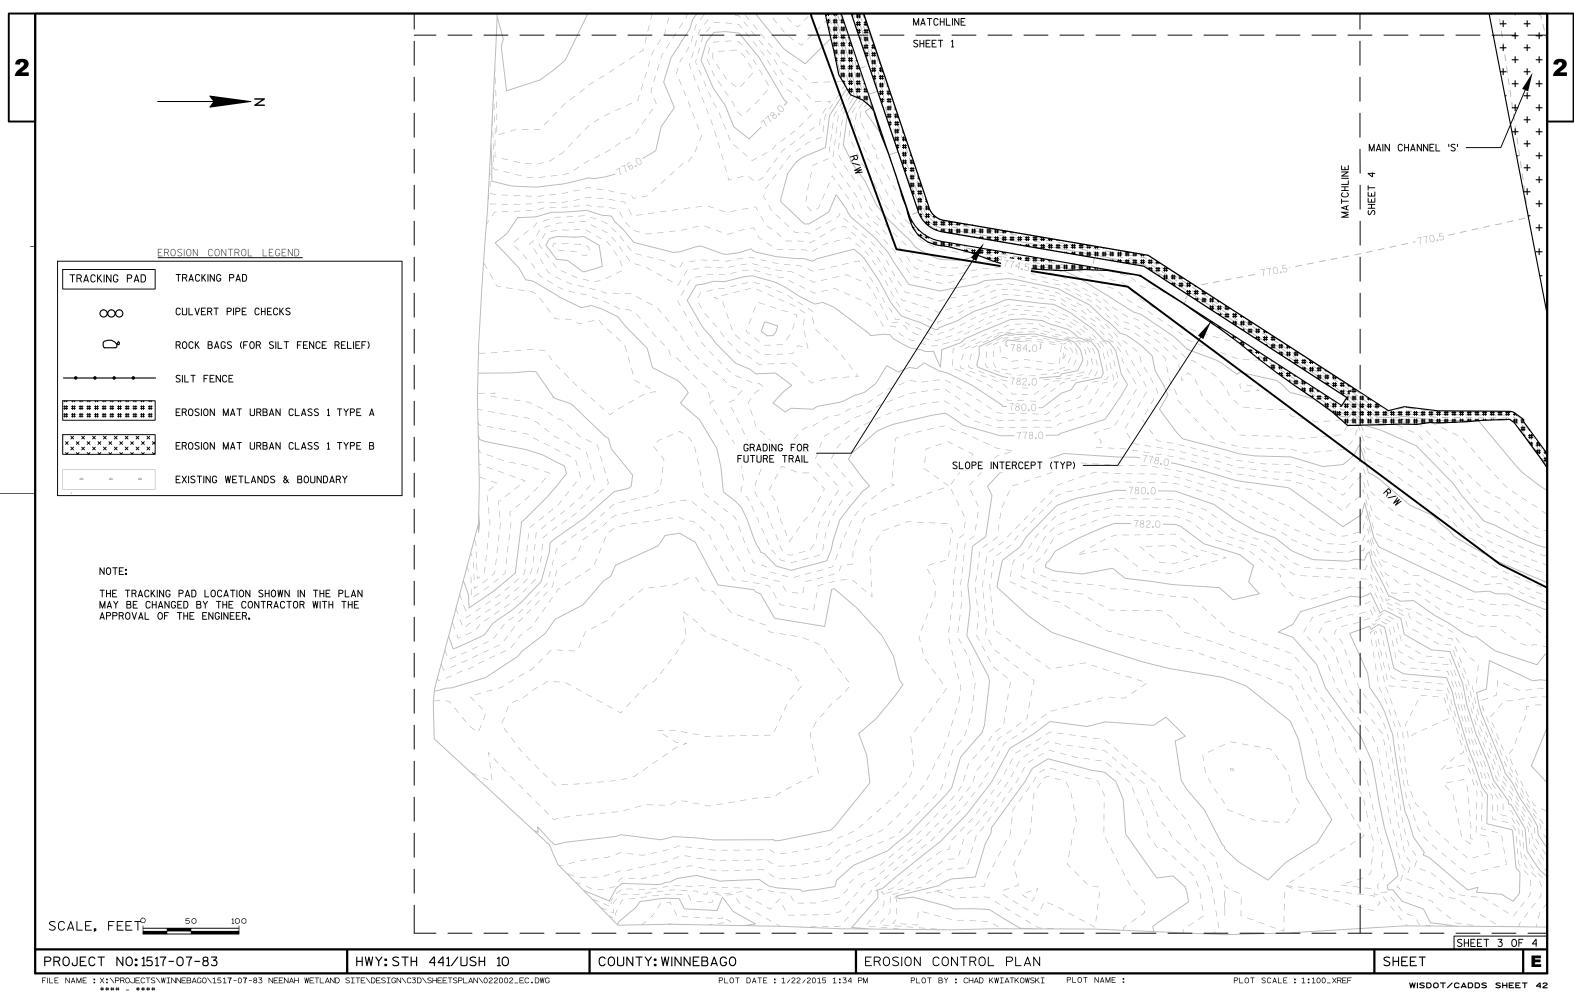


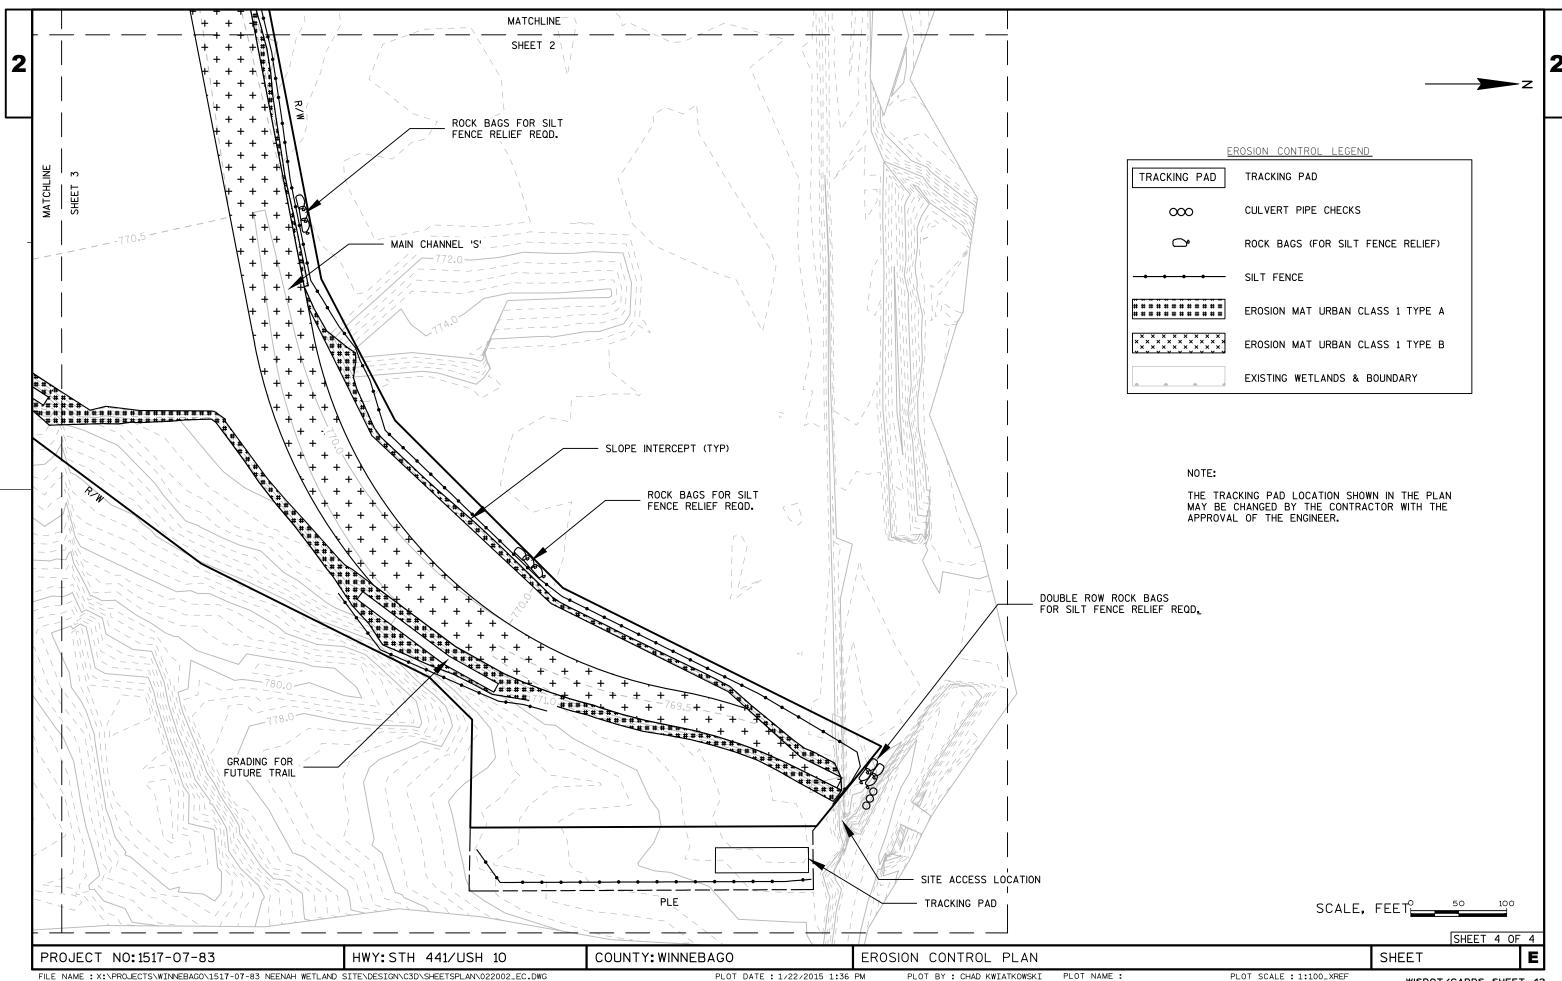


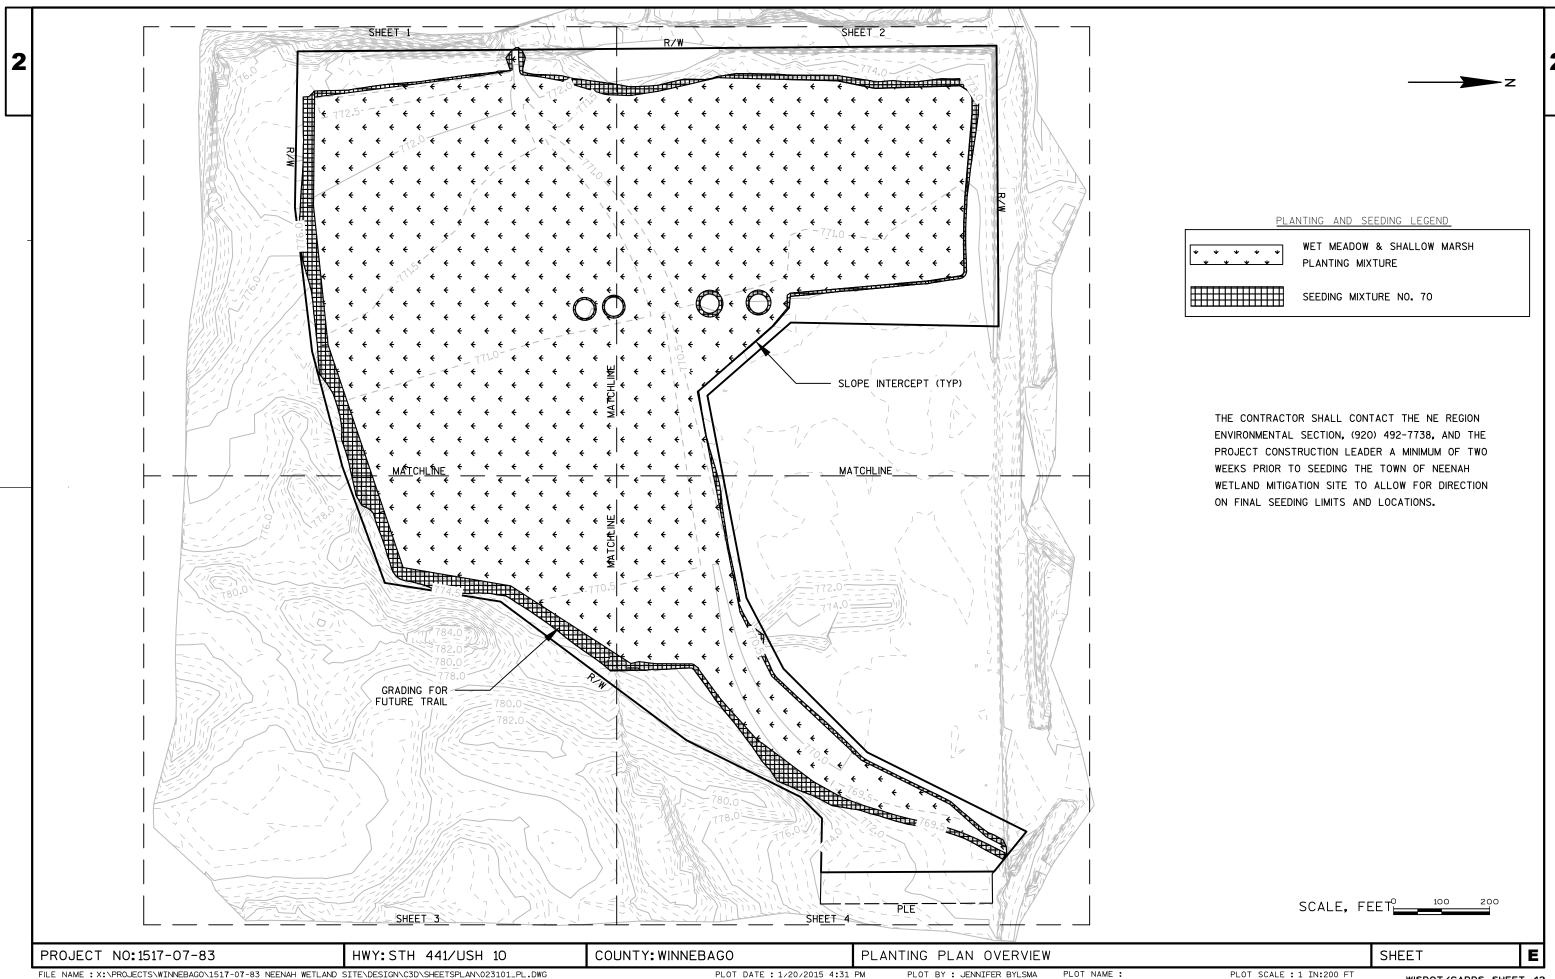

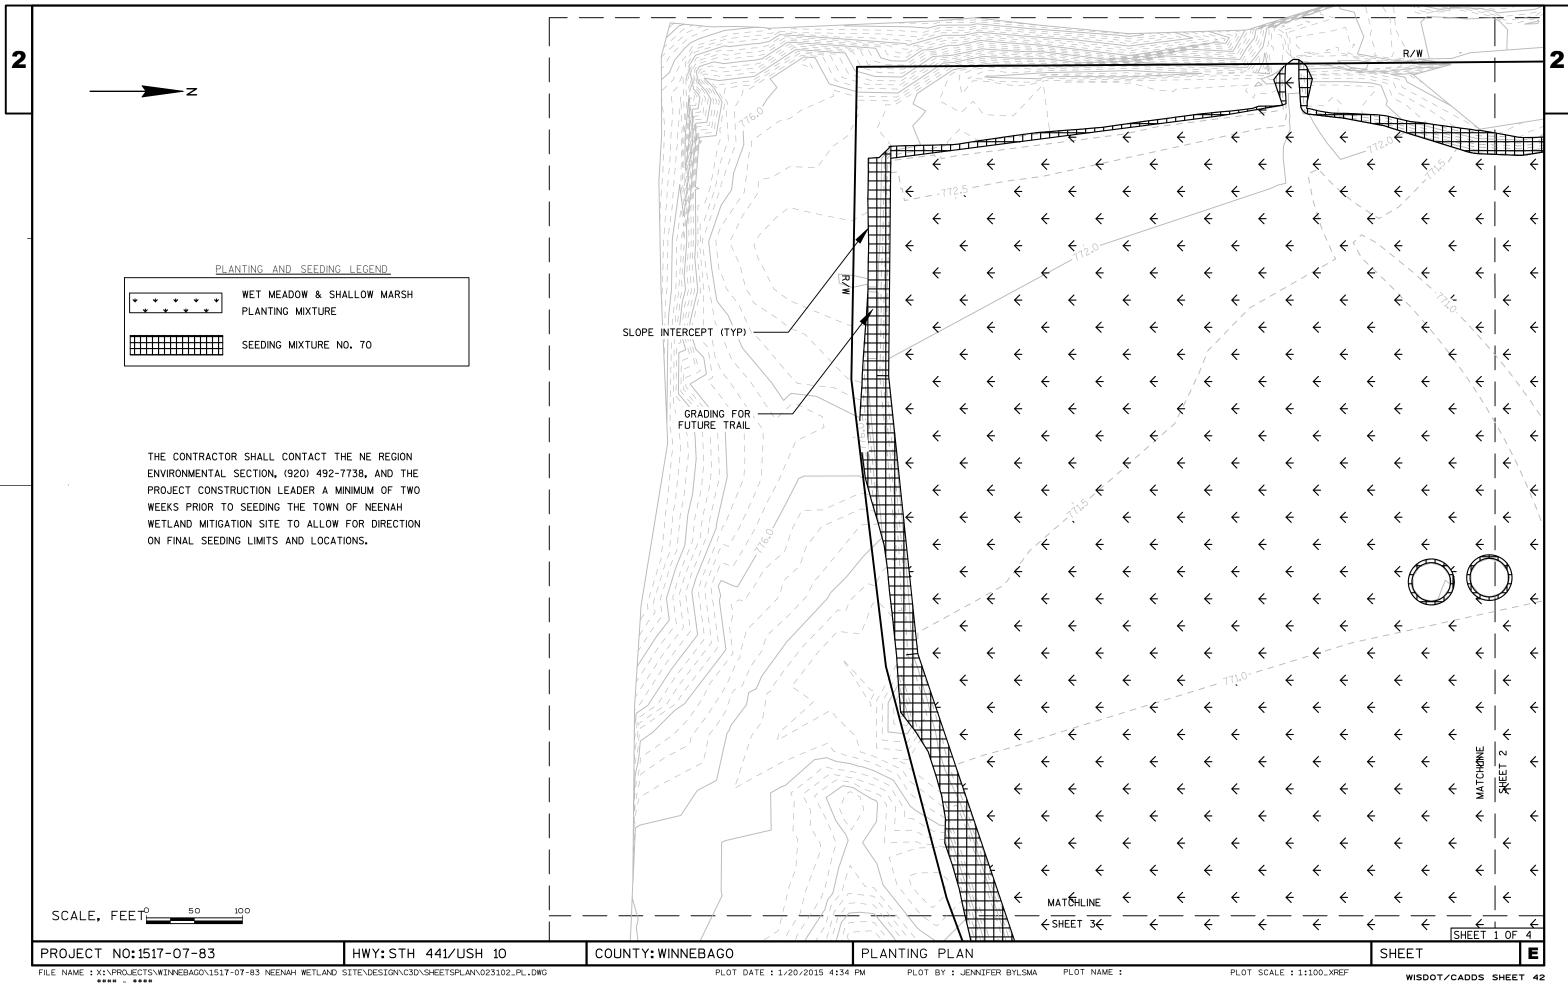

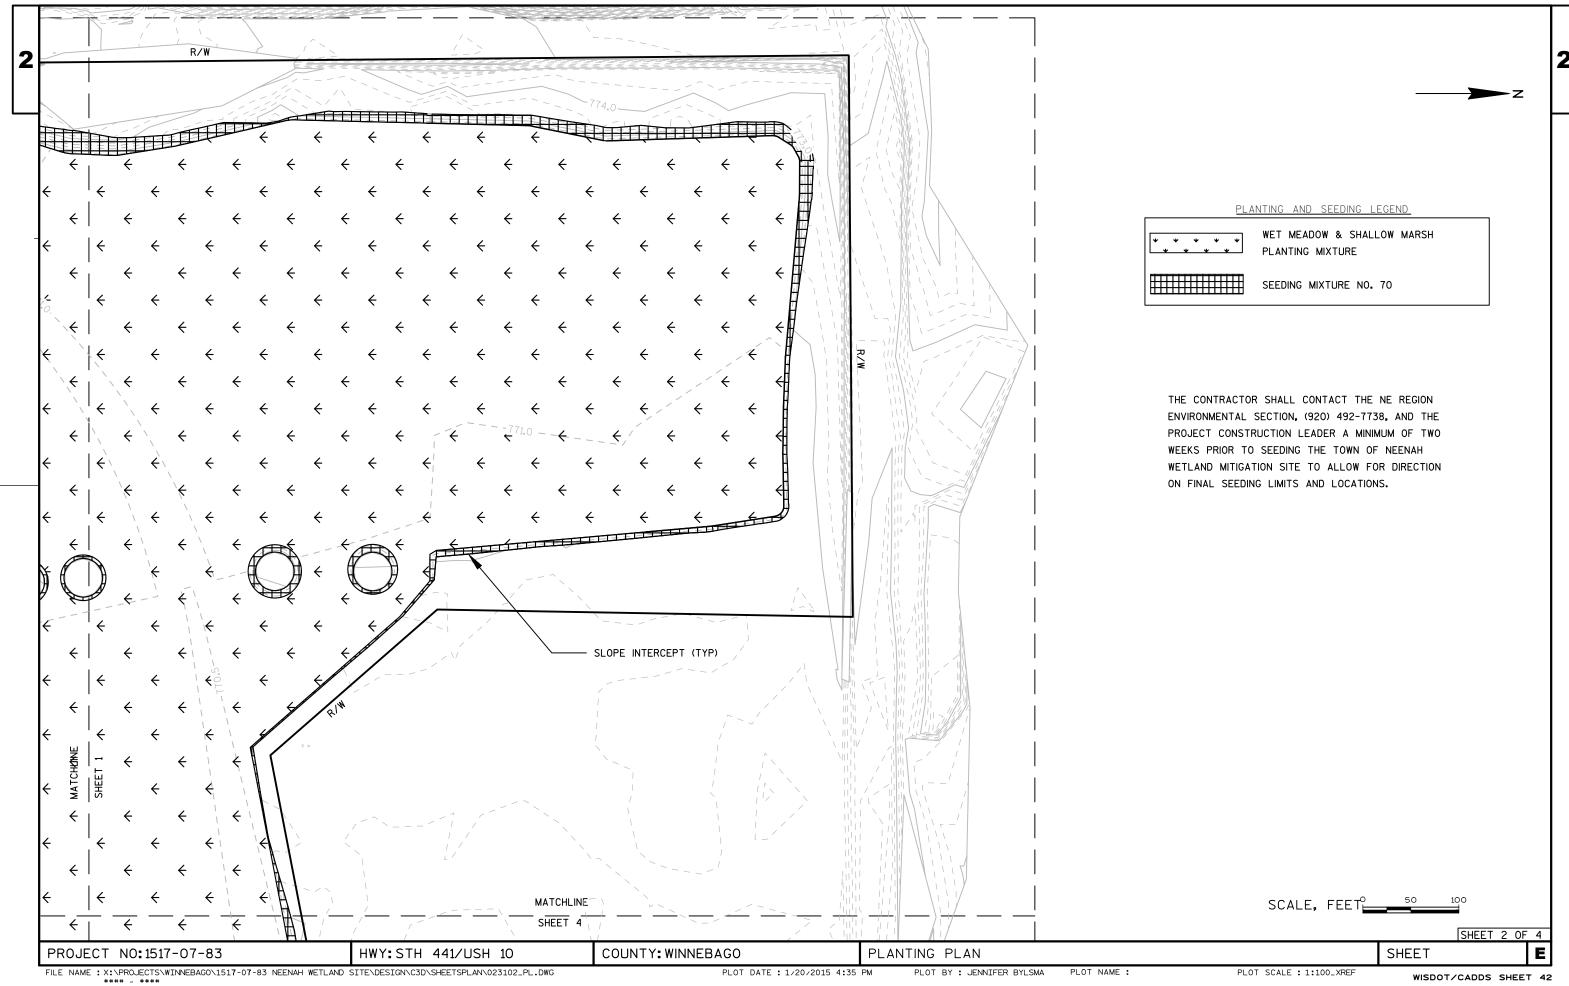


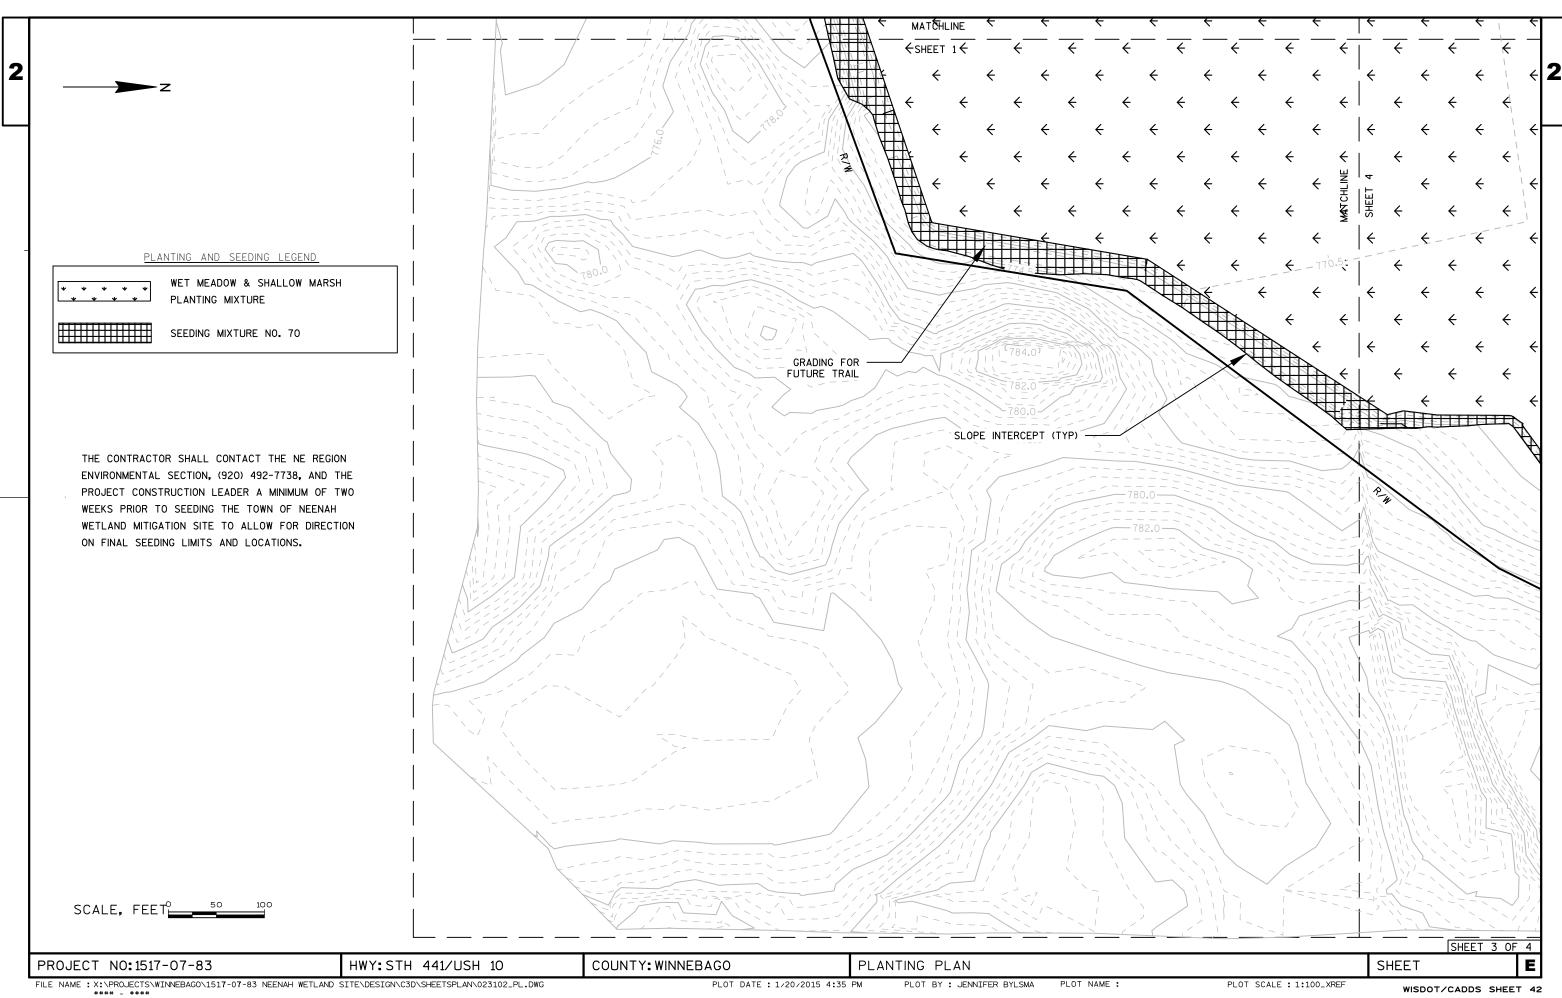


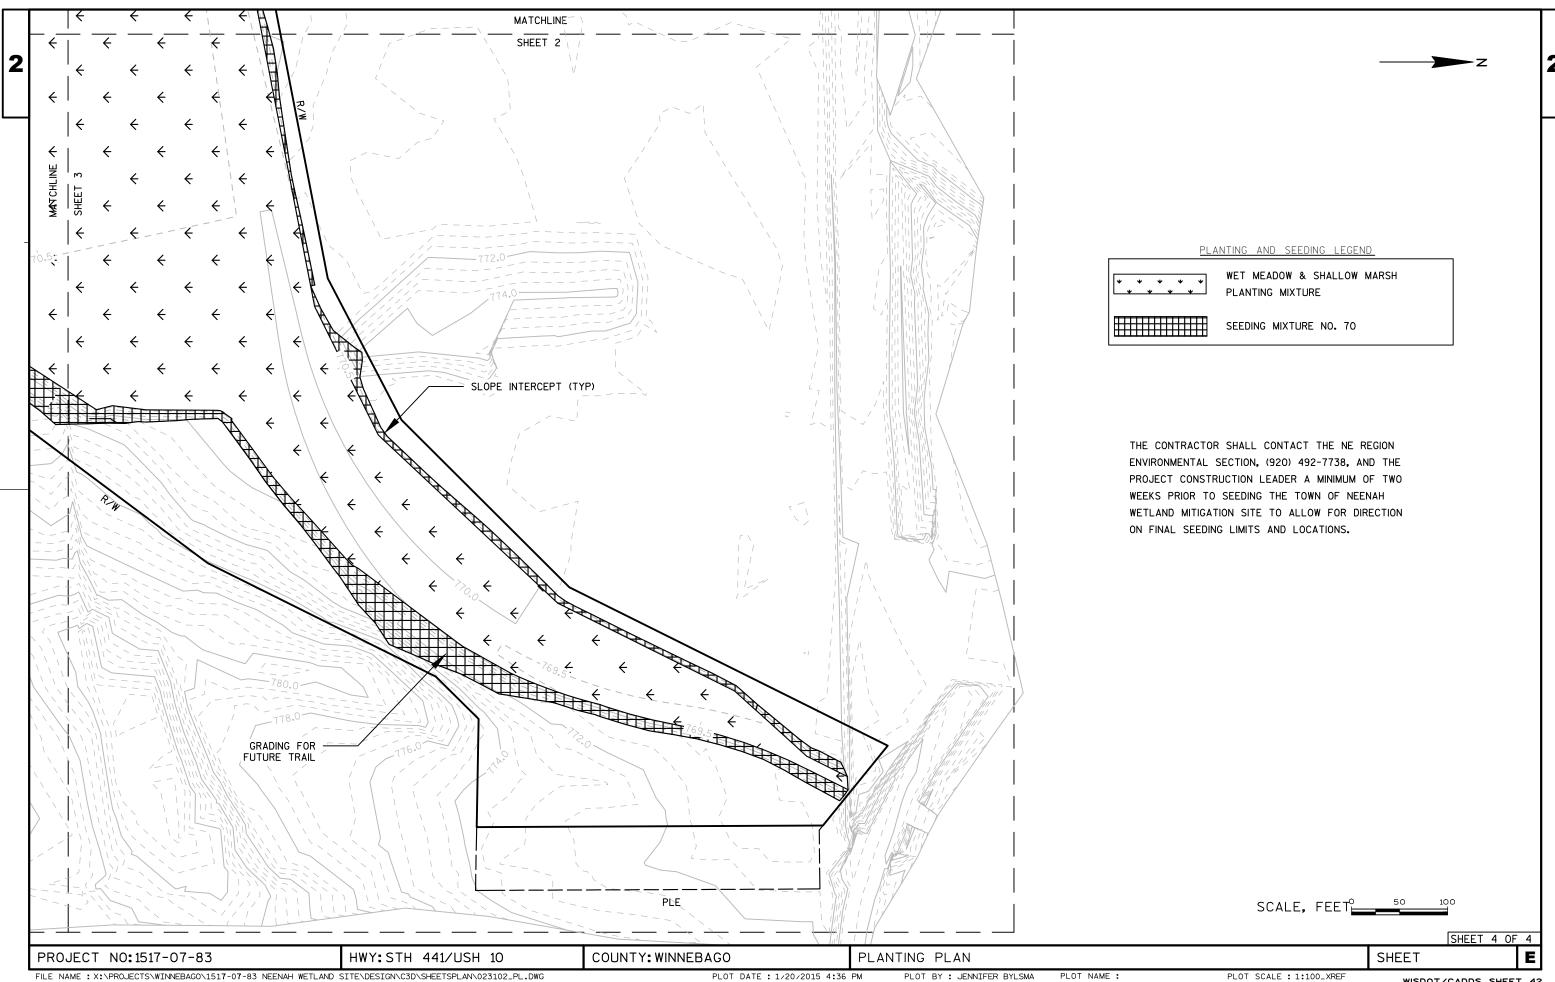

FILE NAME : X:\PROJECTS\WINNEBAGO\1517-07-83 NEENAH WETLAND SITE\DESIGN\C3D\SHEETSPLAN\023102_PL.DWG

PLOT SCALE : 1:100_XREF

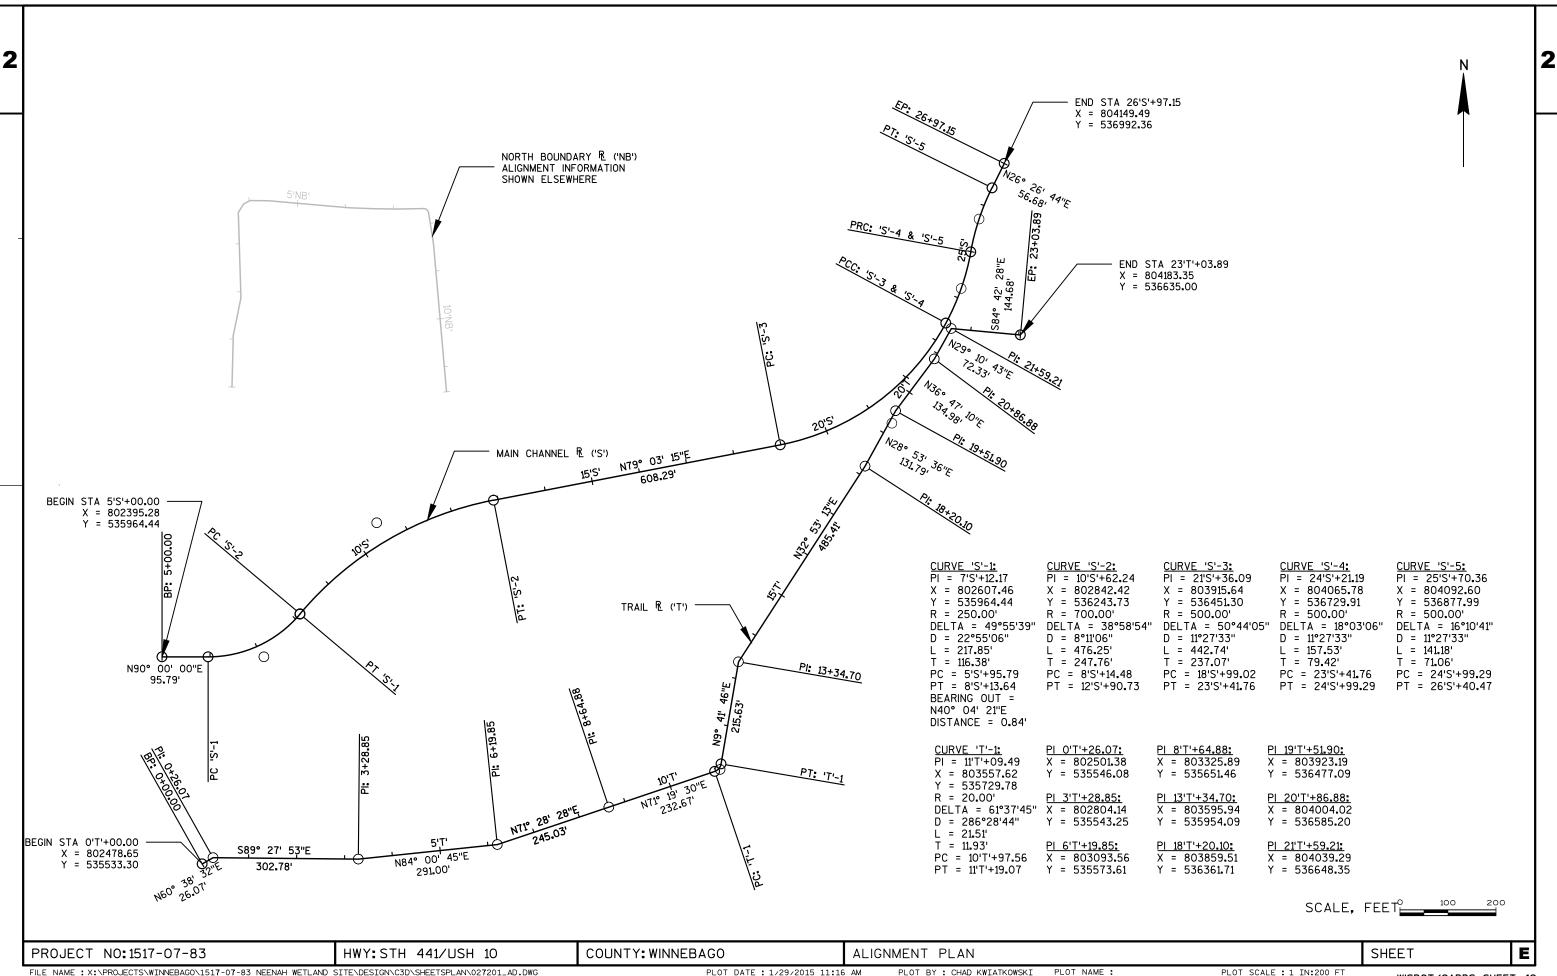

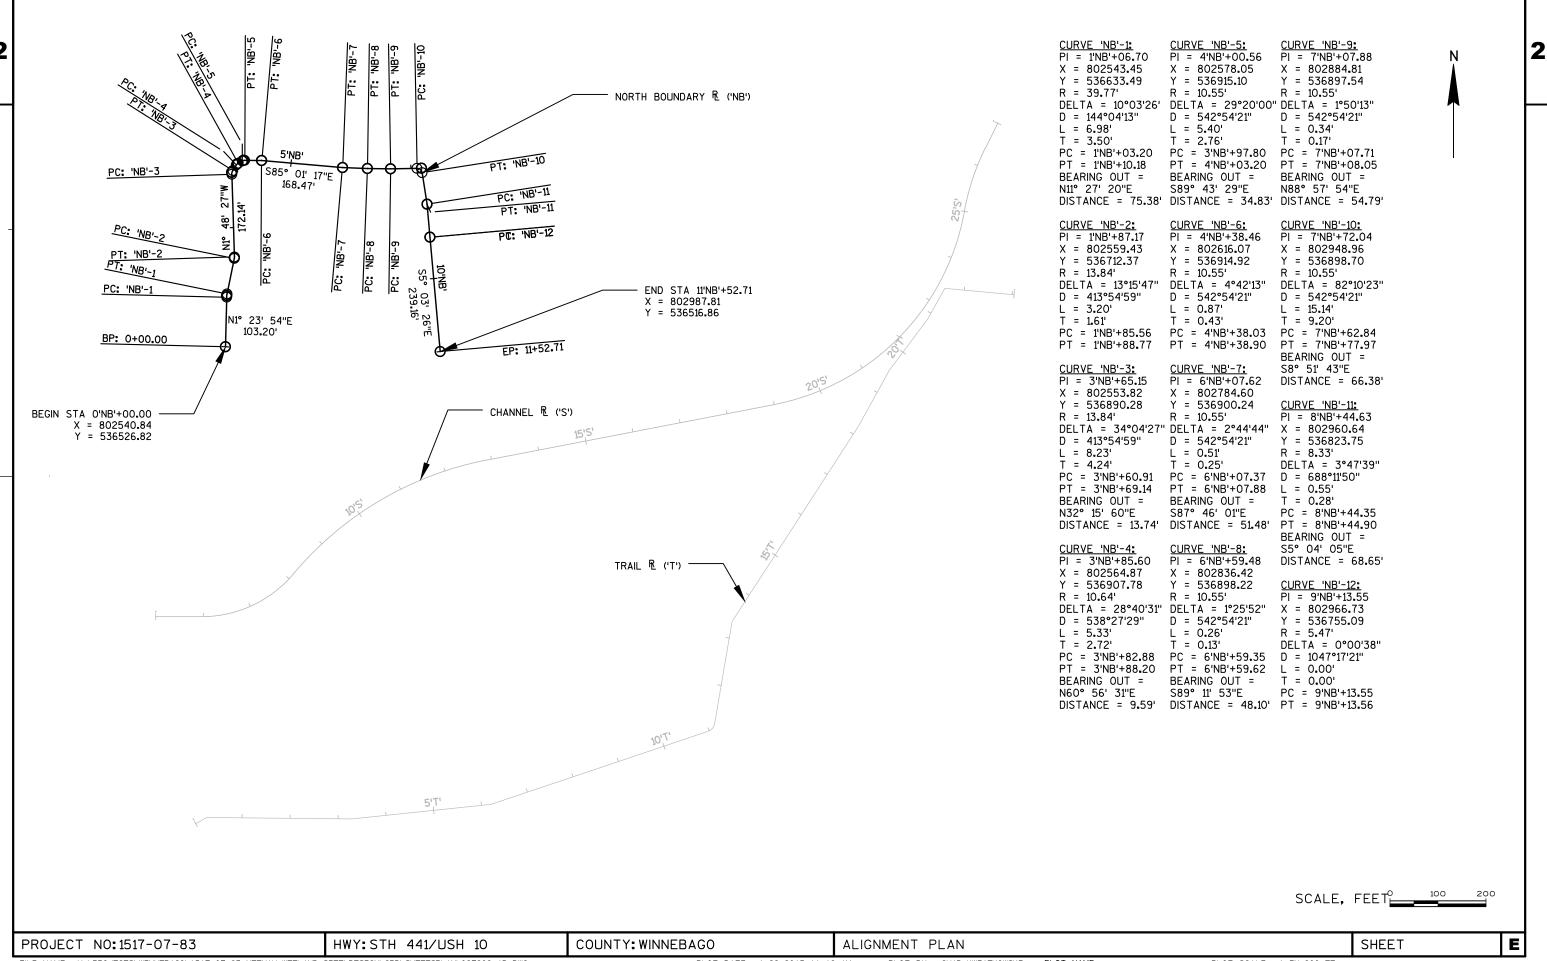

DATE 29	APR15	EST	IMAT	E O F Q U A I	
LI NE NUMBER	ITEM	ITEM DESCRIPTION	UNI T	TOTAL	1517-07-83 QUANTI TY
0010	201. 0115	Clearing	ACRE	1. 800	1. 800
0020	201. 0215	Grubbi ng	ACRE	1. 800	1. 800
0030	205. 0100	Excavation Common	CY	52, 920. 000	52, 920. 000
0040	213.0100	Finishing Roadway (project) 001.	EACH	1.000	1. 000
		1517-07-83			
0050	612. 0700	Drain Tile Exploration	LF	2, 900. 000	2, 900. 000
0060	618. 0100	Maintenance And Repair of Haul Roads (project) 001. 1517-07-83	EACH	1. 000	1. 000
0070	619. 1000	Mobilization	EACH	1.000	1. 000
0800	624. 0100	Water	MGAL	50. 000	50. 000
0090	625. 0500	Sal vaged Topsoi I	SY	330. 000	330. 000
0100	627. 0200	Mul chi ng	SY	19, 000. 000	19, 000. 000
0100	027.0200	war chi ng	31	19,000.000	17, 000. 000
0110	628. 1504	Silt Fence	LF	2, 400. 000	2, 400. 000
0120	628. 1520	Silt Fence Maintenance	LF	2, 400. 000	2, 400. 000
0130	628. 1905	Mobilizations Erosion Control	EACH	2.000	2. 000
0140	628. 1910	Mobilizations Emergency Erosion Control	EACH	3.000	3. 000
0150	628. 2006	Erosion Mat Urban Člass I Type A	SY	8, 350. 000	8, 350. 000
0160	628. 2008	Erosion Mat Urban Class I Type B	SY	13, 550. 000	13, 550. 000
0170	628. 7555	Cul vert Pi pe Checks	EACH	30. 000	30. 000
0180	628. 7560	Tracki ng Pads	EACH	1. 000	1. 000
0190	628. 7570	Rock Bags	EACH	190. 000	190. 000
0200	629. 0210	Fertilizer Type B	CWT	13. 000	13. 000
0210	630. 0110	Seeding Mixture No. 10	LB	130. 000	130. 000
0220	630. 0170	Seeding Mixture No. 70	LB	38. 000	38. 000
0230	634.0410	Posts Wood 4x4-Inch X 10-FT	EACH	1.000	1.000
0240	638. 2102	Moving Signs Type II	EACH	2.000	2.000
0250	638. 3000	Removing Small Sign Supports	EACH	1. 000	1. 000
0260	638. 4000	Moving Small Sign Supports	EACH	1.000	1.000
0270	642. 5201	Field Office Type C	EACH	1. 000	1. 000
0280	643. 0100	Traffic Control (project) 001. 1517-07-83	EACH	1.000	1. 000
0290	643.0420	Traffic Control Barricades Type III	DAY	134.000	134.000
0300	643. 0705	Traffic Control Warning Lights Type A	DAY	268. 000	268. 000
0310	643. 0900	Traffic Control Signs	DAY	335.000	335.000
0320	ASP. 1TOA	On-the-Job Training Apprentice at \$5.	HRS	1, 200. 000	1, 200. 000
0330	ASP. 1TOG	00/HR On-the-Job Training Graduate at \$5.00/HR	HRS	600. 000	600. 000
	SPV. 0085		HRS LB	235. 000	235. 000
0340	3PV. 0085	Special 150. Seeding, Wet Meadow And Shallow Marsh Mix	LB	∠35.000	∠35. 000
0350	SPV. 0105	Special 001. Survey Project 1517-07-83	LS	1. 000	1. 000
0360	SPV. 0180	Special 150. Salvaged Topsoil 9-Inch	SY	145, 500. 000	145, 500. 000
		3		,	

CLEARING AND GRUBBING										
	201. 0120	201. 0220								
	CLEARI NG	GRUBBI NG								
LOCATI ON	ACRE	ACRE	REMARKS							
TOWN OF NEENAH MITIGATION SITE	1. 8	1. 8								
TOTALS	1.8	1.8								

EARTHWORK SUMMARY

Division	Location	Excavation (05.0100	Salvaged/ Unusable Material	Available Material (4)	Unexpanded Fill	Expanded Fill (5)	Mass Ordinate +/- (6)	Waste	Comment:
		Cut (2)	EBS Excavation (3)				Factor 1.20			
	CHANNEL ALIGNMENT ('S')	52,920	0	0	52,920	70	84	52,836		
Total		52,920	0	0	52,920	70	84	52,836	52,836	
		Total Common Ex	52,920		_				_	

- 1) Excavation Common is the sum of the Cut and EBS Excavation columns. Item number 205.0100
- 2) Salvaged/Unsuable Material is included in Cut.
- 4) Available Material = Cut Salvaged/Unusuable Material
- 5) Expanded Fill Factor = 1.20. Expanded Fill = Unexpanded Fill * Fill Factor. No Rock, Marsh, or EBS will be used in fill on this project.
- 6) The Mass Ordinate + or Qty calculated for the Division. Plus quantity indicates an excess of material within the Division. Minus indicates a shortage of material within the Division.

DRAIN TILE EXPLORATION									
	612. 0700								
LOCATI ON	LF	REMARKS							
TOWN OF NEENAH MITIGATION SITE	2, 900								
TOTALS	2, 900	•							

	WATER	
	624. 0100	
LOCATI ON	MGAL	REMARKS
TOWN OF NEENAH MITIGATION SITE	50	FOR DUST CONTROL
TOTALS	50	

EROSI ON CONTROL SUMMARY										
	627. 02	628. 1504	628. 1520	628. 2006	628. 2008	628. 7555	628. 7560	*675. 7570		
	MULCHI NG	SILT	SILT	EROSION MAT	EROSION MAT	CULVERT	TRACKI NG	ROCK		
		FENCE	FENCE	URBAN CLASS I	URBAN CLASS I	PI PE	PADS	BAGS		
			MAI NTENANCE	TYPE A	TYPE B	CHECKS				
LOCATI ON	SY	LF	LF	SY	SY	EACH	EACH		REMARKS	
TOWN OF NEENAH MITIGATION SITE		1, 900	1, 900	7, 950	12, 900	24	1	180		
SITE INGRESS/EGRESS	300									
PROJECT WASTE AREA	17800								UNDI STRI BUTED	
PROJECT	900	500	500	400	650	6		10	UNDI STRI BUTED	
_										
TOTALS	19, 000	2, 400	2, 400	8, 350	13, 550	30	1	190		
IVIALS	17,000	2, 400	2, 400	0, 330	13, 330	30	ı	170		

*ASSUMES 24" x 12" x 6" BAG SIZE

EROSI ON CONT	EROSION CONTROL MOBILIZATIONS										
	628. 1905	628. 1910									
	MOBI LI ZATI ON	MOBI LI ZATI ON									
	EROSI ON	EMERGENCY									
	CONTROL	EROSION CONTROL									
LOCATI ON	EACH	EACH									
TOWN OF NEENAH MITIGATION SITE	2	3									
TOTAL	2	3									


PROJECT N	O: 1517-07-83	HWY: STH 441/USH 10	COUNTY: WINNEBAGO	MISCELLANEOUS QUANTITIES	SHEET:	E
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	LANDSCAPI NG SUMMARY										
	625. 0500	629. 0210	630. 0110	630. 0170	SPV. 0085. 151	SPV. 0180. 150					
	SALVAGED	FERTI LI ZER	SEEDI NG	SEEDI NG	SEEDING, WET MEADOW	SALVAGED					
	TOPSOI L	TYPE B	MI XTURE	MI XTURE	AND SHALLOW	TOPSOI L					
			NO. 10	NO. 70	MARSH MIX	9-I NCH					
LOCATI ON	SY	CWT	LB	LB	LB	SY	REMARKS				
TOWN OF NEENAH MITIGATION SITE				36	220	138, 500					
SITE INGRESS/EGRESS	300	1	4								
PROJECT WASTE AREA		11	120				UNDI STRI BUTED				
PROJECT	30	1	6	2	15	7, 000	UNDI STRI BUTED				
TOTALS	330	13	130	38	235	145, 500	•				

		643. 0420		643. (0705	643.0	900	643. 0100	
		TRAFFIC CONTROL		TRAFFIC	CONTROL	L TRAFFIC CONTROL		TRAFFIC	
	APPROXI MATE	BARRI CADES	TYPE III	WARNING LIG	HTS TYPE A	SIG	NS	CONTROL	
	SERVI CE	NO. IN		NO. IN		NO. IN		PROJECT	
LOCATI ON	DAYS	SERVI CE	DAYS	SERVI CE	DAYS	SERVI CE	DAYS	EACH	REMARKS
CTH O SITE ACCESS POINT	67	2	134	4	268	5	335	1	
TOTALS			134		268		335	1	

SI GNI NG SUMMARY										
	634.0410 POSTS WOOD 4X4 - INCH X 10-FT	638.2102 MOVING SIGN TYPE II		638. 4000 MOVING SMALL SIGN SUPPORT						
LOCATI ON	EACH	EACH	EACH	EACH	REMARKS					
CTH O ACCESS POINT		1		1	W1-6 MOVED EAST TO ALLOW INGRESS AND EGRESS FROM PROJECT SITE					
CTH O ACCESS POINT	1	1	1		W1-6 RETURNED TO ITS ORIGINAL LOCATION FOLLOWING PROJECT CONCLUSION					
TOTALS	1	2	1	1						

PROJECT N	O: 1517-07-83	HWY: STH 441/USH 10	COUNTY: WINNEBAGO	MISCELLANEOUS QUANTITIES	SHEET:	E
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Standard Detail Drawing List

08E09-06 08E14-01 15D29-03

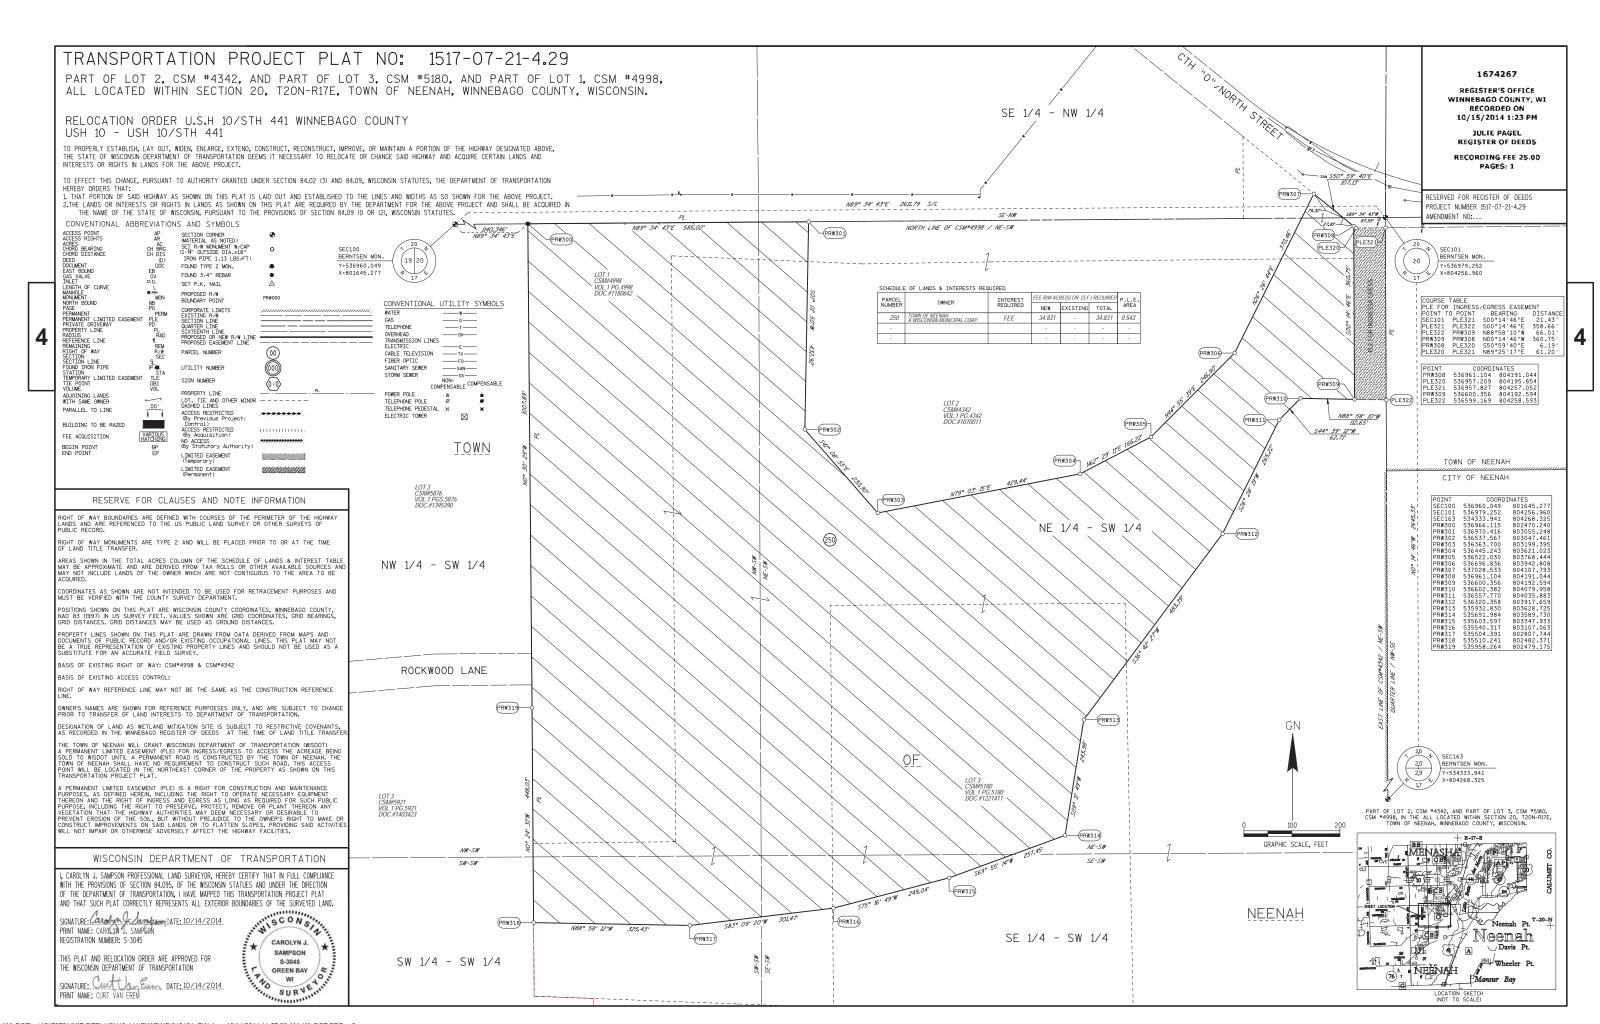SILT FENCE TRACKING PAD TRAFFIC CONTROL, VEHICLE ENTRANCE/EXIT OR HAUL ROAD

TYPICAL APPLICATION OF SILT FENCE

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PLAN VIEW SILT FENCE AT MEDIAN SURFACE DRAINS



GENERAL NOTES

DETAILS OF CONSTRUCTION NOT SHOWN ON THIS DRAWING SHALL CONFORM TO THE PERTINENT REQUIREMENTS OF THE STANDARD SPECIFICATIONS AND APPLICABLE SPECIAL PROVISIONS.

- ① HORIZONTAL BRACE REQUIRED WITH 2" X 4" WOODEN FRAME OR EQUIVALENT AT TOP OF POSTS.
- 2 FOR MANUAL INSTALLATIONS THE TRENCH SHALL BE A MINIMUM OF 4" WIDE & 6" DEEP TO BURY AND ANCHOR THE GEOTEXTILE FABRIC. FOLD MATERIAL TO FIT TRENCH AND BACKFILL & COMPACT TRENCH WITH EXCAVATED SOIL.
- 3 WOOD POSTS SHALL BE A MINIMUM SIZE OF 11/8" X 11/8" OF OAK OR HICKORY.
- 4) SILT FENCE TO EXTEND ACROSS THE TOP OF THE PIPE.
- (5) CONSTRUCT SILT FENCE FROM A CONTINUOUS ROLL IF POSSIBLE BY CUTTING LENGTHS TO AVOID JOINTS. IF A JOINT IS NECESSARY USE ONE OF THE FOLLOWING TWO METHODS; A) OVERLAP THE END POSTS AND TWIST, OR ROTATE, AT LEAST 180 DEGREES, B) HOOK THE END OF EACH SILT FENCE LENGTH.



TRENCH DETAIL



SILT FENCE TIE BACK


(WHEN REQUIRED BY THE ENGINEER)




SILT FENCE

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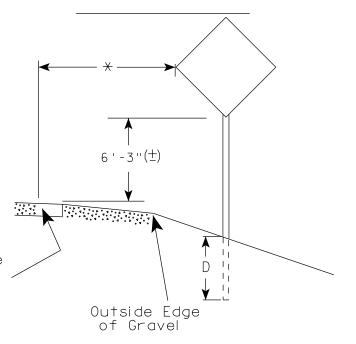


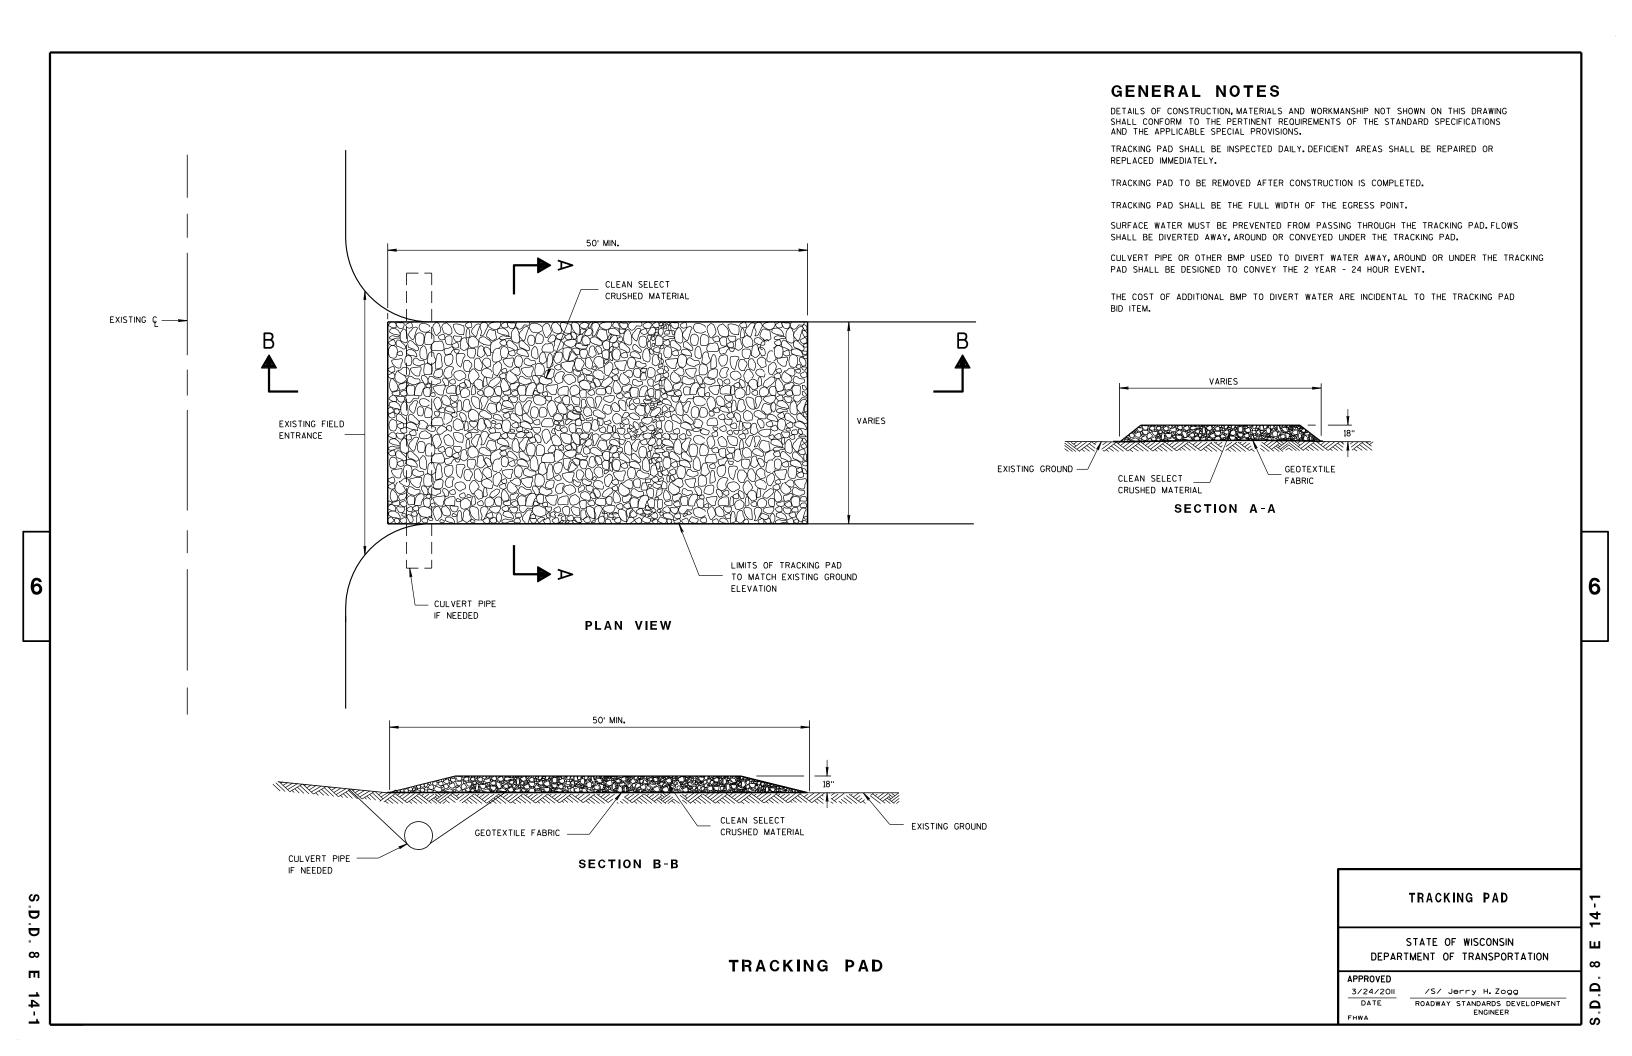


URBAN ARFA

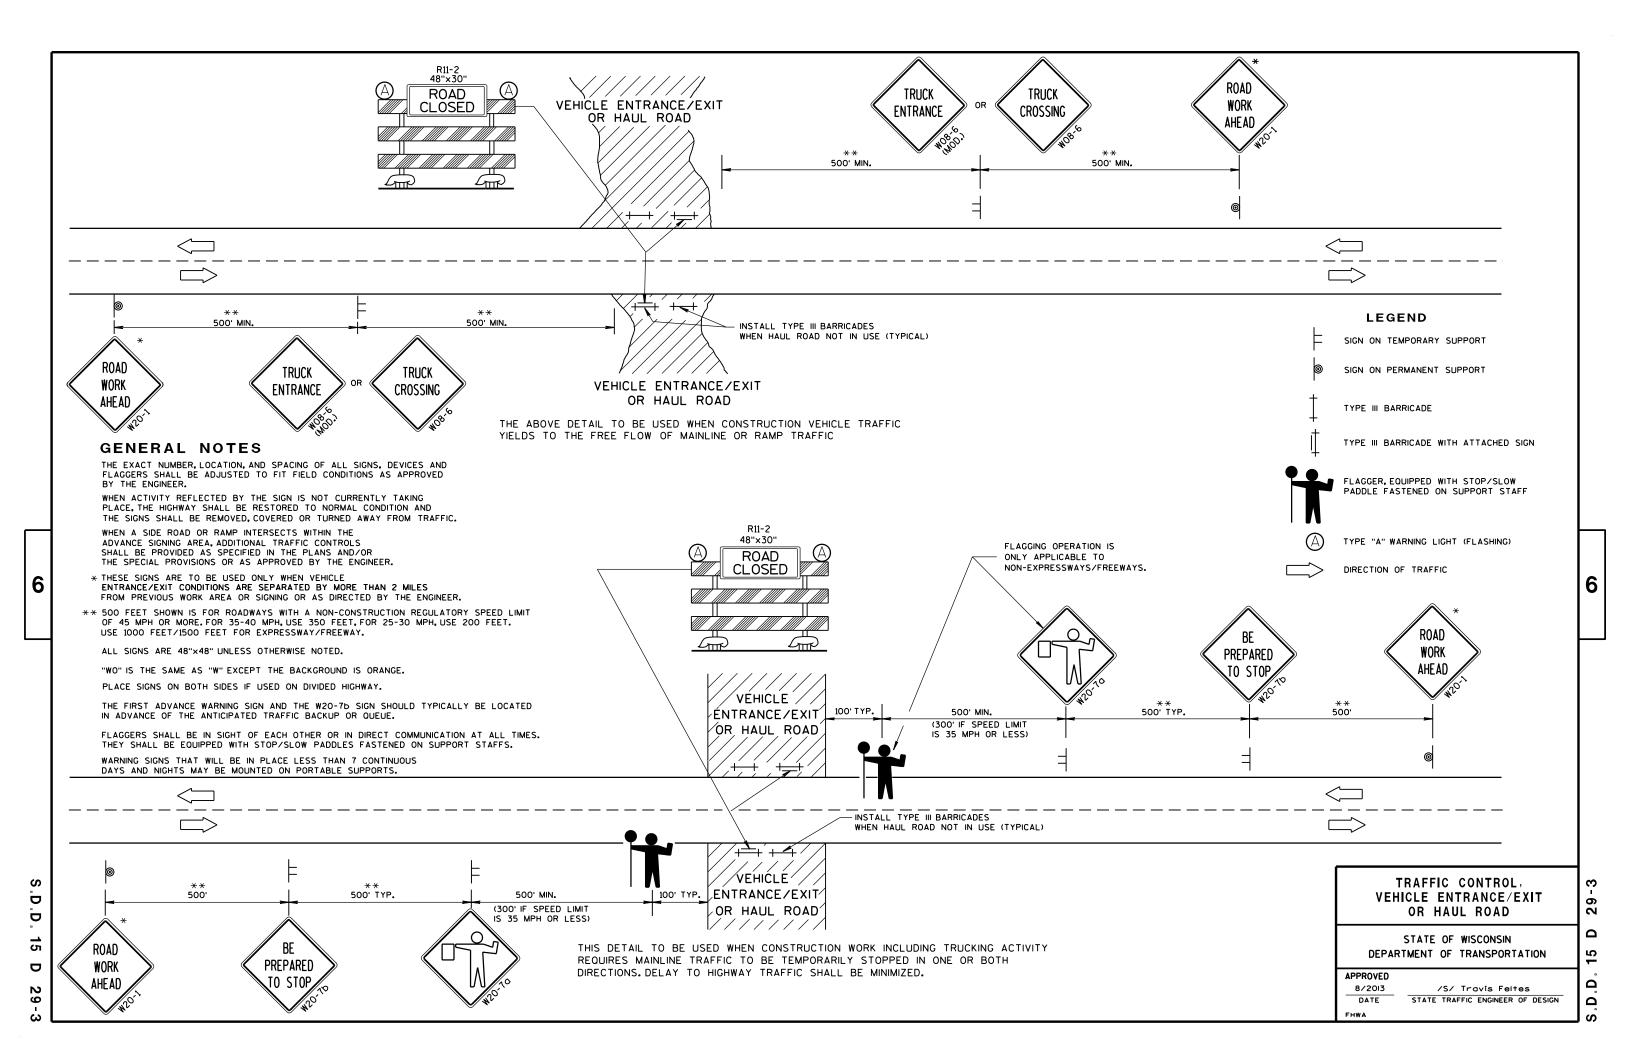2' Min - 4' Max (See Note 6) 7'-3"(士) ** Curb Flowline. White Edgeline Location

RURAL AREA (See Note 2)



2' Min - 4' Max (See Note 6)

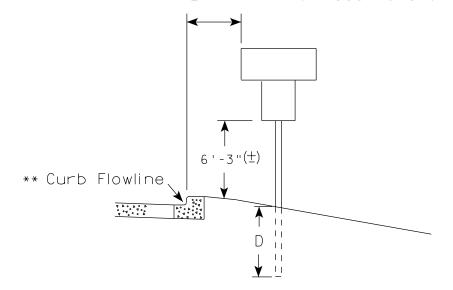

5'-3"(生) D^{-1} Outside Edae of Gravel

White Edgeline Location

** The existence of curb and gutter does not in itself mandate the vertical clearance illustrated.

HWY:

That height is typically measured where there is sidewalk adjacent to the roadway or parking is permitted. In the absence of sidewalk vertical clearance is measured from the top of the curb. Offset of signs is measured from the flow line.

* 6 feet from edge of a paved shoulder or 12 feet from the edge of pavement (edge line location) or 2 feet from outside edge of gravel, whichever is greater unless directed by project engineer.

PLOT DATE: 12-NOV-2014 14:03

GENERAL NOTES

- 1. Signs wider than 4 feet, 20 sq.ft or larger, shall be mounted on multiple posts. Refer to plate A4-4.
- 2. If signs are mounted on barrier wall, see A4-10 sign plate.
- 3. For expressways and freeways, mounting height is $7'-3''(\pm)$ or 6'-3" (±) depending upon existence of a sub-sign.
- 4. Minimum mounting height for J assemblies (A2-1S) is $7'-3''(\pm)$ or $6'-3''(\pm)$ per urban or rural detail respectively.
- 5. Minimum mounting height for signs mounted on traffic signal poles is $5' - 3'' (\pm)$.
- 6. Offset distance shall be consistent with existing signs or consistent throughout length of project.
- 7. The (+) tolerance for mounting height is 3 inches.
- 8. Folding signs shall be mounted at a height of 5'-3'' (\pm) or as directd by the Engineer.
- 9. The Double Arrow sign (W12-1) shall be mounted at a height of 2'-3" (\pm) . The Chevron sign (W1-8), Roundabout Chevron panel (R6-4B), Enhanced Reference Markers, Clearance Markers (W5-52), Mile Markers (D10 series), In Road Object Markers (W5-54) & End of Road Markers (W5-56) shall be mounted at a height of 4'-3'' (\pm).

POST EMBEDMENT DEPTH

D
(Min)
4'
5'

TYPICAL INSTALLATION OF PERMANENT TYPE II SIGNS ON SINGLE POSTS

WISCONSIN DEPT OF TRANSPORTATION

SHEET NO:

APPROVED

for State Traffic Engineer

DATE 11/12/14

PROJECT NO: FILE NAME : C:\CAEFiles\Projects\tr_stdplate\A43.DGN COUNTY:

PLOT BY: mscsja

PLOT NAME :

WISDOT/CADDS SHEET 42

PLOT SCALE: 99.237937:1.000000



NOTES: 1. ALL MATERIAL TO BE APPROVED

BY ENGINEER PRIOR TO INSTALLATION

- 2. SEE SIGN PLATE A4-8 FOR SIGN HARDWARE REQUIREMENTS
- 3. 18 INCH X 18 INCH SQUARE BOX-OUTS MAY BE USED FOR INSTALLATIONS IN EXISTING CONCRETE OR ASPHALT LOCATIONS.



ELEVATION VIEW

DETAIL OF STEEL 2 X 2 SIGN POST IN BOX-OUT



DETAIL OF WOOD 4 X 6 SIGN POST IN BOX-OUT

HWY:



PLAN VIEW

COUNTY:

FOR NEW CONCRETE/ASPHALT INSTALLATIONS

SIGN POST BOX-OUTS A4-3B

WISCONSIN DEPT OF TRANSPORTATION

For State Traffic Engineer

DATE 1/27/14 PLATE NO. A4-3B.1

SHEET NO:

FILE NAME : C:\CAEFiles\Projects\tr_stdplate\A43B.DGN

PROJECT NO:

PLOT DATE: 27-JAN-2014 09:48

PLOT NAME :

PLOT BY: mscsja

PLOT SCALE: 13.659812:1.000000

APPROVED


GENERAL NOTES

- 1. For 3 or 4 post installations, individual post spacing shall be greater than 3'-6".
- 2. See tables below for required number of posts.
- 3. For expressways and freeways. mounting height is 7'-3'' (±) or 6'-3'' (±) depending upon existence of sub-sign.
- 4. The (±) tolerance for mounting height is 3 inches.
- 5. Minimum mounting height for J assemblies (A2-1S) is 7'-3'' (±) or 6'-3'' (±) per urban or rural detail respectively.
- 6. Offset distance shall be consistent with existing signs or consistent throughout length of project.
- 7. Folding signs shall be mounted at a height of 5'-3" (±) or as directed by the engineer.
- 8. The Double Arrow sign (W12-1) shall be mounted at a height of 2'-3" (±). The Chevron sign (W1-8). Roundabout Chevron panel (R6-4B), Clearance Markers (W5-52), Mile Markers (D10 series), In Road Object Markers (W5-54) & End of Road Markers (W5-56) shall be mounted at a height of 4"-3" (±).
- * 6 feet from edge of a paved shoulder or 12 feet from the edge of pavement (edge line location) or 2 feet from outside edge of gravel, whichever is greater unless directed by project engineer.
- ** The existence of curb and gutter does not in itself mandate the vertical clearance illustrated. That height is typically measured where there is sidewalk adjacent to the roadway or parking is permitted. In the absence of sidewalk vertical clearance is measured from the top of the curb. Offset of signs is measured from the flow line.
- *** See A4-3 sign plate for signs 4' or less in width or less than 20 S.F. in area.

URBAN AREA RURAL AREA (See Note 3) 2'Min - 4'Max (See Note 6) ₩E# FF# 6'-3"(±) 6'-3"(±) 7'-3"(±) ** Curb ****\ Flowline D **7000** White Edgeline

2' Min - 4' Max (See Note 6) 6'-3"(±) Curb Flowline. 48" DIAMOND WARNING SIGN

D 11

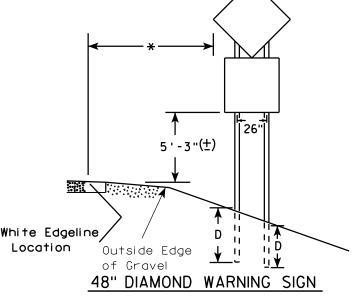

COUNTY:

Outside Edge

of Gravel

	SIGN SHAPE OTHER THAN DIAMON (TWO POSTS REQUIRED)		
	L	E	
* * *	Greater than 48" Less than 60"	12"	
	60" to 120"	L/5	

SIGN SHAPE OTHER THAN DIAMOND (THREE POSTS REQUIRED)		
L	E	
Greater than 120" less than 168"	12"	

HWY:

White Edgeline,

Location

SIGN SHAPE OTHER THAN DIAMOND (FOUR POSTS REQUIRED)			
L	E		
168" and greater	12"		

Location

Outside Edae

of Gravel

POST EMBEDMENT DEPTH

Area of Sign	
Installation	D
(Sq. Ft.)	(Min)
20 or Less	4'
Greater than 20	5'

TYPICAL INSTALLATION OF TYPE II SIGNS ON MULTIPLE POSTS

Matther

PLATE NO. A4-4.13

FILE NAME : C:\CAEFiles\Projects\tr_stdplate\A44.DGN

PROJECT NO:

PLOT DATE: 12-NOV-2014 14:01

PLOT NAME :

PLOT BY: mscsja

PLOT SCALE: 107.021305:1.000000

WISDOT/CADDS SHEET 42


SHEET NO:

WISCONSIN DEPT OF TRANSPORTATION

APPROVED

For State Traffic Engineer

DATE 11/12/14

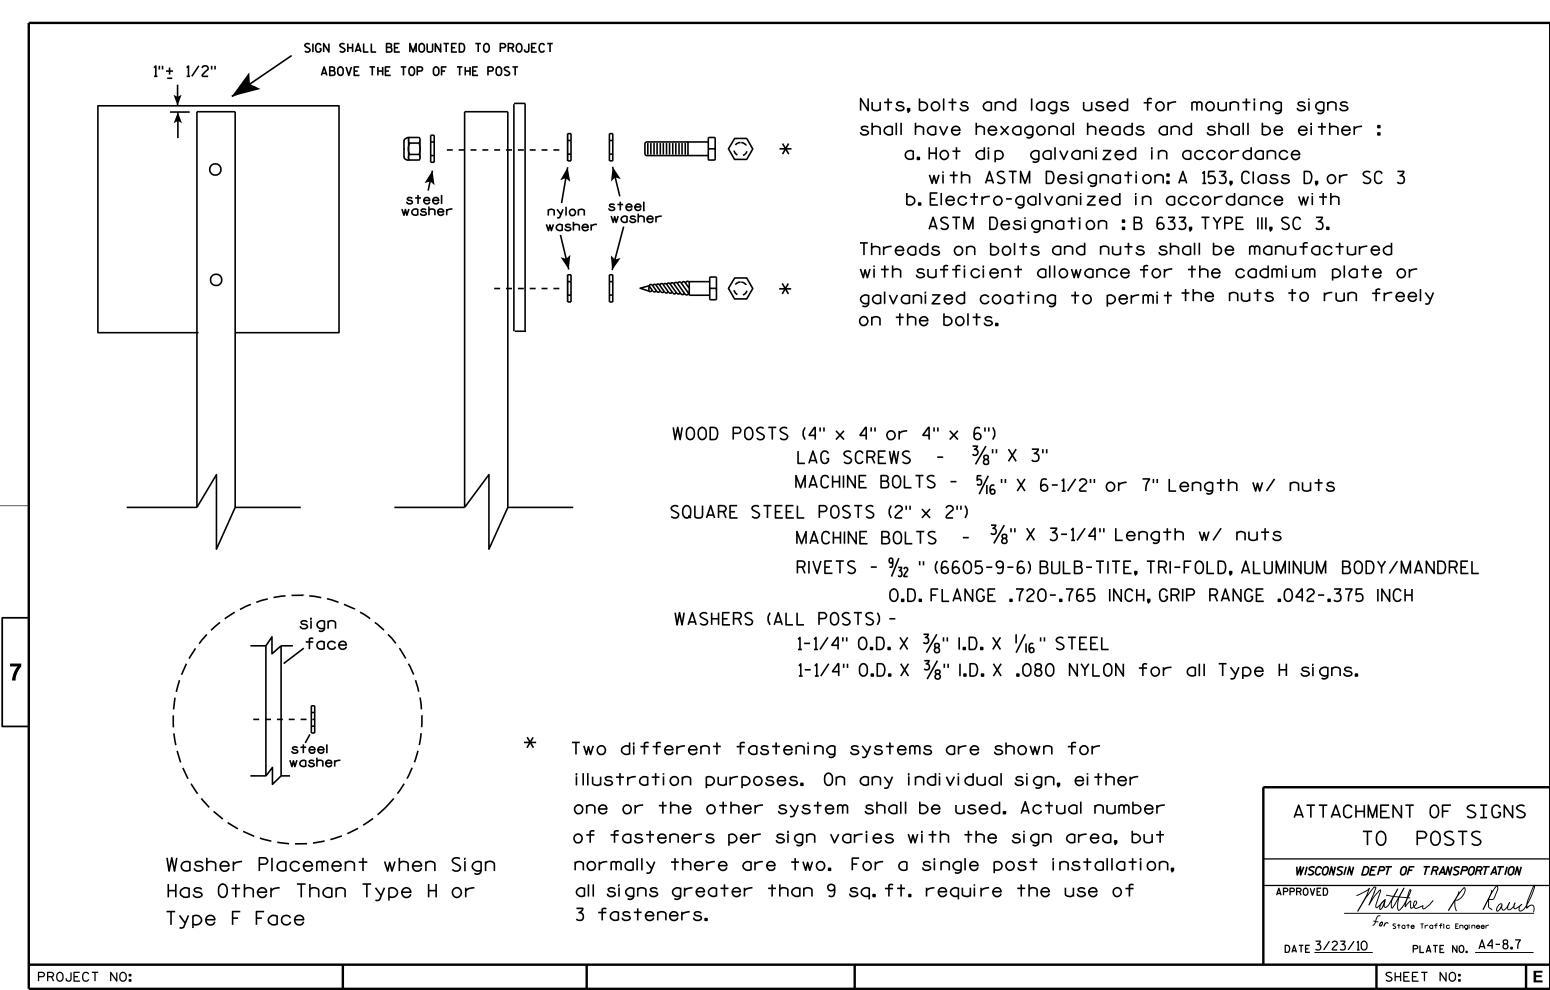



Notes



Wisconsin Department of Transportation

Dedicated people creating transportation solutions through innovation and exceptional service.

http://www.dot.wisconsin.gov