SWL JULY 2015

ORDER OF SHEETS

Section No. 1 Section No. 2 Typical Sections and Details (Including Erosion Control)

Miscellaneous Quantities Section No. 4 Section No. 5 Plan and Profile

Standard Detail Drawings Section No. 6 Sign Plates Section No. 7

Computer Earthwork Data Section No. 9 Cross Sections

TOTAL SHEETS = 40

STATE OF WISCONSIN DEPARTMENT OF TRANSPORTATION


PLAN OF PROPOSED IMPROVEMENT

FEDERAL PROJECT STATE PROJECT PROJECT CONTRACT WISC 2015420 5318-00-72

PATTERSON ROAD BRIDGE & APPROACHES

TOWN OF CLARNO

TOWN ROAD **GREEN COUNTY**

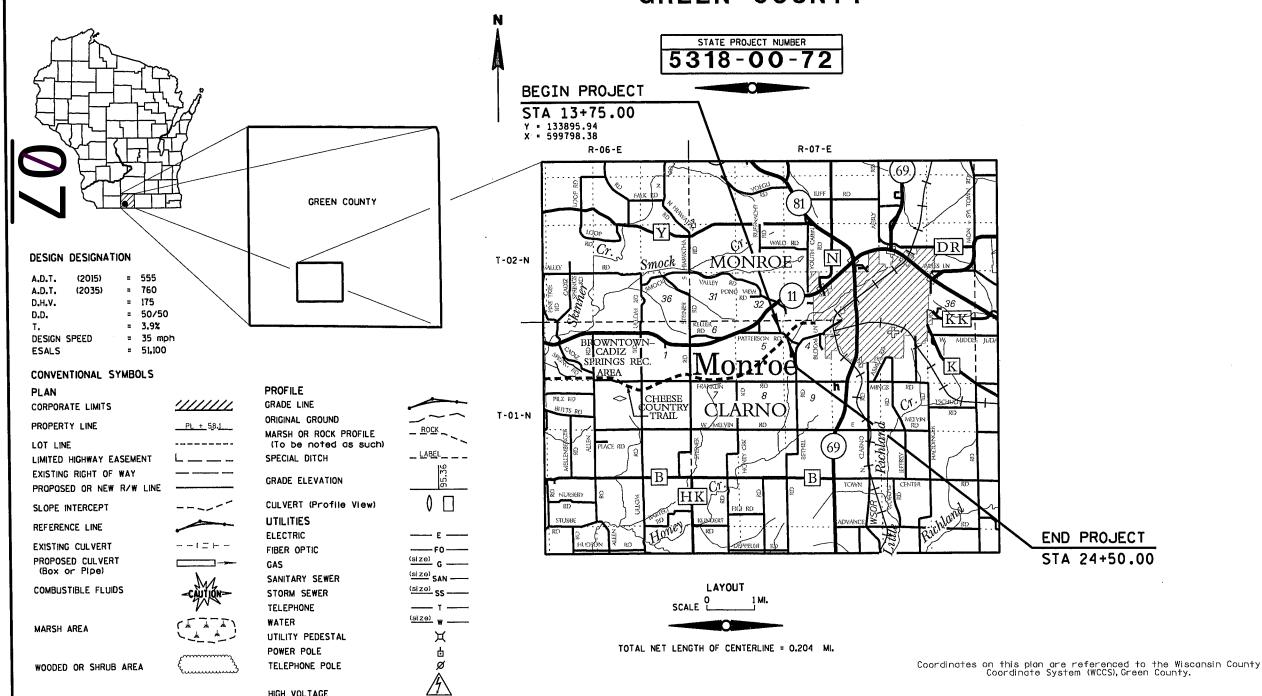

ACCEPTED FOR ACCEPTED FOR ORIGINAL PLANS PREPARED BY **AYRES** ASSOCIATES ALTERNATURE OF THE PARTY OF THE SCONS PETERSEN E - 36785 EAU CLAIRE SIONAL POR UNAL STREET 12/17/14 STATE OF WISCONSIN

DEPARTMENT OF TRANSPORTATION

PREPARED BY Surveyor Designer

Ayres Associates Ayres Associates

Kjohnson Engineers, inc

TE:1/28/15

CADDS SHEET 15

HIGH VOLTAGE

2:21:48 PM

MATCH

EXISTING

EXISTING

GROUND

7% DESIRABLE (10% MAX.)

IN CUT 7% DESIRABLE (10% MAX.)

INFILL

THE EXACT LOCATION AND LIMITS OF FIELD ENTRANCES SHALL BE DETERMINED BY THE ENGINEER IN THE FIELD.

EROSION CONTROL ITEMS TO BE PLACED AS SHOWN ON THE PLAN OR AS DIRECTED BY THE ENGINEER.

NO TREES ARE TO BE REMOVED WITHOUT THE APPROVAL OF THE ENGINEER.

SEED MIXTURES NO. 20, NO. 40 AND TEMPORARY SHALL BE USED IN THE PROJECT. AND SHALL BE PLACED AS SHOWN IN THE PLANS AND/OR AS DIRECTED BY THE ENGINEER, SEED NO. 40 IS TO BE USED IN LAWN AREAS.

THE LOCATIONS OF EXISTING AND PROPOSED UTILITY INSTALLATIONS AS SHOWN ON THE PLANS ARE APPROXIMATE. THERE MAY BE OTHER UTILITY INSTALLATIONS WITHIN THE PROJECT AREA THAT ARE NOT SHOWN.

EXISTING FENCE TO BE REMOVED BY OTHERS.



www.DiggersHotline.com

* DENOTES UTILITIES THAT ARE NOT DIGGERS HOTLINE MEMBERS

UTILITIES

AMERICAN TRANSMISSION COMPANY W234 N2000 RIDGEVIEW PARKWAY COURT WAUKESHA, WI 53188-1000 ATTN: TOM BETTHAUSER (262) 832-8717 tbetthauser@atclic.com

PROJECT NO:5318-00-72

ALLIANT ENERGY 1915 STATE ROAD 69 SOUTH MONROE, WI 53566 ATTN: STEVE LARSEN (608) 328-5339 stevelarsen@alliantenergy.com

ROCK BAGS FLOW-LINE DRAINAGE SECTION VIEW 6" MIN

FRONT VIEW

CULVERT PIPE CHECKS (PLACE AT ALL INLET ENDS OF ALL PIPES)

TDS TELECOM PO BOX 88 827 16TH AVENUE MONROE, WI 53566 ATTN: DAREN NEUENSCHWANDER (608) 328-1158 daren.neuenschwander@tdstelecom.com

RUNOFF COEFFICIENT TABLE

		HYDROLOGIC SOIL GROUP										
		Α			В		С			D		
	SLOPE RANGE (PERCENT)		SLOPE RANGE (PERCENT)			SLOPE RANGE (PERCENT)			SLOPE RANGE (PERCENT)			
LAND USE:	0-2	2-6	6 & OVER	0-2	2-6	6 & OVER	0-2	2-6	6 & OVER	0-2	2-6	6 & OVER
ROW CROPS	.08	.16	.22	.12	.20	.27	.15	.24	.33	.19	.28	.38
	.22	.30	.38	.26	.34	.44	.30	.37	.50	.34	.41	.56
MEDIAN STRIP-	.19	.20	.24	.19	.22	.26	.20	.23	.30	.20	.25	.30
TURF	.24	.26	.30	.25	.28	.33	.26	.30	.37	.27	.32	.40
SIDE SLOPE-			.25			.27			.28			.30
TURF			.32			.34			.36			.38
PAVEMENT:							l					
ASPHAL T						.7095						
CONCRETE						.8095						
BRICK	BRICK .7080											
DRIVES, WALKS	DRIVES, WALKS .7585											
ROOFS						.7595						
GRAVEL ROADS.	SHOULDE	RS				.4060	•				•	

ACRES


HWY: PATTERSON ROAD

TOTAL PROJECT AREA = 2.77 ACRES TOTAL AREA EXPECTED TO BE DISTURBED BY CONSTRUCTION ACTIVITIES = 2.62 DNR CONTACT

WISCONSIN DNR, SOUTHWEST REGION 3911 FISH HATCHERY ROAD FITCHBURG, WI 53711 ATTN: LAURA BUB (608) 275-3485 laura.bub@wisconsin.gov

DESIGNER

AYRES ASSOCIATES 3433 OAKWOOD HILLS PARKWAY EAU CLAIRE, WI 54701 MARK PETERSEN, PE (715) 834-3161 petersenm@ayresassociates.com

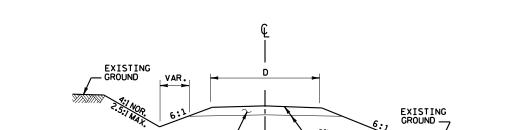

FINISHED SHOULDER

PROFILE VIEW

POINT

ROUNDING

SHOULDER

LANE


PAVED ENTRANCE

MAINTAIN PAVEMENT SLOPE

6" BASE AGGREGATE DENSE 3/4-INCH. OR

6" BASE AGGREGATE DENSE 1/4-INCH, AND CONCRETE DRIVEWAY 6-INCH

TYPICAL CROSS SECTION

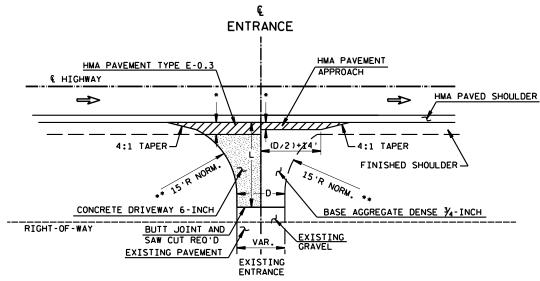

L=VARIABLE. EXACT LENGTH TO BE DETERMINED IN THE ETELD BY THE ENGINEER. BLEND BACK ON THE ENTRANCE FAR ENOUGH TO GET A SMOOTH PROFILE.

D=DRIVEWAY WIDTH D=20'TYP. (PE's & FE's) (12'MIN.-22'MAX.) D=28'TYP. (CE's & FARM ENT.) (24'MIN.-35'MAX.)

- ** RADIUS IS TANGENT AT PAVED SHOULDER EDGE OR 5' MAX. OFF EDGE OF MAIN LINE PAVEMENT WHICH EVER IS LESS.
- * 3' MAX. OR TO FINISHED SHOULDER WHICH EVER IS LESS.

PLAN VIEW

RURAL DRIVEWAY INTERSECTION DETAIL (PE's, FE's & CE'S)

FILE NAME: V:\Structures-EC\42-0613.00 - Green Co., Patterson Road\DGN\420613_020301_ts.dgn

COUNTY: GREEN


TYPICAL SECTIONS: GENERAL NOTES & UTILITIES

PLOT NAME :


SHEET

PLOT DATE: 4/10/2015 PLOT BY : AYRES-EC PLOT SCALE: 1:200

EXISTING TYPICAL SECTION PATTERSON ROAD

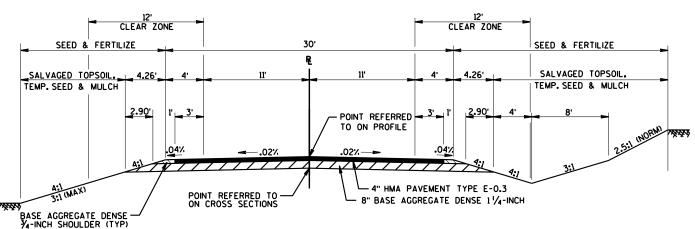


FINISHED TYPICAL SECTION PATTERSON ROAD

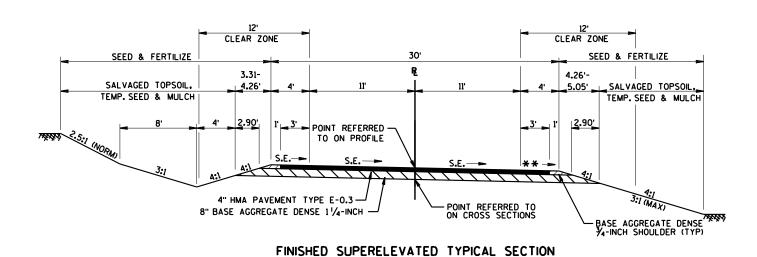


HMA PAVEMENT LAYER THICKNESS

TOTAL LAYER THICKNESS	LAYERS	ASPHALTI MATERIAL		
4"	1.75" UPPER LAYER 2.25" LOWER LAYER	PG 58-28 PG 58-28		

** THE LOW SIDE SHOULDER SLOPE ON SUPERELEVATED SECTION EQUALS
THE SUPERELEVATION RATE WHEN THE SUPERELEVATION RATE IS GREATER
THAN 4%. IF THE SUPERELEVATION RATE IS LESS THAN OR EQUAL TO 4%.
THE LOW SIDE SHOULDER SLOPE IS 4%. HIGH SIDE SHOULDER SLOPE ON
SUPERELEVATED SECTIONS EQUALS THE SUPERELEVATION RATE.
SEE SUPERELEVATION TABLES FOR SE.

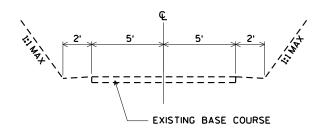


EXISTING TYPICAL SECTION CHEESE COUNTRY RECREATIONAL TRAIL

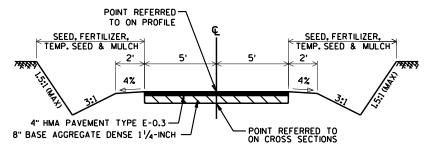

FINISHED TYPICAL SECTION

CHEESE COUNTRY RECREATIONAL TRAIL

STA 102+18 - STA 102+68 STA 103+01 - STA 103+51

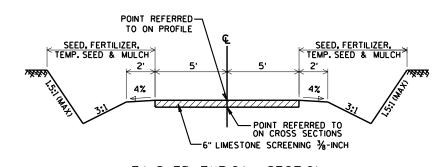

FINISHED TYPICAL SECTION

CHEESE COUNTRY RECREATIONAL TRAIL

STA 101+50 - STA 102+18 STA 103+51 - STA 104+75

FILE NAME: U:\42-0613.00 - Green Co., Patterson Road\DGN\420613_020301_ts.dgn

PROJECT NO:5318-00-72

HWY: PATTERSON ROAD

PATTERSON ROAD

COUNTY: GREEN

TYPICAL SECTIONS

PLOT NAME :

PLOT SCALE: 1:200


WISDOT/CADDS SHEET 42


SHEET

Ε

PLOT DATE: 12/11/2014

PLOT BY : AYRES-EC

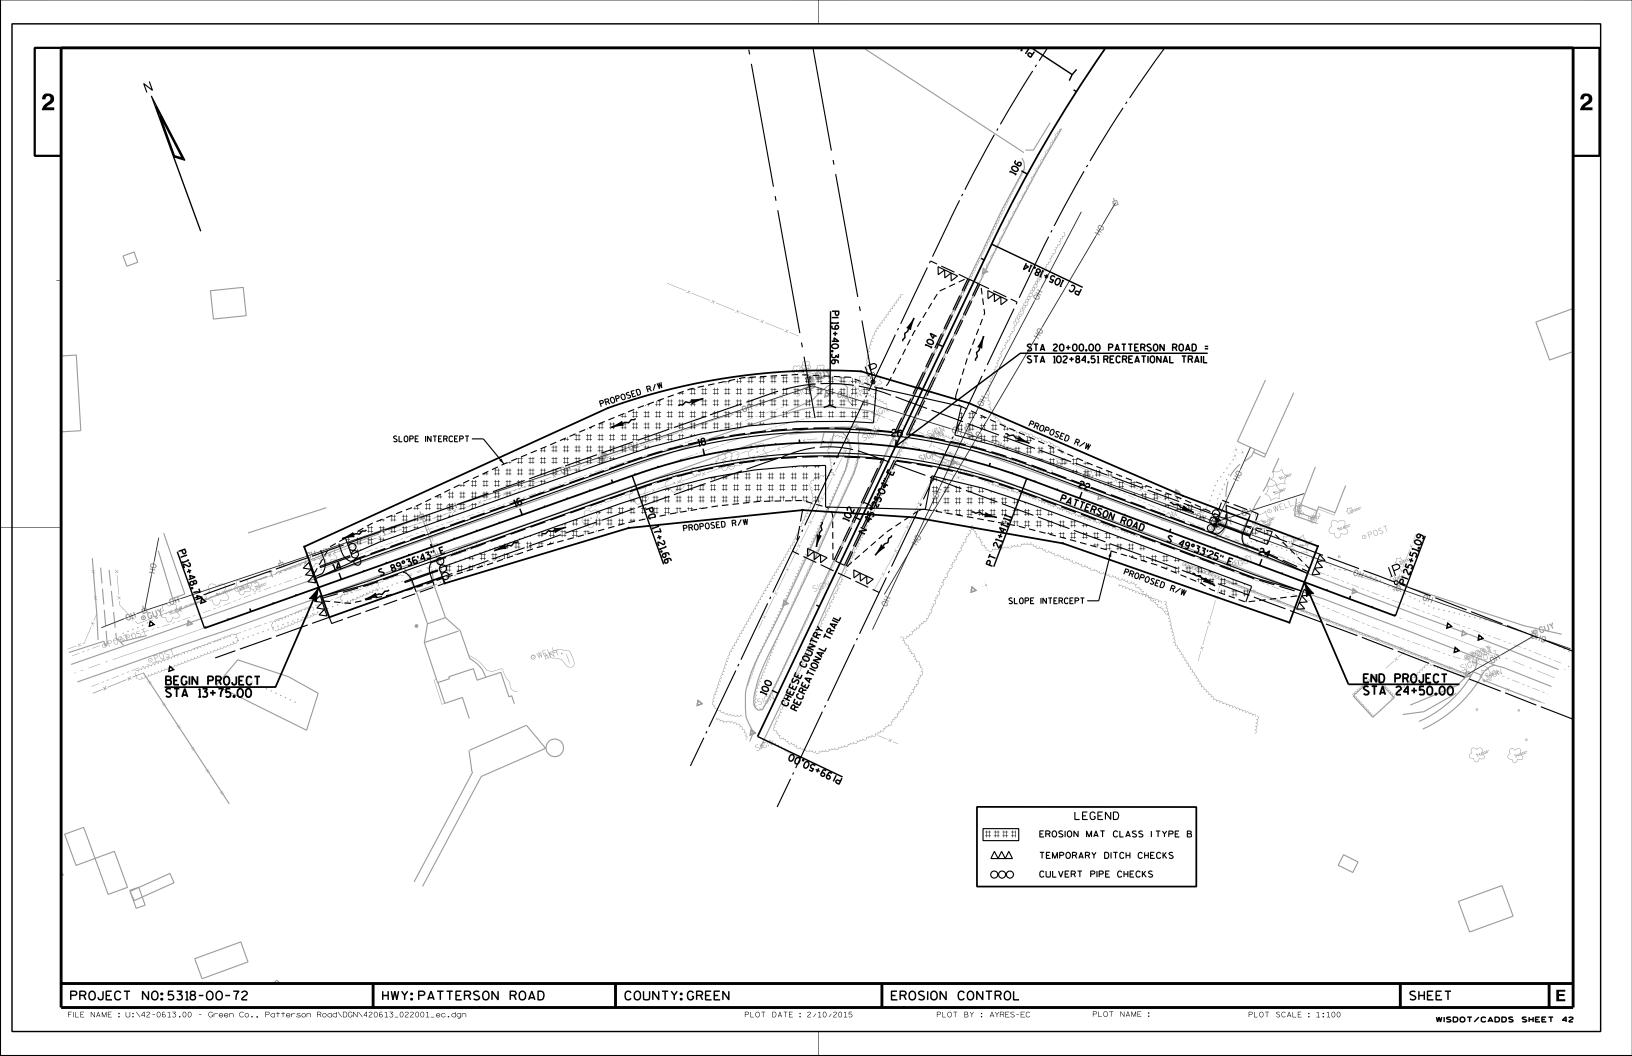

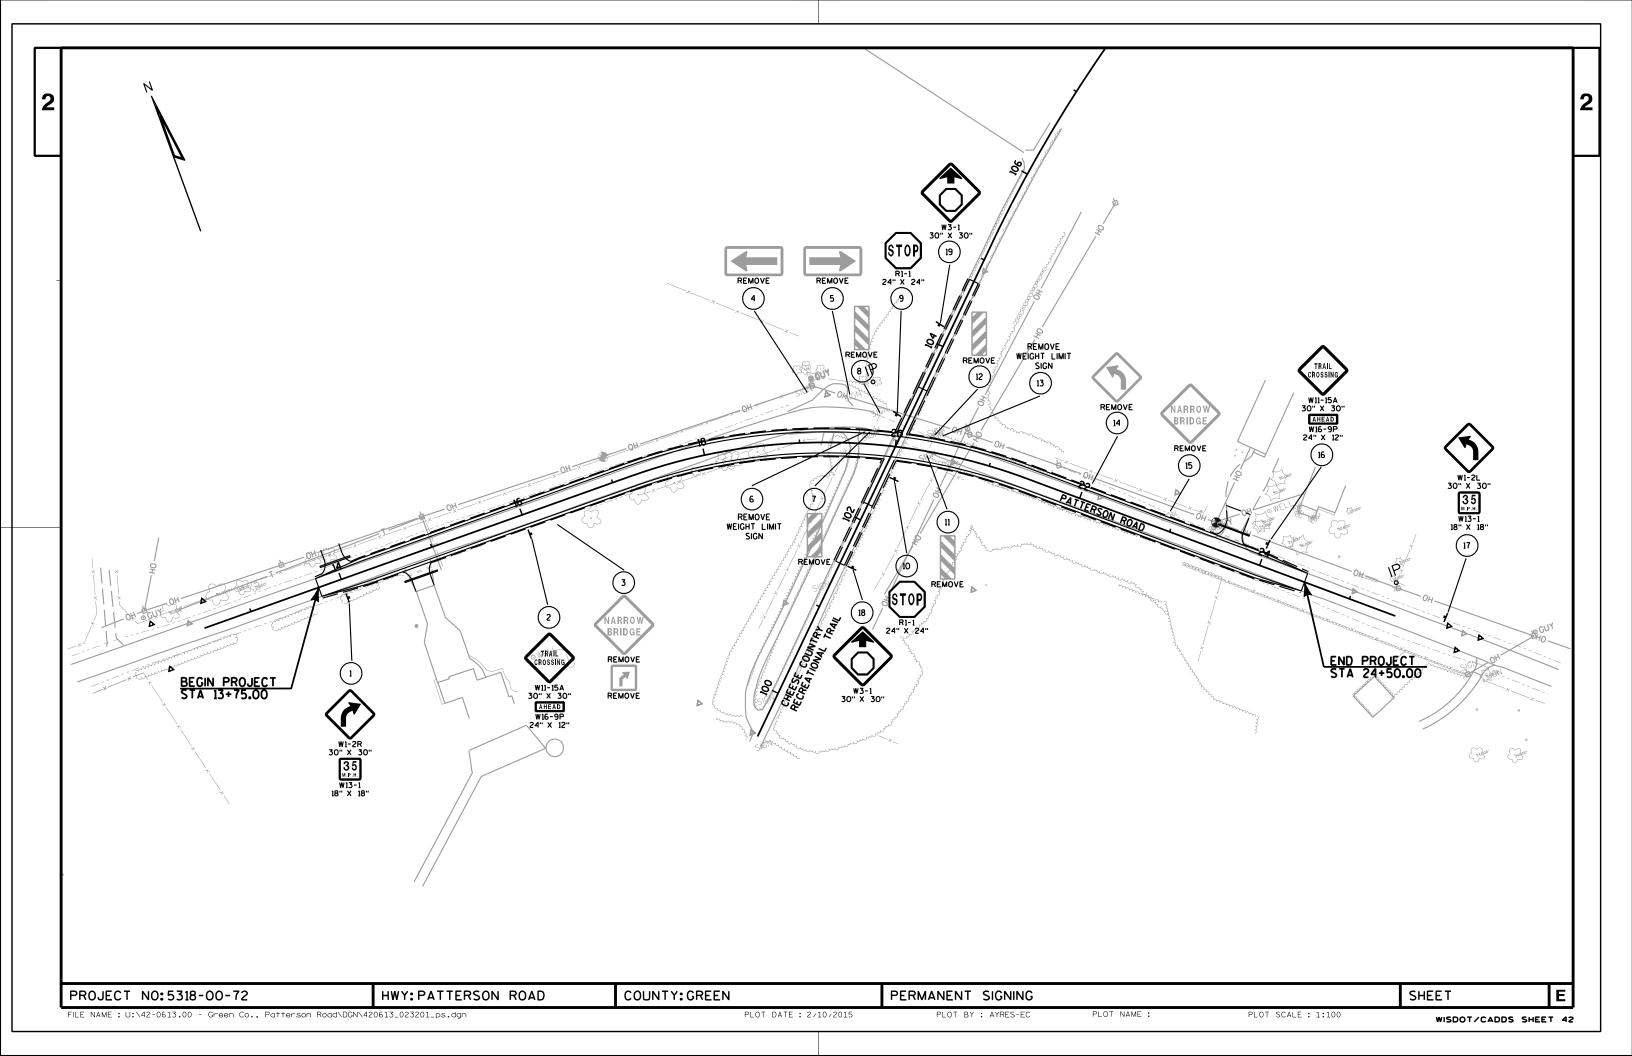

DATE 27	APR15	EST	IMAT	E O F Q U A N	T I T I E S 5318-00-72
NUMBER	ITEM	ITEM DESCRIPTION	UNI T	TOTAL	QUANTI TY
0010	201.0105	CI eari ng	STA	11. 000	11. 000
0020	201. 0205	Grubbi ng	STA	11. 000	11. 000
0030	203. 0100	Removing Small Pipe Culverts	EACH	2. 000	2. 000
0040	203. 0200	Removing Old Structure (station) 01.	LS	1. 000	1. 000
0050	205. 0100	20+00 Excavation Common	CY	21, 669. 000	21, 669. 000
	205 2222	F		F 002 000	F 002 000
0060	205. 0200	Excavation Rock	CY	5, 983. 000	5, 983. 000
0070	213. 0100	Finishing Roadway (project) 01.	EACH	1. 000	1. 000
0800	305. 0110	5318-00-72 Base Aggregate Dense 3/4-Inch	TON	130. 000	130. 000
0090	305. 0110	Base Aggregate Dense 1 1/4-Inch	TON	1, 950. 000	1, 950. 000
0100	416. 0160	Concrete Driveway 6-Inch	SY	60. 000	60. 000
0110	455. 0105	Asphaltic Material PG58-28	TON	42. 900	42. 900
0110	455. 0605	Tack Coat	GAL	242. 000	242. 000
0120	460. 1100	HMA Pavement Type E-0.3	TON	780. 000	780. 000
0130	460. 1100	Incentive Density HMA Pavement	DOL	500.000	500.000
0150	460. 4000	HMA Cold Weather Paving	TON	780. 000	780. 000
0130	400. 4000	HIWA COLU WEATHEL FAVILIY	ION	700.000	700.000
0160	520. 0118	Culvert Pipe Class III 18-Inch	LF	108.000	108. 000
0170	520. 1018	Apron Endwalls for Culvert Pipe 18-Inch	EACH	6. 000	6. 000
0170	619. 1000	Mobilization	EACH	1. 000	1. 000
0190	624. 0100	Water	MGAL	150. 000	150. 000
0200	625. 0500	Salvaged Topsoil	SY	9, 261. 000	9, 261. 000
0200	525. 0500	our raged Topsort	JI	7, 201. 000	7, 201. 000
0210	627. 0200	Mul chi ng	SY	11, 570. 000	11, 570. 000
0220	628. 1504	Silt Fence	LF	100.000	100.000
0230	628. 1520	Silt Fence Maintenance	LF	100. 000	100. 000
0240	628. 1905	Mobilizations Erosion Control	EACH	2. 000	2. 000
0250	628. 1910	Mobilizations Emergency Erosion Control	EACH	2. 000	2. 000
0260	628. 2004	Erosion Mat Class I Type B	SY	6, 150. 000	6, 150. 000
0270	628. 7504	Temporary Ditch Checks	LF	100.000	100.000
0280	628. 7555	Culvert Pipe Checks	EACH	8. 000	8. 000
0290	629. 0210	Fertilizer Type B	CWT	7. 000	7. 000
0300	630. 0120	Seeding Mixture No. 20	LB	220. 000	220. 000
0310	630. 0140	Seeding Mixture No. 40	LB	90.000	90.000
0320	630. 0200	Seeding Temporary	LB	155. 000	155. 000
0330	634.0614	Posts Wood 4x6-Inch X 14-FT	EACH	8. 000	8. 000
0340	637. 2210	Signs Type II Reflective H	SF	6. 620	6. 620
0350	637. 2230	Signs Type II Reflective F	SF	46. 000	46. 000
0360	638. 2602	Removing Signs Type II	EACH	12.000	12.000
0370	638. 3000	Removing Small Sign Supports	EACH	12. 000	12.000
0380	642. 5001	Field Office Type B	EACH	1. 000	1. 000
0390	643.0100	Traffic Control (project) 01. 5318-00-72	EACH	1. 000	1. 000
0400	650. 4500	Construction Staking Subgrade	LF	1, 400. 000	1, 400. 000
0.440	/FO F000	On the contract of the contrac		1 400 000	1 400 000
0410	650. 5000	Construction Staking Base	LF	1, 400. 000	1, 400. 000
0420	650. 9910	Construction Staking Supplemental	LS	1. 000	1. 000
		Control (project) 01. 5318-00-72			
0430	650. 9920	Construction Staking Slope Stakes	LF	1, 400. 000	1, 400. 000
0440	690. 0150	Sawing Asphalt	LF	40.000	40. 000
0450	690. 0250	Sawing Concrete	LF	20. 000	20. 000
0460	CDV 010F	Charlet 01 Limentons Comments		75 000	75 000
0460	SPV. 0195	Special 01. Limestone Screenings 3/8-Inch	TON	75. 000	75. 000
		3/ U-TITICIT			

CLEARING AND GRUBBING REMOVING OLD STRUCTURE (STA 20+00)

		201.0105	201.0205			203.0100					
		CLEARING	GRUBBING	STATION	LOCATION	EACH	LENGTH	SIZE	COMMENTS	STATION	
STATION TO STATION	LOCATION	STA	STA								
				14+79	RT	1	29'	15"	DRIVEWAY CMCP	20+00	
13+75 - 15+00	LT/RT	2	2	23+62	LT	1	38'	12"	DRIVEWAY CMCP		
16+00 - 24+50	LT/RT	9	9								
				PROJECT TO	FAL	2					
PROJECT TOTALS		11	11								

EARTHWORK SUMMARY

			CUT	205.0100 EXCAVATION COMMON	(9) AVAILABLE MATERIAL	(6) 205.0200 EXCAVATION ROCK	UNEXPANDED FILL	(2) (4) EXPANDED FILL	(5) MASS ORDINATE +/-	(1) WASTE
DIVISION	STATION TO STATION	LOCATION	СУ	CY	CY	CY	CY	CY	CY	CY
	13+75 - 24+50	PATTERSON RD	25191	20244	20244	4947	172	215	25471	25471
	101+50 - 104+75	TRAIL	2461	1425	1425	1036	175	219	2346	2346

5983

460.1100

460.4000

(1) WASTE = EXPANDED FILL - EXCAVATION COMMON - 1.1 * EXCAVTION ROCK (FOR INFORMATION ONLY - NOT A BID ITEM)

(2) EXPANSION FACTOR = 1.25

PROJECT ID TOTALS

- (3) BORROW = EXPANDED FILL -AVAILABLE MATERIAL
- (4) EXPANDED FILL = UNEXPANDED FILL * EXPANSION FACTOR
- (5) THE MASS ORDINATE + OR QTY CALCULATED FOR THE DIVISION. PLUS QUANTITY INDICATES AN EXCESS OF MATERIAL WITHIN THE DIVISION. MINUS INDICATES A SHORTAGE OF MATERIAL WITHIN THE DIVISION.

21669

- (6) ROCK EXPANSION FACTOR = 1.1
- (9) AVAILABLE MATERIAL = COMMON EXCAVATION

BASE AGGREGATE DENSE

STATION TO STATION	305.0110 3/4-INCH TON	305.0120 1 1/4-INCH TON
13+75 - 24+50	90	1900
102+18 - 102+68		25
103+01 - 103+51		25
DRIVEWAYS	40	
PROJECT TOTALS	130	1950

STATION

14+79

PROJECT TOTAL

HMA PAVEMENT ITEMS

455.0105

FINISHING R	OADWAY
OCATION	213.0100 EACH
. 5318-00-72	1
OJECT TOTAL	1

CULVERT PIPE CLASS III 18-INCH

520.0118 520.1018

416.0160

SY

60

60

		PIPE	ENDWALL	THICKNES	SS(INCHES)
STATION	LOCATION	LF	EACH	STEEL	ALUMINUM
14+00	LT	36	2	0.064	0.060
14+79	RT	36	2	0.064	0.060
23+62	LT	36	2	0.064	0.060
PROJECT TO	OTAT.S	108	6		

PROJECT TOTALS 108 6

CONCRETE DRIVEWAY 6-INCH

LOCATION

PROJECT NUMBER: 5318-00-72 HWY: PATTERSON ROAD COUNTY: GREEN MISCELLANEOUS QUANTITIES SHEET NO: E

MISCELLANEOUS QUANTITIES


PROJECT NUMBER: 5318-00-72

HWY: PATTERSON ROAD

COUNTY: GREEN

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SHEET NO:

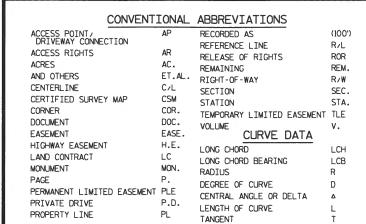


CONVENTIONAL UTILITY SYMBOLS WATER GAS TELEPHONE OVERHEAD TRANSMISSION LINES ELECTRIC CABLE TELEVISION -----TV-FIBER OPTIC SANITARY SEWER STORM SEWER -----ss-----COMPENSABLE COMPENSABLE POWER POLE TELEPHONE POLE TELEPHONE PEDESTAL X ELECTRIC TOWER \boxtimes

BEGIN RELOCATION ORDER

STA, 13+75,00

1,445.28' SOUTH OF AND 538.43' WEST OF THE NORTHEAST CORNER OF SEC. 5. T. 01 N. R. 07 E.

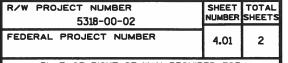

PLAT OF RIGHT-OF-WAY REQUIRED FOR


PATTERSON ROAD BRIDGE & APPROACHES, TOWN OF CLARNO

TOWN ROAD

GREEN COUNTY

CONSTRUCTION PROJECT NUMBER 5318-00-72

CONVENTIONAL SYMBOLS

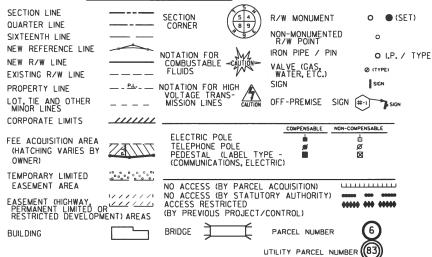

NOTES:

POSITIONS SHOWN ON THIS PLAT ARE WISCONSIN COUNTY COORDINATES, GREEN COUNTY, NAD83(1991) ADJUSTMENT IN U.S. SURVEY FEET. VALUES SHOWN ARE GRID COORDINATES, GRID BEARINGS AND GRID DISTANCES. GRID DISTANCES MAY BE USED AS AND GROUND DISTANCES.

ALL NEW RIGHT-OF-WAY MONUMENTS WILL BE TYPE 2 (TYPICALLY 3/4" X 24" IRON REBARS), UNLESS OTHERWISE NOTED, AND WILL BE PLACED PRIOR TO THE COMPLETION OF THE PROJECT BY OTHERS.

RIGHT-OF-WAY BOUNDARIES ARE DEFINED WITH COURSES OF THE PERIMETER OF THE HIGHWAY LANDS REFERENCED TO THE U.S. PUBLIC LAND SURVEY SYSTEM OR OTHER "SURVEYS OF PUBLIC RECORD".


PROPERTY LINES SHOWN ON THIS PLAT ARE DRAWN FROM DATA DERIVED FROM MAPS AND DOCUMENTS OF PUBLIC RECORD AND/OR EXISTING OCCUPATIONAL LINES. THIS PLAT MAY NOT BE A TRUE REPRESENTATION OF EXISTING PROPERTY LINES, EXCLUDING RIGHT-OF-WAY LINES, AND SHOULD NOT BE USED AS A SUBSTITUTE FOR AN ACCURATE FIELD SURVEY.

EXISTING HIGHWAY RIGHT-OF-WAY SHOWN HEREIN IS BASED ON THE FOLLOWING POINTS OF REFERENCE: EXISTING HIGHWAY R/W PATTERSON ROAD ESTABLISHED FROM CENTERLINE OF EXISTING ROAD AND STATUTE 82.31.

A TEMPORARY LIMITED EASEMENT (TLE) IS A RIGHT FOR CONSTRUCTION PURPOSES, AS DEFINED HEREIN, INCLUDING THE RIGHT TO OPERATE NECESSARY EQUIPMENT THEREON AND THE RIGHT OF INGRESS AND EGRESS, AS LONG AS REQUIRED FOR SUCH PUBLIC PURPOSE, INCLUDING THE RIGHT TO PRESERVE, PROTECT, REMOVE, OR PLANT THEREON ANY VEGETATION THAT THE HIGHWAY AUTHORITIES MAY DEEM NECESSARY OR DESIRABLE. ALL TLES EXPIRE AT THE COMPLETION OF THE CONSTRUCTION PROJECT FOR WHICH THIS INSTRUMENT IS GIVEN.

A HIGHWAY EASEMENT (H.E.) IS AN EASEMENT FOR HIGHWAY PURPOSES, AS LONG AS SO USED, INCLUDING THE RIGHT TO PRESERVE, PROTECT, REMOVE OR PLANT THEREON ANY VEGETATION THAT THE HIGHWAY AUTHORITIES MAY DEEM NECESSARY OR DESIRABLE.

DIMENSIONING FOR THE NEW RIGHT-OF-WAY IS MEASURED ALONG AND PERPENDICULAR TO NEW REFERENCE LINES.

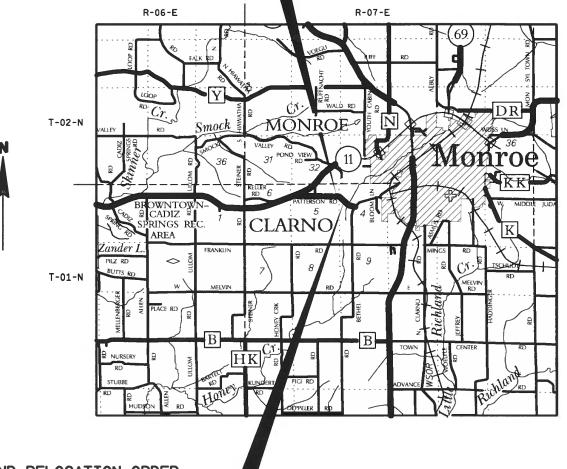

END RELOCATION ORDER

STA. 24+50.00

1.791.36' SOUTH OF AND 428.45' EAST OF THE NORTHEAST CORNER OF SEC. 5, T. 01 N., R. 07 E.

LAYOUT

PLOT BY : kk226

TOTAL NET LENGTH OF CENTERLINE = 0.204 MI.

ACCEPTED FOR

ORIGINAL PLAT PREPARED BY





THIS SURVEY IS PREPARED AT THE REQUEST OF THE TOWN. THE FIELD SURVEY WAS PERFORMED IN JULY 2009. THIS SURVEY IS CORRECT TO THE BEST OF MY KNOWLEDGE


JOHN FAVORITE (PRINTED NAME) ____

(REGISTRATION NUMBER)

REVISION DATE

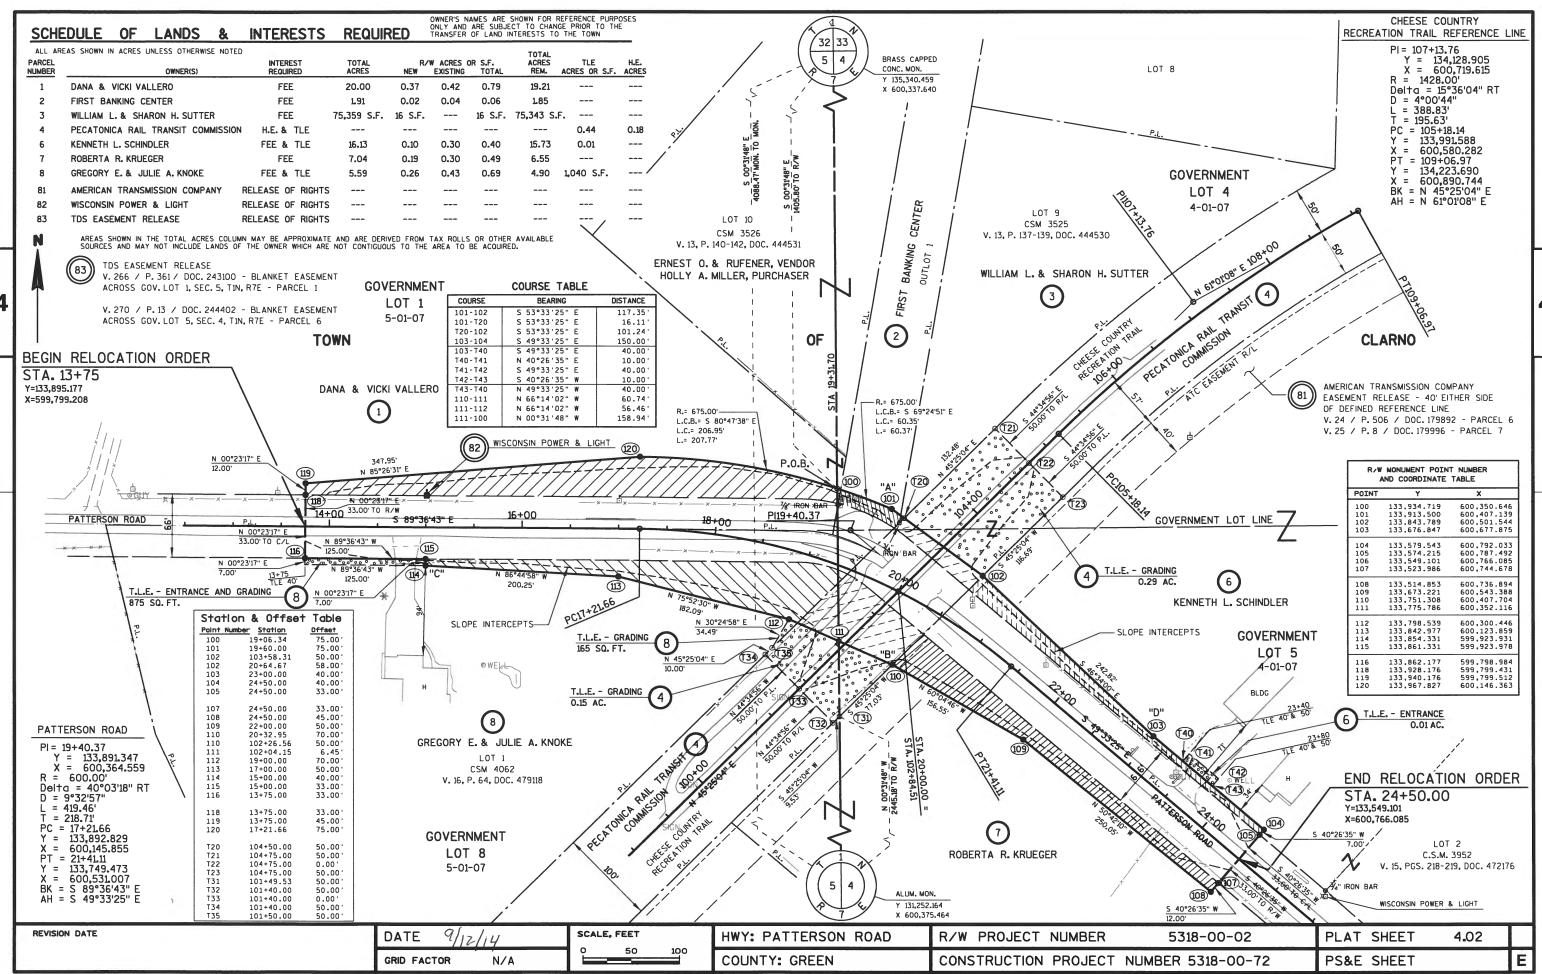

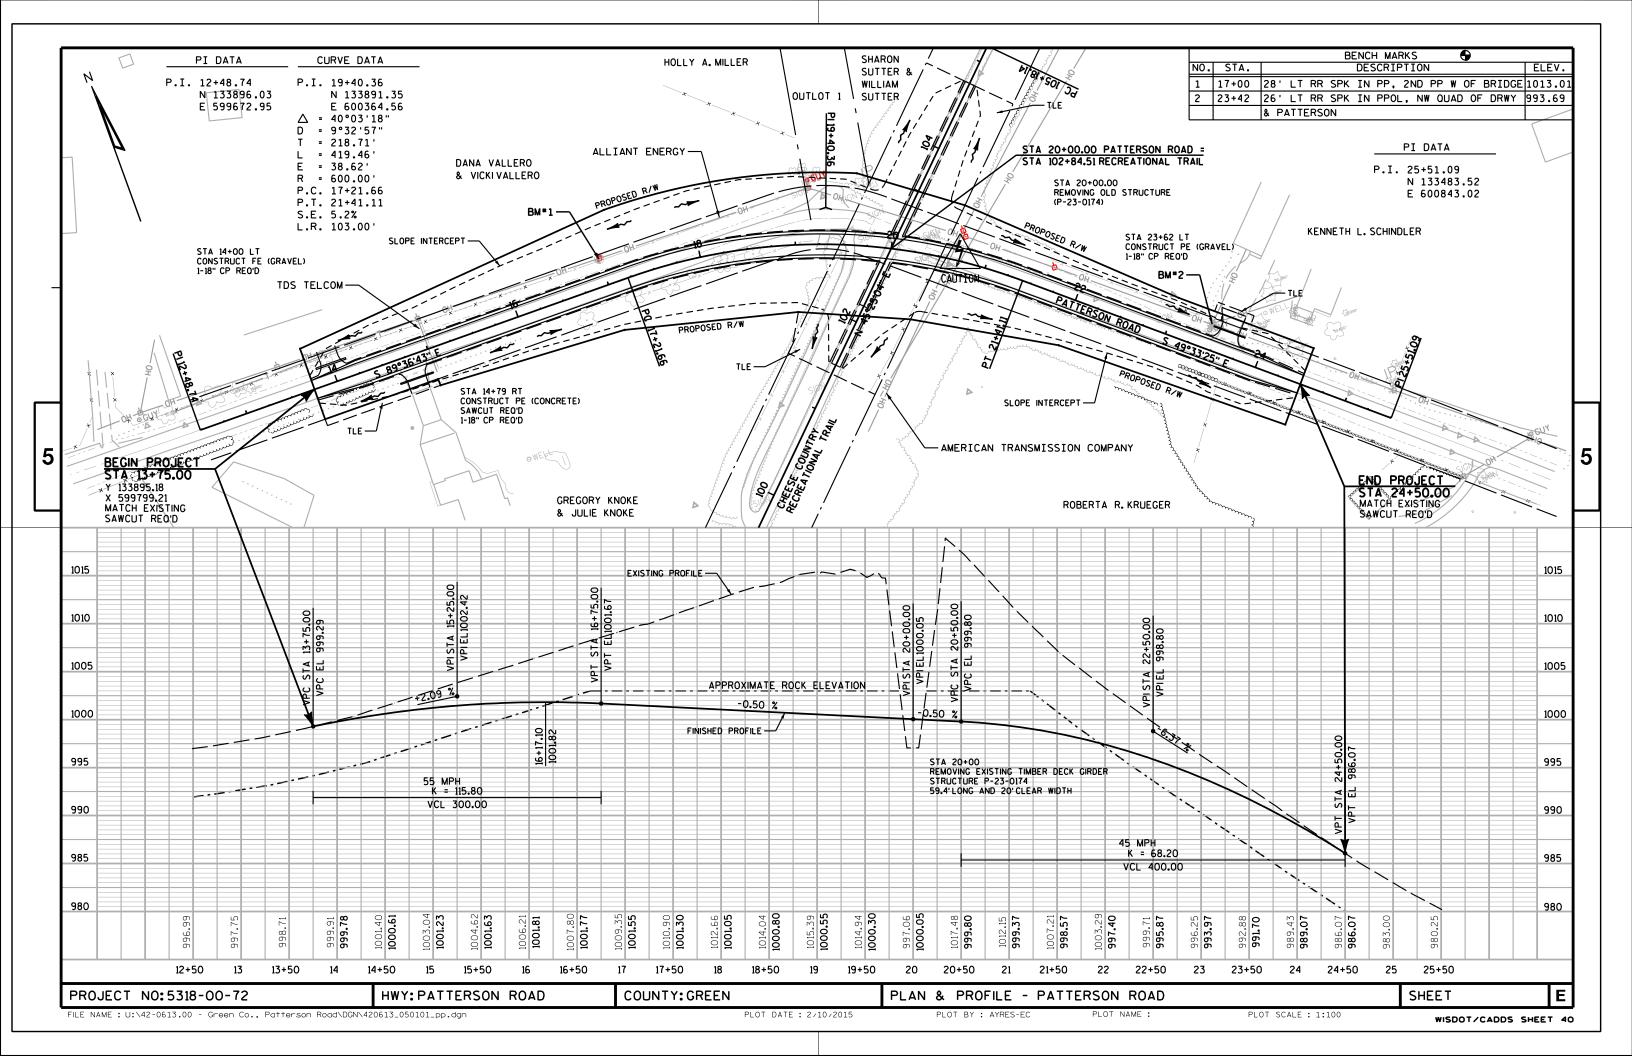

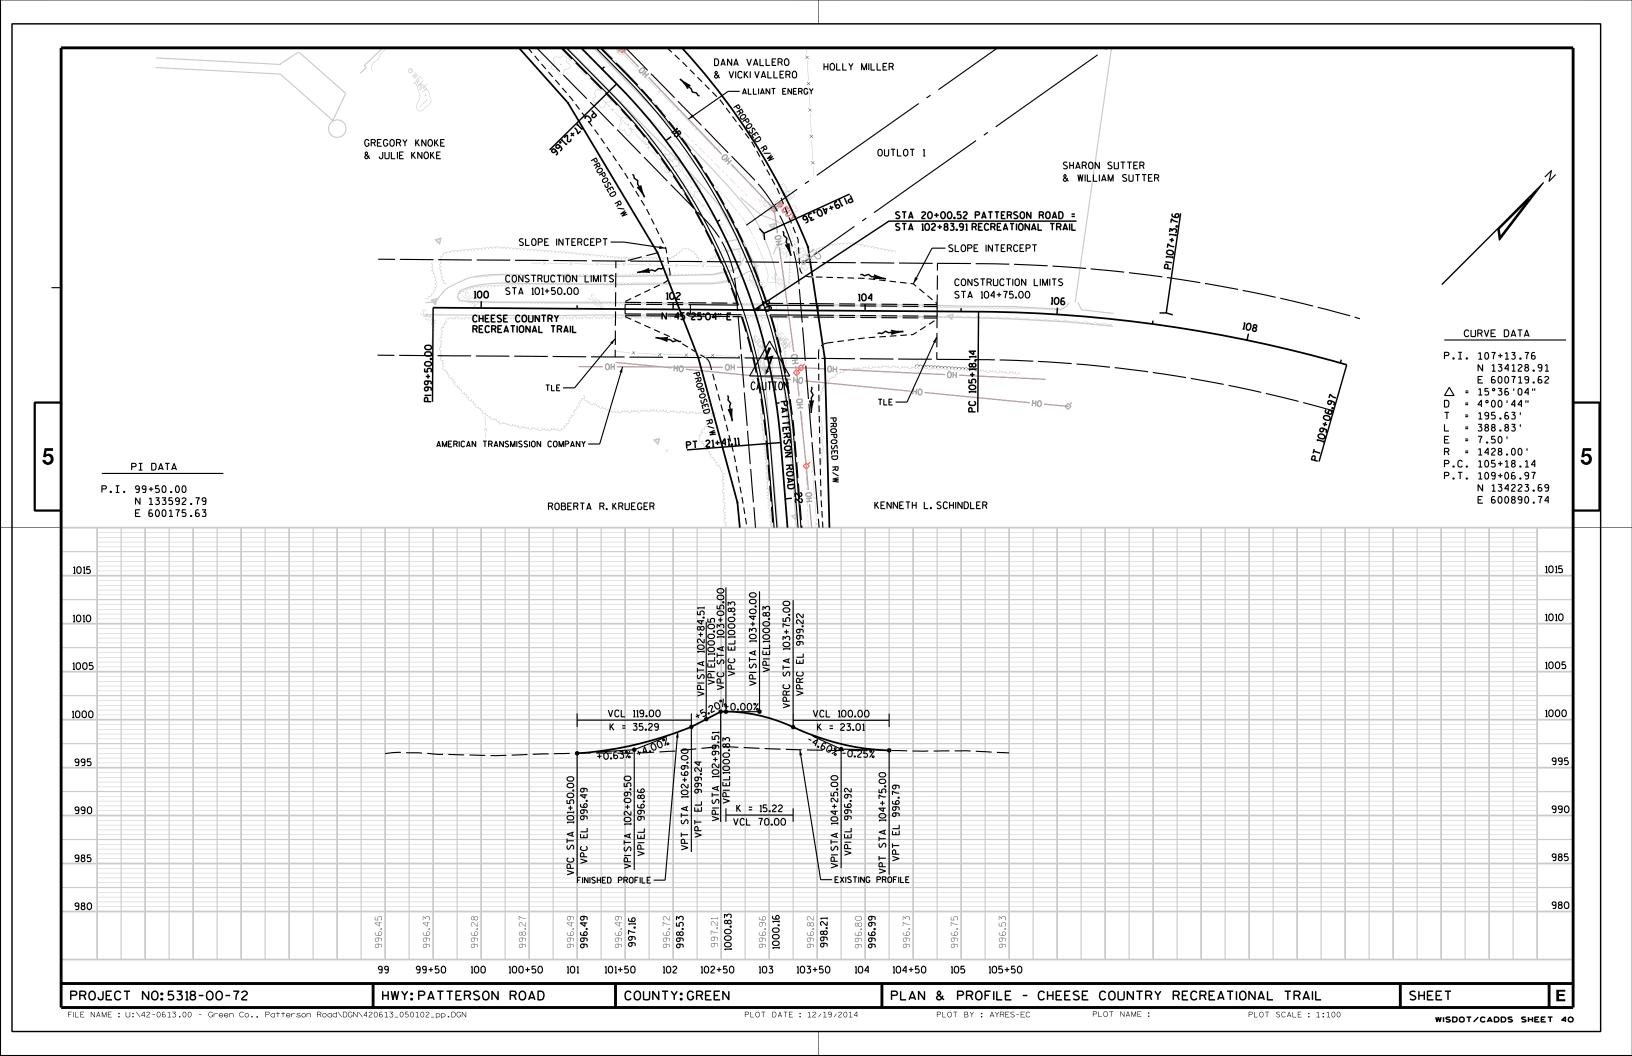


Standard Detail Drawing List

08E08-03 08F09-06	TYPICAL INSTALLATIONS OF EROSION BALES / TEMPORARY DITCH CHECKS
08E09-06 08F01-11	APRON FNDWALLS FOR CULVERT PLPF
15C02-05A	BARRI CADES AND SIGNS FOR MAINLINE CLOSURES
15C02-05B	BARRICADES AND SIGNS FOR MAINLINE CLOSURES
15C03-02	BARRI CADES AND SIGNS FOR SIDEROAD CLOSURES
15C12-04	TRAFFIC CONTROL FOR LANE CLOSURE (SUITABLE FOR MOVING OPERATIONS)


GENERAL NOTES

DETAILS OF CONSTRUCTION, MATERIALS AND WORKMANSHIP NOT SHOWN ON THIS DRAWING SHALL CONFORM TO THE PERTINENT REQUIREMENTS OF THE STANDARD SPECIFICATIONS AND THE APPLICABLE SPECIAL PROVISIONS.


TEMPORARY DITCH CHECKS EITHER EROSION BALES OR MANUFACTURED SHALL BE PAID FOR UNDER THE BID ITEM OF TEMPORARY DITCH CHECK. THE DEPARTMENT WILL NOT PAY FOR TEMPORARY DITCH CHECKS CONSTRUCTED OF A SINGLE ROW OF EROSION BALES.

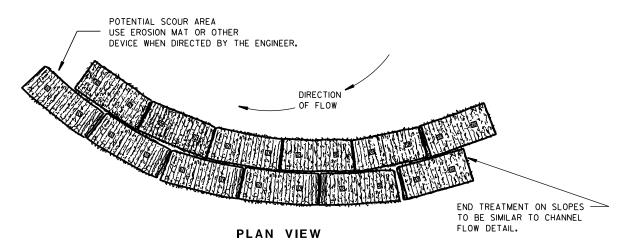

WHEN ALTERING THE DIRECTION OF FLOW

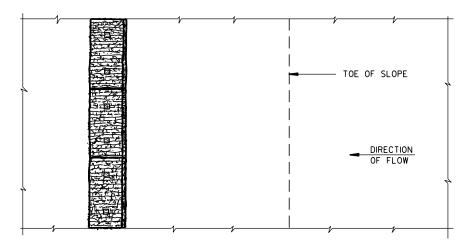

PLAN VIEW

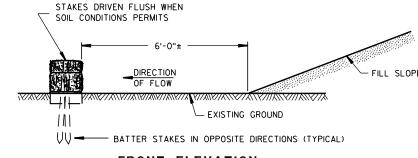

FRONT ELEVATION

WHEN EXISTING GROUND SLOPES AWAY FROM FILL SLOPE

EROSION BALES FOR SHEET FLOW

TYPICAL INSTALLATIONS OF **EROSION BALES / TEMPORARY** DITCH CHECKS

6

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STATE OF WISCONSIN DEPARTMENT OF TRANSPORTATION

APPROVED

6/04/02 /S/ Beth Connestro
CHIEF ROADWAY DEVELOPMENT ENGINEER

6

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TYPICAL APPLICATION OF SILT FENCE

6

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PLAN VIEW SILT FENCE AT MEDIAN SURFACE DRAINS



GENERAL NOTES

DETAILS OF CONSTRUCTION NOT SHOWN ON THIS DRAWING SHALL CONFORM TO THE PERTINENT REQUIREMENTS OF THE STANDARD SPECIFICATIONS AND APPLICABLE SPECIAL PROVISIONS.

- ① HORIZONTAL BRACE REQUIRED WITH 2" X 4" WOODEN FRAME OR EQUIVALENT AT TOP OF POSTS.
- 2 FOR MANUAL INSTALLATIONS THE TRENCH SHALL BE A MINIMUM OF 4" WIDE & 6" DEEP TO BURY AND ANCHOR THE GEOTEXTILE FABRIC. FOLD MATERIAL TO FIT TRENCH AND BACKFILL & COMPACT TRENCH WITH EXCAVATED SOIL.
- 3 WOOD POSTS SHALL BE A MINIMUM SIZE OF 11/8" X 11/8" OF OAK OR HICKORY.
- 4) SILT FENCE TO EXTEND ACROSS THE TOP OF THE PIPE.
- (5) CONSTRUCT SILT FENCE FROM A CONTINUOUS ROLL IF POSSIBLE BY CUTTING LENGTHS TO AVOID JOINTS. IF A JOINT IS NECESSARY USE ONE OF THE FOLLOWING TWO METHODS; A) OVERLAP THE END POSTS AND TWIST, OR ROTATE, AT LEAST 180 DEGREES, B) HOOK THE END OF EACH SILT FENCE LENGTH.



TRENCH DETAIL



SILT FENCE TIE BACK

(WHEN REQUIRED BY THE ENGINEER)



SILT FENCE

တ ∞

 ∞

Δ

	METAL APRON ENDWALLS										
PIPE	MIN. 1	THICK.			DIMENS	SIONS (II	nches)			APPROX.	
DIA.	(Incl		A	В	Н	L	Lį	L ₂	W	SLOPE	BODY
(IN.)	STEEL	ALUM.	(±]")	(MAX.)	(±]")	(±1½")	①	0	(±2")		
12	.064	.060	6	6	6	21	12	171/2	24	21/2+o 1	1Pc.
15	.064	.060	7	8	6	26	14	213/4	30	2½+o 1	1Pc.
18	.064	.060	8	10	6	31	15	281/4	36	2½+o 1	1Pc.
21	.064	.060	9	12	6	36	18	29%	42	$2\frac{1}{2}$ to 1	1Pc.
24	.064	. 075	10	13	6	41	18	371/4	48	$2\frac{1}{2}$ to 1	1Pc.
30	.079	. 075	12	16	8	51	18	521/4	60	$2\frac{1}{2}$ to 1	1Pc.
36	.079	. 105	14	19	9	60	24	59¾	72	$2\frac{1}{2}$ to 1	2 Pc.
42	.109	. 105	16	22	11	69	24	75%	84	$2\frac{1}{2}$ to 1	2 Pc.
48	.109	.105	18	27	12	78	24	81	90	2 ¹ / ₄ +o 1	3 Pc.
54	.109	. 105	18	30	12	84	30	851/2	102	21/4+0 1	3 Pc.
60	.109×	.105×	18	33	12	87	_		114	2 to 1	3 Pc.
66	.109×	.105×	18	36	12	87	_	_	120	2 to 1	3 Pc.
72	.109×	.105×	18	39	12	87	_	_	126	2 to 1	3 Pc.
78	.109×	.105×	18	42	12	87	_	_	132	11/2+0 1	3 Pc.
84	.109×		18	45	12	87	_	_	138	1/2+0 1	3 Pc.
90	.109×	.105×	18	37	12	87	_	_	144	11/2+0 1	3 Pc.
96	.109×	.105×	18	35	12	87	_		150	11/2+0 1	3 Pc.

* EXCEPT CENTER PANEL

SEE GENERAL NOTES

PLAN VIEW

END VIEW

SIDE ELEVATION

METAL ENDWALLS

SHOULDER

SLOPE

	REINFORCED CONCRETE APRON ENDWALLS							
PIPE			DIM	ENSIONS	(Inches)			APPROX.
DIA.	Т	A	В	С	C D		G	SLOPE
12	2	4	24	48 1/8	721/8	24	2	3 to 1
15	21/4	6	27	46	73	30	21/4	3 to 1
18	21/2	9	27	46	73	36	21/2	3 to 1
21	23/4	9	36	371/2	731/2	42	23/4	3 to 1
24	3	91/2	431/2	30	731/2	48	3	3 to 1
27	31/4	101/2	$49^{1}/_{2}$	24	731/2	54	31/4	3 to 1
30	$3\frac{1}{2}$	12	54	193⁄4	731/2	60	31/2	3 to 1
36	4	15	63	34¾	97¾	72	4	3 to 1
42	$4\frac{1}{2}$	21	63	35	98	78	41/2	3 to 1
48	5	24	72	26	98	84	5	3 to 1
54	51/2		65	* ** 33 ¹ / ₄ -35	* 98 ¹ / ₄ - 100	90	51/2	2% to 1
60	6	* ** 30-35	60	39	99	96	5	2 to 1
66	61/2		* ** 72-78	* * * 21-27	99	102	51/2	2 to 1
72	7	* ** 24-36	78	21	99	108	6	2 to 1
78	71/2	* ** 24-36	78	21	99	114	61/2	2 to 1
84	8	36	901/2	21	1111/2	120	61/2	11/2+0 1
90	81/2	41	871/2	24	1111/2	132	61/2	11/2+0 1

*MINIMUM

PLAN

END VIEW

END SECTION

GROOVED END ON OUTLET END SECTION TONGUE END ON INLET END SECTION

BAR OR STEEL FABRIC

REINFORCEMENT

LONGITUDINAL SECTION

CONCRETE ENDWALLS

OPTIONAL

1 1/2" R

CULVERT

MEASURED LENGTH

OF CULVERT (TO-

NEAREST FOOT)

DESIGN

REINFORCED

SECTION A-A)

END CORNER PLATES MAY

BE FASTENED TO APRON

THE SURFACES TIGHTLY

TOGETHER

PROPER BY BOLTS, RIVETS, OR RESISTANCE SPOT WELDS WHICH WILL HOLD

TOE PLATE (SAME THICKNESS

AND METAL AS APRON) SHALL

BE FURNISHED WHEN CALLED

FOR ON THE PLANS

FDGE (SFE


END SECTION CONNECTOR STRAP LUG


1" WIDE, 12 GA. (0.109"


THICK) GALVANIZED STRAP

WITH STANDARD 6" X 1/2" BAND BOLT AND NUT

TYPE 1 FOR 12" THRU 24" CORR. PIPE

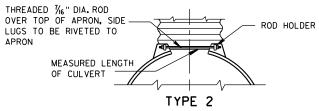

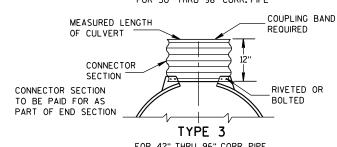

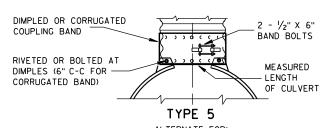



ALTERNATE FOR: ALL SIZES CORRUGATED CIRCULAR PIPE


NOTE: DIMPLED BAND FITS OVER OUTSIDE OF ENDWALL. AND CORRUGATED BAND FITS INSIDE ENDWALL. DIMPLED BAND MAY BE USED WITH HELICALLY CORRUGATED PIPE.


CONNECTION DETAILS 1, 2 OR 5.

ALTERNATE FOR TYPE 1 CONNECTION

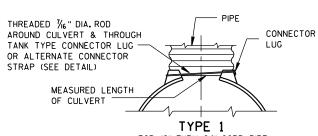

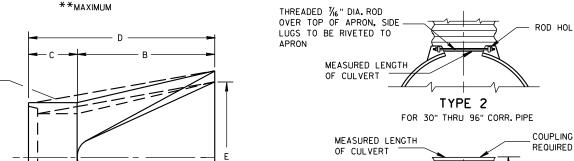

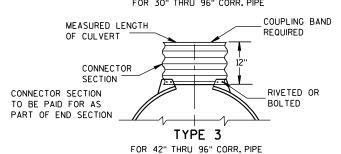

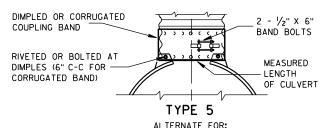


FOR CIRCUMFERENTIALLY CORRUGATED PIPE USE ENDWALL CONNECTION DETAILS 1, 2, 3 OR 5

FOR HELICALLY CORRUGATED PIPE USE ENDWALL

FOR HELICALLY CORRUGATED PIPES WITH TWO CIRCUMFERENTIAL CORRUGATIONS AT EACH END USE ENDWALL CONNECTION DETAILS 1, 2 OR 3.

CONNECTION DETAILS

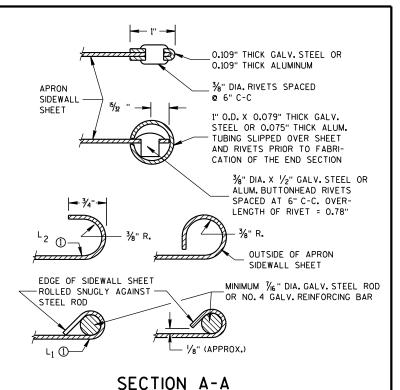

GENERAL NOTES

DETAILS OF CONSTRUCTION, MATERIALS AND WORKMANSHIP NOT SHOWN ON THIS DRAWING SHALL CONFORM TO THE PERTINENT REQUIREMENTS OF THE STANDARD SPECIFICATIONS AND THE APPLICABLE SPECIAL PROVISIONS.

CONCRETE CULVERT ENDWALLS MAY NOT BE USED WITH GALVANIZED STEEL OR ALUMINUM CULVERT PIPE OR VISE VERSA, GALVANIZED STEEL OR ALUMINUM ENDWALLS SHALL NORMALLY BE INSTALLED ON CULVERT PIPE OF THE SAME METAL.

ALL THREE PIECE STEEL APRON ENDWALLS FOR 60" DIAMETER PIPE AND LARGER SHALL HAVE 0.109" SIDES AND 0.138" CENTER PANELS. ALL THREE PIECE ALUMINUM APRON ENDWALLS FOR 60" DIAMETER PIPE AND LARGER SHALL HAVE 0.105" SIDES AND 0.134" CENTER PANELS. THE WIDTH OF CENTER PANELS SHALL BE GREATER THAN 20 PERCENT OF THE PIPE

LAP SEAMS SHALL BE TIGHTLY JOINED BY GALVANIZED RIVETS OR BOLTS FOR STEEL UNITS AND ALUMINUM RIVETS AND BOLTS FOR ALUMINUM UNITS. FOR THE 60" THROUGH 96" DIAMETER APRON ENDWALL SIZES. THE REINFORCED EDGES AND CENTER PANEL SEAMS SHALL BE FURTHER REINFORCED WITH GALVANIZED STEEL OR ALUMINUM STIFFENER ANGLES. THE ANGLES SHALL BE ATTACHED BY GALVANIZED NUTS AND BOLTS FOR STEEL UNITS AND ALUMINUM NUTS AND BOLTS FOR ALUMINUM UNITS.

WHERE TWO OR MORE PIPES WITH APRON ENDWALLS ARE LAID ADJACENT TO EACH OTHER, THEY SHALL BE SEPARATED BY A DISTANCE SUFFICIENT TO PROVIDE A MINIMUM CLEARANCE OF 6 INCHES BETWEEN APRON ENDWALLS.

(1) FOR PIPE SIZES UP TO 60" DIAMETER, A 180° ROLLED EDGE MAY BE USED INSTEAD OF STEEL ROD REINFORCEMENT. SEE SECTION A-A.

APRON ENDWALLS FOR CULVERT PIPE

STATE OF WISCONSIN DEPARTMENT OF TRANSPORTATION

11/30/94 /S/ Rory L. Rhinesmith CHIEF ROADWAY DEVELOPMENT ENGINEER

END CORNER

1/16" DIA. HOLES FOR

BOLTS OR RIVETS -

12" C-C MAX. SPACING



BRIDGE ROAD 1)TWO-WAY **CLOSED** TYPE "A" WARNING LIGHTS REQUIRED OUTSIDE EDGE OF SHOULDER OUTSIDE EDGE OF SHOULDER OR FACE OF CURB OR FACE OF CURB **DETAIL D**

ROAD CLOSURE BARRICADE DETAIL

APPROACH VIEW



LANE CLOSURE BARRICADE DETAIL

APPROACH VIEW

SEE SDD 15C2-SHEET "a" FOR LEGEND

GENERAL NOTES

THE EXACT NUMBER, LOCATION, AND SPACING OF ALL SIGNS AND BARRICADES SHALL BE ADJUSTED TO FIT FIELD CONDITIONS AS APPROVED BY THE ENGINEER.

ANY SIGNS TEMPORARY OR EXISTING, WHICH CONFLICT WITH TRAFFIC CONTROL "IN USE" SHALL BE REMOVED OR COVERED AS NEEDED AND AS APPROVED BY THE ENGINEER.

THE SPACING BETWEEN TRAFFIC CONTROL SIGNS SHOULD BE ADJUSTED TO NOT CONFLICT WITH AND SHOULD PROVIDE A DESIRABLE MINIMUM OF 200 FEET CLEARANCE TO EXISTING SIGNS THAT WILL REMAIN IN PLACE.

BARRICADES THAT MUST BE MOVED FOR A WORK OPERATION SHALL BE IMMEDIATELY RE-ESTABLISHED UPON COMPLETION OF THE OPERATION OR, FOR CONTINUING OPERATIONS, AT THE END OF EACH WORKING DAY.

SIGNS THAT WILL BE IN PLACE LESS THAN 7 CONTINUOUS DAYS AND NIGHTS MAY BE MOUNTED ON PORTABLE SUPPORTS.

ALL TYPE III BARRICADES SHALL HAVE RAILS REFLECTORIZED ON BOTH FACES. STRIPES SHALL BE PROPERLY SLOPED DOWN TOWARD THE TRAFFIC SIDE OR AS SHOWN IN THE ROAD CLOSURE BARRICADE DETAIL D FOR FULL ROAD CLOSURES.

TYPE "A" LOW-INTENSITY FLASHING WARNING LIGHTS SHALL BE VISIBLE ON BOTH SIDES OF THE

THE R11-2, R11-3, M4-9, R11-4 AND R10-61 SIGNS PLACED ON BARRICADES SHALL COVER NO MORE THAN THE TOP RAIL. THE SIGNS SHALL NOT COVER ANY PORTION OF THE MIDDLE OR BOTTOM RAILS.

"WO AND "MO" SIGNS ARE THE SAME AS "W" AND "M" SIGNS EXCEPT THE BACKGROUND IS ORANGE.

ALL SIGNS SHALL BE 48" X 48" UNLESS OTHERWISE NOTED BELOW:

R11-2 SHALL BE 48" X 30". R11-3, R11-4 AND R10-61 SHALL BE 60" X 30". M4-9 SHALL BE 30" X 24". M3-X SHALL BE 24" X 12". (36" X 18" IF NEEDED TO MATCH EXISTING SIGNS.) M4-8 SHALL BE 24" X 12". (30" X 15" IF NEEDED TO MATCH EXISTING SIGNS.)

M1-4, M1-5A, AND M1-6 SHALL BE 24" X 24". (36" X 36" IF NEEDED TO MATCH EXISTING SIGNS.) MO5-1 AND MO6-1 SHALL BE 21" X 21". (30" X 30" IF NEEDED TO MATCH EXISTING SIGNS.) D1-X SHALL BE AS SHOWN ON SPECIFIC PROJECT SIGNING DETAIL SHEETS. R1-1 SHALL BE 36" X 36".

- (1) TWO WARNING LIGHTS SHALL BE PROVIDED ON THE CENTER BARRICADE AND A MINIMUM OF ONE WARNING LIGHT SHALL BE PROVIDED ON EACH OF THE OTHER BARRICADES WITHIN THE ROADWAY LIMITS. SPACING OF THE WARNING LIGHTS SHALL BE UNIFORM TO THE EDGE OF ROADWAY AS SHOWN (APPROX. 8-FOOT
- THESE SIGNS AND BARRICADES ARE NOT REQUIRED IF ROAD CLOSURE BEGINS AT INTERSECTION.
- FOR ROAD CLOSURE WITHOUT LOCAL ACCESS TO PROJECT, SEE ROAD CLOSURE BARRICADE DETAIL D.
- FOR ROAD CLOSURE WITH LOCAL ACCESS TO PROJECT, SEE LANE CLOSURE BARRICADE DETAIL E.
- FOR BRIDGE OR CULVERT REPLACEMENTS, SUBSTITUTE "BRIDGE OUT" INSTEAD OF "ROAD CLOSED" ON R11-2 AND R11-3 SIGNS.
- INSTALL DETOUR AND COMMUNITY GUIDE SIGNS AND ARROWS ONLY IF SPECIFIED IN THE CONTRACT. IF THERE ARE EXISTING ROUTE MARKER ASSEMBLIES THAT WILL REMAIN IN PLACE, ADJUST THE LOCATION OF THE DETOUR ROUTE SIGNS TO CORRESPOND WITH THE EXISTING ASSEMBLIES. MODIFY EXISTING SIGNS WHERE POSSIBLE. SEE SPECIFIC PROJECT DETOUR SIGNING DETAIL SHEETS. IF DETOUR SIGNS ARE BEING INSTALLED BY OTHERS. PLACE THE CONTRACTED TRAFFIC CONTROL SIGNS TO ALLOW FOR PLACEMENT OF ALL WARNING, DETOUR AND GUIDE SIGNS AS SHOWN.
- "EAST" CARDINAL DIRECTION MARKERS AND RIGHT TURN ARROWS ARE SHOWN. USE OTHER CARDINAL DIRECTIONS AND ARROWS AS APPROPRIATE.

BARRICADES AND SIGNS FOR MAINLINE CLOSURES

STATE OF WISCONSIN DEPARTMENT OF TRANSPORTATION

/S/ Travis Feltes STATE TRAFFIC ENGINEER OF DESIGN

2

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GENERAL NOTES

THE EXACT NUMBER, LOCATION, AND SPACING OF ALL SIGNS AND BARRICADES SHALL BE ADJUSTED TO FIT FIELD CONDITIONS AS APPROVED BY THE ENGINEER.

ANY SIGNS TEMPORARY OR EXISTING, WHICH CONFLICT WITH TRAFFIC CONTROL "IN USE" SHALL BE REMOVED OR COVERED AS NEEDED AND AS APPROVED BY THE ENGINEER.

THE SPACING BETWEEN TRAFFIC CONTROL SIGNS SHOULD BE ADJUSTED TO NOT CONFLICT WITH AND SHOULD PROVIDE A DESIRABLE MINIMUM OF 200 FEET CLEARANCE TO EXISTING SIGNS THAT WILL REMAIN IN PLACE.

IF A "STOP" SIGN MUST BE REMOVED FOR A WORK OPERATION, A TEMPORARY "STOP" SIGN SHALL BE PLACED PRIOR TO THE SIGN REMOVAL, OR A FLAGGER SHALL BE PROVIDED UNTIL THE SIGN IS RE-ESTABLISHED.

BARRICADES THAT MUST BE MOVED FOR A WORK OPERATION SHALL BE IMMEDIATELY RE-ESTABLISHED UPON COMPLETION OF THE OPERATION OR, FOR CONTINUING OPERATIONS, AT THE END OF EACH WORKING DAY.

SIGNS THAT WILL BE IN PLACE LESS THAN 7 CONTINUOUS DAYS AND NIGHTS MAY BE MOUNTED ON PORTABLE SUPPORTS.

ALL TYPE III BARRICADES SHALL HAVE RAILS REFLECTORIZED ON BOTH FACES. STRIPES SHALL BE PROPERLY SLOPED DOWN TOWARD THE TRAFFIC SIDE OR AS SHOWN IN THE ROAD CLOSURE BARRICADE DETAIL D FOR FULL ROAD CLOSURES.

TYPE "A" LOW-INTENSITY FLASHING WARNING LIGHTS SHALL BE VISIBLE ON BOTH SIDES OF THE BARRICADE.

THE R11-2, R11-3 AND R11-4 SIGNS PLACED ON BARRICADES SHALL COVER NO MORE THAN THE TOP RAIL. THE SIGNS SHALL NOT COVER ANY PORTION OF THE MIDDLE OR BOTTOM RAILS.

ALL SIGNS SHALL BE 48" X 48" UNLESS OTHERWISE NOTED BELOW:
RI1-2 SHALL BE 48" X 30".
RI1-4 AND RI1-3 SHALL BE 60" X 30".

*OMIT THE "ROAD CLOSED 500 FT." SIGN IF THE LAST INTERSECTION IS 500 FT. OR LESS FROM THE WORK ZONE.

**500' MAX. OR AT LAST INTERSECTION WHICHEVER IS CLOSER.

LEGEND

SIGN ON PERMANENT SUPPORT

TYPE III BARRICADE

TYPE III BARRICADE WITH
ATTACHED SIGN

(A) TYPE "A" WARNING LIGHT (FLASHING)

//// w

WORK AREA

BARRICADES AND SIGNS FOR SIDEROAD CLOSURES

STATE OF WISCONSIN
DEPARTMENT OF TRANSPORTATION

APPROVED


8/2013 /S/ Travis Feltes

DATE STATE TRAFFIC ENGINEER OF DESIGN


S.D.D. 15 C 3-2




URBAN ARFA

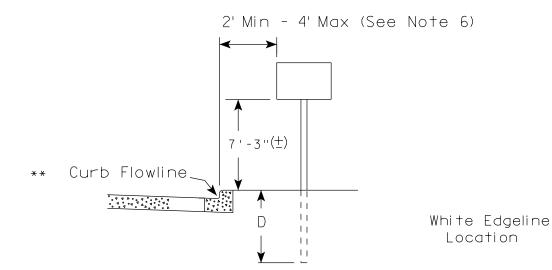

RURAL AREA (See Note 2)

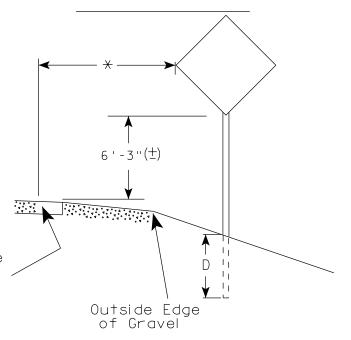

2' Min - 4' Max (See Note 6)

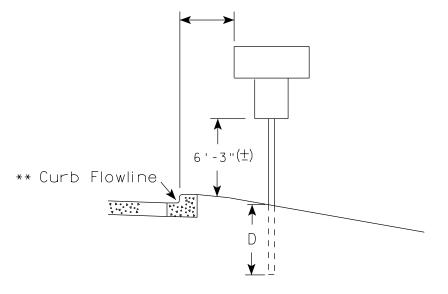

5'-3"(生) White Edgeline D^{-1} Location Outside Edae of Gravel

** The existence of curb and gutter does not in itself mandate the vertical clearance illustrated. That height is typically measured where there is sidewalk adjacent to the roadway

or parking is permitted. In the absence of sidewalk vertical clearance is measured from the top of the curb. Offset of signs is measured from the flow line.

* 6 feet from edge of a paved shoulder or 12 feet from the edge of pavement (edge line location) or 2 feet from outside edge of gravel, whichever is greater unless directed by project engineer.

GENERAL NOTES

- 1. Signs wider than 4 feet, 20 sq.ft or larger, shall be mounted on multiple posts. Refer to plate A4-4.
- 2. If signs are mounted on barrier wall, see A4-10 sign plate.
- 3. For expressways and freeways, mounting height is 7'- 3" (+) or 6'-3" (+) depending upon existence of a sub-sign.
- 4. Minimum mounting height for J assemblies (A4-5) is $7'-3''(\pm)$ or $6'-3''(\pm)$ per urban or rural detail respectively.
- 5. Minimum mounting height for signs mounted on traffic signal poles is 5' - 3" (+).
- 6. Offset distance shall be consistent with existing signs or consistent throughout length of project.
- 7. The (+) tolerance for mounting height is 3 inches.
- 8. Folding stop signs (R1-1F) shall be mounted at a height of 5'-3" (+) or as directed by the Engineer.
- 9. The Double Arrow sign (W12-1) shall be mounted at a height of 2'-3'' (\pm). The Chevron sign (W1-8), Roundabout Chevron panel (R6-4B), Enhanced Reference Markers, Clearance Markers (W5-52), Mile Markers (D10 series) & End of Rod Markers (W5-56 & W5-56A) shall be mounted at a height of 4'-3" (+).

POST EMBEDMENT DEPTH

Area of Sign	
Installation	D
(Sq. Ft.)	(Min)
20 or Less	4'
Greater than 20	5'

TYPICAL INSTALLATION OF PERMANENT TYPE II SIGNS ON SINGLE POSTS

WISCONSIN DEPT OF TRANSPORTATION

APPROVED

for State Traffic Engineer

DATE 9/30/13

PROJECT NO: 5318-00-72 FILE NAME : C:\CAEfiles\Projects\tr_stdplate\A43.DGN HWY: PATTERSON ROAD

COUNTY: GREEN

SIGN DETAILS


PLOT BY: mscj9h

PLOT DATE: 30-SEP-2013 13:25

PLOT NAME :

PLOT SCALE: 99.237937:1.000000

SHEET NO: WISDOT/CADDS SHEET 42

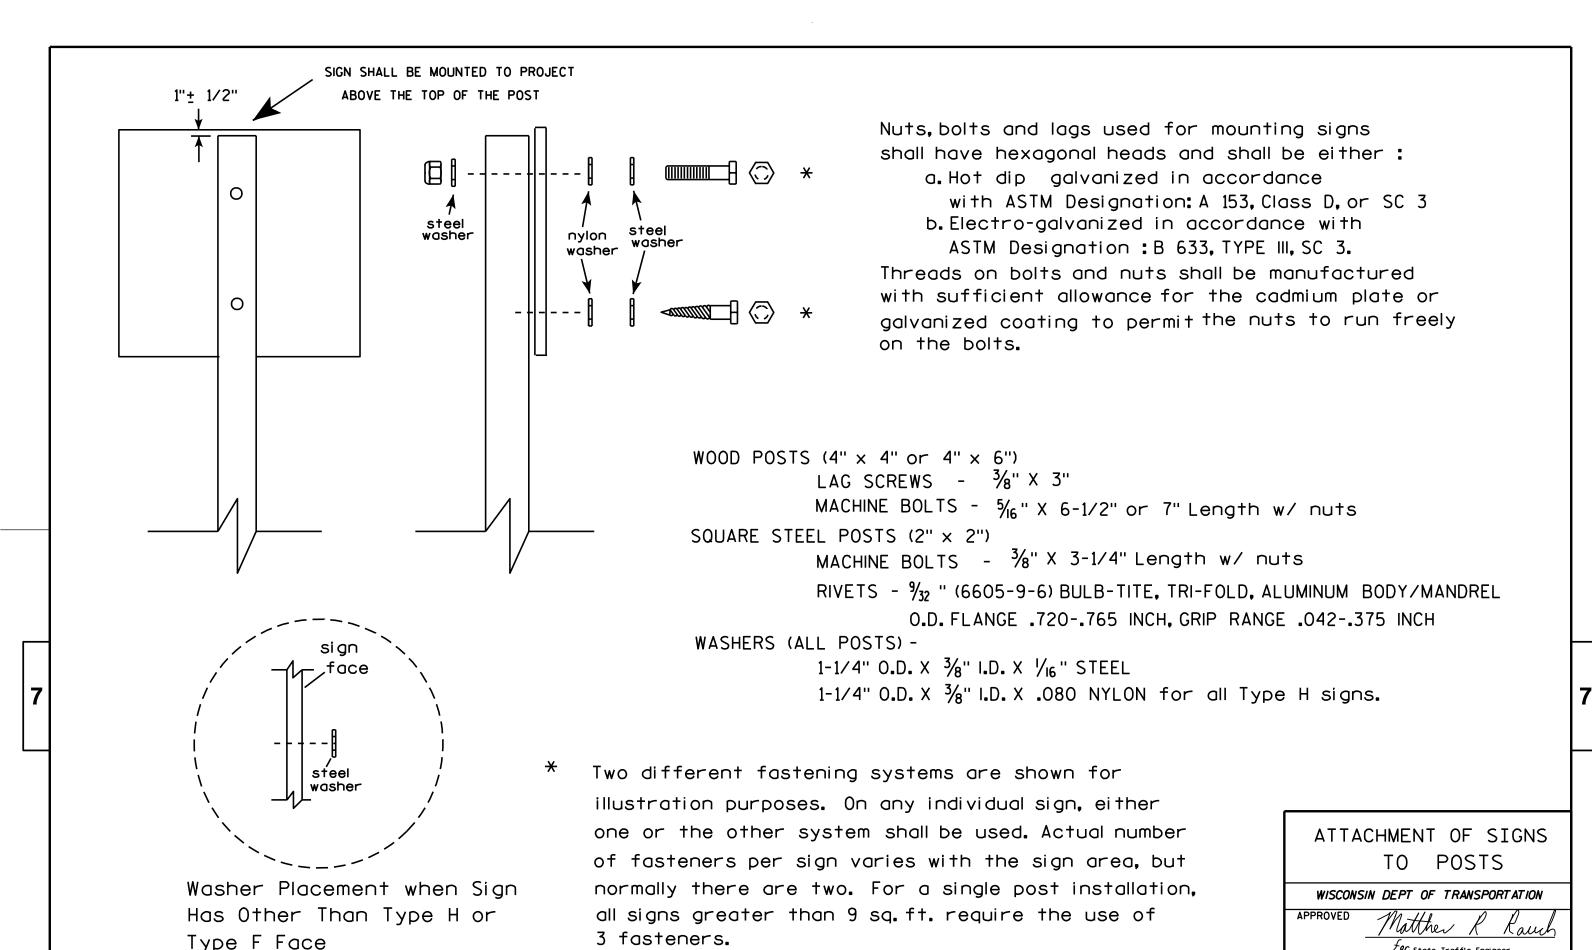



PROJECT NO: 5318-00-72 **HWY: PATTERSON ROAD COUNTY: GREEN** SIGN DETAILS SHEET NO: FILE NAME : C:\Users\PROJECTS\tr_stdplate\A48.DGN PLOT DATE: 23-MAR-2010 10:15 PLOT BY : dit iph WISDOT/CADDS SHEET 42

For State Traffic Engineer

PLATE NO. 44-8.7

DATE 3/23/10

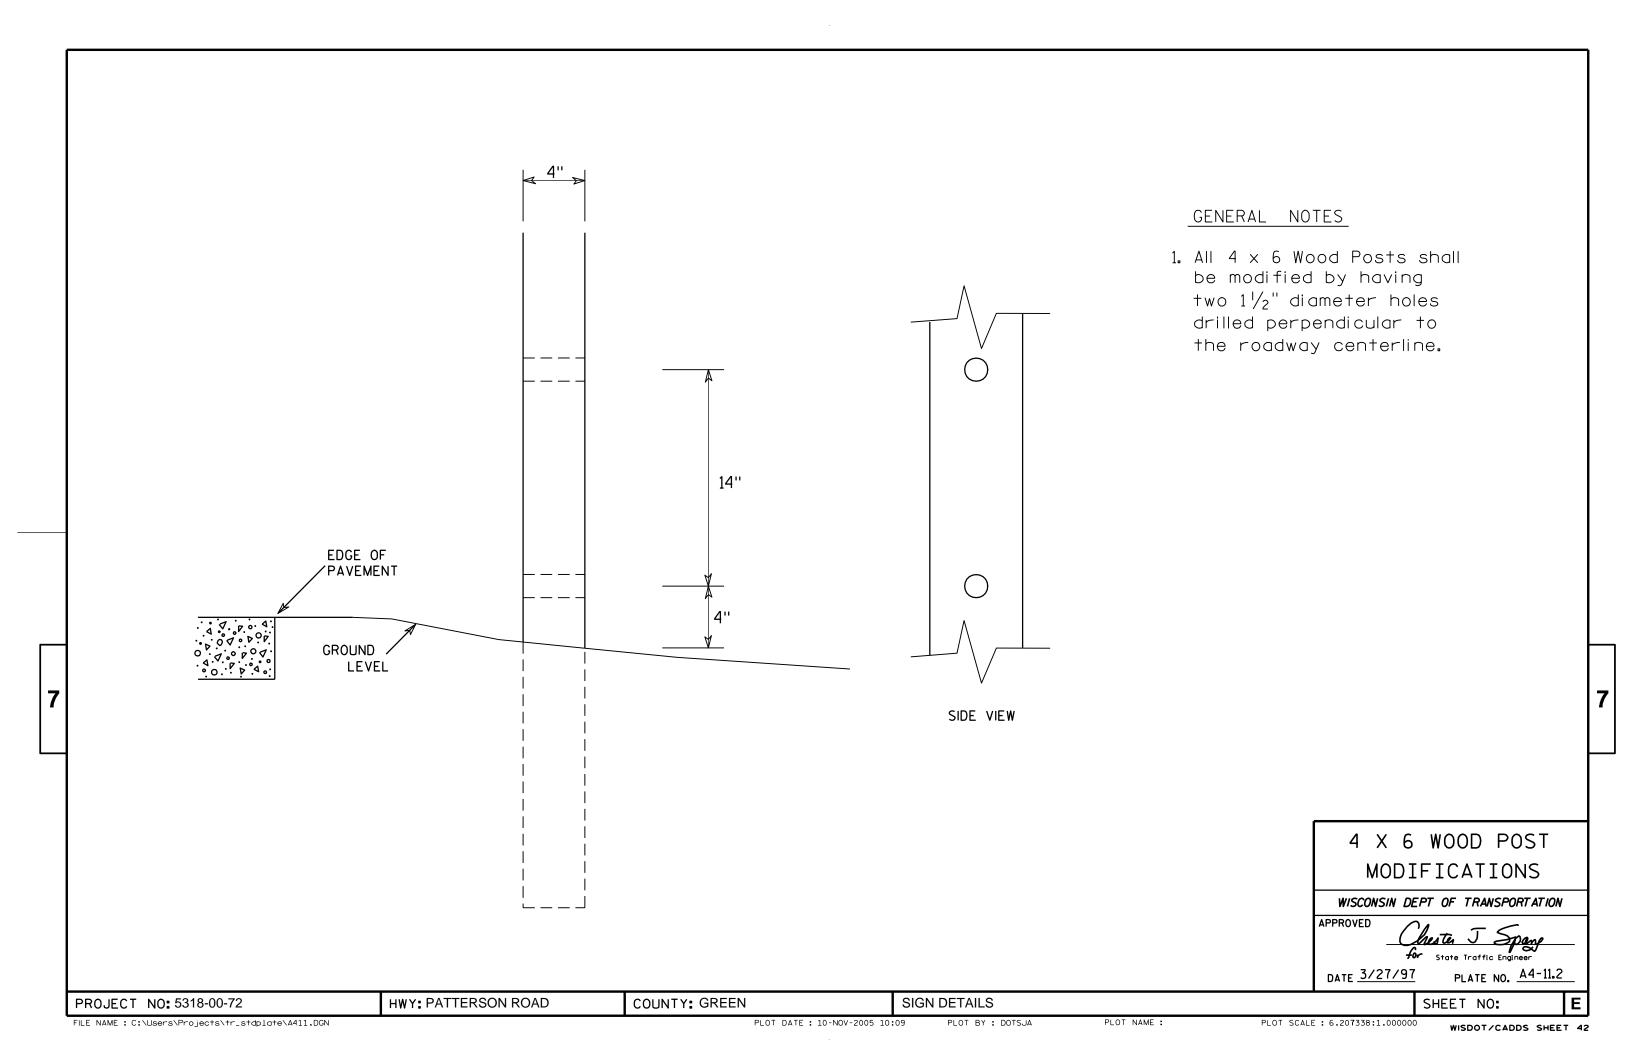

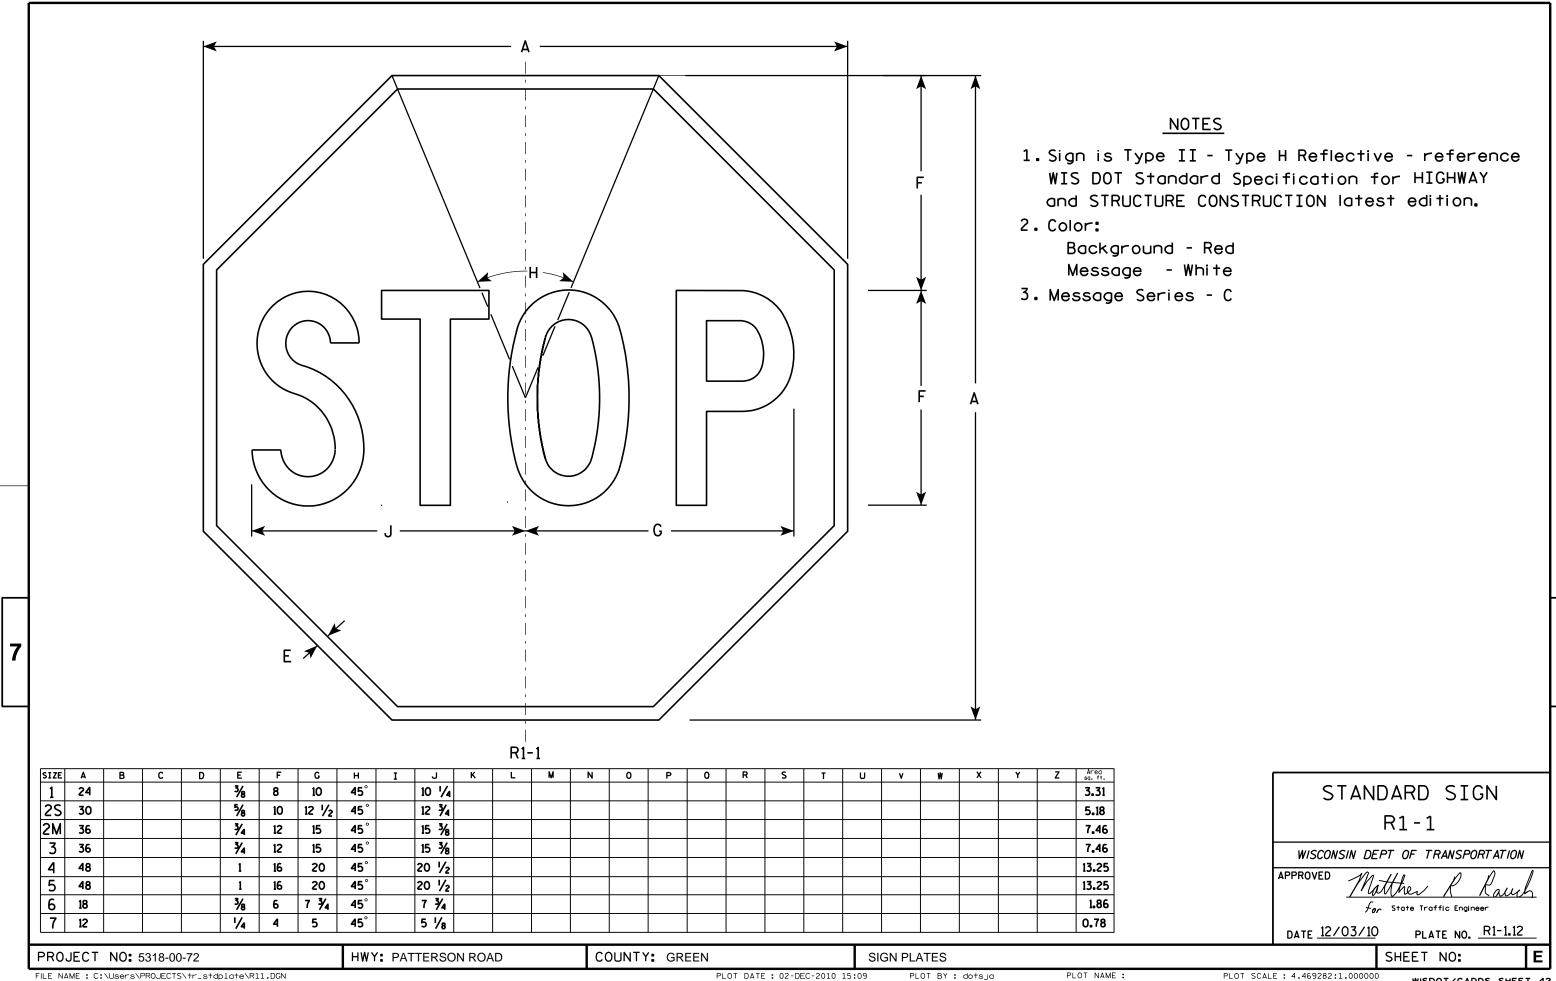

PLOT DATE: 02-DEC-2010 15:09


PLOT SCALE: 4.469282:1.000000

NOTES

- 1. Sign is Type II Type F Reflective reference WIS DOT Standard Specification for HIGHWAY and STRUCTURE CONSTRUCTION latest edition.
- 2. Color:

Background - Yellow Message - Black

- 3. Corners may be square or rounded when base material is plywood but borders shall be rounded as shown. When base material is metal, the corners and borders shall be rounded.
- 4. W1-2L is the same as W1-2R except the arrow is reversed along the vertical centerline.

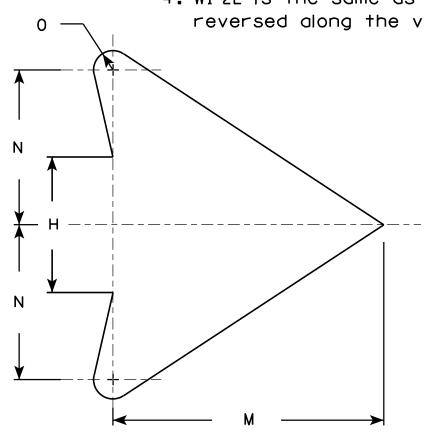

ARROW DETAIL	OW DETAIL
--------------	-----------

PLOT NAME :

	W1-2K																										
SIZE	Ε Α	В	С	D	E	F	G	Н	I	J	K	L	M	N	0	Р	0	R	S	Т	U	V	W	X	Y	Z	Areg sq. ft.
1	24		1 1/8	3/8	1/2		8 1/4	3 1/2	4 1/2	1 3/4	2 3/8	7 1/4	7	4	1/2												4.0
25	30		1 3/8	1/2	5/8		10 1/4	4 3/8	5 %	2 1/4	3	9 1/8	8 3/4	5	5/8												6.25
2N	36		1 %	5/8	3/4		12 3/8	5 1/4	6 3/4	2 %	3 1/2	10 %	10 1/2	6	3/4												9.0
3	36		1 %	5⁄8	3/4		12 3/8	5 1/4	6 3/4	2 %	3 1/2	10 %	10 1/2	6	3/4												9.0
4	36		1 %	5/8	3/4		12 3/8	5 1/4	6 3/4	2 %	3 1/2	10 %	10 1/2	6	3/4												9.0
5	48		2 1/4	3/4	1		16 1/2	7	9	3 1/2	4 %	14 1/2	14	8	1												16.0
	•	•	•			•		•	•	•	•	•		•	•	•		•		•		•			•	•	

STANDARD SIGN W1-2

WISCONSIN DEPT OF TRANSPORTATION

APPROVED

Matther R Rauch For State Traffic Engineer

DATE <u>5/15/12</u>

15/12 PLATE NO. W1-2.10

SHEET NO:

HWY: PATTERSON ROAD

W1-2R

← H →


COUNTY: GREEN

PLOT DATE: 15-MAY-2012 14:03

SIGN PLATES

PLOT SCALE: 6.202372:1.000000

PROJECT NO: 5318-00-72

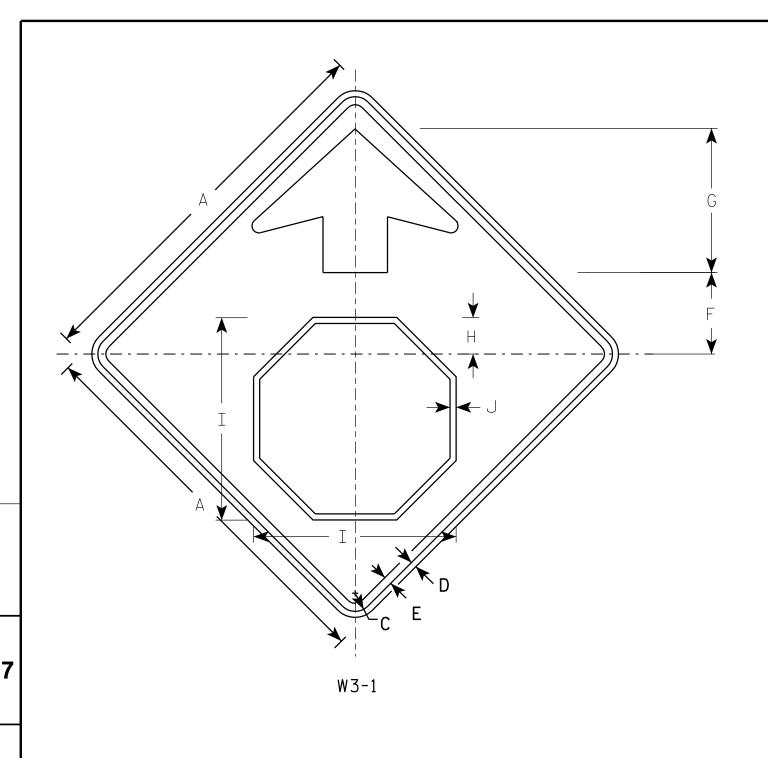

HWY: PATTERSON ROAD


<u>NOTES</u>

- 1. All Signs Type II Type F Reflective reference WIS DOT Standard Specification for HIGHWAY and STRUCTURE CONSTRUCTION latest edition.
- 2. Color:

Background - YELLOW

Arrow & Border - BLACK

Stop Symbol - WHITE BORDER ON RED BACKGROUND

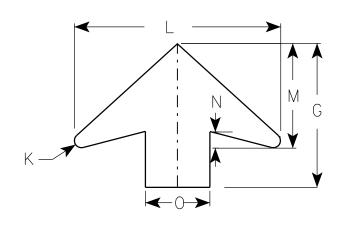

RROW	DETAIL

SIZE	Α	В	С	D	E	F	G	Н	I	J	K	L	М	N	0	P	0	R	S	Т	U	٧	W	X	Y	Z	Area sq. ft.
1	30		1 3/8	1/2	5/8	6 1/4	11 1/4	2 %	15 3/4	1/2	1/2	16	8	1 1/4	5												6.25
2S	36		1 %	5/8	3/4	7 1/2	13 1/2	3 1/2	19	5/8	5/8	19 1/4	9 3/4	1 %	6												9.0
2M	36		1 %	5/8	3/4	7 1/2	13 1/2	3 1/2	19	5/8	5/8	19 1/4	9 3/4	1 5/8	6												9.0
3	36		1 %	5/8	3/4	7 1/2	13 1/2	3 1/2	19	5/8	5/8	19 1/4	9 3/4	1 %	6												9.0
4	48		2 1/4	3/4	1	10	17 1/8	4 1/2	25 1/8	3/4	7 /8	25 %	13	2	8												16.0
5	48		2 1/4	3/4	1	10	17 1/8	4 1/2	25 1/8	3/4	½	25 %	13	2	8												16.0

COUNTY: GREEN

STANDARD SIGN W3-1

WISCONSIN DEPT OF TRANSPORTATION

SHEET NO:

APPROVED Matthew

For State To

For State Traffic Engineer

DATE 6/7/10 PLATE NO. W3-1.12

PLOT DATE: 07-JUN-2010 12:59

PLOT BY : ditjph

SIGN PLATES

FILE NAME : C:\Users\PROJECTS\tr_stdplate\W31.DGN

PROJECT NO: 5318-00-72

<u>NOTES</u>

1. Sign is Type II - Type F Reflective - reference WIS DOT Standard Specification for HIGHWAY and STRUCTURE CONSTRUCTION latest edition.

2. Color:

Background - Yellow Message - Black

- 3. Message Series C
- 4. Corners may be square or rounded when base material is plywood but borders shall be rounded as shown. When base material is metal, the corners and borders shall be rounded.

A	
TRAIL F	

Areg sq. ft. SIZE A С D Ε G H I 0 0 S w 1 1/8 2 3/8 6 1/8 10 3/4 24 3∕8 1/2 4.0 2S 30 1 3/8 1/2 5/8 3 7 3/4 13 3/8 6.25 2M 36 1 5/8 5/8 ₹4 3 1/2 9 1/4 16 9.0 3 1 % 5/8 36 ₹4 3 1/2 9 1/4 16 9.0 2 1/4 3/4 12 1/8 21 1/4 4 48 16.0

COUNTY: GREEN

HWY: PATTERSON ROAD

STANDARD SIGN W11-15A

WISCONSIN DEPT OF TRANSPORTATION

APPROVED

Matthew R

for State Traffic Engineer

DATE 12/21/10 PLATE NO. W11-15A.1

SHEET NO:

FILE NAME : C:\Users\PROJECTS\tr_stdplate\W1115A.DGN

PROJECT NO: 5318-00-72


PLOT DATE: 05-JAN-2011 08:51

SIGNS PLATES

PLOT BY: ditjph

PLOT NAME :

PLOT SCALE: 6.281820:1.000000

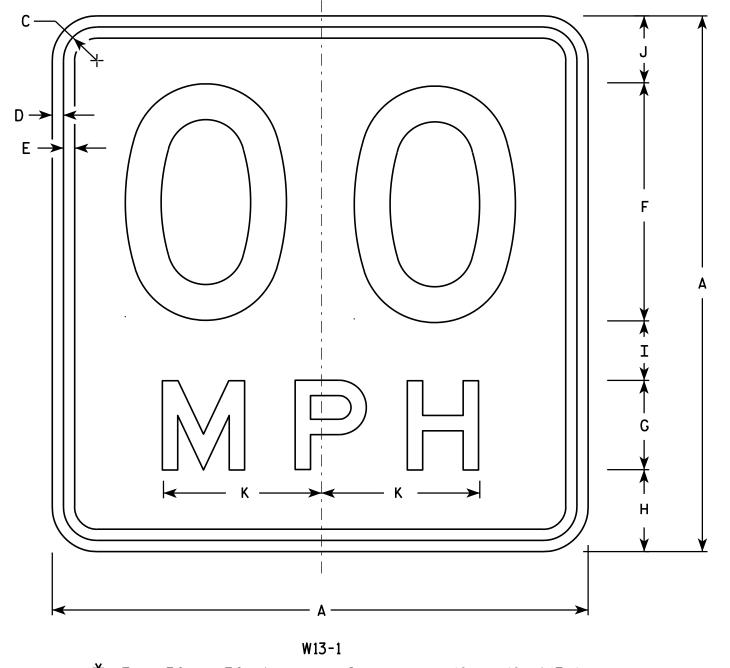

* For 30" x 30" Warning Signs, use 18" x 18" W13-1 signs.
For 36" x 36" Warning Signs, use 24" x 24" W13-1 signs.

HWY: PATTERSON ROAD

NOTES

- 1. Sign is Type II Type F Reflective reference WIS DOT Standard Specification for HIGHWAY and STRUCTURE CONSTRUCTION latest edition.
- 2. Color:

Background - Yellow Message - Black

- 3. Message Series See Note 6
- 4. Corners may be square or rounded when base material is plywood but borders shall be rounded as shown. When base material is metal, the corners and borders shall be rounded.
- 5. Substitute appropriate numerals and optically space about centerline to achieve proper balance.
- 6. Line 1 is Series D Line 2 is Series E

S	SIZE	Α	В	С	D	E	F	G	Н	I	J	К	L	М	N	0	Р	0	R	S	T	U	V	₩	X	Y	Z	Area sq. ft.
	1	18		1 1/8	3/8	3/8	8	3	2 3/4	2	2 1/4	5 3/8																2.25
 *[2S	18		1 1/8	3/8	3/8	8	3	2 3/4	2	2 1/4	5 3/8																2.25
 *[2	2M	18		1 1/8	3/8	3%	8	3	2 3/4	2	2 1/4	5 %																2.25
	3	24		1 1/8	3/8	1/2	10	4	4	2 3/4	3 1/4	6 %																4.00
	4	36		1 5/8	5/8	3/4	16	6	5 1/2	4	4 1/2	10 %																9.00
	5	36		1 5/8	5/8	3/4	16	6	5 1/2	4	4 1/2	10 %																9.00

COUNTY: GREEN

STANDARD SIGN W13-1

WISCONSIN DEPT OF TRANSPORTATION

APPROVED /

For State Traffic Engineer

DATE <u>5/31/12</u>

PLATE NO. W13-1.16

FILE NAME : C:\CAEFiles\Projects\tr_stdplate\W131.DGN

PROJECT NO: 5318-00-72

PLOT DATE: 31-MAY-2012 10:57

PLOT BY: mscsja

PLOT NAME :

SIGNS PLATES


PLOT SCALE: 3.225232:1.000000

NOTES

- 1. Sign is Type II Type F Reflective reference WIS DOT Standard Specification for HIGHWAY and STRUCTURE CONSTRUCTION latest edition.
- 2. Color:

Background - Yellow Message - Black

- 3. Message Series C
- 4. Corners may be square or rounded when base material is plywood but borders shall be rounded as shown. When base material is metal, the corners and borders shall be rounded.

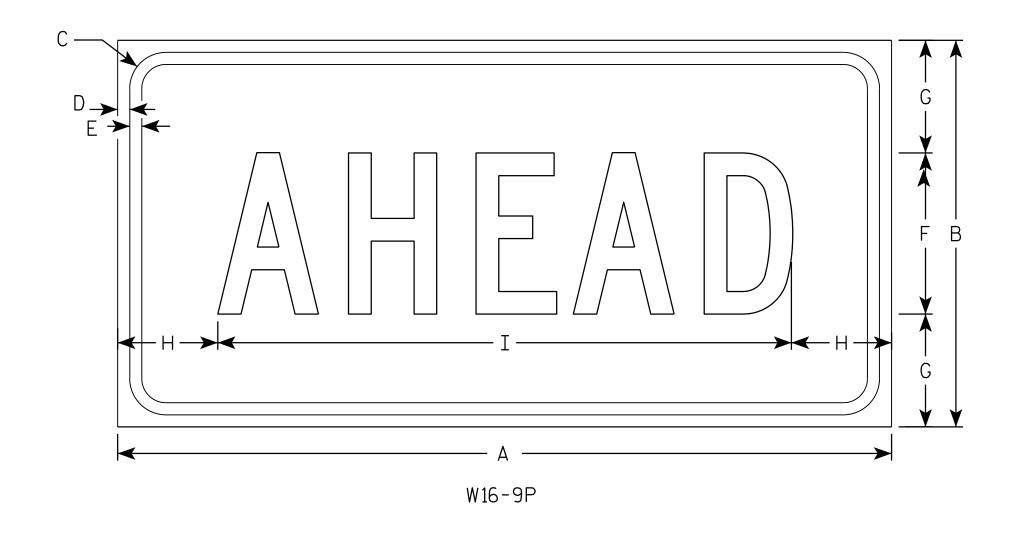

SIZE	Α	В	С	D	E	F	G	Н	I	J	K	L	М	N	0	Р	0	R	S	T	U	٧	₩	X	Y	Z	Areg sq. ft.
1																											
2S	24	12	1 1/8	3/8	3/8	5	3 1/2	3 1/8	17 3/4																		2.0
2M	30	18	1 1/8	3/8	1/2	7	5 1/2	2 3/4	24 1/2																		3.75
3	30	18	1 1/8	3/8	1/2	7	3 1/2	2 3/4	24 1/2																		3.75
4	48	24	1 3/8	1/2	5/8	10	7	6 1/8	35 ¾																		8.0
5																											

COUNTY: GREEN

HWY: PATTERSON ROAD

STANDARD SIGN W16-9P

WISCONSIN DEPT OF TRANSPORTATION

APPROVED

Matther R Rauch
For State Traffic Engineer

SHEET NO:

DATE 12/28/10

PLATE NO. W16-9P.6

FILE NAME : C:\Users\PROJECTS\tr_stdplate\W169P.DGN

PROJECT NO: 5318-00-72

PLOT DATE: 28-DEC-2010 13:39

PLOT BY : dotsja

SIGNS PLATES

PLOT NAME :

PLOT SCALE: 2.979524:1.000000

EARTHWORK DATA - PATTERSON ROAD

		END AREA			VOLUME		
STATION	COMMON	ROCK	FILL	COMMON	ROCK	FILL	MASS HAUL
	SF	SF	SF	CY	CY	CY	
13+50.00	0.00	0.00	0.00	0.00	0.00	0.00	0.00
14+00.00	73.15	0.00	0.00	67.73	0.00	0.00	67.73
14+50.00	165.58	0.00	0.00	221.05	0.00	0.00	288.78
14+79.00	194.92	0.00	0.00	193.60	0.00	0.00	482.38
15+00.00	231.59	0.00	0.00	165.87	0.00	0.00	648.24
15+50.00	348.80	0.00	0.00	537.40	0.00	0.00	1185.64
16+00.00	446.52	29.55	0.00	736.41	30.10	0.00	1922.05
16+50.00	472.48	120.20	0.00	850.93	152.52	0.00	2772.98
17+00.00	599.28	154.20	0.00	992.37	279.48	0.00	3765.35
17+49.90	794.90	176.10	0.00	1288.33	335.74	0.00	5053.67
18+00.00	1009.40	193.40	0.00	1673.99	377.10	0.00	6727.66
18+49.90	1136.99	211.10	0.00	1983.42	411.17	0.00	8711.08
19+00.00	1190.78	229.10	0.00	2159.65	449.25	0.00	10870.74
19+50.00	1331.94	415.60	0.00	2335.85	656.64	0.00	13206.59
20+00.00	9.98	32.70	93.05	1242.52	456.60	107.70	14341.41
20+50.00	1028.98	283.70	0.00	962.00	322.26	107.70	15195.72
21+00.00	595.68	317.00	0.00	1504.31	611.82	0.00	16700.03
21+50.00	371.17	211.00	0.00	895.23	537.78	0.00	17595.26
22+00.00	342.83	54.60	0.00	661.11	270.52	0.00	18256.37
22+50.00	278.05	0.00	0.00	574.89	55.61	0.00	18831.26
23+00.00	180.72	0.00	0.00	424.79	0.00	0.00	19256.05
23+50.00	159.69	0.00	0.00	315.19	0.00	0.00	19571.24
23+62.00	172.49	0.00	0.00	73.82	0.00	0.00	19645.06
24+00.00	161.27	0.00	0.00	234.87	0.00	0.00	19879.93
24+50.00	0.00	0.00	0.00	149.32	0.00	0.00	20029.25


EARTHWORK DATA - TRAIL


			AINT I I I VOINT L	7A I A - I IVAIL			
		END AREA			VOLUME		
STATION	COMMON	ROCK	FILL	COMMON	ROCK	FILL	MASS HAU
	SF	SF	SF	CY	CY	CY	
101+50.00	0.00	0.00	0.00	0.00	0.00	0.00	0.00
102+00.00	88.62	98.45	1.27	82.06	100.27	1.47	80.59
102+50.00	483.40	255.89	16.03	529.65	360.90	20.02	590.21
102+84.51	0.00	0.00	0.00	308.93	179.89	12.81	886.33
103+00.00	0.00	0.00	47.11	0.00	0.00	16.89	869.44
103+50.00	141.21	39.76	38.84	130.75	40.50	99.48	900.71
104+00.00	94.55	77.50	9.99	218.30	119.43	56.52	1062.49
104+50.00	36.71	76.60	0.00	121.54	156.95	11.56	1172.47
105+00.00	0.00	0.00	0.00	33.99	78.02	0.00	1206.46


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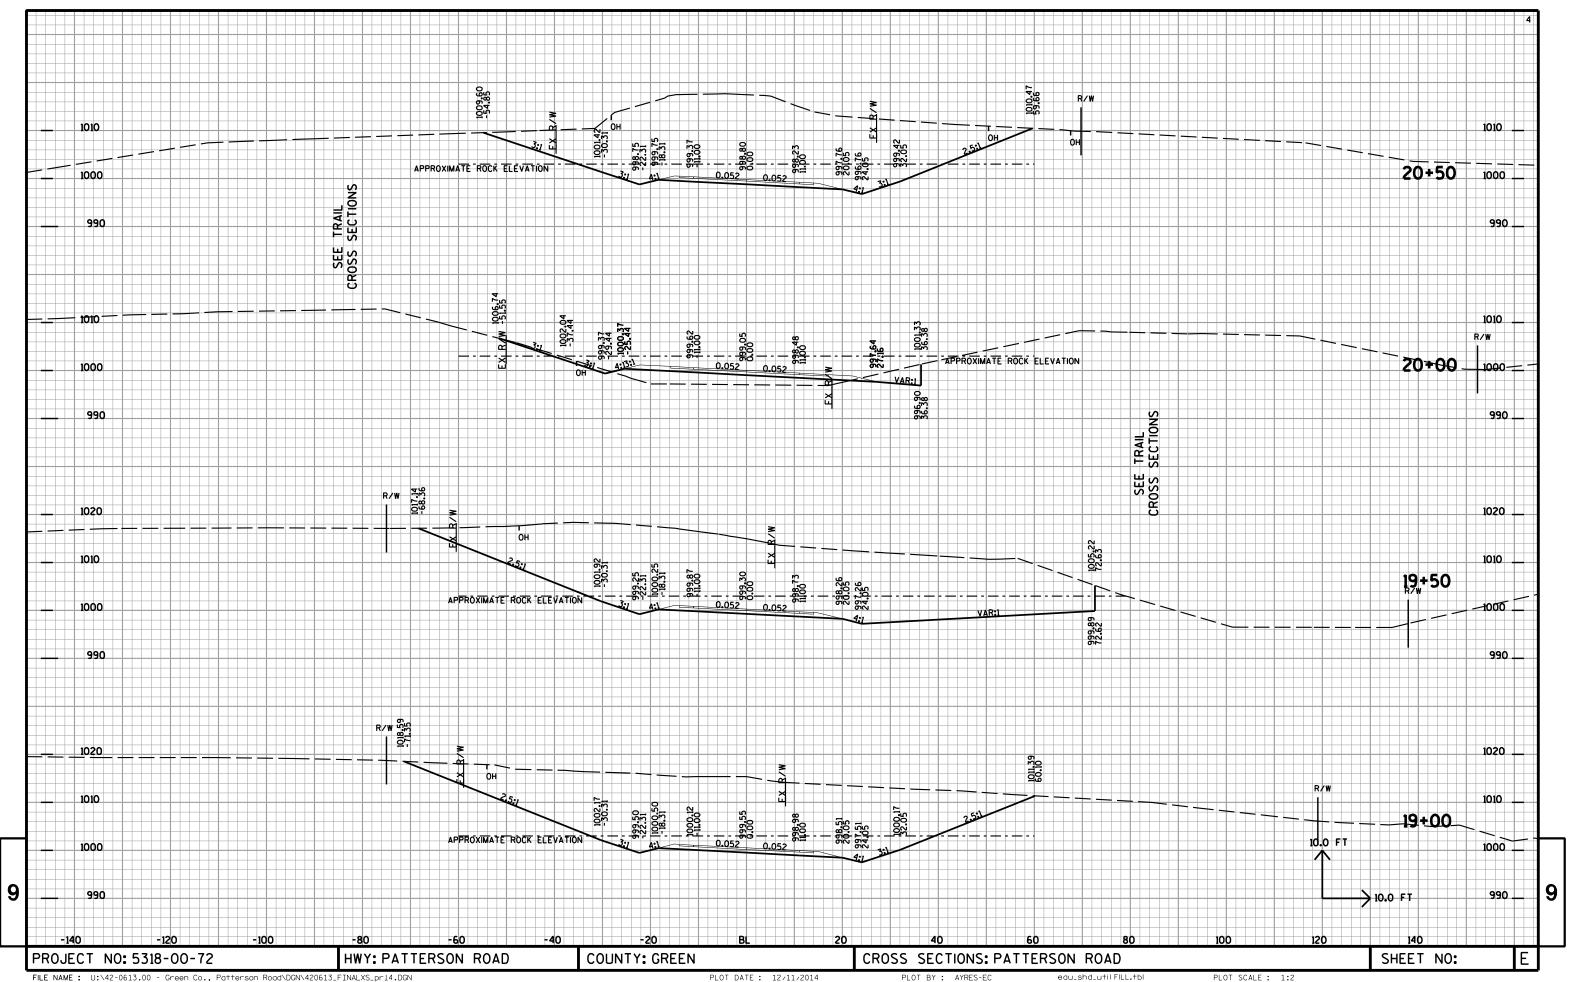
9


PROJECT NO: 5318-00-72 HWY: PATTERSON ROAD COUNTY: GREEN EARTHWORK DATA SHEET E




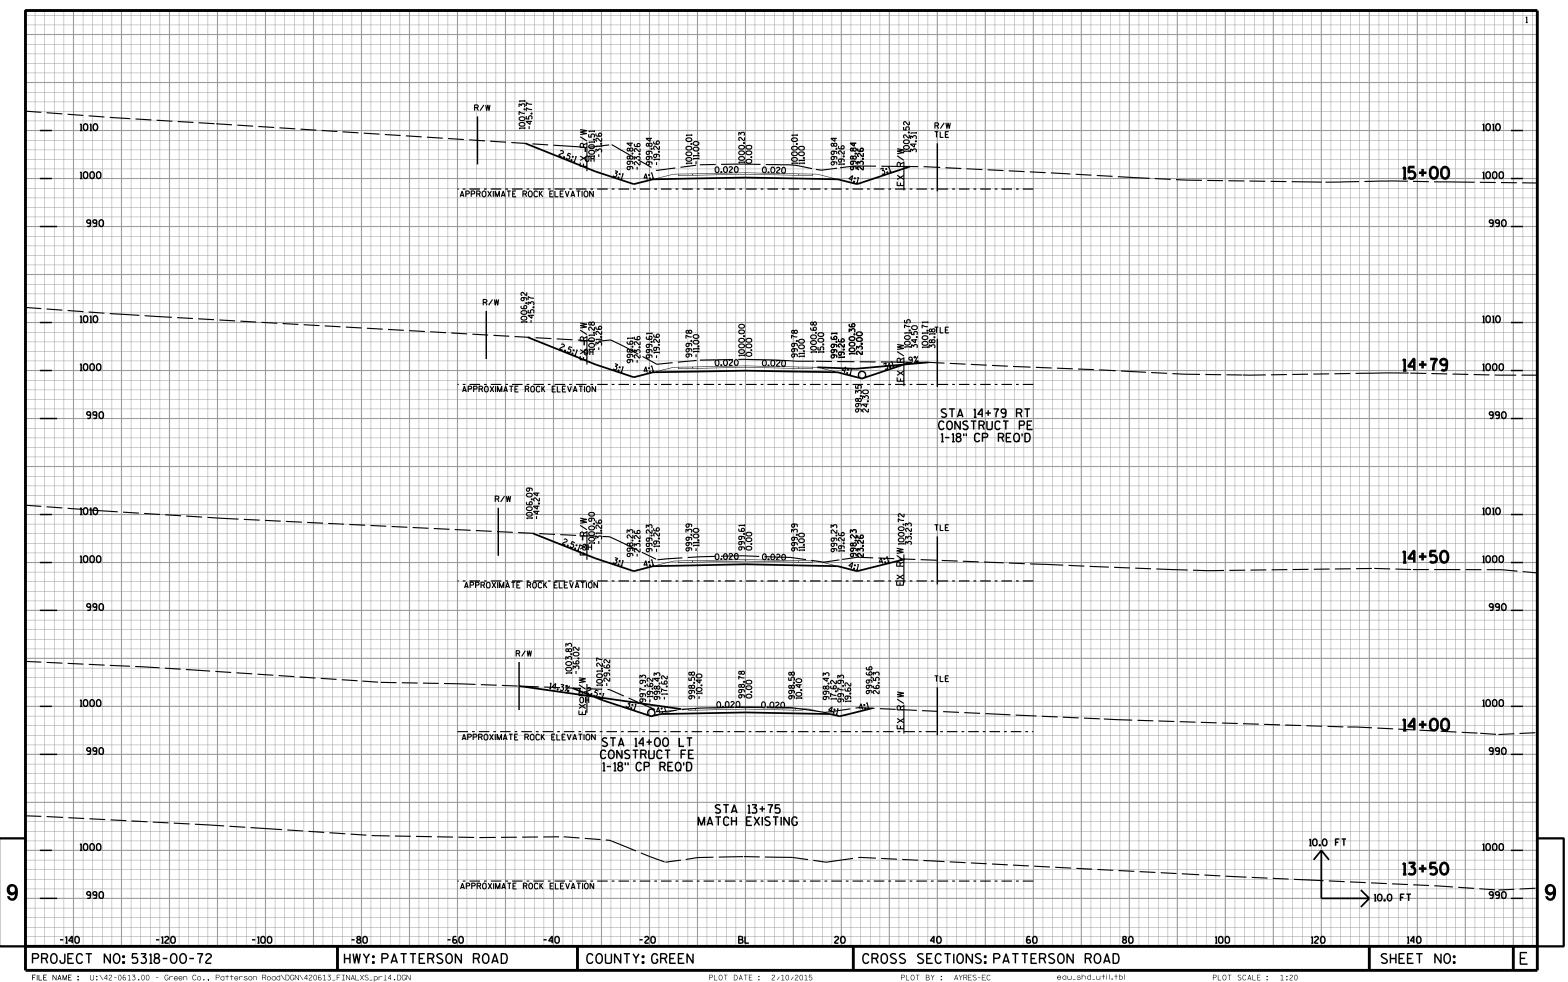


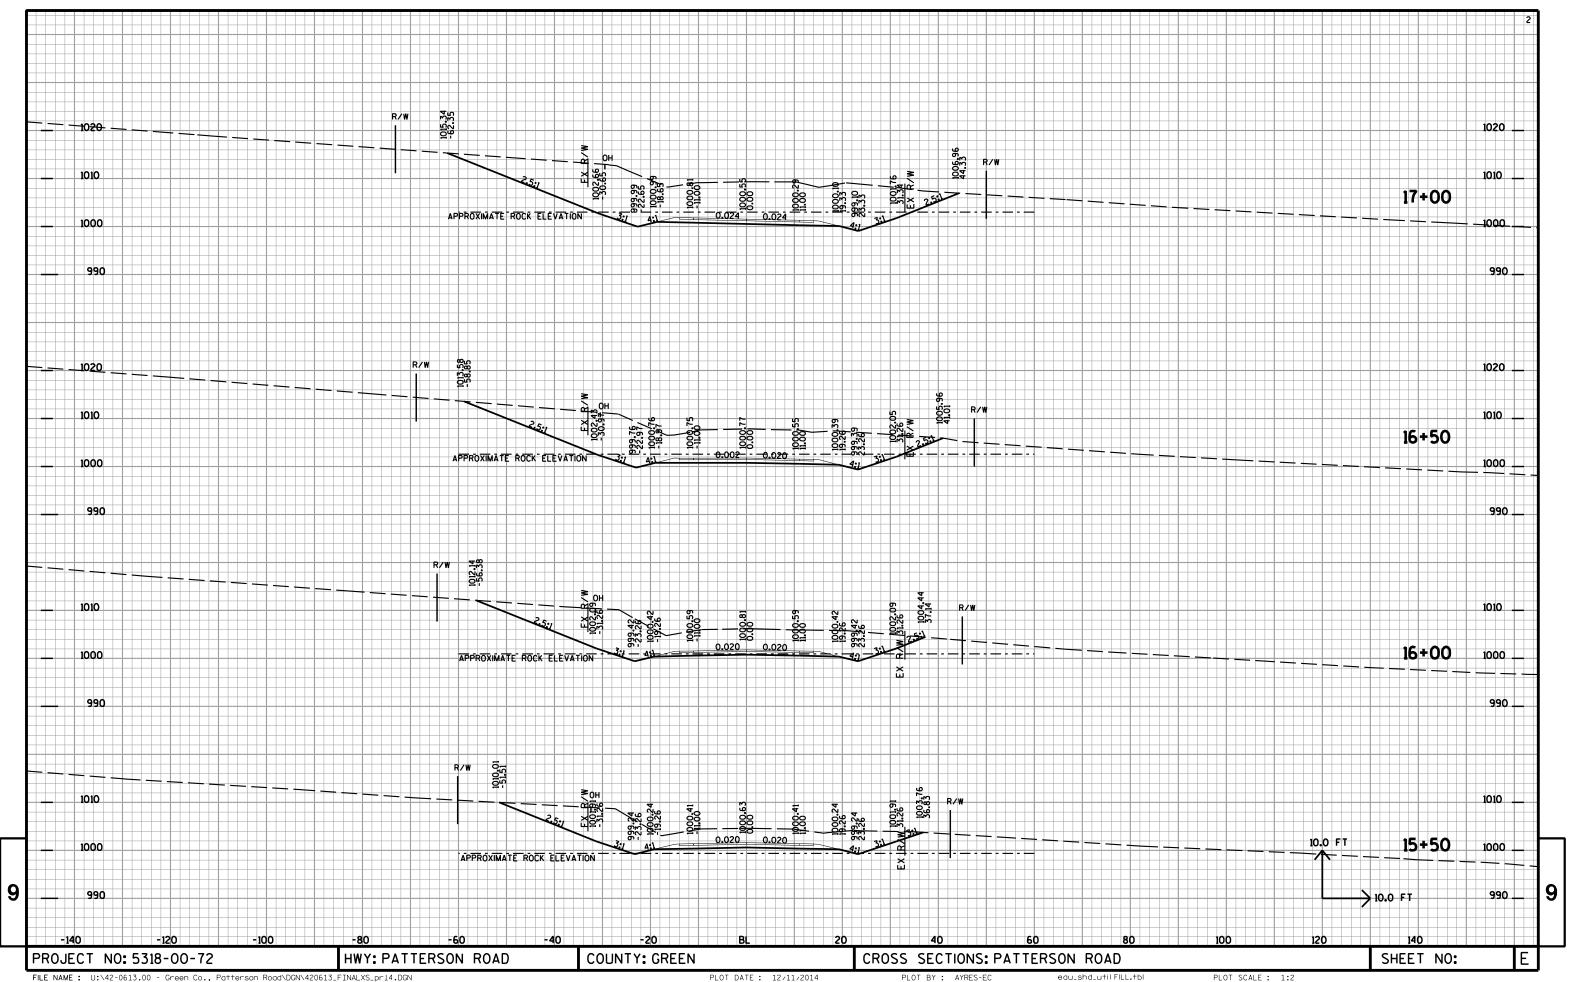


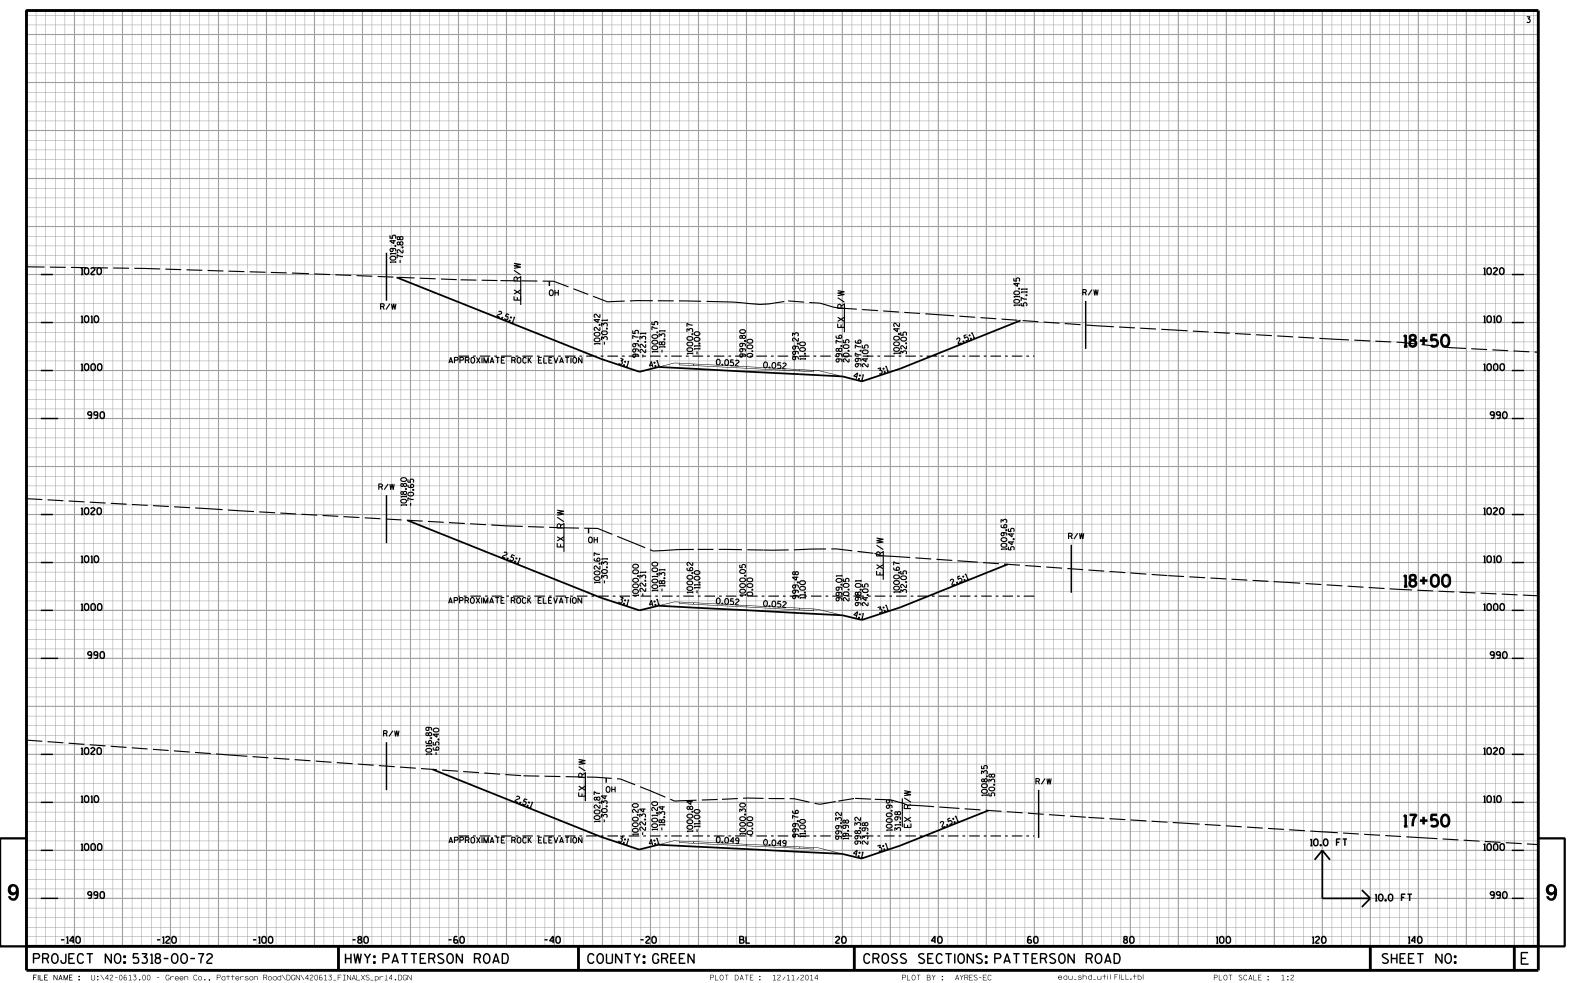


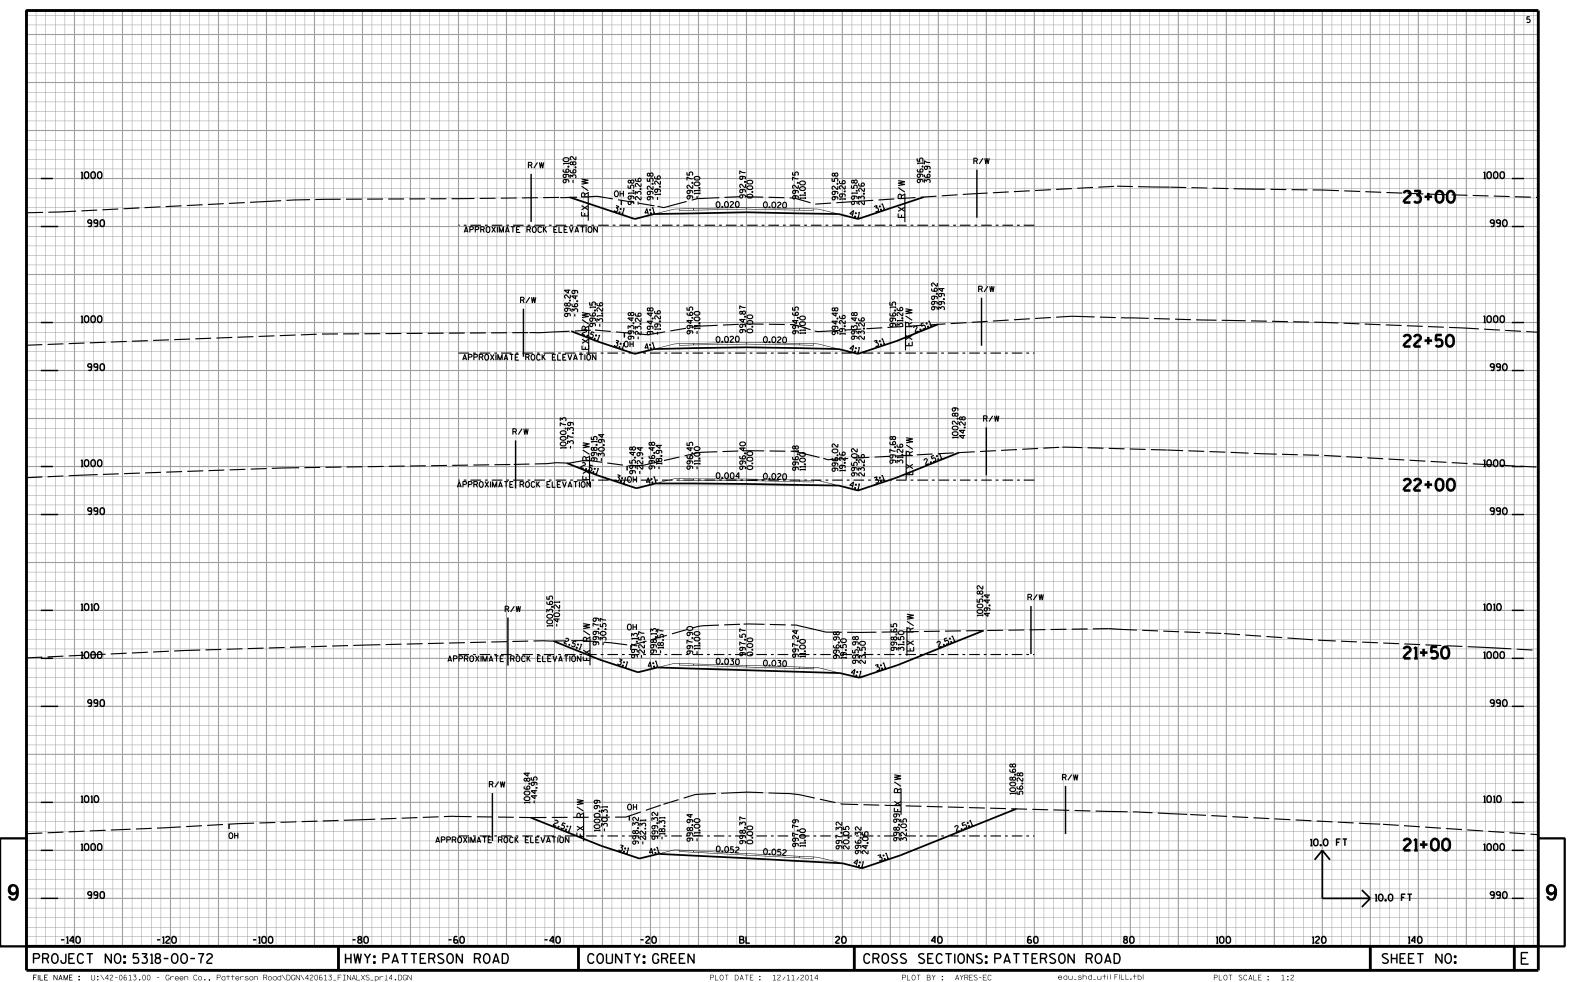

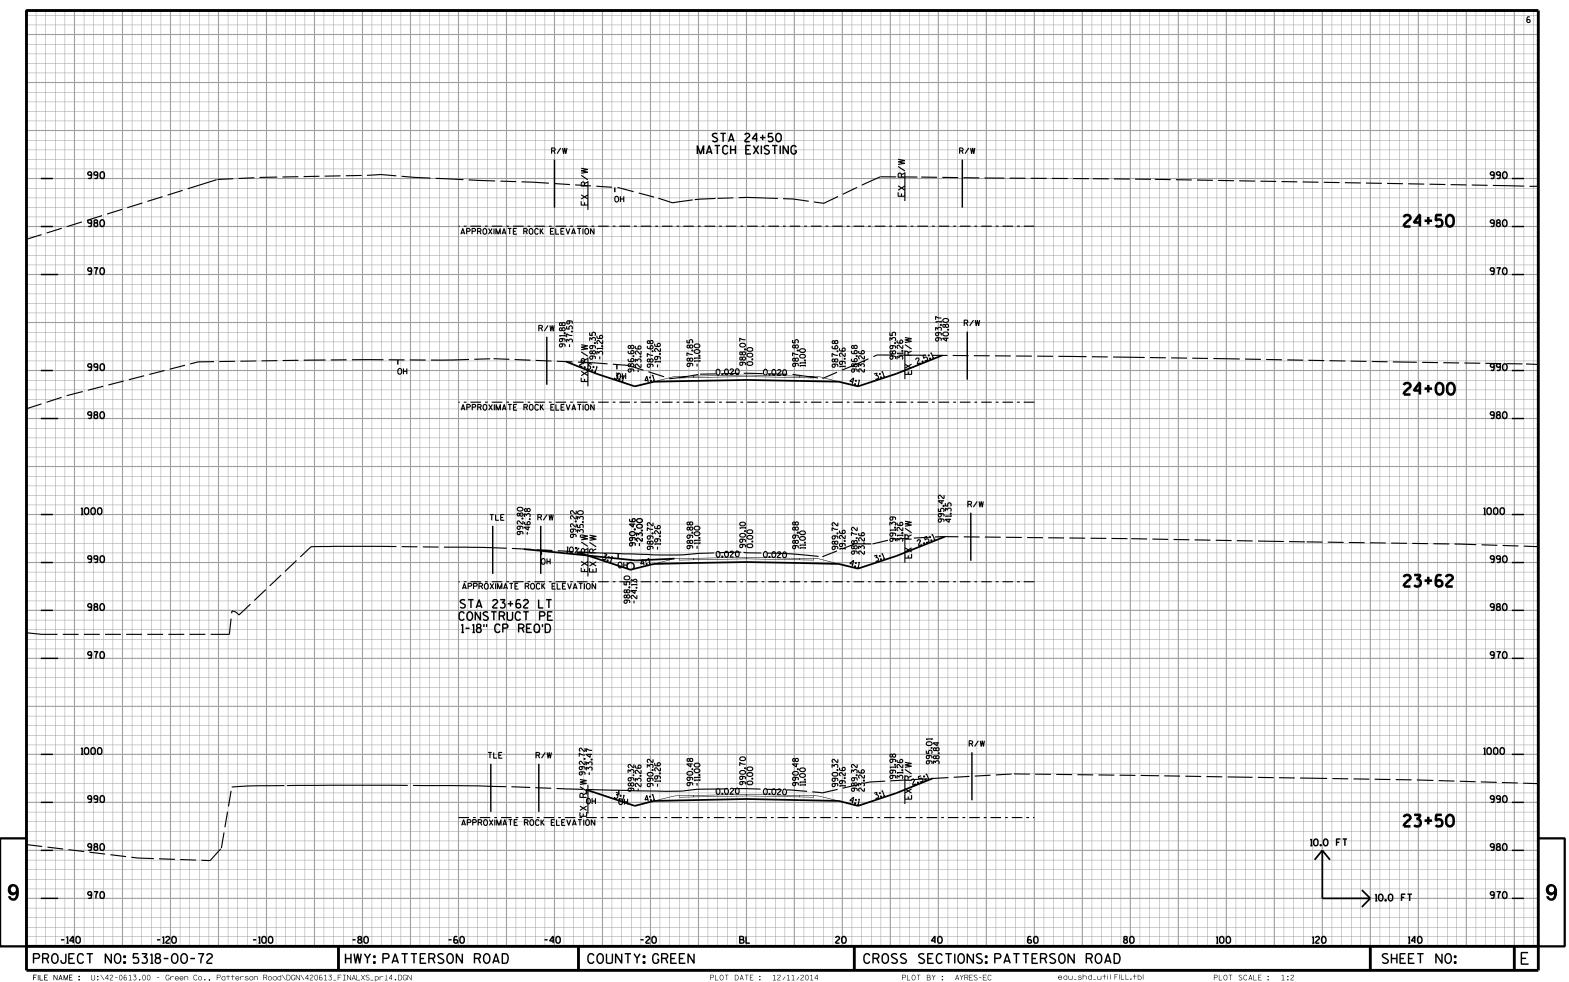

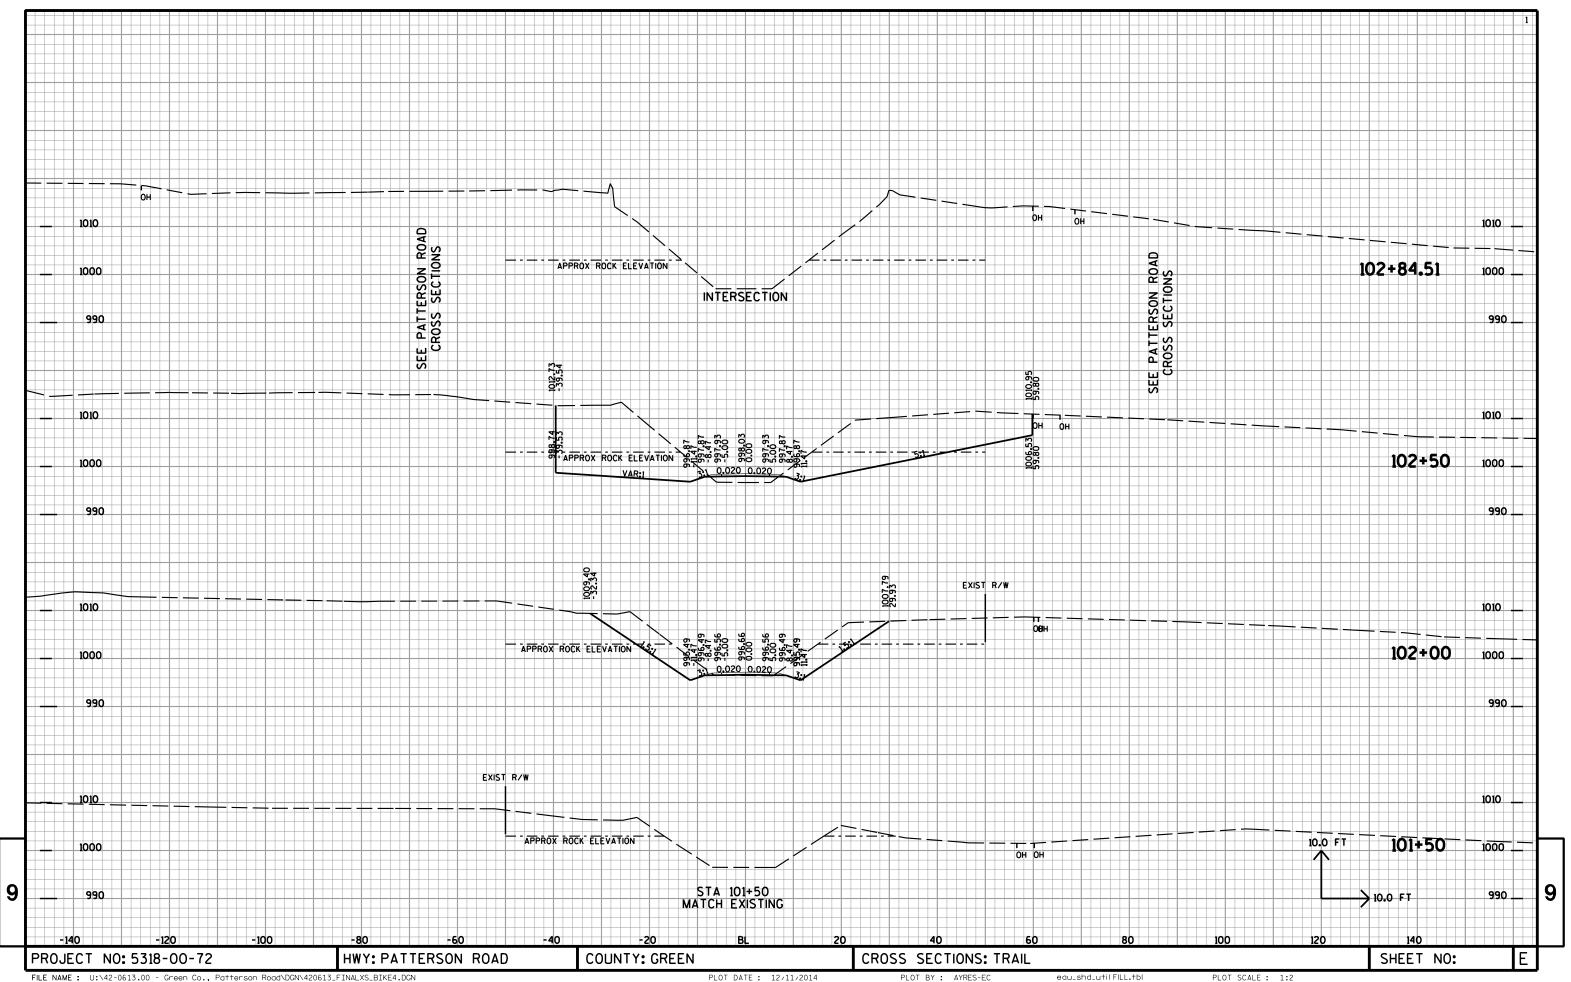

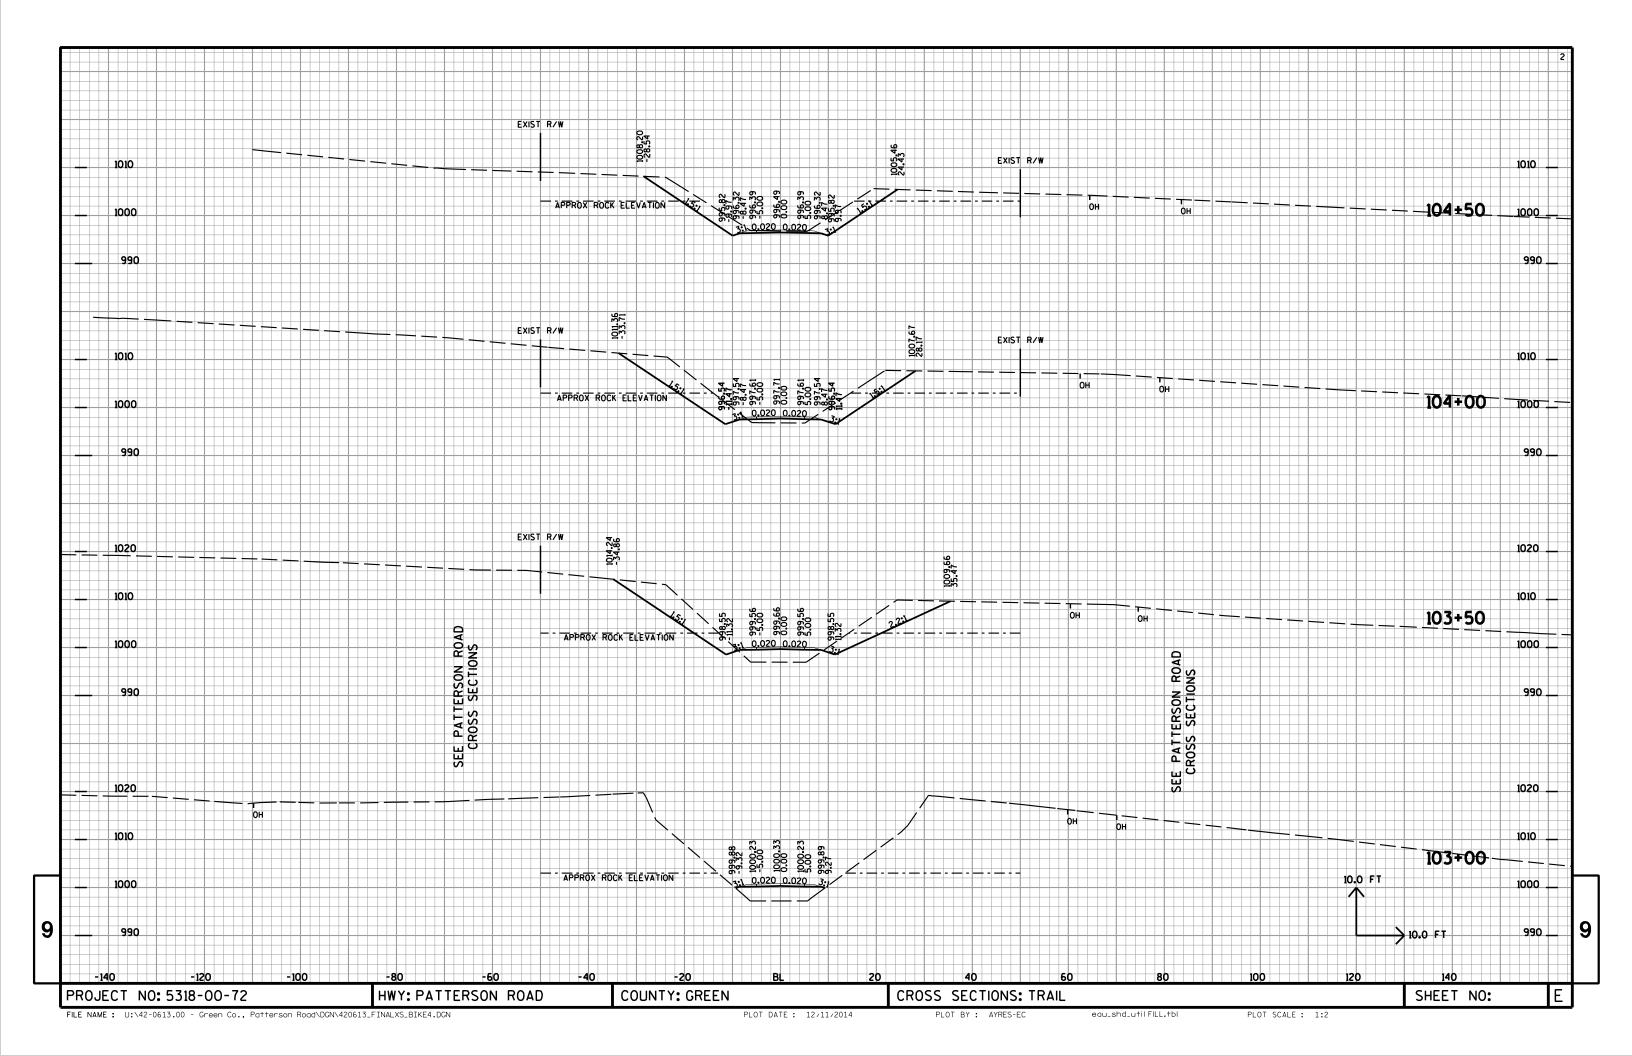

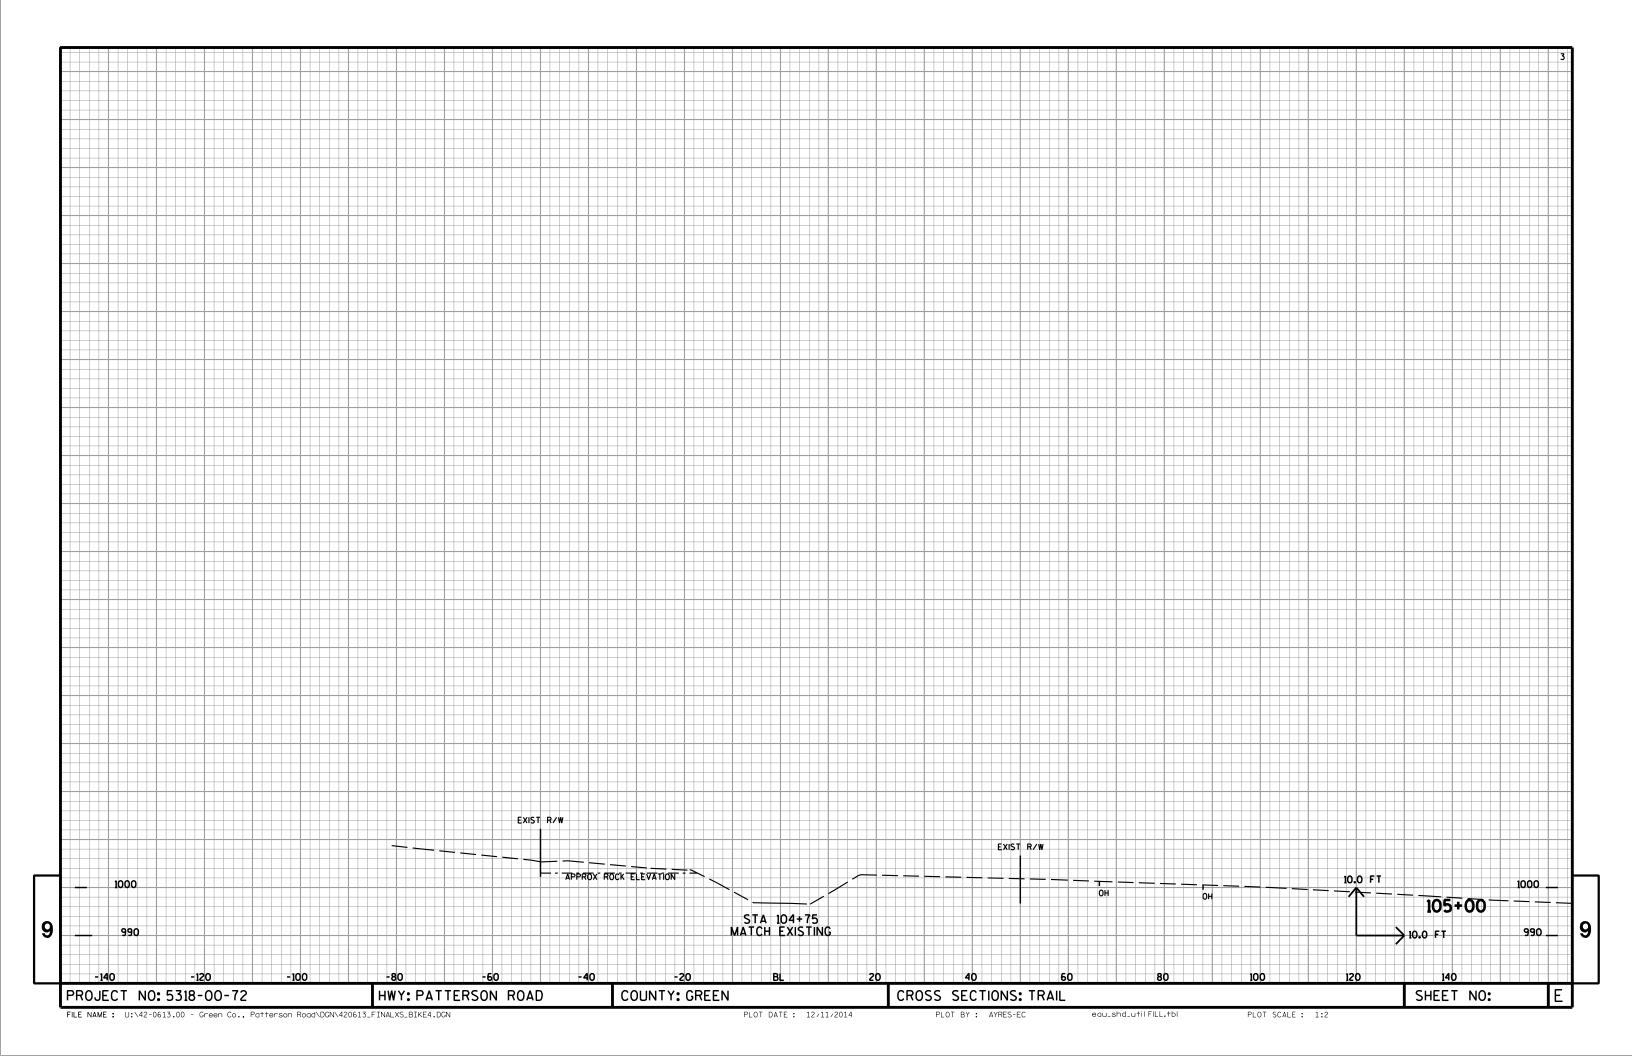



Wisconsin Department of Transportation

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