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DEC 2014

ORDER OF SHEETS

Section No. 1

Typical Sections and Details Section No. 2 (Includes Erosion Control Details)

Estimate of Quantities Section No. 3 Miscellaneous Quantities Right of Way Plat

Section No. 5 Plan and Profile

Section No. 6 Standard Detail Drawings Sign Plates Section No. 7

Section No. 8 Structure Plans

Section No. 9 Computer Earthwork Data

Section No. 9 Cross Sections

TOTAL SHEETS = 80

STATE OF WISCONSIN DEPARTMENT OF TRANSPORTATION


PLAN OF PROPOSED IMPROVEMENT

REEDSBURG - WISCONSIN DELLS


FAWN VALLEY DRIVE - IH 90

CTH H SAUK COUNTY

STATE PROJECT NUMBER 5897-00-70

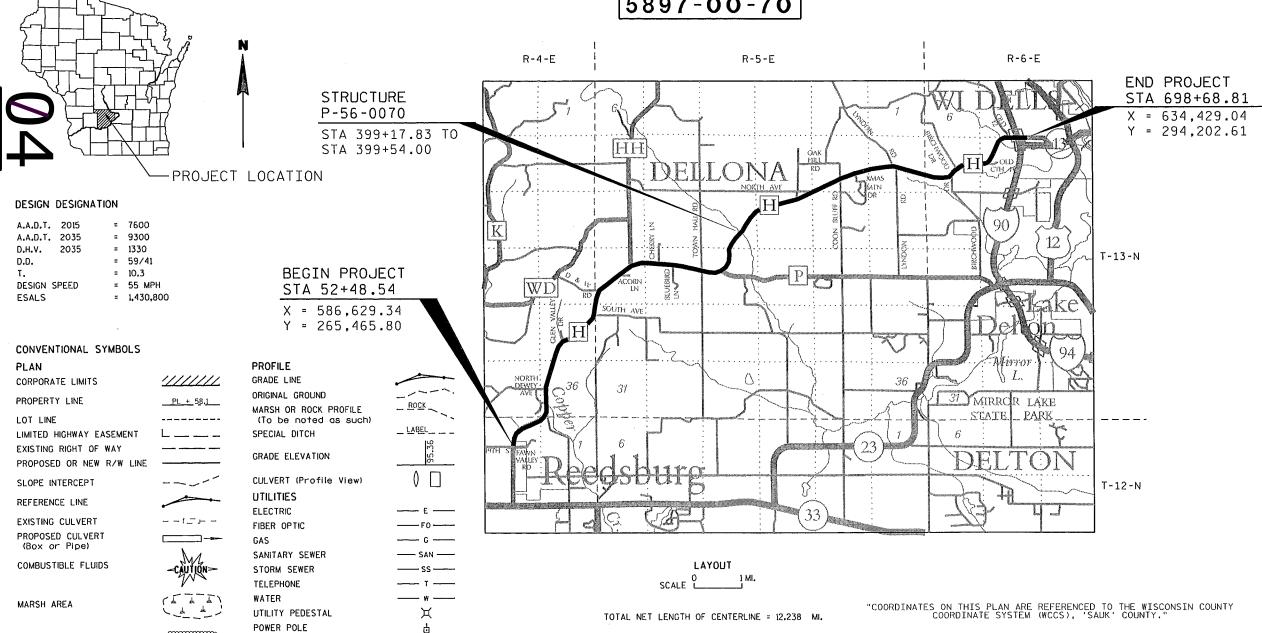


FEDERAL PROJECT STATE PROJECT PROJECT CONTRACT 5897-00-70 WISC 2014434

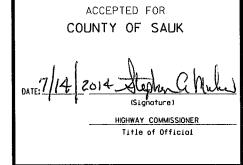

ORIGINAL PLANS PREPARED BY

PROFESSIONAL SURVICES

608-356-2771 1-800-362-4505 Fax: 608-356-2770

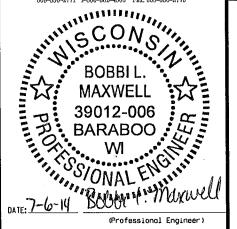

STATE OF WISCONSIN DEPARTMENT OF TRANSPORTATION

PREPARED BY

MSA PROFESSIONAL SERVICES MSA PROFESSIONAL SERVICES

Management Consultant C.O. Examine

KJOHNSON ENGINEERS

PLOT SCALE: 1:100

PLOT BY : blee

PLOT NAME :

WISDOT/CADDS SHEET 15

TELEPHONE POLE

WOODED OR SHRUB AREA

GENERAL NOTES

THERE ARE UTILITY FACILITIES WITHIN THE PROJECT AREA THAT ARE NOT SHOWN ON THE PLANS. COORDINATE CONSTRUCTION ACTIVITIES WITH A CALL TO DIGGERS HOTLINE AND/OR A DIRECT CALL TO THE UTILITIES THAT HAVE FACILITIES IN THE AREA. NOT ALL UTILITIES ARE MEMBERS OF DIGGERS HOTLINE.

PAVEMENT REMOVAL WILL BE TO THE NEAREST JOINT OR A SAWED EDGE WILL BE REQUIRED AS DIRECTED BY THE ENGINEER.

NO TREES OR SHRUBS ARE TO BE REMOVED WITHOUT APPROVAL OF THE ENGINEER.

DISTURBED AREAS WITHIN THE RIGHT-OF-WAY ARE TO BE FERTILIZED. SEEDED AND TEMPORARILY SEEDED AS DIRECTED BY THE ENGINEER.

ALL WASTE MATERIAL RESULTING FROM THE VARIOUS CONSTRUCTION OPERATIONS ADJACENT TO PAVEMENT UNDER TRAFFIC SHALL BE ENTIRELY REMOVED AND PROPERLY DISPOSED OF IMMEDIATELY OR AS DIRECTED BY THE ENGINEER.

THE LOW SIDE SHOULDER SLOPE ON SUPERELEVATION SECTIONS EQUALS SUPERELEVATION WHEN SUPERELEVATION IS GREATER THAN 4.00%. IF SUPERELEVATION IS LESS THAN OR EQUAL TO 4.00%, THEN THE LOW SIDE SHOULDER SLOPE IS 4.00%. HIGH SIDE SHOULDER SLOPE ON SUPERELEVATION SECTIONS EQUALS SUPERELEVATION.

THE QUANTITY OF THE ITEMS FOR EROSION PROTECTION INCLUDES AN UNDISTRIBUTED AMOUNT FOR PROTECTION, CONTROL AND ABATEMENT OF WATER POLLUTION RESULTING FROM SOIL EROSION. THE DISTRIBUTION AND LOCATION OF THESE MATERAILS ARE TO BE DETERMINED BY THE ENGINEER.

THE EXACT LOCATION OF PRIVATE ENTRANCES IS TO BE DETERMINED IN THE FIELD BY THE ENGINEER. ALL DRIVEWAYS ARE TO BE REPLACED IN KIND.

PURSUANT TO CHAPTER 59 OF THE WISCONSIN STATUTES, THE CONTRACTOR SHALL CAREFULLY MAKE A SEARCH FOR EVIDENCE OF A LANDMARK IN ALL AREAS WHERE SUCH A LANDMARK MAY EXIST.

HMA PAVEMENT TYPE E-3 TO BE PLACED IN TWO LAYERS. THE CONTRACTOR'S OPERATIONS SHALL BE CONSISTENT WITH THE PLAN TYPICAL SECTIONS. FOR THE 31/2-INCH HMA PAVEMENT, THE LAYERS SHALL BE 13/4-INCHES WITH NOMINAL AGGREGATE SIZE OF 12.5MM. FOR THE 4-INCH HMA PAVEMENT, THE BOTTOM LAYER SHALL BE 21/4-INCHES WITH NOMINAL AGGREGATE SIZE OF 19MM, AND THE TOP LAYER SHALL BE 13/4-INCHES WITH NOMINAL AGGREGATE SIZE

THE CONTRACTOR IS TO WORK WITH UTMOST CARE AND PROTECT ALL SURVEY MARKERS.

HMA PAVEMENT CALCULATED BY USING 112 LB/SY/IN.

ABBREVIATIONS

FG FINISHED GRADE W WELL		AC ASPH AVG ADT BAM CL CCC CIR CCSCP CSM CTH CUL CP CC CSM CTH CUL CP CB CT	ACRES ASPHALT CEMENT ASPHALT AVERAGE AVERAGE DAILY TRAFFIC BASE AGGREGATE DENSE BENCHMARK CENTERLINE CENTER TO CENTER COLD IN-PLACE RECYCLING CONCRETE CORRUGATED STEEL CULVERT PIPE CERTIFIED SURVEY MAP COUNTY TRUNK HIGHWAY CULVERT CULVERT CULVERT PIPE CURB & GUTTER DEGREE OF CURVE DESIGN HOURLY VOLUME DIAMETER DRIVEWAY EAST EAST GRID COORDINATE ELEVATION ENDWALL ENTRANCE EQUIVALENT SINGLE AXLE LOADS EXCAVATION EXCAVATION EXCAVATION BELOW SUBGRADE EXISTING FACE TO FACE FERTILIZER FIELD ENTRANCE FINISHED GRADE	FT G.V. INV IP JCT LHF L LS NC N YPC PI PT PL PR REOD R/W SHLDR STA SE TALD STA SE TALD TYP VERT VOL WV	FOOT GAS VALVE INVERT IRON PIPE JUNCTION LEFT HAND FORWARD LENGTH LUMP SUM NORMAL CROWN NORTH NORTH GRID COORDINATE POINT OF CURVATURE POINT OF INTERSECTION POINT OF TANGENCY PROPERTY LINE PRIVATE ENTRANCE RADIUS REQUIRED RIGHT-OF-WAY RIGHT HAND FORWARD SALVAGED SHOULDER STANDARD DETAIL DRAWINGS STATION SUPERELEVATION TANGENT TEMPORARY LIMITED EASEMENT TRUCKS TYPICAL VERTICAL VE
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DESIGN CONTACT

MSA PROFESSIONAL SERVICES, INC. ATTN: MS. BOBBIL. MAXWELL 1230 SOUTH BOULEVARD BARABOO, WI 53913 TELEPHONE: 608-355-8861 EMAIL: BMAXWELL@MSA-PS.COM

SAUK COUNTY, HWY COMMISSIONER ATTN: STEVE MUCHOW P.O. BOX 26 BARABOO, WI 53913 TELEPHONE: 608-355-4855 EMAIL: SMUCHOW@CO.SAUK.WI.US

DNR LIASON

WISCONSIN DEPARTMENT OF NATURAL RESOURCES ATTN: ANDREW BARTA 3911 FISH HATCHERY ROAD FITCHBURG, WI 53711 TELEPHONE: 608-275-3308 EMAIL: ANDREW.BARTA@WISCONSIN.GOV

UTILITIES

*SANITARY SEWER CITY OF WISCONSIN DELLS ATTN: DAVE HOLZEM DIRECTOR OF PUBLIC WORKS 300 LACROSSE STREET P.O. BOX 655 WISCONSIN DELLS, WI 53965 608-253-2542 EMAIL: DHOLZEM@DELLSCITYGOV.COM

FIBER OPTIC REEDSBURG UTILITY COMMISSION ATTN: BRETT SCHUPPNER 501 UTILITY COURT REEDSBURG, WI 53959 608-768-6435 BRETTS@RUCLS.NET

ELECTRIC & GAS ALLIANT ENERGY ATTN: TOM ORMSON 338 E. STATE STREET MAUSTON, WI 53948 608-847-1319 EMAIL: TOMORMSON@ALLIANTENERGY.COM

FIRER OPTIC SAUK COUNTY ATTN: TIM STIEVE SAUK COUNTY COURTHOUSE ANNEX 510 BROADWAY BARABOO, WI 53913 608-355-4419 EMAIL: TSTIEVE@CO.SAUK.WI.US

FIBER OPTIC WINDSTREAM KDL. INC. ATTN: DENNIS RUESS 8531 COUNTY ROAD FF WISCONSIN RAPIDS. WI 54494 608-512-5587 EMAIL: DENNIS.RUESS@WINDSTREAM.COM

TELEPHONE FRONTIER COMMUNICATIONS ATTN: JERRY MOORE 222 WEST WISCONSIN STREET PORTAGE, WI 53901 608-742-9507 EMAIL: JEROLD.R.MOORE@FTR.COM

FIBER OPTIC CHARTER COMMUNICATION ATTN: HARLOW JARVIS E10704 STATE HWY 33 BARABOO, WI 53913 608-448-2119

EMAIL: HARLOW.JARVIS@CHARTERCOM.COM

TRANSMISSION LINES ATC ATTN: JIM OLSON 2 FEN OAK COURT MADISON, WI 53718 608-877-3622 EMAIL: JROLSON@ATCLLC.COM

* NOT A DIGGER'S HOTLINE MEMBER




www.DiggersHotline.com


PROJECT NO:5897-00-70 HWY: CTH H FILE NAME: P:\3000s\3060s\3060\03060007\CADD\Planshts\Details\020101_gn.DGN


COUNTY: SAUK

GENERAL NOTES

SHEET

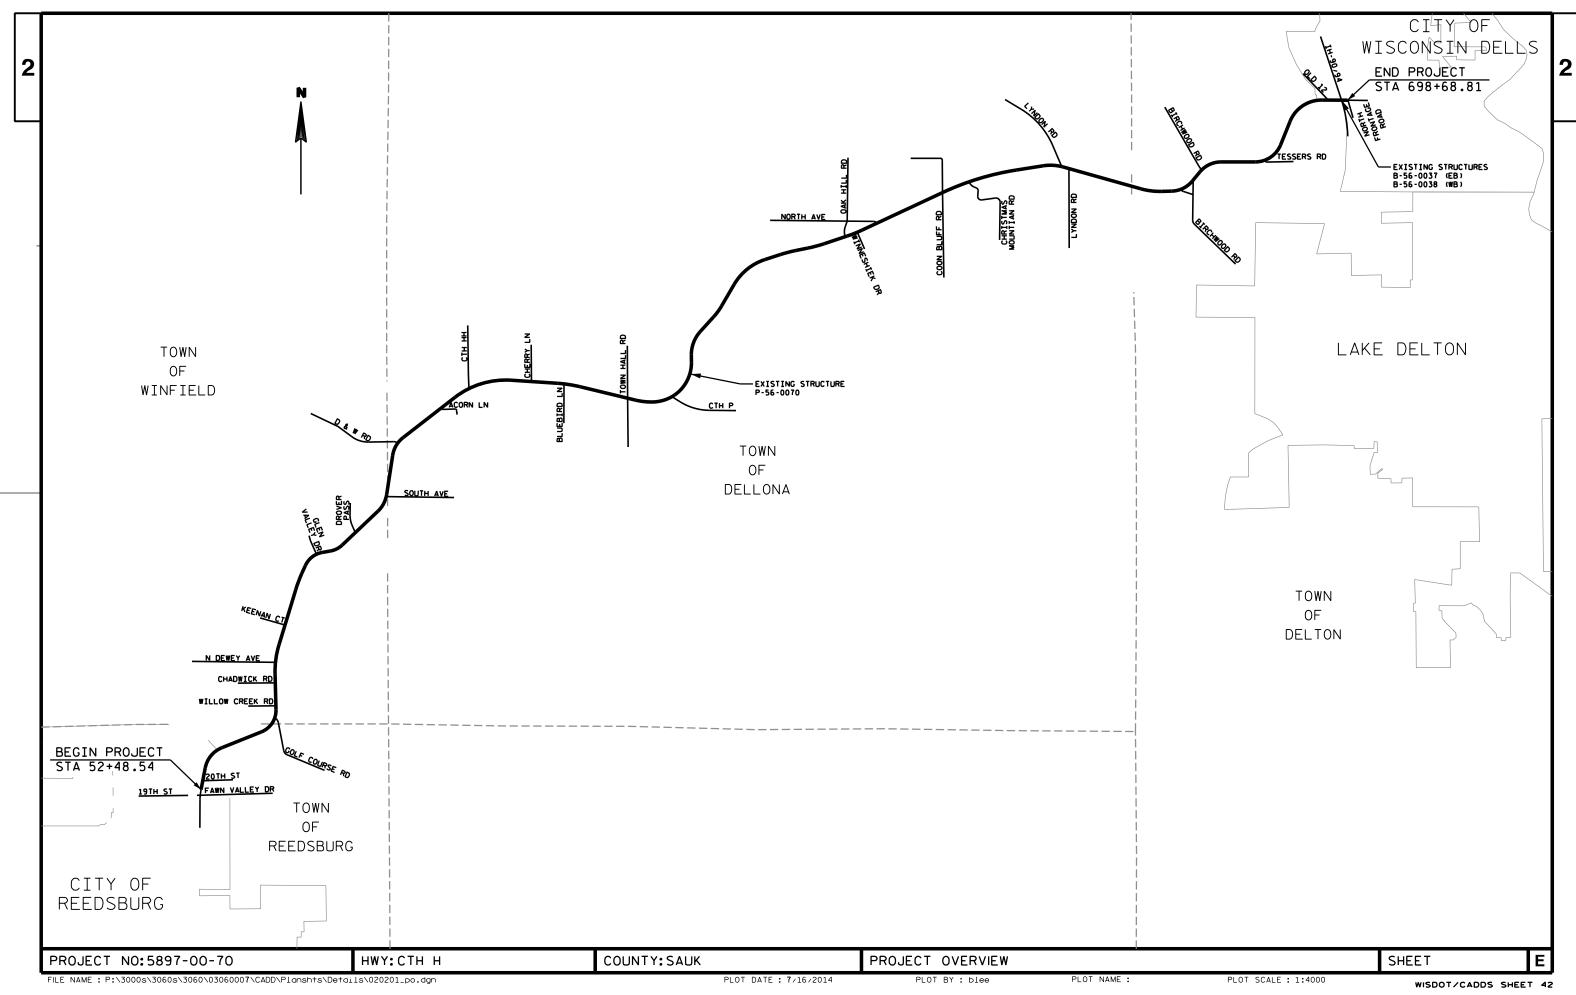

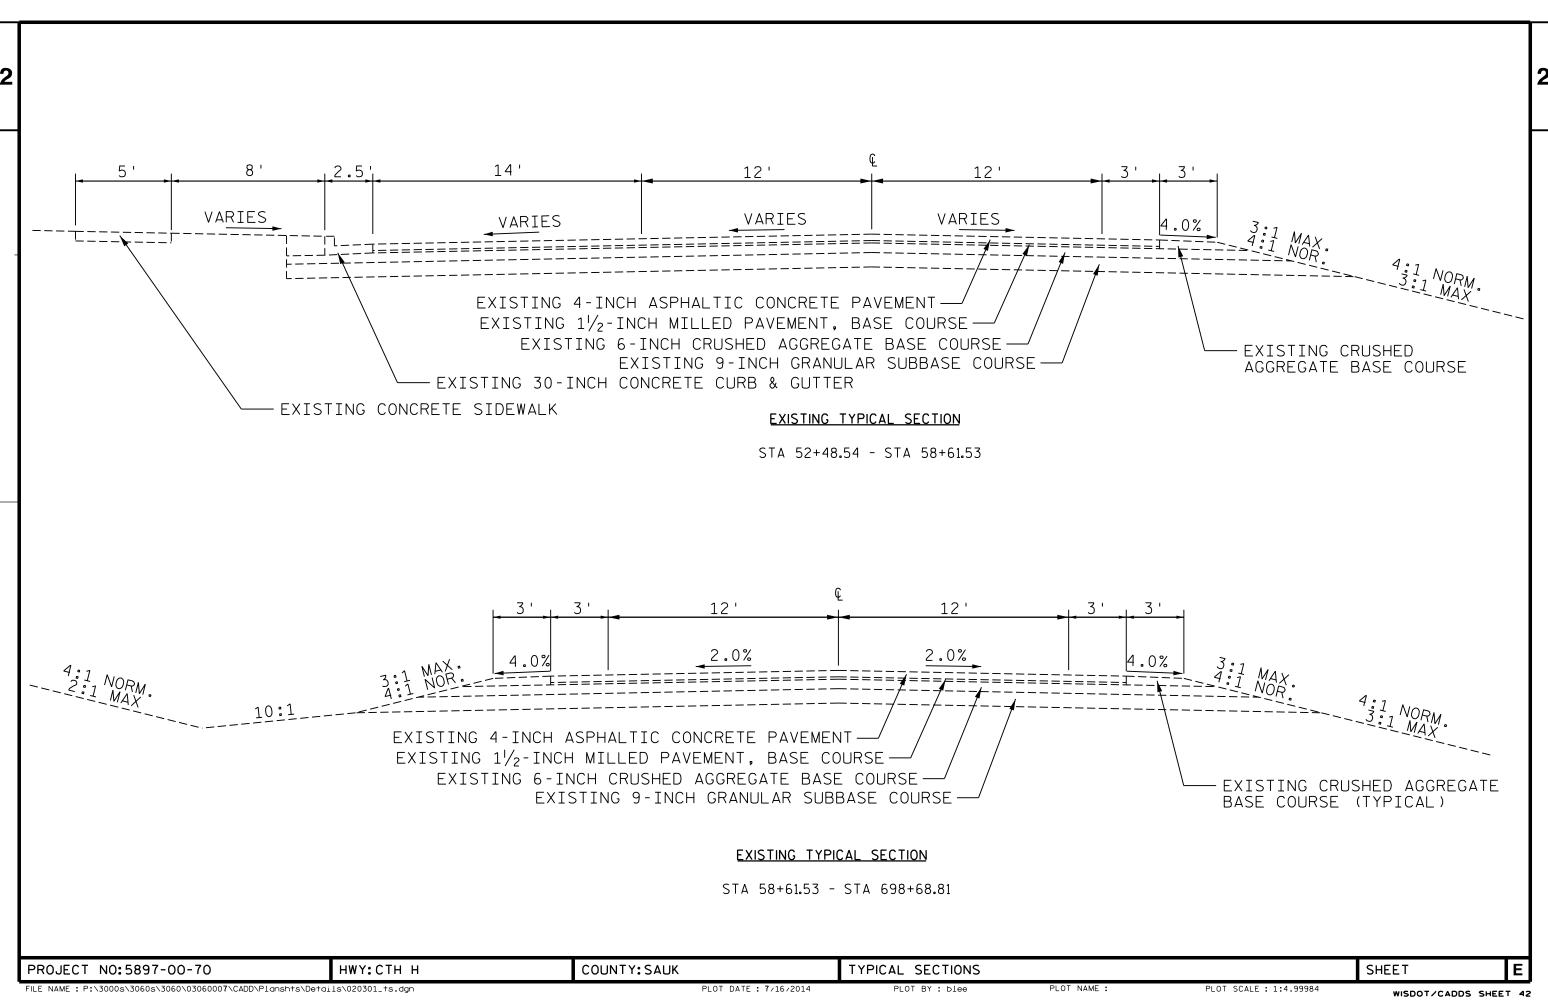

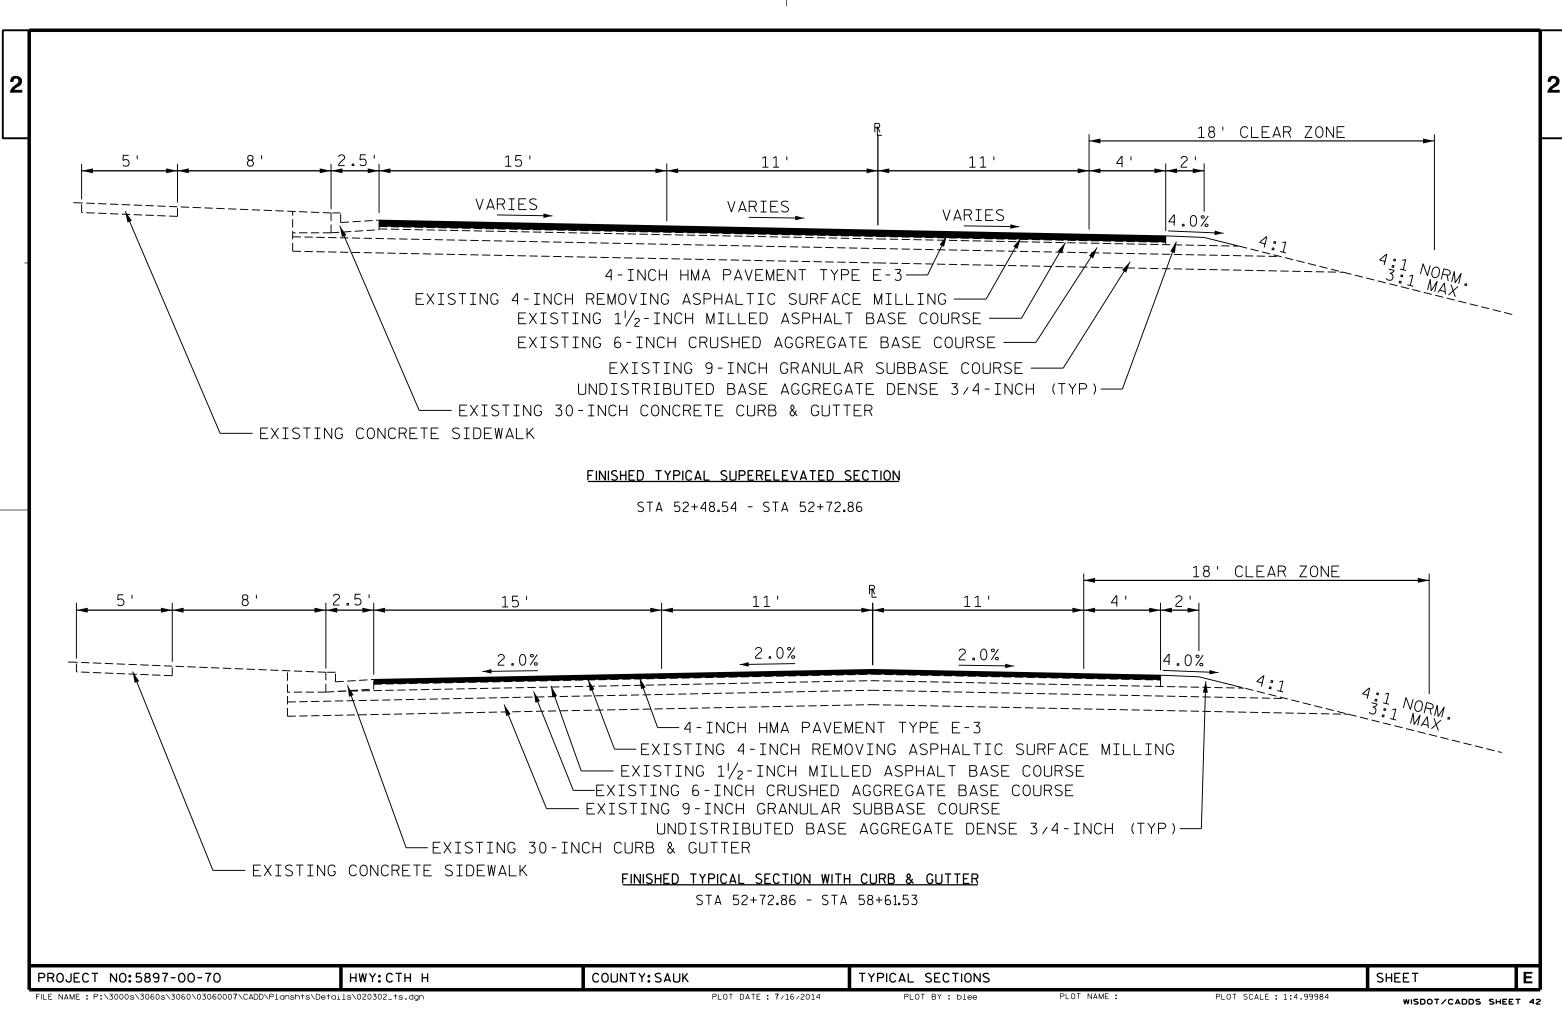



3½-INCH HMA PAVEMENT TYPE E-3

4-INCH COLD IN PLACE RECYCLED (CIR)
PAVEMENT (17'-19' PAY LIMITS)

3½-INCH BASE AGGREGATE DENSE 3/4-INCH (TYP)

UNDISTRIBUTED BASE AGGREGATE DENSE 3/4-INCH (TYP)


FINISHED TYPICAL SECTION WITH BEAM GUARD

STA 74+69.95 - STA 77+41RT STA 83+57 - STA 86+22 LT STA 83+05 - STA 89+24.82 RT STA 142+75 - STA 144+05 LT & RT STA 224+72 - STA 226+35.40 LT STA 238+50 - STA 239+72 RT STA 238+56 - STA 239+71LT STA 304+04 - STA 305+32 RT STA 304+02 - STA 305+30 LT STA 321+17 - STA 322+46 LT STA 321+14 - STA 322+42 RT

COUNTY: SAUK

STATION	OFFSET
77+43	19'-3 ^l / ₄ " RT
83+55	19'-3 ^l / ₄ " LT
86+24	19'-3 ^l / ₄ " LT
83+03	19'-3 ^l / ₄ " RT
142+74	19'-3 ^l / ₄ " LT & RT
144+06	19'-3 ¹ / ₄ " LT & RT
224+66	19'-3 ¹ / ₄ " LT
238+45	19'-3 ¹ / ₄ " RT
239+77	19'-3 ¹ / ₄ " RT
238+54	19'-3 ¹ / ₄ " LT
239+73	19'-3 ¹ / ₄ " LT
304+02	19'-3 ¹ / ₄ " RT
305+34	19'-3 ¹ / ₄ " RT
304+00	19'-3 ¹ / ₄ " LT
305+32	19'-3 ¹ / ₄ " LT
321+16	19'-3 ¹ / ₄ " LT
322+47	19'-3 ¹ / ₄ " LT
321+12	19'-3 ¹ / ₄ " RT
322+44	19'-3 ¹ / ₄ " RT

POST 1LOCATIONS

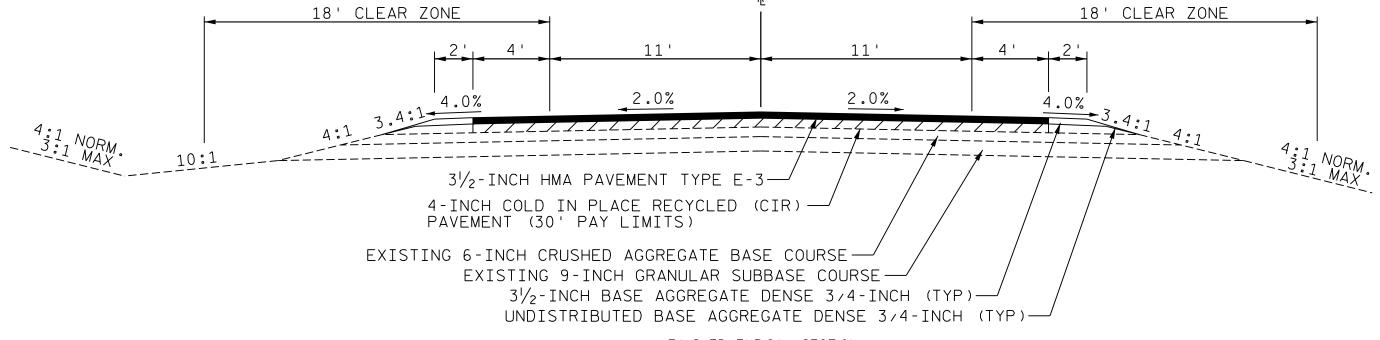

FINISHED TYPICAL SECTION

 STA 58+61.53 - STA 59+95.82
 STA 213+08.98 - STA 226+35.40

 STA 74+69.95 - STA 89+24.82
 STA 238+48.35 - STA 262+22.43

 STA 104+18.94 - STA 115+38.50
 STA 291+10.70 - STA 306+01.85

 STA 131+99.38 - STA 151+32.22
 STA 320+81.69 - STA 340+15.61

 STA 175+51.34 - STA 175+78.28
 STA 390+18.22 - STA 394+89.42

HWY: CTH H

STA 404+33.86 - STA 411+22.94 STA 431+54.78 - STA 434+10.23 STA 445+41.35 - STA 445+82.16 STA 457+70.88 - STA 462+93.85 STA 474+50.27 - STA 551+07.19

TYPICAL SECTIONS

STA 562+72.62 - STA 593+02.30 STA 605+34.91 - STA 606+19.73 STA 619+20.63 - STA 620+94.18 STA 634+24.47 - STA 645+27.29 STA 662+12.61 - STA 669+28.11 STA 689+69.41 - STA 693+00.00

FILE NAME: P:\3000s\3060s\3060\03060007\CADD\Planshts\Details\020303_ts.dgn

PLOT DATE : 7/16/2014

PLOT BY: blee PLOT NAME:


WISDOT/CADDS SHEET 42


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SHEET

PROJECT NO:5897-00-70





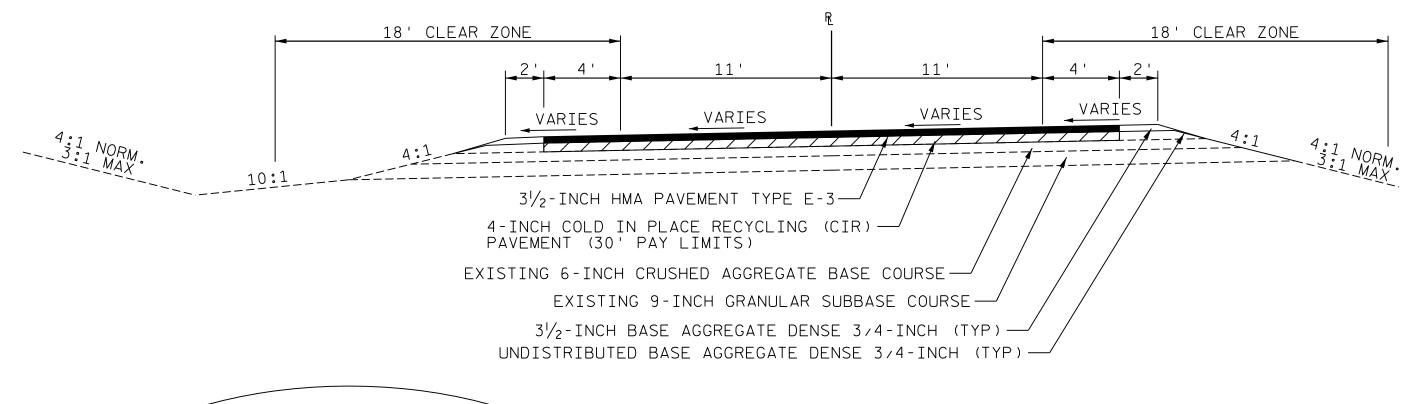

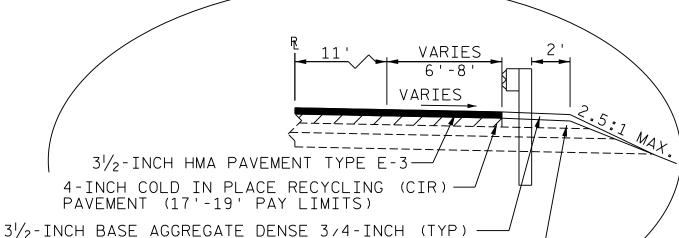FINISHED TYPICAL SUPERELEVATED SECTION WITH BEAM GUARD

HWY: CTH H

STA 62+50 - STA 63+75 LT STA 62+25 - STA 63+60 RT STA 74+13 - STA 74+69.95 RT STA 89+24.82 - STA 89+83 RT STA 94+88 - STA 98+23 RT STA 99+80 - STA 101+55 RT STA 115+50 - STA 116+90 LT & RT STA 169+00 - STA 170+30 LT & RT STA 177+36 - STA 181+68 RT

UNDISTRIBUTED BASE AGGREGATE DENSE 3/4-INCH (TYP)

STA 226+35.40 - STA 233+04 LT STA 234+18 - STA 235+77 LT STA 266+27 - STA 267+55 LT & RT STA 273+47 - STA 274+75 LT STA 273+45 - STA 274+75 RT STA 397+50 - STA 398+00 RT STA 400+10 - STA 400+60 RT STA 398+10 - STA 398+60 LT STA 400+75 - STA 401+25 LT STA 678+21 - STA 681+04 RT STA 679+47 - STA 681+72 LT

COUNTY: SAUK

FINISHED SUPERELEVATED TYPICAL SECTION

STA 59+95.82 - STA 74+69.95 STA 89+24.82 - STA 104+18.94 STA 115+38.50 - STA 131+99.38 STA 151+32.22 - STA 175+51.34 STA 175+78.28 - STA 184+57.93 STA 201+90.40 - STA 213+08.98 STA 226+35.40 - STA 238+48.35 STA 262+22.43 - STA 291+10.70 STA 306+01.85 - STA 320+81.69 STA 340+15.61 - STA 390+18.22

STA 394+89.42 - STA 404+33.86 STA 411+22.94 - STA 431+54.78 STA 434+10.23 - STA 445+41.35 STA 445+82.16 - STA 457+70.88 STA 462+93.85 - STA 474+50.27 STA 551+07.19 - STA 562+72.62 STA 593+02.30 - STA 605+34.91 STA 606+19.73 - STA 619+20.63 STA 620+94.18 - STA 634+24.47 STA 645+27.29 - STA 662+12.61 STA 669+28.11 - STA 689+69.41

POST 11 OCATIONS

<u> FUST</u>	I LUCATIONS
STATION	OFFSET
62+47	19'-3 / ₄ '' LT
63+78	19'-3 ^l ∕₄'' LT
62+21	19'-3 ∕₄'' RT
63+64	19'-3 ∕₄'' RT
74+11	19'-3 ∕₄'' RT
89+85	19'-3 ∕₄" RT
94+84	19'-3 ∕₄'' RT
98+27	19'-3 ∕₄'' RT
99+77	19'-3 ∕₄'' RT
101+58	19'-3 ∕₄" RT
115+48	19'-3 ¹ / ₄ " LT & RT
116+92	19'-3 / ₄ '' LT & RT
168+99	19'-3 / ₄ '' LT & RT
170+31	19'-3 / ₄ " LT & RT

STATION OFFSET 177+30	POST	1 LOCATIONS
181+74 19'-3\(\frac{1}{4}\)" RT 233+10 19'-3\(\frac{1}{4}\)" LT 234+13 19'-3\(\frac{1}{4}\)" LT 235+82 19'-3\(\frac{1}{4}\)" LT 266+25 19'-3\(\frac{1}{4}\)" LT & RT 267+57 19'-3\(\frac{1}{4}\)" LT & RT 273+45 19'-3\(\frac{1}{4}\)" LT 273+44 19'-3\(\frac{1}{4}\)" RT	STATION	OFFSET
235+82 19'-3 ¹ / ₄ " LT 266+25 19'-3 ¹ / ₄ " LT & RT 267+57 19'-3 ¹ / ₄ " LT & RT 273+45 19'-3 ¹ / ₄ " LT 274+77 19'-3 ¹ / ₄ " LT 273+44 19'-3 ¹ / ₄ " RT	181+74	19'-3 / ₄ '' RT 19'-3 / ₄ '' LT
267+57 19'-3 ¹ / ₄ " LT & RT 273+45 19'-3 ¹ / ₄ " LT 274+77 19'-3 ¹ / ₄ " LT 273+44 19'-3 ¹ / ₄ " RT		19'-3 ¹ / ₄ '' LT
074 76 401 71/11 57	267+57 273+45 274+77	19'-3 ¹ / ₄ " LT & RT 19'-3 ¹ / ₄ " LT 19'-3 ¹ / ₄ " LT 19'-3 ¹ / ₄ " RT
274+76	397+87	19'-3 ¹ / ₄ '' RT

POST 1LOCATIONS

STATION	OFFSET
400+23	19'-3 ^l / ₄ '' RT
400+73	19'−3 ^l ∕₄'' RT
400+88	19'-3 ^l / ₄ '' LT
397+97	19'-3 ¹ / ₄ '' LT
401+38	19'-3 ^l / ₄ '' LT
678+16	19'-3 ^l / ₄ '' RT
681+09	19'-3 ^l / ₄ '' RT
679+44	19'-3 ^l ∕₄'' LT
681+75	19'-3 ^l ∕₄'' LT
694+64	19'-3 ^l / ₄ '' LT
694+76	19'-3 ^l ∕₄'' RT
697+70	19'-3 ^l / ₄ '' LT
697+82	19'-3 / ₄ '' RT

SHEET

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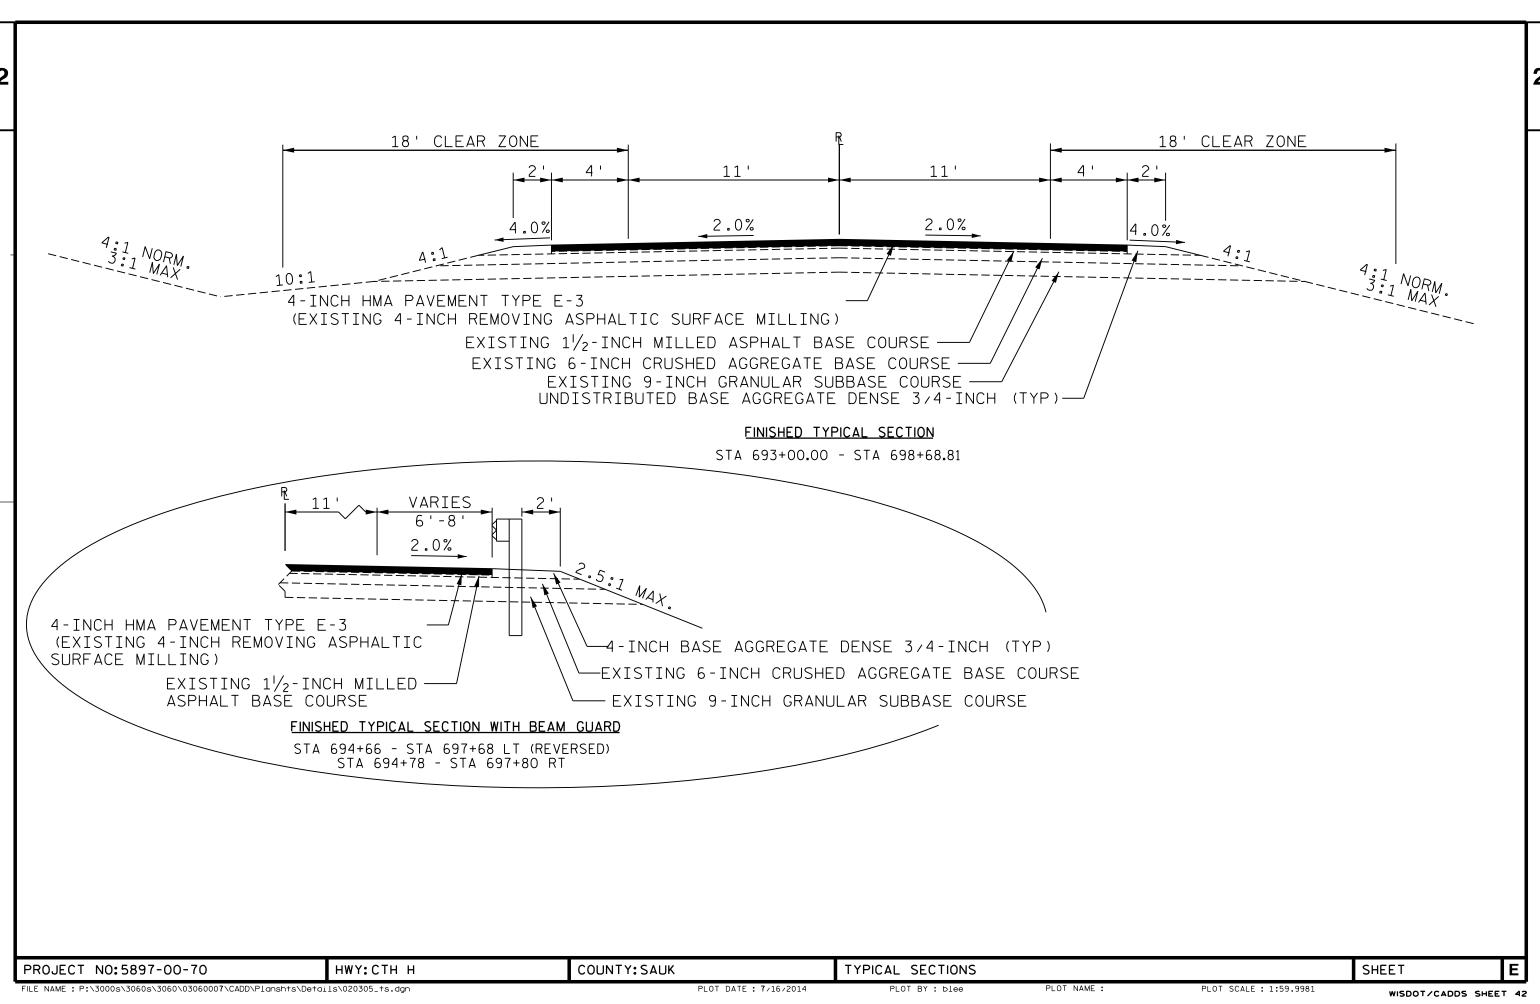
TYPICAL SECTIONS PLOT BY : blee

PLOT NAME :


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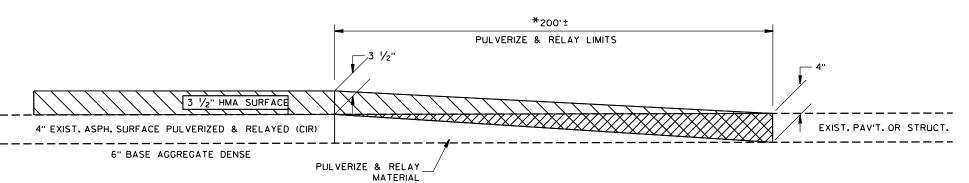
WISDOT/CADDS SHEET 42

PROJECT NO:5897-00-70







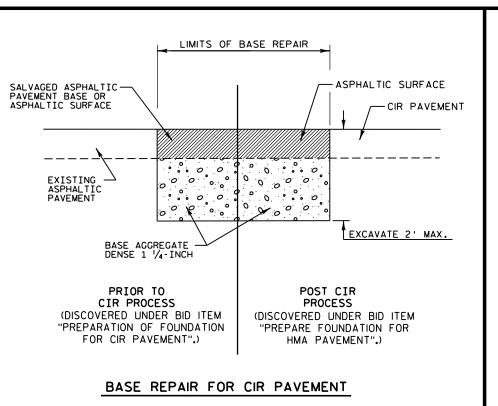


REMOVE PULVERIZED ASPHALTIC SURFACE (INCLUDED UNDER "PULVERIZE AND RELAY" ITEM)

HMA SURFACE


TYPICAL TRANSITION DETAIL

200' TRANSITIONS

STA 58+61.53 - STA 60+61.53 STA 397+17.83 - STA 399+17.83 STA 399+54.00 - STA 401+54.00 STA 691+00.00 - STA 693+00.00

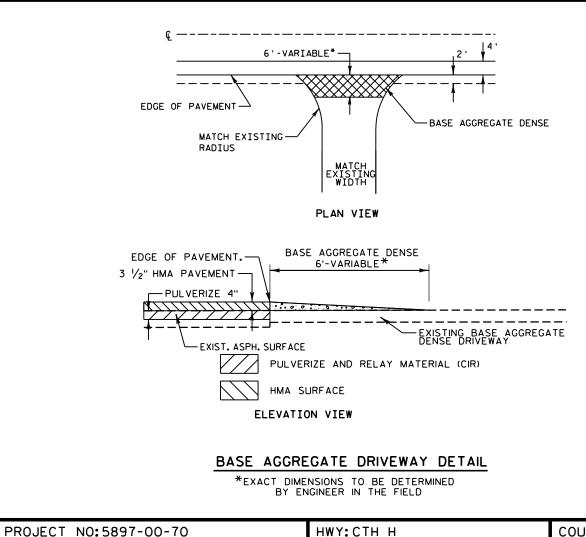



HWY: CTH H

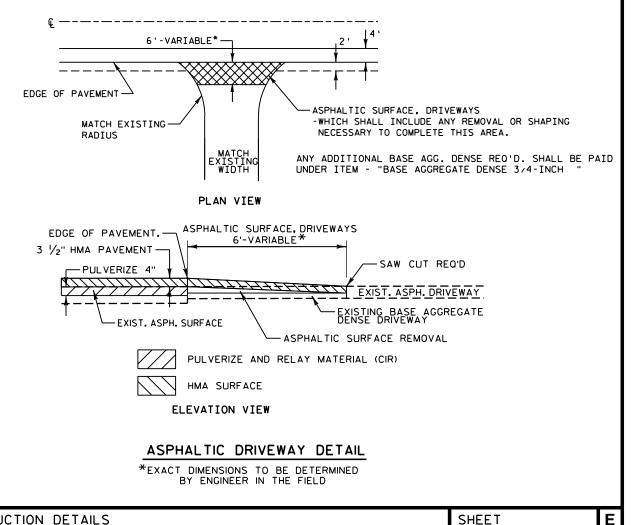

PLOT BY : blee


WISDOT/CADDS SHEET 42

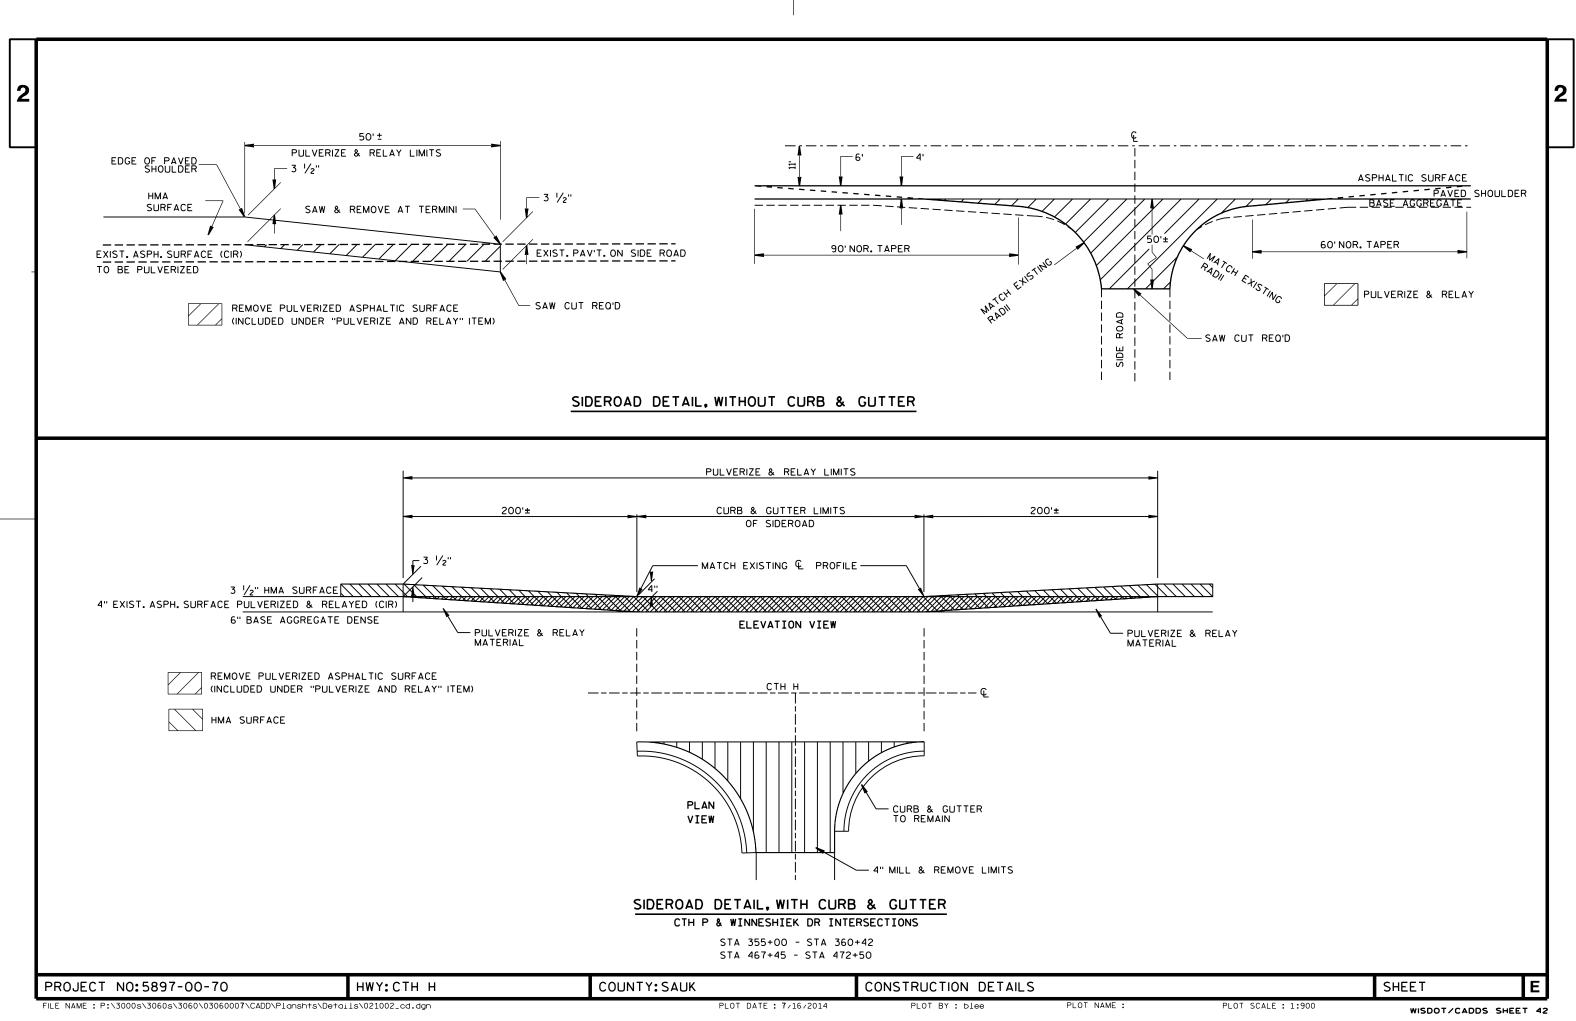

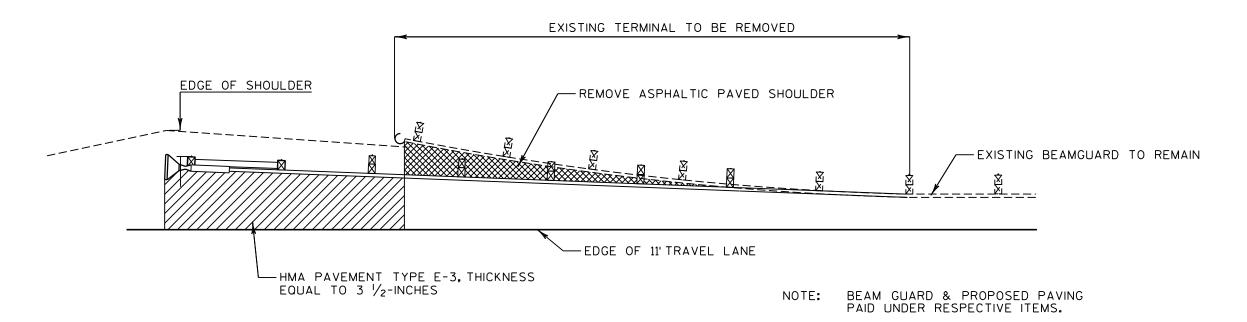

BEAM GUARD TERMINAL UPGRADE AT EXISTING BRIDGE (P-56-0070)

SEE S.D.D. "STEEL PLATE BEAM GUARD ENERGY ABSORBING TERMINAL".

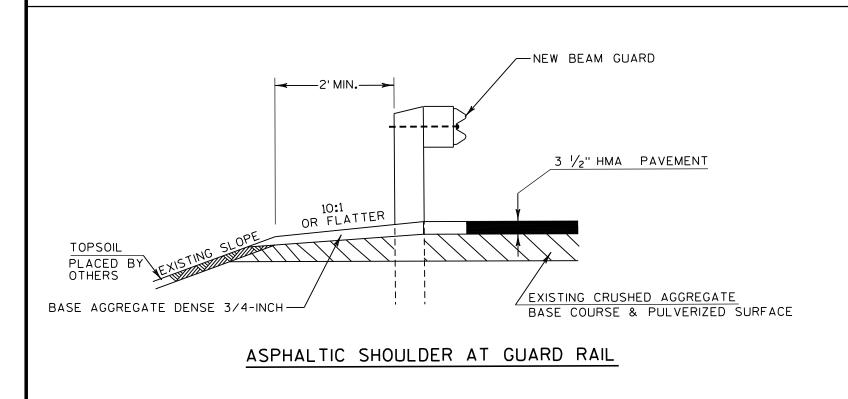


RUNOFF COEFFICIENT TABLE


	İ					HYDROLOGIC S	SOIL GROU	JP					
		Α			В			С			D		
	SLOPE	RANGE	(PERCENT)	SLOPE	RANGE	(PERCENT)	SLOPE	RANGE	(PERCENT)	SLOPE	RANGE	(PERCENT	
LAND USE:	0-2	2-6	6 & OVER	0-2	2-6	6 & OVER	0-2	2-6	6 & OVER	0-2	2-6	6 & OVER	
ROW CROPS	.08	.16	.22	.12	.20	.27	.15	.24	.33	.19	.28	.38	
	.22	.30	.38	.26	.34	.44	.30	.37	.50	.34	.41	.56	
MEDIAN STRIP-	.19	.20	.24	.19	.22	.26	.20	.23	.30	.20	.25	.30	
TURF	.24	.26	.30	.25	.28	.33	.26	.30	.37	.27	.32	.40	
SIDE SLOPE-			.25			.27			.28			.30	
TURF			.32			.34			.36			.38	
PAVEMENT:													
ASPHAL T						.7095							
CONCRETE						.8095							
BRICK						.7080							
DRIVES, WALKS						.7585				•			
ROOFS						.7595							
GRAVEL ROADS,	SHOULDE	ERS			•	.4060		•		_			


TOTAL PROJECT AREA = 50.4 ACRES
TOTAL AREA EXPECTED TO BE DISTURBED BY CONSTRUCTION ACTIVITIES = 50.4 ACRES


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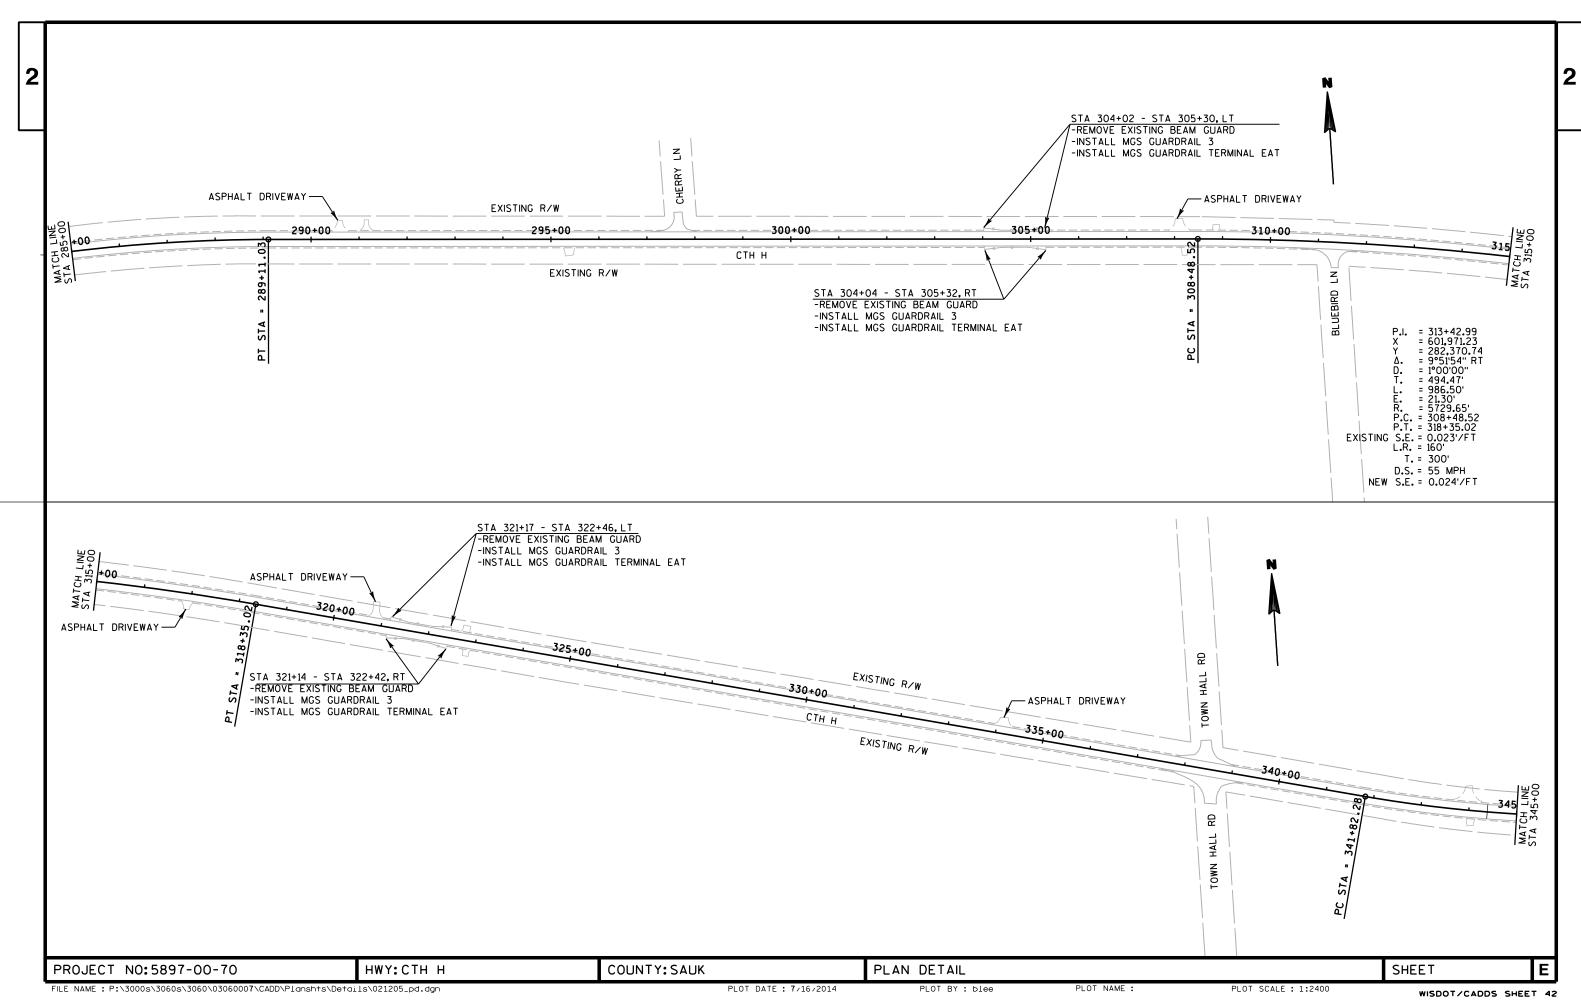
PROJECT NO:5897-00-70 HWY:CTH H COUNTY:SAUK CONSTRUCTION DETAILS SHEET E




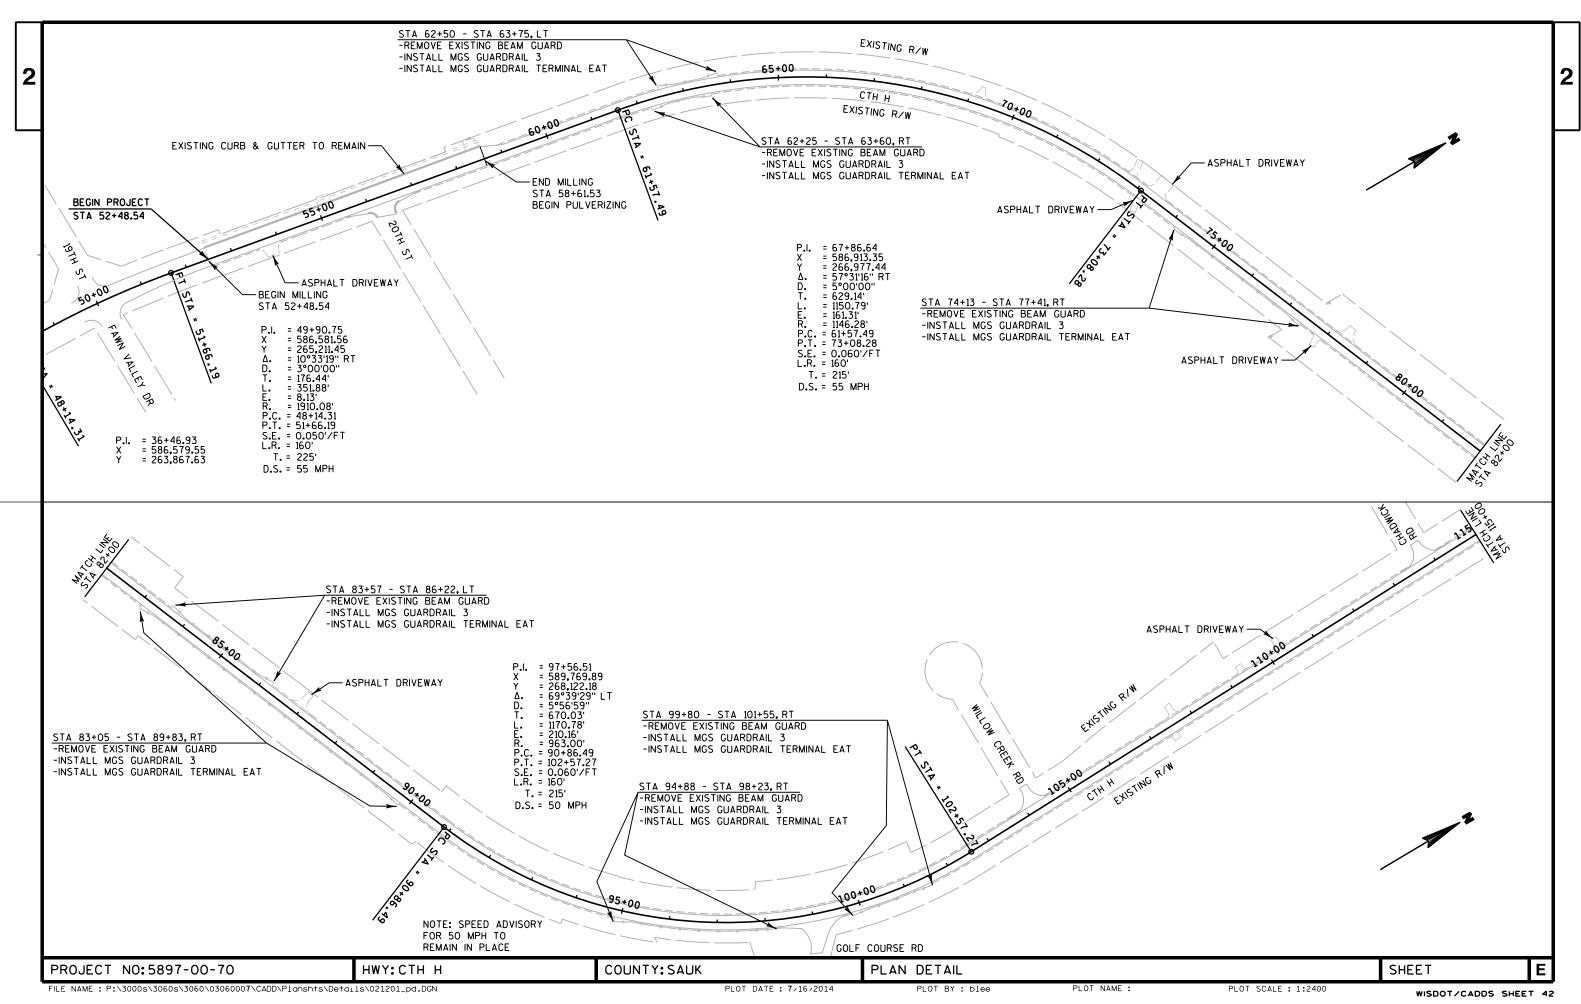


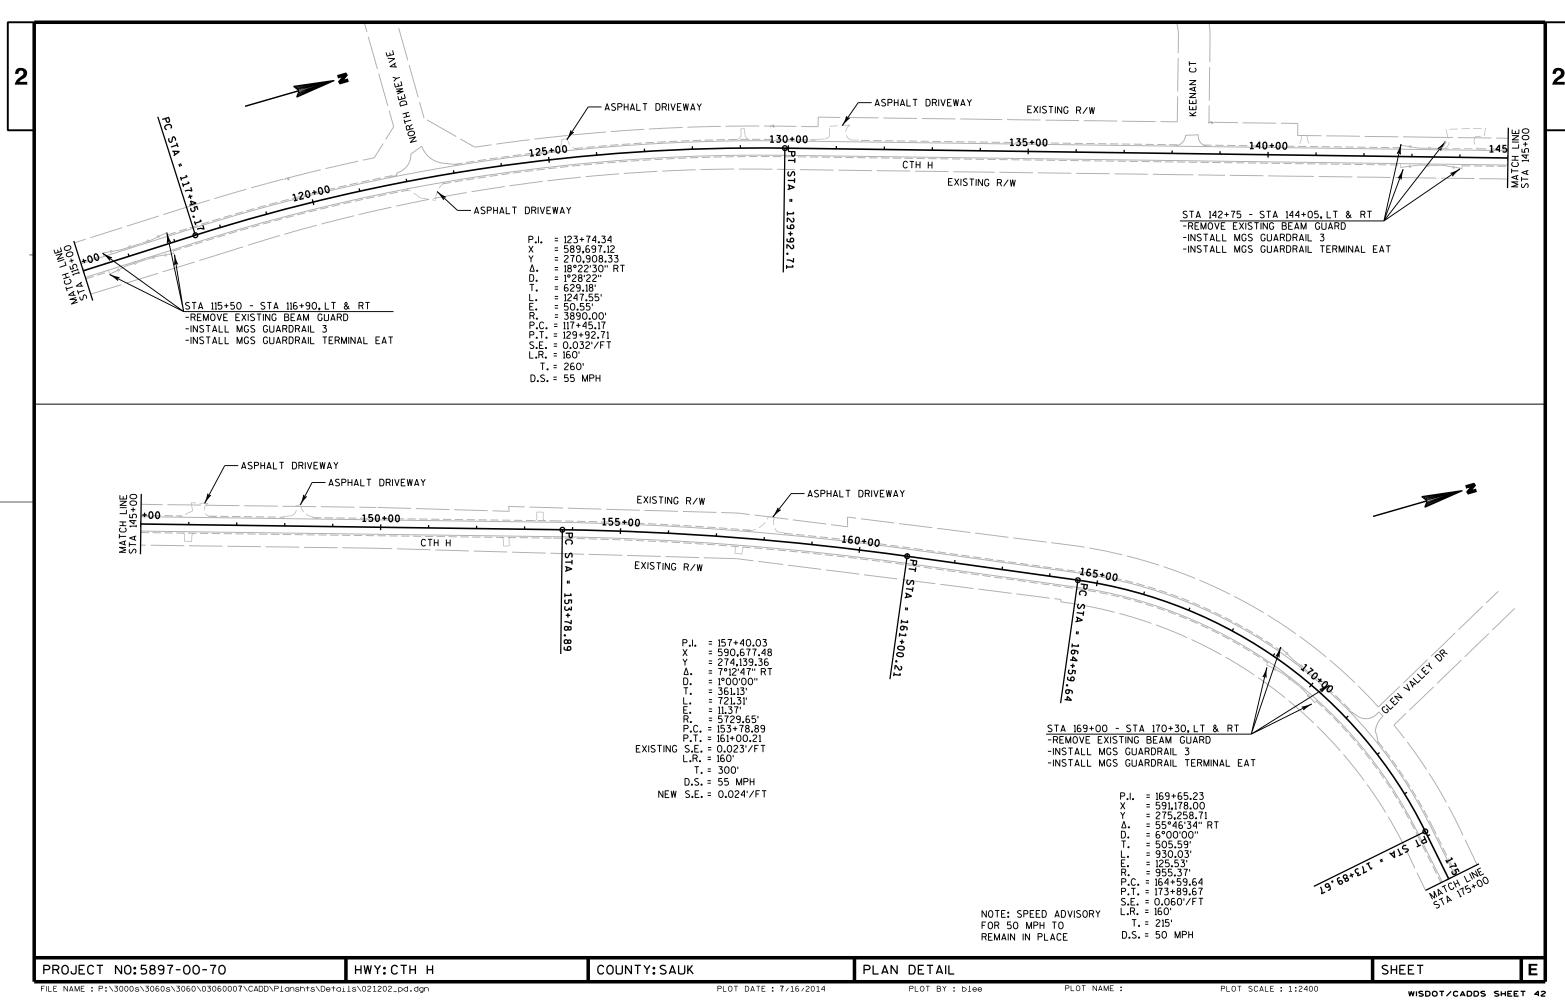


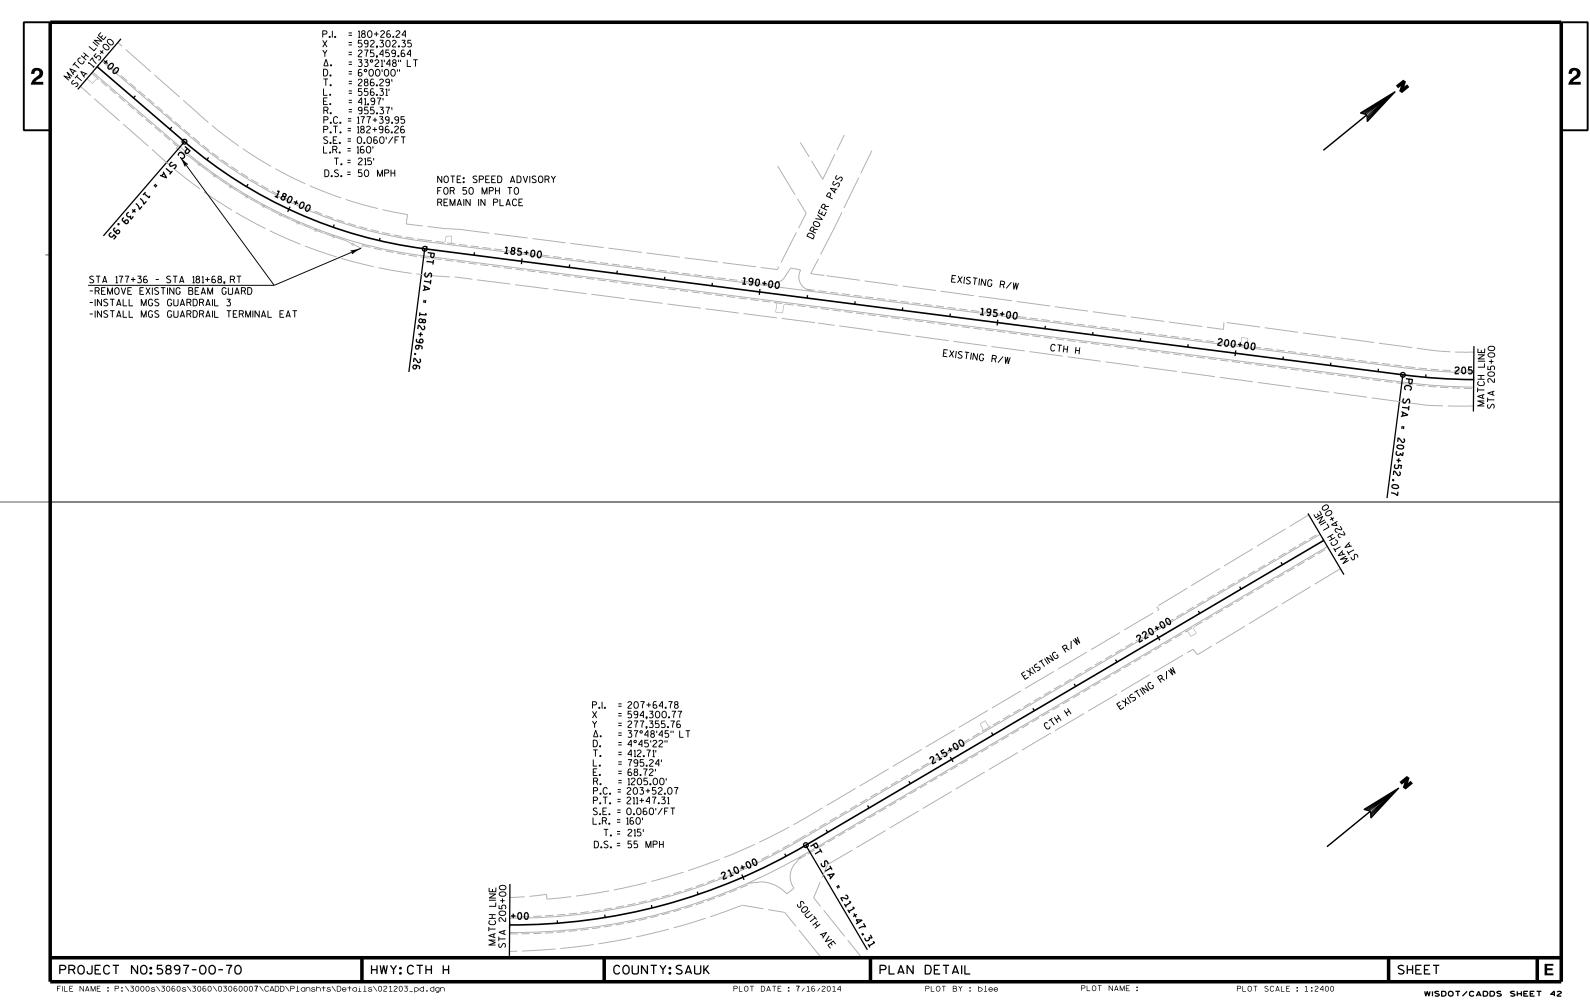


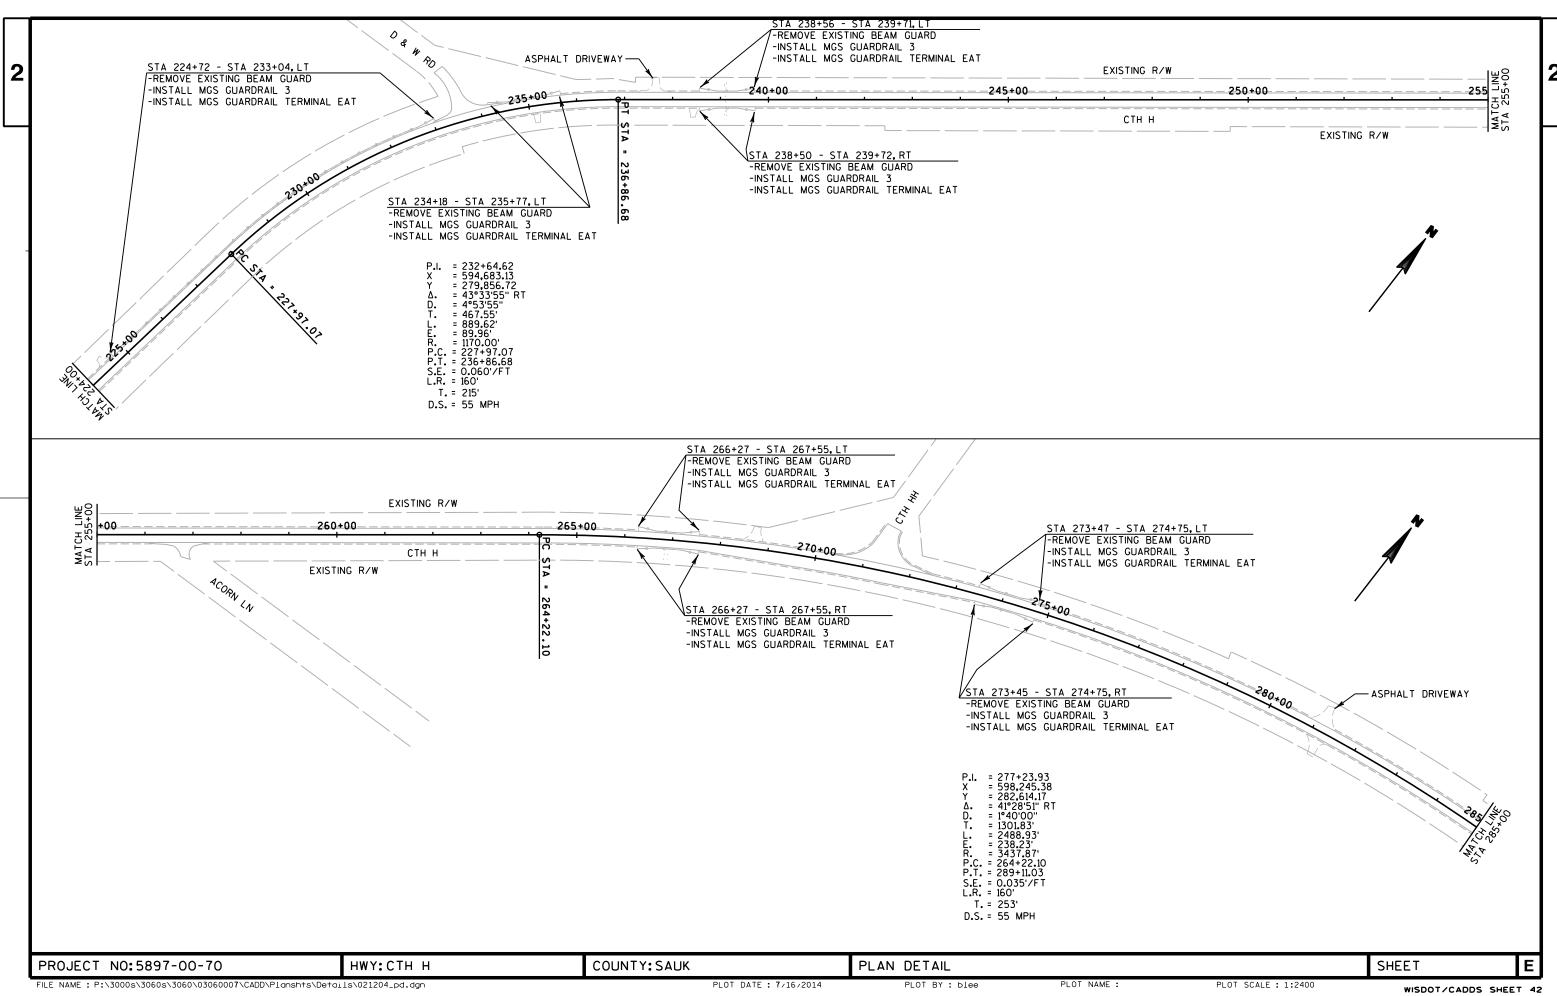


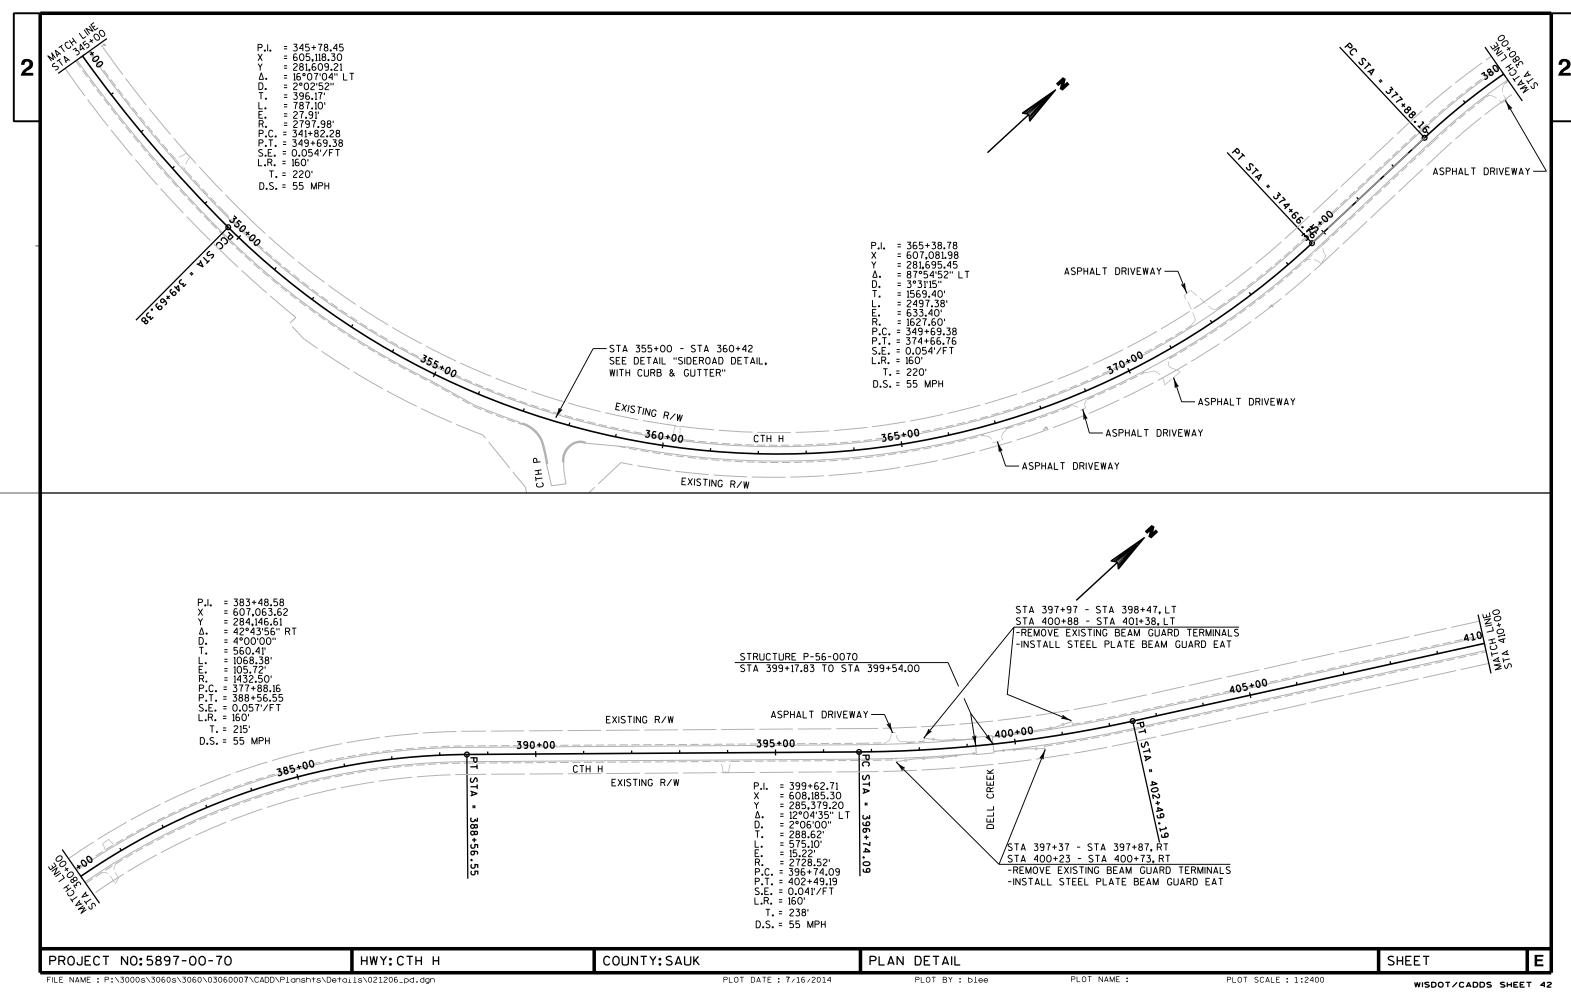


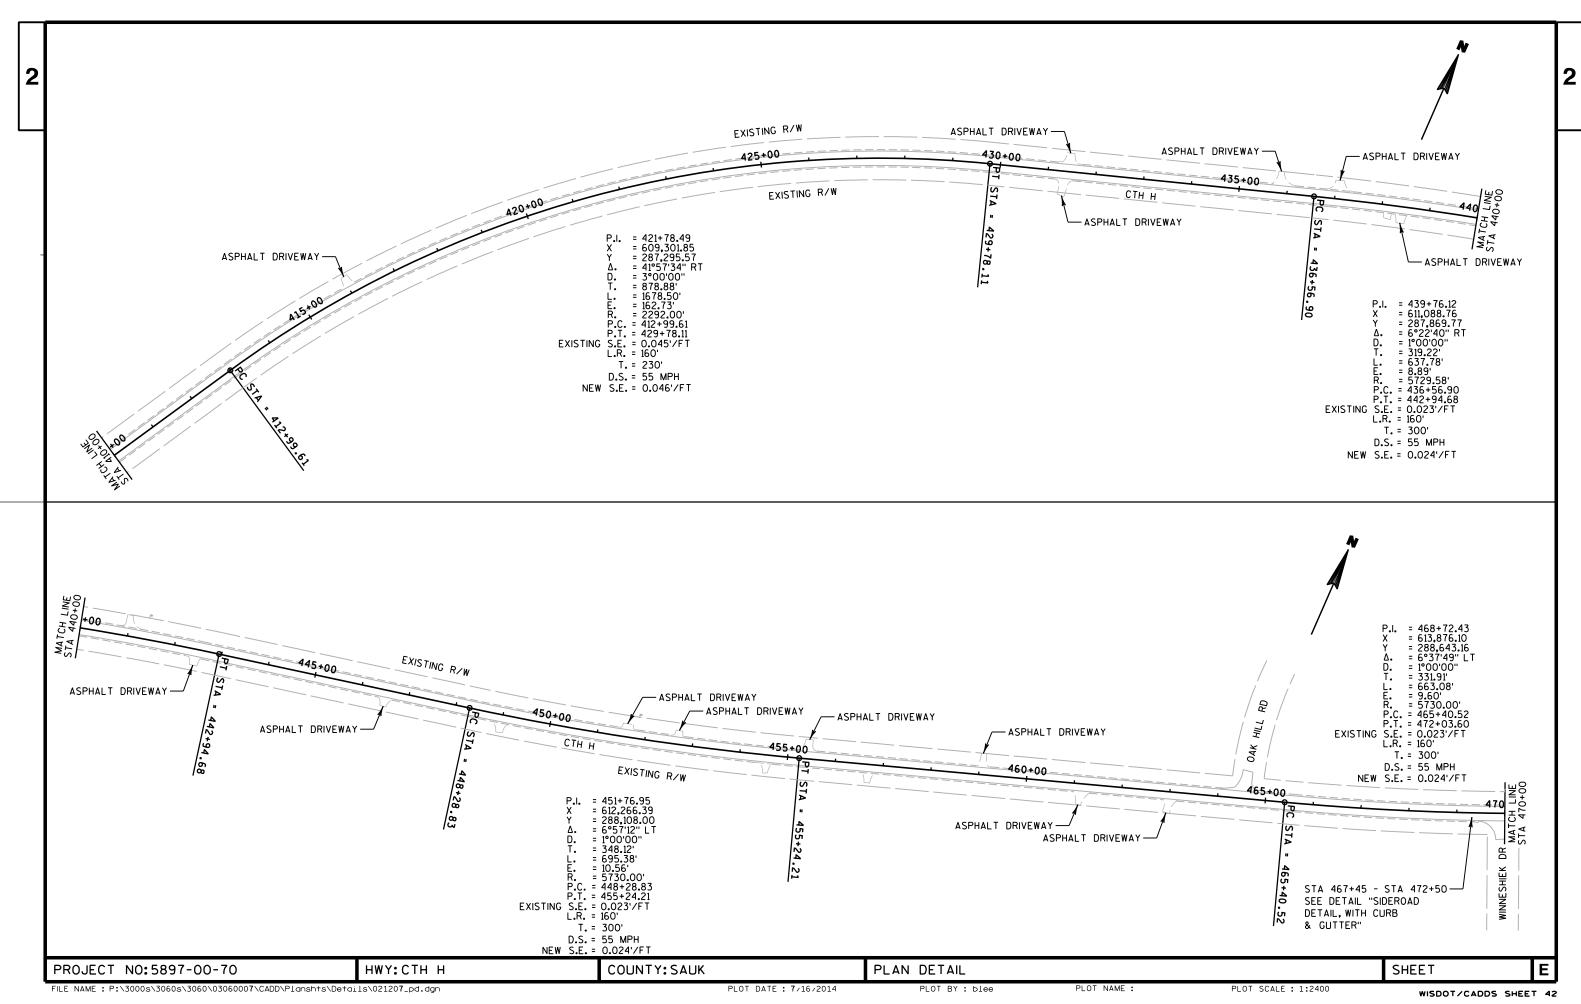

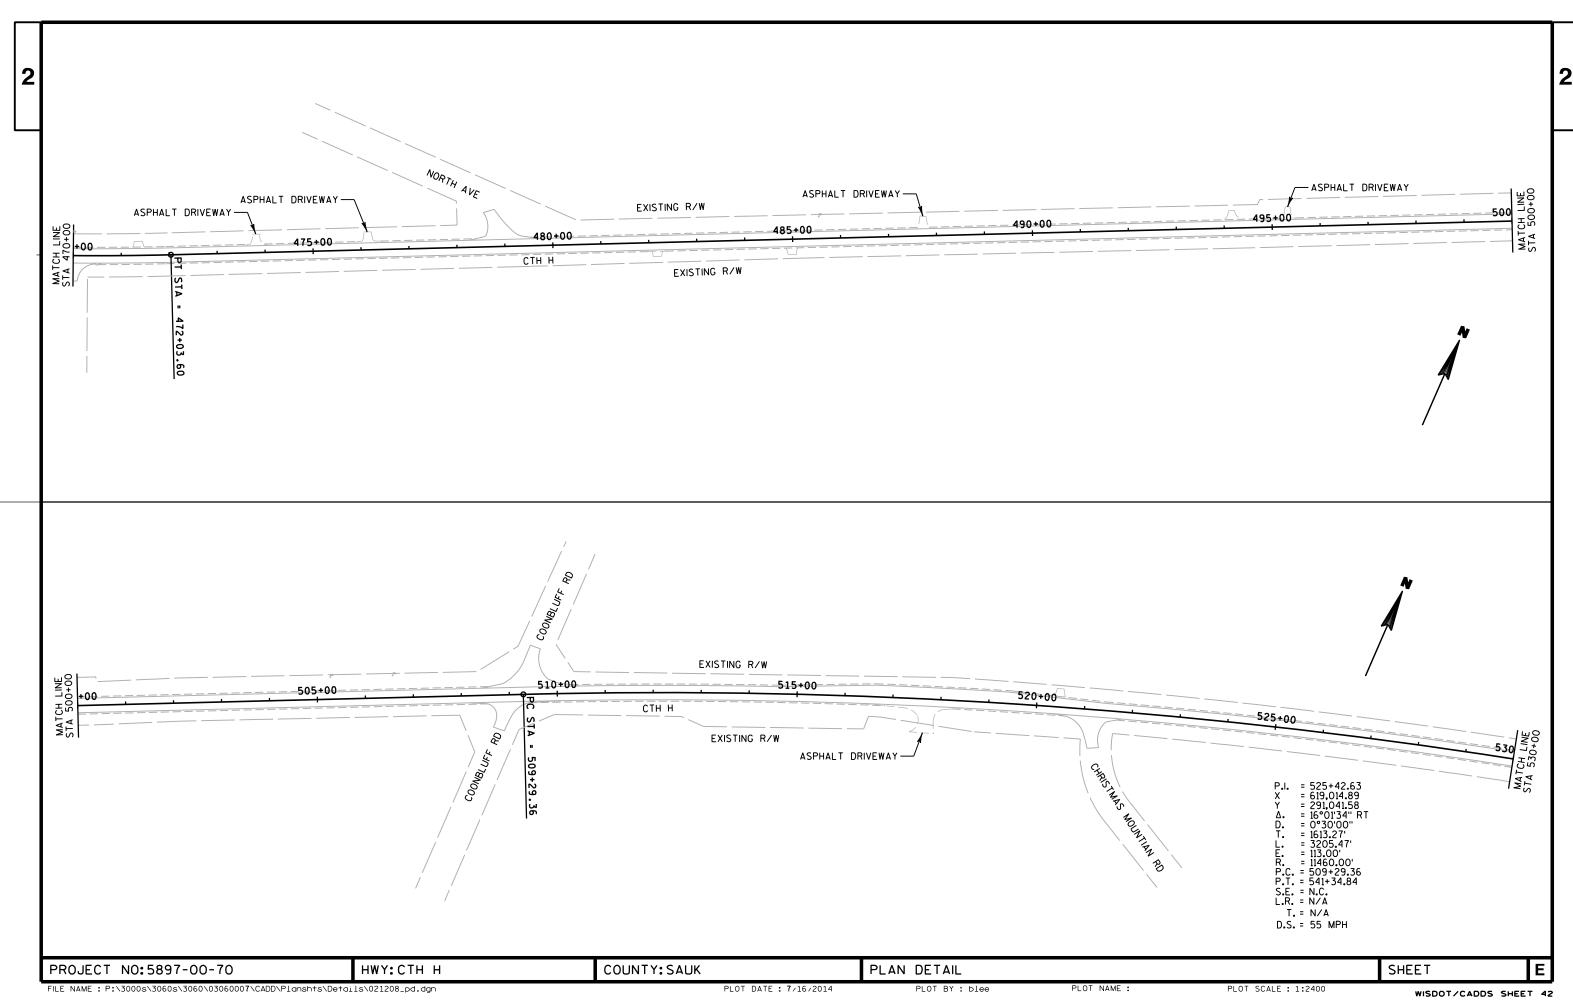

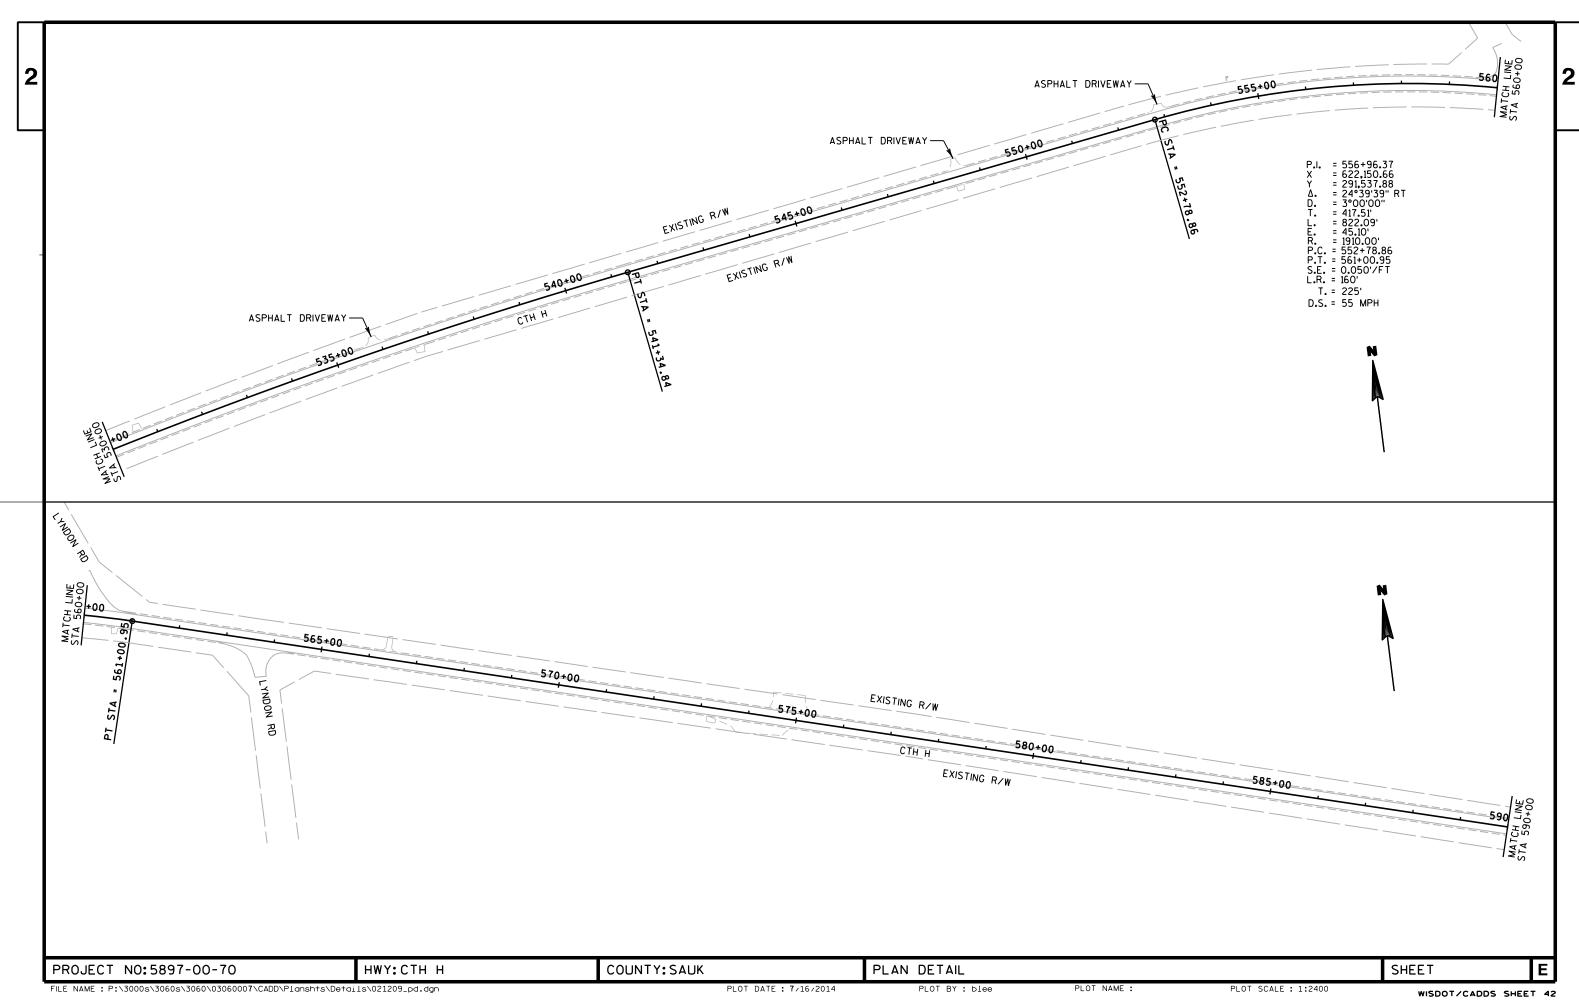

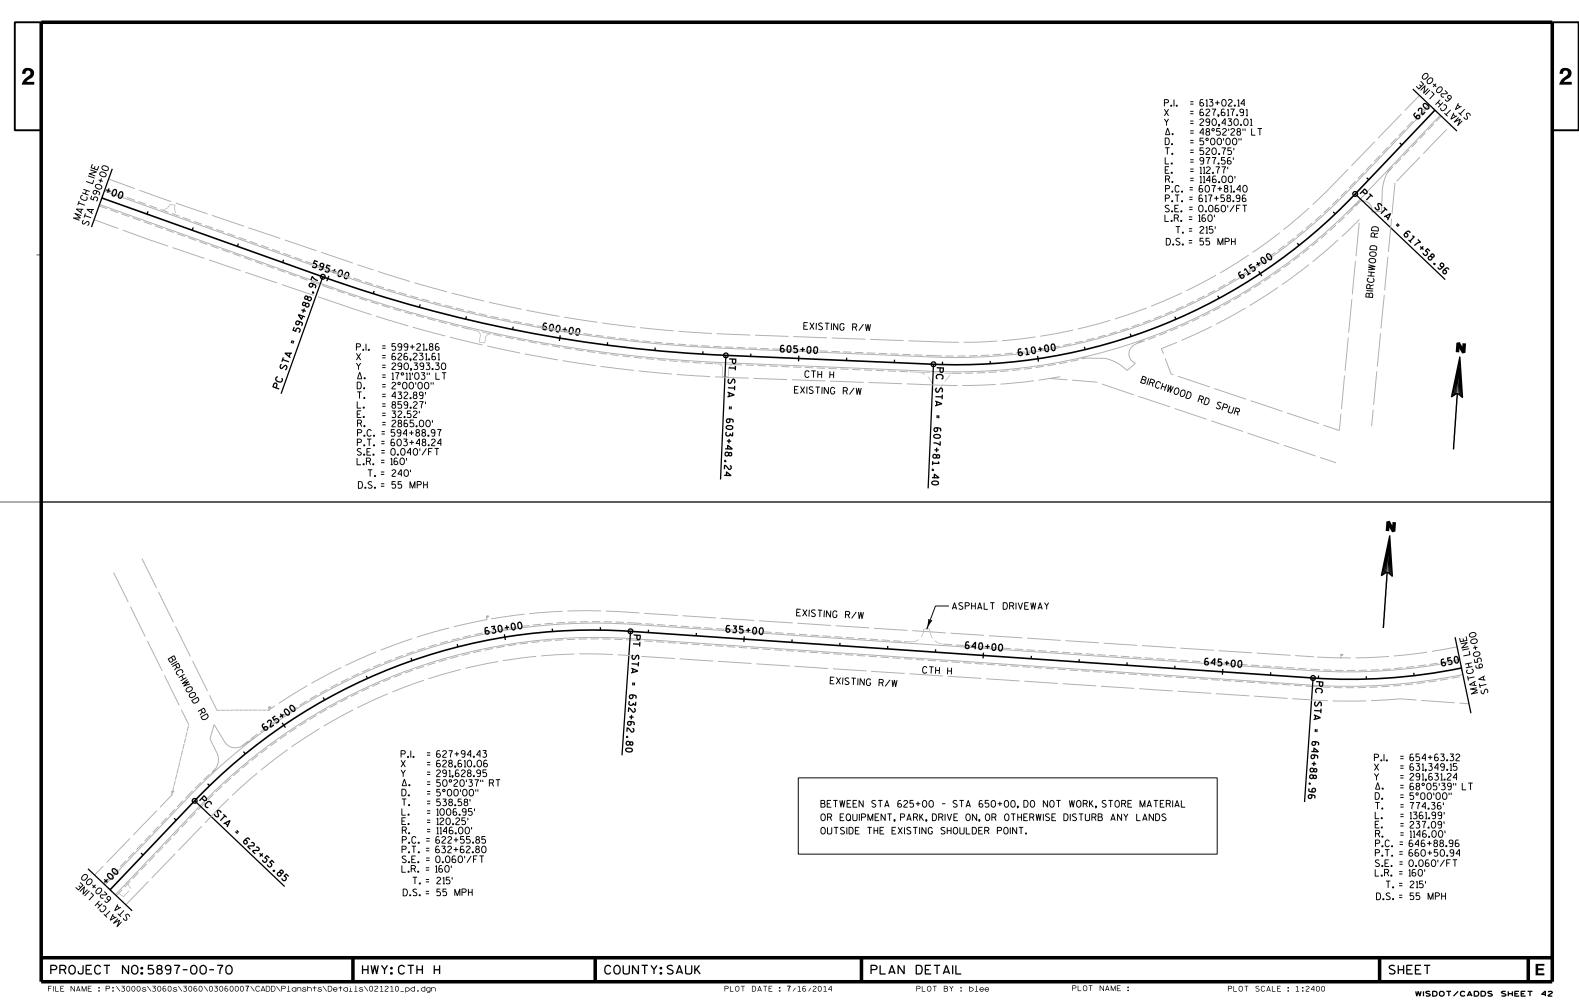

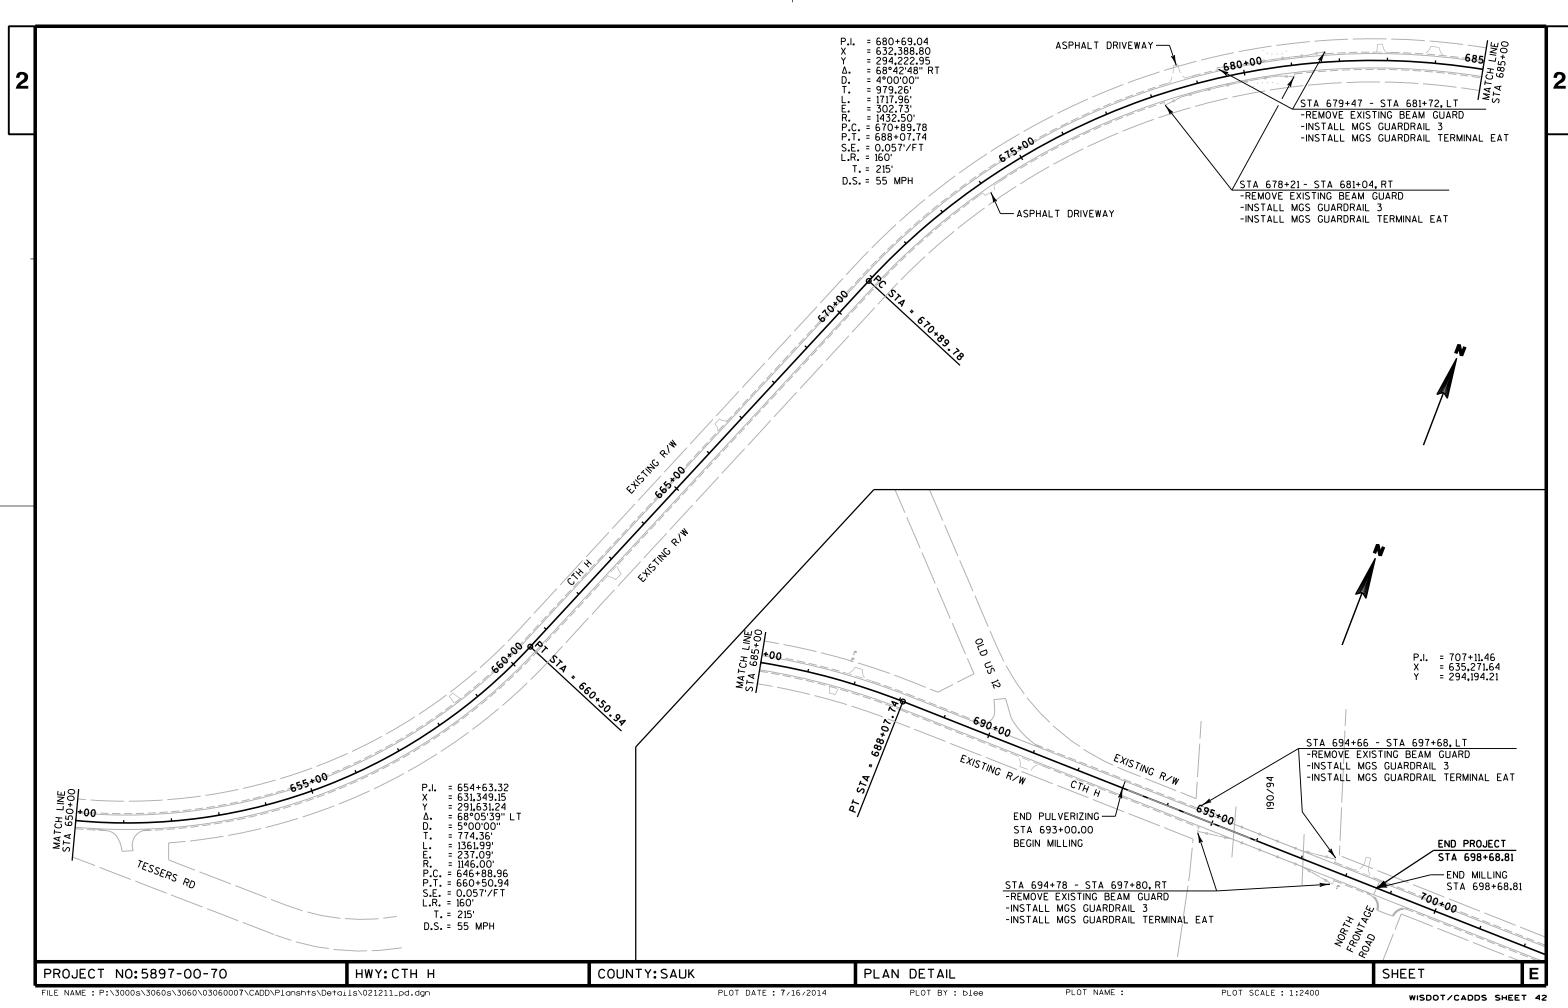

DATE 18	BSEP14	EST	IMAT	E O F Q U A N	
LI NE NUMBER		ITEM DESCRIPTION	UNI T	TOTAL	5897-00-70 QUANTI TY
0010 0020	204. 0110 204. 0120	REMOVING ASPHALTIC SURFACE REMOVING ASPHALTIC SURFACE MILLING	SY SY	2, 118. 000 5, 664. 000	2, 118. 000 5, 664. 000
0030	213. 0100	FINISHING ROADWAY (PROJECT) 01.	EACH	1. 000	1. 000
0040	305. 0110	5897-00-70 BASE AGGREGATE DENSE 3/4-INCH	TON	9, 427. 000	9, 427. 000
0050	305. 0500	SHAPI NG SHOULDERS	STA	617. 000	617. 000
0060	325. 0100	PULVERIZE AND RELAY	SY	7, 812. 000	7, 812. 000
0070		S INCENTIVE IRI RIDE	DOL	48, 944. 000	48, 944. 000
0800	455. 0105	ASPHALTIC MATERIAL PG58-28	TON	2, 473. 000	2, 473. 000
0090 0100	455. 0605 460. 1103	TACK COAT HMA PAVEMENT TYPE E-3	GAL TON	16, 052. 000 44, 760. 000	16, 052. 000 44, 760. 000
0110	460. 2000 465. 0130	INCENTIVE DENSITY HMA PAVEMENT	DOL	28, 654. 000	28, 654. 000
0120	465. 0120	ASPHALTIC SURFACE DRIVEWAYS AND FIELD ENTRANCES	TON	306. 000	306. 000
0130	611. 8110	ADJUSTING MANHOLE COVERS	EACH	1. 000	1.000
0140		S COVER PLATES TEMPORARY	EACH	1.000	1.000
0150	614. 0370	STEEL PLATE BEAM GUARD ENERGY ABSORBING TERMINAL	EACH	4. 000	4. 000
0160	614. 0920	SALVAGED RAIL	LF	6, 800. 000	6, 800. 000
0170 0180	614. 2300 614. 2610	MGS GUARDRAIL 3 MGS GUARDRAIL TERMINAL EAT	LF EACH	3, 600. 000 60. 000	3, 600. 000 60. 000
0190	619. 1000	MOBI LI ZATI ON	EACH	1.000	1. 000
0200	624. 0100	WATER	MGAL	945. 000	945. 000
0210	625. 0100	TOPSOI L	SY	100.000	100.000
0220	627. 0200	MULCHI NG	SY	100.000	100.000
0230 0240	628. 1504 628. 1520	SILT FENCE SILT FENCE MAINTENANCE	LF LF	1, 800. 000 1, 800. 000	1, 800. 000 1, 800. 000
0250	629. 0210	FERTILIZER TYPE B	CWT	25. 800	25. 800
02/0		CEEDLING MINTURE NO. 22		1 105 000	1 105 000
0260 0270	630. 0120 630. 0200	SEEDING MIXTURE NO. 20 SEEDING TEMPORARY	LB LB	1, 105. 000 1, 105. 000	1, 105. 000 1, 105. 000
0280	634. 0612	POSTS WOOD 4X6-INCH X 12-FT	EACH	13.000	13. 000
0290	634. 0614	POSTS WOOD 4X6-INCH X 14-FT	EACH	109.000	109. 000
0300	634. 0616	POSTS WOOD 4X6-INCH X 16-FT	EACH	10. 000	10. 000
0310	637. 2210	SIGNS TYPE II REFLECTIVE H	SF	417. 150	417. 150
0320	637. 2230	SIGNS TYPE II REFLECTIVE F	SF	529.000	529. 000
0330 0340	638. 2602 638. 3000	REMOVING SIGNS TYPE II REMOVING SMALL SIGN SUPPORTS	EACH EACH	157. 000 120. 000	157. 000 120. 000
0340	642. 5001	FIELD OFFICE TYPE B	EACH	1. 000	1. 000
0260		TRAFFIC CONTROL (DDC LFCT) 04 F007 00 70	FACU	1 000	1 000
0360 0370	643. 0100 646. 0106	TRAFFIC CONTROL (PROJECT) 01. 5897-00-70 PAVEMENT MARKING EPOXY 4-INCH	EACH LF	1. 000 126, 199. 000	1. 000 126, 199. 000
0380	646. 0126	PAVEMENT MARKING EPOXY 8-INCH	LF	150.000	150. 000
0390	646. 0406	PAVEMENT MARKING SAME DAY EPOXY 4-INCH	LF	83, 887. 000	83, 887. 000
0400	647. 0566	PAVEMENT MARKING STOP LINE EPOXY 18-INCH	나	38. 000	38. 000
0410	648. 0100	LOCATING NO-PASSING ZONES	MI	12. 240	12. 240
0420	649. 0200	TEMPORARY PAVEMENT MARKING REFLECTIVE	LF	167, 774. 000	167, 774. 000
0430	650. 8000	PAINT 4-INCH CONSTRUCTION STAKING RESURFACING	LF	63, 402. 000	63, 402. 000
		REFERENCE			,
0440	690. 0150	SAWING ASPHALT	LF ups	2, 236. 000	2, 236. 000
0450	ASP. 1T0A	ON-THE-JOB TRAINING APPRENTICE AT \$5. OO/HR	HRS	1, 600. 000	1, 600. 000
04/0	ACD 4700		LIDO	4 000 000	4 000 000
0460 0470	ASP. 1T0G SPV. 0035	ON-THE-JOB TRAINING GRADUATE AT \$5.00/HR SPECIAL O1. BASE REPAIR FOR CIR PAVEMENT	HRS CY	1, 320. 000 13, 825. 000	1, 320. 000 13, 825. 000
0470	SPV. 0060	SPECIAL 01. ADJUSTING WATER VALVES	EACH	3. 000	3. 000

	DATE 18 LINE	BSEP14	E S	TIMAT	E OF QUAN	TITIES 5897-00-70	
	NUMBER	ITEM	ITEM DESCRIPTION	UNI T	TOTAL	QUANTI TY	
	0490	SPV. 0105	SPECIAL 01. PREPARATION OF FOUNDATION FOR CIR PAVEMENT 5897-00-70	LS	1.000	1. 000	
	0500	SPV. 0105	SPECIAL 02. PREPARE FOUNDATION FOR HMA PAVING 5897-00-70	LS	1.000	1. 000	
	0510	SPV. 0180	SPECIAL 01. COLD-IN-PLACE RECYCLING (CIR) PAVEMENT PARTIAL DEPTH	SY	207, 371. 000	207, 371. 000	
	0520	SPV. 0195	SPECÍAL 01. ASPHALT STABILIZING AGENT	TON	929. 000	929. 000	
3							

									20E 044	10 BASE AGGREGA	TE DENICE 2/4 IN	VICH				
		HALTIC SURFACE							305.01	IU DASE AGGREGA	11E DENSE 3/4-11	NCH BASE				
204.0120 R	REMOVING ASPI	HALTIC SURFACE MILLING								STATION - STATION	LOCATI					
		D		LIALTIC DEMOVING ACRUALTIC						52+48.54 - 58+61.53	RT	2				
		K	SURFACE	HALTIC REMOVING ASPHALTIC SURFACE MILLING						58+61.53 - 693+00	RT & L	_T 7,427				
AOITAT2	N - STATION	LOCATION	SUKFACE	SURFACE WILLING SY						693+00 - 698+68.81	RT & L					
	54 - 58+61.53	C & G SECTION		2,991						DRIVEWAYS	RT & L					
	7+75, RT	CTH P		366						UNDISTRIBUTED		1,869				
	0+00, RT	WINNESHIEK DR		237												
693+00	0 - 698+68.81	UNDER BRIDGE		2,070							TOTA	L 9,427				
60+61.39	9 - 355+00.00	BEAM GUARD AREAS	567	, 		05.0500 SHAPING SH		A \ /E B 4 E B I T								
397+50	50 - 400+60	BEAM GUARD AREAS	69			SPV.0035.01 BASE REP SPV.0105.01 PREPARAT			OID DAV/EMENT C	007 00 70						
678+00.0	00 - 682.00.00	BEAM GUARD AREAS	44		_	SPV.0105.01 PREPARA SPV.0105.02 PREPARE			-	897-00-70						
	53+80	RT	30		3	0F V.0103.02 FREFARE	FOUNDATION F	-OK HIVIA FA	VING 5697-00-70							
	73+15	RT	17						SHAPING	BASE**	ASPHALTIC**	ASPHALTIC**	BASE REPAIR	CIR	HMA	
	73+40	LT	37						SHOULDERS	1 1/4-INCH	BASE	SURFACE	FOR CIR	PAVEMENT	PAVING	
	77+85	RT	12			STATION - STATION	LOC	CATION	STA	TON	TON	TON	CY	LS	LS	
	87+00	LT	35			60+61.53 - 355+00.0		CATIONS	295	11,131	2,244	2,244	6,678			_
	110+30	LT	18			360+42.00 - 397+17.8		CATIONS	37	1,362	275	275	817			
	122+35	RT	49			401+54.00 - 467+45.0		CATIONS	66	2,442	493	493	1,465			
	25+35	LT	26			472+50.00 - 691+00.0		CATIONS	219	8,109	1,635	1,635	4,865			
	31+00 46+15	LT LT	54 38			PROJECT 5897-00-7	CIR LO	CATIONS						1	1	
	146+15 148+30	LT	38 40													
	148+30 58+00	LI LT	40 45	 	_	TOTAL			617	23,044	4,647	4,647	13,825	1	1	_
	237+65	LT	45 32	 												
	281+15	LT	35		**	* FOR INFORMATIONAL	PURPOSES O	NLY TO ESTI	MATE FOR SPV.0	035.01 BASE REPAIR	R FOR CIR PAVE	MENT				
	290+60	LT	20													
	308+10	LT	25		325.0100 PULVERIZE AND RE	ELAY				10 4440 C INIOENTS	E IDI DIDE					
	316+95	RT	14		624.0100 WATER				44	10.4410.S INCENTIV	E IRI RIDE					
	320+85	LT	21			_								INCENTIVE		
33	334+15	LT	25				WATER**			STATION - STA	ATION	MILES	LANE MILES	DOL		
	366+95	RT	35			AND RELAY	*		_	52+48.54 - 399-		6.57	13.14	\$26,280		
37	370+60	RT	42		LOCATION 50 COLOR 50	SY COA	MGAL			399+54 - 698+		5.67	11.33	\$20,260 \$22,664		
37	371+95	LT	41		58+61.53 - 60+61.53	694	2			J997J4 - U907	00.01	5.07	11.00	ψ ∠ ∠,00 4		
37	379+70	RT	32		355+00.00 - 360+42.00	2,151	7		_				TOTAL	\$48,944		
39	397+50	LT	29		397+17.83 - 399+17.83 399+54.00 - 401+54.00	743 745	2						10 17 L	ψ.ιο,ο		
41	116+00	LT	17				6									
	131+35	RT	30		467+45.00 - 472+50.00 691+00.00 - 693+00.00	1,683 667	2									
	131+45	LT	29		GOLF COURSE RD	324	1	455.0105	ASPHALTIC MA	TERIAI PG58-28						
	135+90	LT	29		WILLOW CREEK RD	158	1		TACK COAT							
	137+10	LT	35		CHADWICK RD	170	1		HMA PAVEMEN	IT TYPE E-3						
	138+40	RT	19		NORTH DEWEY AVE	311	1			ISITY HMA PAVEMEN	NT					
	142+45	RT DT	20		KEENAN CT	167	1									
	146+50	RT	19		GLEN VALLEY DR	157	1						**			
	151+65 152+70	LT LT	21 15		DROVER PASS	203	1				THICKNESS	MATERIA MATERIA	L TAC	K	HMA	INCENTIVE
	152+70 155+40	LT	24		SOUTH AVE	272	1	S1	TATION - STATION		INCH	TON	GAI	<u>L</u>	TON	DOL
	159+05	LT	2 4 17	 	D&W RD	264	1		2+48.54 - 60+61.39		4	36	73		647	\$415
	161+15	RT	22		ACORN LN	163	1		2+48.54 - 60+61.39		4	3	5		45	\$29
	163+00	RT	18		CTH HH	495	2		+61.39 - 355+00.00		3.5	1,064	2,46		19,329	\$12,371
	173+80	LT	23		CHERRY LN	143	0		+61.39 - 355+00.00			39	89		691	\$443
	176+15	LT	27		BLUEBIRD LN	162	1		+61.39 - 355+00.00			27	61		474	\$304
	187+70	LT	17		TOWN HALL RD	535	2		5+00.00 - 360+42.0		4	23	46		405	\$260
	195+30	LT	20		OAK HILL RD	175	1		5+00.00 - 360+42.0		4	10	19		165	\$106
	517+65	RT	93		NORTH AVE	290	1)+42.00 - 397+17.8		3.5	133	307		2,402	\$1,538
	535+85	LT	34		COONBLUFF RD	672	2		'+17.83 - 399+17.8		4	9	17		150	\$96
54	548+50	LT	27		CHRISTMAS MOUNTAIN R		7		'+17.83 - 399+17.8)+54.00 - 401+54.0		D 4 4	9	<u>4</u> 17		32 150	\$21 \$96
55	552+90	LT	29		LYNDON RD	622	2				•	9	17		150 23	\$96 \$15
	38+80	LT	45		BIRCHWOOD RD SPUR	256 434	1)+54.00 - 401+54.0 +54.00 - 691+00.0		D 4 3.5	1,041	3 2,41	ვ 1	23 18,912	\$15 \$12,104
67	674+05	RT	26		BIRCHWOOD RD TESSERS RD	424 202	1		+54.00 - 691+00.0			38	2,41	J 1	18,912 686	\$12,104 \$440
67	678+60	LT	30		OLD US 12	202 340	1		+54.00 - 691+00.0			38	5		39	\$440 \$25
					OLD 03 12	3 4 0	ı		+00.00 - 698+68.8		<u> </u>	32	65		575	\$368
		TOTAL	2,118	5,664	TOTAL	7,812	26		+00.00 - 698+68.8		· -	2	4		35	\$23
					*RATE OF 10 GALS/TON OF F	PULVERIZED MATERIAL					TOTAL	2,473	5,68	2 4	14,760	\$28,654
					** ADDITIONAL QUANTITIES L	ISTED ELSEWHERE		J								
								** ADDITI	IONAL QUANTITIE	S LISTED ELSEWHEI	RÉ					
PROJECT	NO: 5897-0	0-70		HWY: CTH H	COUNTY: S	AUK			MISCELLAN	EOUS QUANTIT	ΓIES		SHE	ET		E

455.0605 TACK COAT

SPV.0180.01 COLD-IN-PLACE RECYCLING (CIR) PAVEMENT PARTIAL DEPTH

SPV.0195.01 ASPHALT STABILIZING AGENT

TACK CIR AGENT STATION - STATION GAL SY TON 60+61.53 - 355+00.00 5,009 100,173 449 55 360+42.00 - 397+17.83 613 12,253 401+54.00 - 467+45.00 1,099 21,970 98 472+50.00 - 691+00.00 3,649 72,975 327

929

TOTAL 10,370 207,371

** ADDITIONAL QUANTITIES LISTED ELSEWHERE
NOTE: TACK LAYER IS ON TOP OF CIR LAYER USING A RATE OF 0.05 GAL/SY

465.0120 ASPHALTIC SURFACE DRIVEWAYS AND FIELD ENTRANCES

53+80 RT 6 73+15 RT 4 73+40 LT 8 77+85 RT 3 87+00 LT 7 110+30 LT 4 122+35 RT 10 125+35 LT 6 131+00 LT 11 146+15 LT 8 148+30 LT 8 148+30 LT 8 158+00 LT 9 237+65 LT 7 281+15 LT 7 281+15 LT 7 290+60 LT 4 308+10 LT 6 316+95 RT 3 320+85 LT 5 334+15 LT 6 370+60 RT 9 371+95 LT 9 379+70 RT 7 397+50 LT 6 416+00 LT 4 431+45 LT 6<
73+40 LT 8 77+85 RT 3 87+00 LT 7 110+30 LT 4 122+35 RT 10 125+35 LT 6 131+00 LT 11 146+15 LT 8 148+30 LT 8 158+00 LT 9 237+65 LT 7 281+15 LT 7 290+60 LT 4 308+10 LT 6 316+95 RT 3 320+85 LT 5 334+15 LT 6 366+95 RT 7 370+60 RT 9 371+95 LT 9 379+70 RT 7 397+50 LT 6 416+00 LT 4 431+45 LT 6 437+10 LT 7 438+40 RT 4 445+65 LT
77+85 RT 3 87+00 LT 7 110+30 LT 4 122+35 RT 10 125+35 LT 6 131+00 LT 11 146+15 LT 8 148+30 LT 8 158+00 LT 9 237+65 LT 7 281+15 LT 7 290+60 LT 4 308+10 LT 6 316+95 RT 3 320+85 LT 5 334+15 LT 6 370+60 RT 9 371+95 LT 9 379+70 RT 7 397+50 LT 6 416+00 LT 4 431+35 RT 6 431+45 LT 6 437+10 LT 7 438+40 RT 4
87+00 LT 7 110+30 LT 4 122+35 RT 10 125+35 LT 6 131+00 LT 11 146+15 LT 8 148+30 LT 8 158+00 LT 9 237+65 LT 7 281+15 LT 7 290+60 LT 4 308+10 LT 6 316+95 RT 3 320+85 LT 5 334+15 LT 6 370+60 RT 9 371+95 LT 9 379+70 RT 7 397+50 LT 6 416+00 LT 4 431+45 LT 6 437+10 LT 7 438+40 RT 4 442+45 RT 4 455+70 LT 4
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446+50 RT 4 451+65 LT 5 452+70 LT 4 455+40 LT 5 459+05 LT 4 461+15 RT 5 463+00 RT 4 473+80 LT 5 476+15 LT 6
451+65 LT 5 452+70 LT 4 455+40 LT 5 459+05 LT 4 461+15 RT 5 463+00 RT 4 473+80 LT 5 476+15 LT 6
452+70 LT 4 455+40 LT 5 459+05 LT 4 461+15 RT 5 463+00 RT 4 473+80 LT 5 476+15 LT 6
455+40 LT 5 459+05 LT 4 461+15 RT 5 463+00 RT 4 473+80 LT 5 476+15 LT 6
459+05 LT 4 461+15 RT 5 463+00 RT 4 473+80 LT 5 476+15 LT 6
461+15 RT 5 463+00 RT 4 473+80 LT 5 476+15 LT 6
463+00 RT 4 473+80 LT 5 476+15 LT 6
473+80 LT 5 476+15 LT 6
476+15 LT 6
487+70 LT 4
495+30 LT 4
517+65 RT 19
535+85 LT 7
548+50 LT 6
552+90 LT 6
638+80 LT 9
674+05 RT 6
678+60 LT 6
TOTAL 306

611.8110 ADJUSTING MANHOLE COVERS 611.8120.S COVER PLATES TEMPORARY SPV.0060.01 ADJUSTING WATER VALVES

			ADJUS I	COVER	WATER
			COVER	PLATES	VALVES
CATEGORY	STATION	LOCATION	EACH	EACH	EACH
020	690+00	RT	1	1	
	691+00	OLD HWY 12			1
	695+00	WEST OF IH 90			1
	698+00	EAST OF IH 90			1
	TOTAL CAT	TEGORY 020	1	1	3

PROJECT NO: 5897-00-70 HWY: CTH H COUNTY: SAUK MISCELLANEOUS QUANTITIES SHEET **E**

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	614.0920 SALVAGED RAIL			
	STATION - STATION	LOCATION	LF	
	62+25 - 63+60	RT	137.5	
	62+50 - 63+75	LT	125	
	74+13 - 77+41	RT	325	
	83+05 - 89+83	RT	675	
	83+57 - 86+22	LT	262.5	
	94+88 - 98+23	RT	337.5	
	99+80 - 101+55	RT	175	
	115+50 - 116+90	LT & RT	275	
	142+75 - 144+05	LT & RT	250	
	169+00 - 170+30	LT & RT	250	
	177+36 - 181+68	RT	437.5	
	224+72 - 233+04	LT	837.5	
	234+18 - 235+77	LT	162.5	
	238+56 - 239+71	LT	112.5	
	238+50 - 239+72	RT	125	
	266+27 - 267+55	LT & RT	250	
	273+45 - 274+75	RT	125	
	273+47 - 274+75	LT	125	
	304+02 - 305+30	LT	125	
	304+04 - 305+32	RT	125	
	321+17 - 322+46	LT	125	
	321+14 - 322+42	RT	125	
	397+50 - 400+00	RT	50	
	398+10 - 398+60	LT	50	
	400+75 - 401+25	LT	50	
	400+10 - 400+60	RT	50	
	678+21 - 681+04	RT	287.5	
	679+47 - 681+72	LT	225	
	694+66 - 697+68	LT	300	
	694+78 - 697+80	RT	300	
		TOTAL	6,800	
<u> </u>	STEEL PLATE BEAM GUARD ENE			
,	OILLE LAIL DEAN GOAND LINE	IND I ADDODING IL	1 \1V111 1 /_	

614.0370 STEEL PLATE BEAM GUARD ENERGY ABSORBING TERMINAL

614.2300 MGS GUARDRAIL 3

PROJECT NO: 5897-00-70

614.2610 MGS GUARDRAIL TERMINAL EAT

STATION - STATION	LOCATION	STEEL PLATE EAT EACH	MGS GUARDRAIL LF	MGS TERMINAL EACH
62+21 - 63+64	RT		37.5	2
62+47 - 63+78	LT		25	2
74+11 - 77+43	RT		225	2
83+03 - 89+85	RT		575	2
83+55 - 86+24	LT		162.5	2
94+84 - 98+27	RT		237.5	2
99+77 - 101+58	RT		237.3 75	2
115+48 - 116+92	LT & RT		75 75	4
142+74 - 144+06	LT & RT		50	4
168+99 - 170+31	LT & RT		50 50	4
177+30 - 181+74	RT		337.5	2
224+66 - 233+10	LT		337.5 737.5	2
234+13 - 235+82 238+54 - 239+73	LT LT		62.5 12.5	2 2
238+45 - 239+77	RT		25	2
266+25 - 267+57	LT & RT		50	4
273+44 - 274+76	RT		25	2
273+45 - 274+77	LT		25	2
304+00 - 305+32	LT		25	2
304+02 - 305+34	RT		25	2
321+16 - 322+47	LT		25	2
321+12 - 322+44	RT		25	2
397+37 - 397+87	RT	1		
397+97 - 398+47	LT	1		
400+88 - 401+38	LT	1		
400+23 - 400+73	RT	1		
678+16 - 681+09	RT		187.5	2
679+44 - 681+75	LT		125	2
694+64 - 697+70	LT		200	2
694+76 - 697+82	RT		200	2
	TOTAL	4	3600	60
T NO: 5897-00-70		HW	Y: CTH H	

624.0100 WATER 625.0100 TOPSOIL 627.0200 MULCHING 629.0210 FERTILIZER TYPE B 630.0120 SEEDING MIXTURE NO. 20

630.0200 SEEDING TEMPORARY

				SEED	TEMPORARY	**
	TOPSOIL	MULCH	FERTILIZER	NO 20	SEED	WATER
STATION - STATION	SY	SY	CWT	LB	LB	MGAL
UNDISTRIBUTED	100	100	25.8	1,105	1,105	919
TOTAL	100	100	25.8	1.105	1.105	919

^{**} ADDITIONAL QUANTITIES LISTED ELSEWHERE

628.1504 SILT FENCE 628.1520 SILT FENCE MAINTENANCE

		SILT FENCE	MAINTENANCE
STATION - STATION	LOCATION	LF	LF
397+00 - 402+00	LT & RT	1000	1000
677+00 - 682+00	LT & RT	800	800
	TOTAL	1800	1800

634.0612 POSTS WOOD 4x6-INCH X 12-FT 634.0614 POSTS WOOD 4x6-INCH X 14-FT 634.0616 POSTS WOOD 4x6-INCH X 16-FT 637.2210 SIGNS TYPE II REFLECTIVE H 637.2230 SIGNS TYPE II REFLECTIVE F

				TYPE H	TYPE F	12-FT	14-FT	16-FT	
STATION	LOCATION	CODE	SIZE	SF	SF	EACH	EACH	EACH	COMMENTS
52+55	RT	W6-3	36" X 36"		9.0	1			
53+30	LT	R2-1	24" X 30"	5.00		1			
54+40	LT	R3-7R	30" X 30"	6.25		1			
54+60	RT	W1-2R	30" X 30"		6.25	1			
		W13-1	18" x 18"		2.25				
56+55	RT	R1-1	30" X 30"	5.18		1			
57+35	RT	R2-1	24" X 30"	5.00		1			
57+40	LT	D9-2	24" X 24"	4.00		1			
59+80	LT	12-3	66" X 24"	11.00		2			POPULATION
60+65	LT	W3-5	36" X 36"		9.00		1		
78+35	RT	R2-1	24" X 30"	5.00			1		
83+65	RT	W1-2L	30" X 30"		6.25		1		
		W13-1	18" X 18"		2.25				
83+65	LT	W1-2L	30" X 30"		6.25		1		
		W13-1	18" X 18"		2.25				
91+30	RT	W2-2R	30" X 30"		6.25		1		
93+10	LT	R2-1	24" X 30"	5.00			1		
93+60	RT	W1-6L	48" X 24"		8.00		1		
99+55	RT	R1-1	30" X 30"	5.18			1		
104+05	LT	R1-1	30" X 30"	5.18		1			
109+20	LT	R2-1	24" X 30"	5.00			1		
111+90	LT	W1-2R	30" X 30"		6.25		1		
		W13-1	18" X 18"		2.25		1		
112+00	RT	R2-1	24" X 30"	5.00			1		
		W14-3	36" X 48"		6.00				
113+65	LT	R1-1	30" X 30"	5.18			1		
118+30	LT	W14-3	36" X 48"		6.00		1		
		W3-5	36" X 36"		9.00		1		
122+05	LT	R1-1	30" X 30"	5.18			1		
137+30	RT	W14-3	36" X 48"		6.00		1		

COUNTY: SAUK	MISCELLANEOUS QUANTITIES	SHEET	Е	
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STATION	LOCATION	CODE	SIZE	TYPE H SF	TYPE F SF	12-FT EACH	14-FT EACH	16-FT EACH	COMMENTS
138+25	LT	R1-1	30" X 30"	5.18			1		COMMENTS
148+70	RT	W1-4R	30" X 30"				1		
140+70	ΚI				6.25				
		W13-1	18" X 18"		2.25				
156+30	LT	W14-3	36" X 48"		6.00		1		
164+59.64	RT	W1-2R	30" X 30"		6.25		1		
		W13-1	18" x 18"		2.25				
171+30	LT	R1-1	30" X 30"	5.18			1		
173+89.67	LT	W1-2L	30" X 30"		6.25		1		
		W13-1	18" x 18"		2.25				
177+39.95	RT	W1-2L	30" X 30"		6.25		1		
177-55.55	IXI	W13-1	18" x 18"		2.25		<u></u>		
400.00.00	DT								
182+96.26	RT	W1-2R	30" X 30"		6.25		1		
		W13-1	18" x 18"		2.25				
190+40	LT	R1-1	30" X 30"	5.18			1		
191+20	LT	W1-4R	30" X 30"		6.25		1		
		W13-1	18" X 18"		2.25				
194+10	RT	W1-2L	30" X 30"		6.25		1		
101110	111	W13-1	18" X 18"		2.25				
			36" X 48"		6.00				
101 70		W14-3							
194+70	LT	W14-3	36" X 48"		6.00		1		
		R2-1	24" X 30"	5.00					
201+90	RT	W2-2R	30" X 30"		6.25		1		
210+90	RT	R1-1	30" X 30"	5.18			1		
221+75	RT	W1-2R	30" X 30"		6.25		1		
		W13-1	18" X 18"		2.25				
222+50	LT	W2-2L	30" X 30"		6.25		1		
225+75	LT	W1-2R	30" X 30"		6.25		1		
226+45	RT	W2-2L	30" X 30"		6.25		1		
233+45	LT	R1-1	30" X 30"	5.18			1		
242+70	RT	W14-3	36" X 48"		6.00		1		
246+05	LT	W14-3	36" X 48"		6.00		1		
		W1-2L	30" X 30"		6.25				
		W13-1	18" X 18"		2.25				
256+20	RT	W1-2R	30" X 30"		6.25		1		
230+20	IXI								
		W13-1	18" X 18"		2.25				
256+95	RT	R1-1	30" X 30"	5.18			1		
264+65	RT	J1-1	24" X 39"	6.50			1		
		M2-1	21" X 15"						JCT
		M1-5A	24" X 24"						CTH HH
265+60	LT	W14-3	36" X 48"		6.00		1		
266+45	RT	D1-1	60" X 15"	6.25			2		LEFT ARROW, LYNDON
268+85	RT	W14-3	36" X 48"		6.00		1		LET TYTING W, ETHOON
271+10	LT	R1-1	30" X 30"	5.18		1			
		J1-2	48" X 39"	13.00			2		
		M1-5A	24" X 24"						CTH H
		M6-4	21" X 21"						DOUBLE ARROW
		M1-5A	24" X 24"						CTH HH
		M4-6	24" X 12"						END
271+25	RT	J13-1	24" X 45"	7.50			1		
21 1725	IXI								
		M1-5A	24" X 24"						CTH HH
		M6-1	21" X 21"						ARROW LEFT
271+25	RT	D1-2	72" X 30"	15.00			2		WIS DELLS LT, REEDSBURG
271+30	RT	W1-7	48" X 24"		8.00			1	
272+30	LT	J13-1	24" X 45"	7.50			1		
		M1-5A	24" X 24"						СТН НН
		M6-1	21" X 21"						ARROW RIGHT
206 25	1.7								
286+25	LT	J1-1	24" X 39"	6.50			1		
		M2-1	21" X 15"						JCT
		M1-5A	24" X 24"						CTH HH
			36" X 48"						

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MISCELLANEOUS QUANTITIES

SHEET

COUNTY: SAUK

634.0612 POSTS WOOD 4x6-INCH X 12-FT
634.0614 POSTS WOOD 4x6-INCH X 14-FT
634.0616 POSTS WOOD 4x6-INCH X 16-FT
637.2210 SIGNS TYPE II REFLECTIVE H
637.2230 SIGNS TYPE II REFLECTIVE F

HWY: CTH H

PROJECT NO: 5897-00-70

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STATION	LOCATION	CODE	SIZE	TYPE H SF	TYPE F SF	12-FT EACH	14-FT EACH	16-FT EACH	COMMENTS
296+55	LT	W1-2L	30" X 30"		6.25		1		
297+50	LT	R1-1	30" X 30"	5.18		1			
311+45	RT	R1-1	30" X 30"	5.18		1			
325+75	RT	W2-1	30" X 30"		6.25				
332+45	LT	W14-3	36" X 48"		6.00			1	
334+00	RT	W1-4L	30" X 30"		6.25		1		
338+20	LT	R1-1	30" X 30"	5.18			1		
338+80	RT	R1-1	30" X 30"	5.18			1		
348+10	RT	J1-1	24" X 39"	6.50			1		
		M2-1	21" X 15"						JCT
		M1-5A	24" X 24"						CTH P
0.40 50									
348+50	LT	W2-1	30" X 30"		6.25		1		
350+35	RT	W2-2R	30" X 30"		6.25			1	
		W13-1	18" X 18"		2.25				
351+25	RT	D1-2	78" X 30"	16.25			2		WIS DELLS LT, LAKE DELTO
353+40	RT	S3-1	36" X 36"	9.00			1		
356+65	RT	J2-2	48" X 57"	19.00				2	
330+03	ΝI								
		M1-5A	24" X 24"						CTH H
		M6-1	21" X 21"						ARROW STRAIGHT
		M1-5A	24" X 24"						CTH P
		M6-1	21" X 21"						ARROW RIGHT
357+50	LT	W1-7	48" X 24"		8.00		1		
007 100		D1-2	72" X 30"	15.00			2		REEDSBURG LT, WIS DELLS
050 00	DT								REEDSBORG LT, WIS DELLS
358+20	RT	R1-1	30" X 30"	5.18			1		
358+20	RT	J2-2	48" X 57"	19.00			1		
		M1-5A	24" X 24"						CTH H
		M6-4	21" X 21"						DOUBLE ARROW
		M1-5A	24" X 24"						CTH P
		M4-6	24" X 12"						END
050.50									
358+50	LT	J2-2	48" X 57"	19.00			1		
		M1-5A	24" X 24"						CTH H
		M6-1	21" X 21"						ARROW STRAIGHT
		M1-5A	24" X 24"						CTH P
		M6-1	21" X 21"						ARROW LEFT
362+80	RT	M1-5A	24" X 24"	4.00			1		CTH H
	LT	W2-2L							
364+20	LI		30" X 30"		6.25		1		
		W13-1	18" X 18"		2.25				
365+95	LT	S3-1	36" X 36"	9.00			1		
367+00	LT	J1-1	24" X 39"	6.50			1		
		M2-1	21" X 15"						JCT
		M1-5A	24" X 24"						CTH P
200 - 20	DT								
390+20	RT	W1-2L	30" X 30"		6.25		1		
395+80	LT	W1-4L	30" X 30"		6.25		1		
407+00	LT	W14-3	36" X 48"		6.00			1	
408+70	RT	W14-3	36" X 48"		6.00			1	
410+30	LT	W1-2R	30" X 30"		6.25		1		
436+88	RT	R2-1	24" X 30"	5.00	0.25		1		
7JUTU0	IXI						ı		
.== :-		W14-3	36" X 48"		6.00				
458+10	RT	W2-2L	30" X 30"		6.25		1		
		W13-1	18" X 18"		2.25				
462+25	RT	W2-2R	30" X 30"		6.25		1		
-		W13-1	18" X 18"		2.25				
161.25	1.7				2.25				
464+35	LT	R1-1	30" X 30"	5.18			1		
470+20	RT	R1-1	30" X 30"	5.18			1		
470+90	LT	W2-2R	30" X 30"		6.25		1		
		W13-1	18" X 18"		2.25				
472+40	RT	W2-2L	30" X 30"		6.25		1		
	111				2.25				
470 - 50		W13-1	18" X 18"						
476+50	LT	W2-2L	30" X 30"		6.25		1		
		W13-1	18" X 18"		2.25				

634.0612 POSTS WOOD 4x6-INCH X 12-FT 634.0614 POSTS WOOD 4x6-INCH X 14-FT 634.0616 POSTS WOOD 4x6-INCH X 16-FT 637.2210 SIGNS TYPE II REFLECTIVE H 637.2230 SIGNS TYPE II REFLECTIVE F

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PROJECT NO: 5897-00-70 HWY: CTH H COUNTY: SAUK MISCELLANEOUS QUANTITIES SHEET **E**

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	634.0612 POSTS 634.0614 POSTS	WOOD 4x6-INCH	X 14-FT								638.2602 REMO\ 638.3000 REMO\				
	634.0616 POSTS 637.2210 SIGNS	TYPE II REFLECT	IVE H								STATION	LOCATION	SIGNS EACH	SUPPORTS EACH	DESCRIPTION
	637.2230 SIGNS	TYPE II REFLECT	IVEF								52+55	RT	1	1	TWO WAY TRAFFIC
					TYPE H	TYPE F	12-FT	14-FT	16-FT		53+30	LT	1	1	SPEED LIMIT 35 MPH
	STATION	LOCATION	CODE	SIZE	SF	SF	EACH	EACH	EACH	COMMENTS	54+40	LT	1	1	RIGHT LANE MUST TURN RIGHT
	478+60	LT	R1-1	30" X 30"	5.18			1			54+60	RT	2	1	CURVE, 45 MPH
	485+55	LT	W2-2R	30" X 30"	J. 10 	6.25		1			56+55	RT	1	1	STOP
	400100		W13-1	18" X 18"		2.25					57+35	RT	1	1	SPEED LIMIT 45 MPH
_	502+50	RT	W2-1	30" X 30"		6.25		1			57+40	LT	2	1	HOSPITAL, ARROW
3			W13-1	18" X 18"		2.25					59+80	LT	1	2	REEDSBURG POPULATION
	504+00	LT	W14-3	36" X 48"		6.00		1			60+65	LT	1	1	REDUCE SPEED, 35 MPH
			R2-1	24" X 30"	5.00						78+35	RT	1	1	SPEED LIMIT 45 MPH
	509+10	LT	R1-1	30" X 30"	5.18			1			83+65	RT	2	1	CURVE, 45 MPH
	509+20	RT	R1-1	30" X 30"	5.18			1			83+65	LT	2	1	CURVE, 45 MPH
	514+25	RT	W2-2R	30" X 30"		6.25		1			91+30 93+10	RT LT	1	1	INTERSECTION SPEED LIMIT 45 MPH
			W13-1	18" X 18"		2.25					93+60	RT	1	1	ARROW
	515+70	LT	W2-1	30" X 30"		6.25		1			99+55	RT	1	1	STOP
			W13-1	18" X 18"		2.25					104+05	LT	1	1	STOP
	521+45	RT	R1-1	30" X 30"	5.18			1			109+20	LT	1	1	SPEED LIMIT 45 MPH
	F.45 . 50		W13-1	18" X 18"		2.25					111+90	LT	2	1	CURVE, 45 MPH
	545+50	LT	W2-2L	30" X 30"		6.25		1			112+00	RT	2	1	SPEED LIMIT 55 MPH, NO PASSING
	553+40	RT	W13-1 R2-1	18" X 18" 24" X 30"	5.00	2.25			 1		113+65	LT	1	1	STOP
	555+40	KI	W14-3	36" X 48"	5.00	6.00					118+30	LT	2	1	NO PASSING, REDUCE SPEED, 45 MPH
	559+90	LT	W 14-3 R1-1	30" X 30"	5.18	6.00		1			122+05	LT	1	1	STOP
	563+60	LT	W1-7	48" X 24"	J. 10 	8.00		1			137+30	RT	1	1	NO PASSING
	564+00	RT	R1-1	30" X 30"	5.18			1			138+25	LT	1	1	STOP
	568+10	RT	W14-3	36" X 48"		6.00		1			148+70	RT	2	1	CURVES, 45 MPH
	569+85	LT	W1-2L	30" X 30"		6.25		1			156+30	LT	1	1	NO PASSING
	571+30	LT	W2-1	30" X 30"		6.25		1			171+30	LT	1	1	STOP
			W13-1	18" X 18"		2.25					190+40	LT	1	1	STOP
	584+60	RT	W1-4L	30" X 30"		6.25		1			191+20	LT	2	1	CURVES, 45 MPH
			W13-1	18" X 18"		2.25					194+10 194+70	RT LT	3 2	1	CURVE, 45 MPH, NO PASSING NO PASSING, SPEED LIMIT 55 MPH
	588+70	LT	W14-3	36" X 48"		6.00			1		201+90	RT	1	1	INTERSECTION
	611+90	RT	R1-1	30" X 30"	5.18			1			210+90	RT	1	1	STOP
	618+05	RT	R1-1	30" X 30"	5.18			1			221+75	RT	2	1	CURVE, 45 MPH
	623+55	LT	R1-1	30" X 30"	5.18			1			222+50	LT	1	<u> </u>	INTERSECTION
	638+65	RT	W1-4L	30" X 30"		6.25		1			225+75	LT	2	1	CURVE, 45 MPH
	620.75	LT	W13-1 W1-4L	18" X 18" 30" X 30"		2.25 6.25					226+45	RT	1	1	INTERSECTION
	639+75	LI	W13-1	18" X 18"		2.25					233+45	LT	1	1	STOP
	651+25	RT	R1-1	30" X 30"	5.18	2.23		1		 	242+70	RT	1	1	NO PASSING
	689+95	LT	R1-1	30" X 30"	5.18			1			246+05	LT	3	1	NO PASSING, CURVE, 45 MPH
	692+10	LT	R2-1	24" X 30"	5.00			1			256+20	RT	2	1	CURVE, 45 MPH
	694+00	RT	W3-5	36" X 36"		9.00		1			256+95	RT	1	1	STOP
	694+25	LT	W1-4L	30" X 30"		6.25		1			264+65	RT	1	1	JCT CTH HH
			W13-1	18" X 18"		2.25					265+60	LT	1	11	NO PASSING
											266+45	RT	1	1	LYNDON
				TOTAL	417.15	529.00	13	109	10	_	268+85 271+10	RT LT	1	1	NO PASSING STOP, CTH H ARROW, CTH HH END
											271+10	RT	4		CTH HH ARROW
											271+25	RT	1	1	ARROW
											272+30	LT	1	1	CTH HH ARROW
											286+25	LT	1	1	JCT CTH HH
											291+75	RT	1	1	NO PASSING
											296+55	LT	2	1	CURVE, 45 MPH
											297+50	LT	1	1	STOP
											311+45	RT	1	1	STOP
											325+75	RT	1	1	INTERSECTION
											332+45	LT	1	1	NO PASSING
											334+00	RT	1	1	CURVES
											338+20	LT	11	11	STOP
											338+80	RT	1	1	STOP
											348+10	RT	1	1	JCT CTH P
											348+50	LT	1	1	INTERSECTION
											350+35	RT	1	1	INTERSECTION
											351+25	RT	1		LAKE DELTON, WIS. DELLS
											•		THAITIME I	TO TVENT DA	\(/ = L_

COUNTY: SAUK

HWY: CTH H

PROJECT NO: 5897-00-70

638.2602 REMOVING SIGNS TYPE II

CONTINUED ON NEXT PAGE

SHEET

MISCELLANEOUS QUANTITIES

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646.0126 PAVEMENT MARKING EPOXY 8-INCH 638.3000 REMOVING SMALL SIGN SUPPORTS 646.0406 PAVEMENT MARKING SAME DAY EPOXY 4-INCH 647,0566 PAVEMENT MARKING STOP LINE EPOXY 18-INCH **SUPPORTS** SIGNS 649.0200 TEMPORARY PAVEMENT MARKING REFLECTIVE PAINT STATION LOCATION **EACH** EACH DESCRIPTION **EPOXY** SCHOOL BUS STOP AHEAD 353+40 RT FPOXY **EPOXY** SAME DAY EPOXY STOP LINE *TEMPORARY MARKING 356+65 RT CTH H ARROW, CTH P ARROW 4-INCH WHITE 8-INCH 4-INCH YELLOW 18-INCH 4-INCH YELLOW 357+50 LT ARROW, REEDSBURG, WIS. DELLS SOLID SKIPS SOLID WHITE SOLID SKIPS WHITE SKIPS 358+20 RT STOP STATION - STATION LOCATION LF LF LF LF LF DESCRIPTION ΙF ΙF ΙF 358+20 RT JCT CTH H, CTH P END 53+25 - 103+55 5030 EDGELINE LT CTH H ARROW, CTH P ARROW 358+50 52+48 - 55+45 RT 297 **EDGELINE** RT 362+80 CTH H 55+45 - 55+95 RT 12 EDGELINE 3' SKIPS LT 364+20 INTERSECTION, 45 MPH 56+65 - 98+15 RT 4150 **EDGELINE** 365+95 LT SCHOOL BUS STOP AHEAD RT EDGELINE 3' SKIPS 98+15 - 99+70 39 367+00 LT JCT CTH P 52+48 - 100+00 CENTERLINE 9504 19008 NO PASSING RT 390+20 CURVE CENTERI INF 300 600 **FASTBOUND PASSING** 100+00 - 112+00 1200 2400 395+80 LT CURVES 103+55 - 104+55 LT 24 EDGELINE 3' SKIPS 407+00 LT NO PASSING 104+55 - 113+45 LT 890 **EDGELINE** RT NO PASSING 408+70 EDGELINE 3' SKIPS 113+45 - 114+20 ΙT 18 410+30 LT CURVE, 45 MPH 99+70 - 210+05 RT 11,035 EDGELINE 436+88 RT SPEED LIMIT 55 MPH, NO PASSING 210+05 - 211+30 RT 33 **EDGELINE 3' SKIPS** RT INTERSECTION 458+10 CENTERLINE 150 300 PASSING BOTH WAY 112+00 - 118+00 462+25 RT INTERSECTION, 45 MPH 114+20 - 121+65 LT 745 **EDGELINE** LT 464+35 STOP EDGELINE 3' SKIPS 121+65 - 123+15 ΙT 36 470+20 RT STOP 118+00 - 126+00 CENTERLINE 200 1600 400 WESTBOUND PASSING 800 470+90 LT INTERSECTION, 45 MPH 126+00 - 129+50 CENTERLINE 176 PASSING BOTH WAY 88 RT INTERSECTION, 45 MPH 472+40 CENTERLINE 1540 374 EASTBOUND PASSING 129+50 - 137+20 770 187 LT INTERSECTION, 45 MPH 476+50 2 1490 123+15 - 138+05 ΙT **EDGELINE** 478+60 LT STOP 138+50 - 138+75 1 T 18 EDGELINE 3' SKIPS 485+55 LT INTERSECTION, 45 MPH CENTERLINE PASSING BOTH WAY 137+20 - 156+30 475 950 ---RT INTERSECTION, 45 MPH 502+50 156+30 - 163+20 CENTERLINE 1380 350 WESTBOUND PASSING 690 175 504+00 LT NO PASSING. SPEED LIMIT 55 MPH 138+75 - 170+95 3220 ΙT EDGELINE 509+10 LT STOP 170+95 - 171+85 ΙT 30 **EDGELINE 3' SKIPS** ---509+20 RT STOP 163+20 - 182+30 CENTERLINE 3820 7640 NO PASSING INTERSECTION, 45 MPH RT 514+25 171+85 - 190+00 1815 EDGELINE ΙT LT INTERSECTION, 45 MPH 515+70 27 190+00 - 191+10 **EDGELINE 3' SKIPS** RT 521+45 STOP CENTERLINE 182+30 - 194+10 1180 300 2360 600 EASTBOUND PASSING 528+00 LT CAUTION BLIND DRIVEWAY, 45 MPH 2 194+10 - 194+65 CENTERLINE 13 26 PASSING BOTH WAY 545+50 LT INTERSECTION, 45 MPH 191+10 - 233+00 4190 **EDGELINE** 553+40 RT SPEED LIMIT 55 MPH. NO PASSING 233+00 - 234+50 ΙT **EDGELINE 3' SKIPS** 559+90 LT STOF 194+65 - 206+80 CENTERLINE 1215 300 2430 600 WESTBOUND PASSING 563+60 LT ARROW 206+80 - 233+75 CENTERLINE 5390 10780 NO PASSING 564+00 RT STOP 211+30 - 256+25 RT 4495 **EDGELINE** 568+10 RT NO PASSING 256+25 - 257+30 RT 27 EDGELINE 3' SKIPS 569+85 ΙT CURVE 234+50 - 270+35 ΙT 3585 EDGELINE 571+30 LT INTERSECTION, 45 MPH 270+35 - 272+45 LT 51 **EDGELINE 3' SKIPS** CURVES, 45 MPH 584+60 RT 233+75 - 242+70 CENTERLINE 895 225 1790 450 EASTBOUND PASSING LT NO PASSING 588+70 PASSING BOTH WAY 242+70 - 246+05 CENTERI INF 176 88 611+90 RT STOP 246+05 - 256+20 CENTERLINE 1015 250 2030 500 WESTBOUND PASSING RT 618+05 STOP 256+20 - 265+45 CENTERLINE 825 200 1650 400 EASTBOUND PASSING LT STOF 623+55 257+30 - 310+50 RT 5320 EDGELINE 638+65 RT CURVES, 45 MPH 310+50 - 311+95 **EDGELINE 3' SKIPS** 639+75 LT CURVES, 45 MPH 265+45 - 269+10 CENTERLINE 730 1460 NO PASSING 651+25 RT STOP 269+10 - 271+05 CENTERLINE 50 390 100 WESTBOUND PASSING 195 689+95 LT STOP 269+55 - 271+45 50 EDGELINE 12.5' SKIPS SPEED LIMIT 55 MPH LT 692+10 CENTERLINE 200 PASSING BOTH WAY 271+05 - 275+30 100 694+00 RT REDUCE SPEED, 35 MPH 275+30 - 291+85 CENTERLINE 1655 413 3310 826 EASTBOUND PASSING 694+25 LT 2 CURVES, 45 MPH 272+45 - 297+10 ΙT 2465 **EDGELINE** EDGELINE 3' SKIPS 297+10 - 298+05 LT 24 TOTAL 157 120 298+05 - 337+80 3975 EDGELINE LT **EDGELINE 3' SKIPS** 337+80 - 339+05 1 T 30 291+85 - 332+25 CENTERLINE 1000 2000 PASSING BOTH WAY 332+25 - 345+35 CENTERLINE 1310 325 2620 650 WESTBOUND PASSING 2575 311+95 - 337+70 RT **EDGELINE** 337+70 - 339+25 RT 39 EDGELINE 3' SKIPS 339+25 - 357+05 RT 1780 **EDGELINE** LT **EDGELINE** 339+05 - 464+00 12495 464+00 - 465+25 30 **EDGELINE 3' SKIPS** LT CENTERLINE 21080 345+35 - 398+05 10540 NO PASSING CONTINUED ON NEXT PAGE HWY: CTH H COUNTY: SAUK MISCELLANEOUS QUANTITIES SHEET PROJECT NO: 5897-00-70

646.0106 PAVEMENT MARKING EPOXY 4-INCH

638.2602 REMOVING SIGNS TYPE II

646.0106 PAVEMENT MARKING EPOXY 4-INCH

646.0126 PAVEMENT MARKING EPOXY 8-INCH

646.0406 PAVEMENT MARKING SAME DAY EPOXY 4-INCH

647.0566 PAVEMENT MARKING STOP LINE EPOXY 18-INCH

649.0200 TEMPORARY PAVEMENT MARKING REFLECTIVE PAINT

		EPOXY 4-INCH WHITE		EPOXY	SAME DAY EPOXY		EPOXY STOP LINE	*TEMPORARY MARKING		
				8-INCH		YELLOW	18-INCH	4-INCH		
		SOLID	SKIPS	WHITE	SOLID	SKIPS	WHITE	SOLID	SKIPS	
STATION - STATION	LOCATION	LF	LF	LF	LF	LF	LF	LF	LF	DESCRIPTION
356+00 - 357+50	RT			150						TURN LANE
357+75	CTH P				30		20	60		TOTAL
358+40 - 469+30	RT	11090								EDGELINE
469+30 - 470+60	RT		33							EDGELINE 3' SK
398+05 - 407+00	CENTERLINE				895	225		1790	450	EASTBOUND PAS
407+00 - 408+60	CENTERLINE				320			640	450	NO PASSING
408+60 - 417+85	CENTERLINE				925	225		1850	450	WESTBOUND PA
417+85 - 424+05	CENTERLINE				1240			2480	450	NO PASSIN
424+05 - 436+30	CENTERLINE				1225	300		2450	600	EASTBOUND PAS
436+30 - 503+90	CENTERLINE					1688			3376	PASSING BOTH
470+00	WINNESHIEK DRIVE						18			
470+60 - 508+20	RT	3760								EDGELINE
508+20 - 510+10	RT		48							EDGELINE 3' SI
465+25 - 478+25	LT	1300								EDGELINE
478+25 - 479+70	LT		36							EDGELINE 3' SI
479+70 - 508+45	LT	2875								EDGELINE
508+45 - 510+45	LT		51							EDGELINE 3' SI
503+90 - 521+05	CENTERLINE				3430			6860		NO PASSIN
509+00	COONBLUFF RD, RT				40			80		
510+10 - 520+35	RT	1025								EDGELINE
520+35 - 521+80	RT		36							EDGELINE 3' S
510+45 - 559+50	LT	4905								EDGELINE
559+50 - 561+10	LT		39							EDGELINE 3' S
516+60 - 519+40	LT		75							EDGELINE 12.5'
521+05 - 536+60	CENTERLINE				1555	388		3110	776	EASTBOUND PA
521+80 - 562+75	RT	4095								EDGELINE
562+75 - 564+50	RT		42							EDGELINE 3' SI
536+60 - 545+45	CENTERLINE					225			450	PASSING BOTH
545+45 - 556+40	CENTERLINE				1095	275		2190	550	WESTBOUND PA
	CENTERLINE									
556+40 - 556+80					80			160		NO PASSIN
556+80 - 568+15	CENTERLINE				1135	275		2270	550	EASTBOUND PA
568+15 - 588+60	CENTERLINE					513			1026	PASSING BOTH
563+75	LYNDON RD, RT				40			80		
561+10 - 623+15	LT	6205								EDGELINE
623+15 - 624+40	LT		30							EDGELINE 3' SI
564+50 - 610+85	RT	4635								EDGELINE
610+85 - 612+25	RT		36							EDGELINE 3' S
588+60 - 599+65	CENTERLINE				1105	275		2210	550	WESTBOUND PA
599+65 - 698+70	CENTERLINE				19810			39620		NO PASSIN
612+25 - 617+30	RT	505								EDGELINE
617+30 - 618+55	RT		30							EDGELINE 3' S
618+55 - 650+30	RT	3175								EDGELINE
650+30 - 651+55	RT		30							EDGELINE 3' S
624+40 - 689+65	LT	6525								EDGELINE
689+65 - 691+15	LT		36							EDGELINE 3' SI
691+15 - 698+70	LT	755								EDGELINE
651+55 - 698+70	RT	4715								EDGELINE
	SUBTOTAL	125,117	1,082	150	74,659	9,228	38	149,318	18,456	

^{*} INCLUDES TWO APPLICATIONS: ONE ON THE SAME DAY AS PAVING THE CIR LAYER, AND ONE ON SAME DAY AS PAVING THE LOWER HMA LAYER.

648 0100	LOCATING NO-PASSING	70NFS

STATION - STATION	MI
52+48.54 - 698+68.81	12.24
TOTAL	12.24

650.8000 CONSTRUCTION STAKING RESURFACING REFERENCE

STATION - STATION	LF
58+61.53 - 399+17.83	34,056
399+54.00 - 693+00.00	29,346
TOTAL	63,402

690.0150 SAWING ASPHALT

STATION	LOCATION	LF
53+80	RT	37
20TH ST	RT	38
73+15	RT	16
73+40	LT	37
77+85	RT	16
87+00	LT	30
GOLF COURSE RD	RT	30
WILLOW CREEK RD	LT	18
110+30	LT	19
CHADWICK RD	LT	20
NORTH DEWEY AVE	LT	25
122+35	RT	65
125+35	LT	29
131+00	LT	47
KEENAN CT	LT	27
146+15	LT	45
148+30	LT	43
158+00	LT	42
GLEN VALLEY DR	LT	14
DROVER PASS	LT	21
SOUTH AVE	RT	20
D&W RD	LT	24
237+65	LT	28
ACORN LN	RT	21
CTH HH	LT	44
281+15	LT	46
290+60	LT	27
CHERY LN	LT	18
308+10	LT	37
BLUEBIRD LN	RT	15
316+95	RT	19
320+85	LT	22
334+15	LT	29
TOWN HALL RD	RT & LT	47
366+95	RT	42
370+60	RT	49
371+95	LT	50
379+70	RT	32
397+50	LT	24
416+00	LT	22
431+35	RT	25
431+45	LT	27
435+90	LT	34
437+10	LT	40
438+40	RT	22
442+45	RT	21
446+50	RT	22
451+65	LT	24
452+70	LT	17
455+40	LT	27
459+05	LT	19
461+15	RT	28
463+00	RT I T	22 21
OAK HILL RD	LT pt	21
WINNESHIEK DR	RT LT	27
473+80	LT LT	23
476+15		21
NORTH AVE	LT	27
487+70	LT	21
495+30	LT	19

CONTINUED IN NEXT COLUMN

690.0150 SAWING ASPHALT

STATION	LOCATION	LF
COONBLUFF RD	RT & LT	60
517+65	RT	74
CHRISTMAS MOUNTIAN RD	RT	26
535+85	LT	28
548+50	LT	27
552+90	LT	25
LYNDON RD	RT & LT	55
BIRCHWOOD RD SPUR	RT	23
BIRCHWOOD RD	RT & LT	44
638+80	LT	43
TESSERS RD	RT	23
674+05	RT	27
678+60	LT	27
OLD US 12	LT	32
	TOTAL	2236

PROJECT NO: 5897-00-70 HWY: CTH H COUNTY: SAUK MISCELLANEOUS QUANTITIES SHEET **E**

Standard Detail Drawing List

08E09-06	SILT FENCE
14B15-08A	STEEL PLATE BEAM GUARD, CLASS "A" INSTALLATION & ELEMENTS
14B15-08B	STEEL PLATE BEAM GUARD, CLASS "A" INSTALLATION & ELEMENTS
14B24-08A	STEEL PLATE BEAM GUARD ENERGY ABSORBING TERMINAL
14B24-08B	STEEL PLATE BEAM GUARD ENERGY ABSORBING TERMINAL
14B24-08C	STEEL PLATE BEAM GUARD ENERGY ABSORBING TERMINAL
14B42-03A	MIDWEST GUARDRAIL SYSTEM (MGS) GUARDRAIL
14B42-03B	MIDWEST GUARDRAIL SYSTEM (MGS) GUARDRAIL
14B42-03C	MIDWEST GUARDRAIL SYSTEM (MGS) GUARDRAIL
14B44-02A	MIDWEST GUARDRAIL SYSTEM ENERGY ABSORBING TERMINAL (MGS)
14B44-02B	MIDWEST GUARDRAIL SYSTEM ENERGY ABSORBING TERMINAL (MGS)
14B44-02C	MIDWEST GUARDRAIL SYSTEM ENERGY ABSORBING TERMINAL (MGS)
15C05-02	TRAFFIC CONTROL, ADVANCE WARNING SIGNS 40 M.P.H. OR LESS
15C08-16A	PAVEMENT MARKING (MAINLINE)
15C08-16B	PAVEMENT MARKING (INTERSECTIONS)
15C12-04	TRAFFIC CONTROL FOR LANE CLOSURE (SUITABLE FOR MOVING OPERATIONS)
15C33-01	STOP LINE AND CROSSWALK PAVEMENT MARKING

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TYPICAL APPLICATION OF SILT FENCE

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PLAN VIEW SILT FENCE AT MEDIAN SURFACE DRAINS



GENERAL NOTES

DETAILS OF CONSTRUCTION NOT SHOWN ON THIS DRAWING SHALL CONFORM TO THE PERTINENT REQUIREMENTS OF THE STANDARD SPECIFICATIONS AND APPLICABLE SPECIAL PROVISIONS.

- \bigcirc HORIZONTAL BRACE REQUIRED WITH 2" X 4" WOODEN FRAME OR EQUIVALENT AT TOP OF POSTS.
- ② FOR MANUAL INSTALLATIONS THE TRENCH SHALL BE A MINIMUM OF 4" WIDE & 6" DEEP TO BURY AND ANCHOR THE GEOTEXTILE FABRIC. FOLD MATERIAL TO FIT TRENCH AND BACKFILL & COMPACT TRENCH WITH EXCAVATED SOIL.
- 3 WOOD POSTS SHALL BE A MINIMUM SIZE OF 11/8" X 11/8" OF OAK OR HICKORY.
- 4) SILT FENCE TO EXTEND ACROSS THE TOP OF THE PIPE.
- (5) CONSTRUCT SILT FENCE FROM A CONTINUOUS ROLL IF POSSIBLE BY CUTTING LENGTHS TO AVOID JOINTS. IF A JOINT IS NECESSARY USE ONE OF THE FOLLOWING TWO METHODS; A) OVERLAP THE END POSTS AND TWIST, OR ROTATE, AT LEAST 180 DEGREES, B) HOOK THE END OF EACH SILT FENCE LENGTH.



TRENCH DETAIL



SILT FENCE TIE BACK
(WHEN REQUIRED BY THE ENGINEER)

STATE OF WISCONSIN
DEPARTMENT OF TRANSPORTATION


APPROVED
4-29-05 /S/ Beth Cannestra

29-05 /S/ Beth Cannestra
DATE CHIEF ROADWAY DEVELOPMENT ENGINEER

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FRONT VIEW

POST SPACING STANDARD INSTALLATION


SECTION THRU W

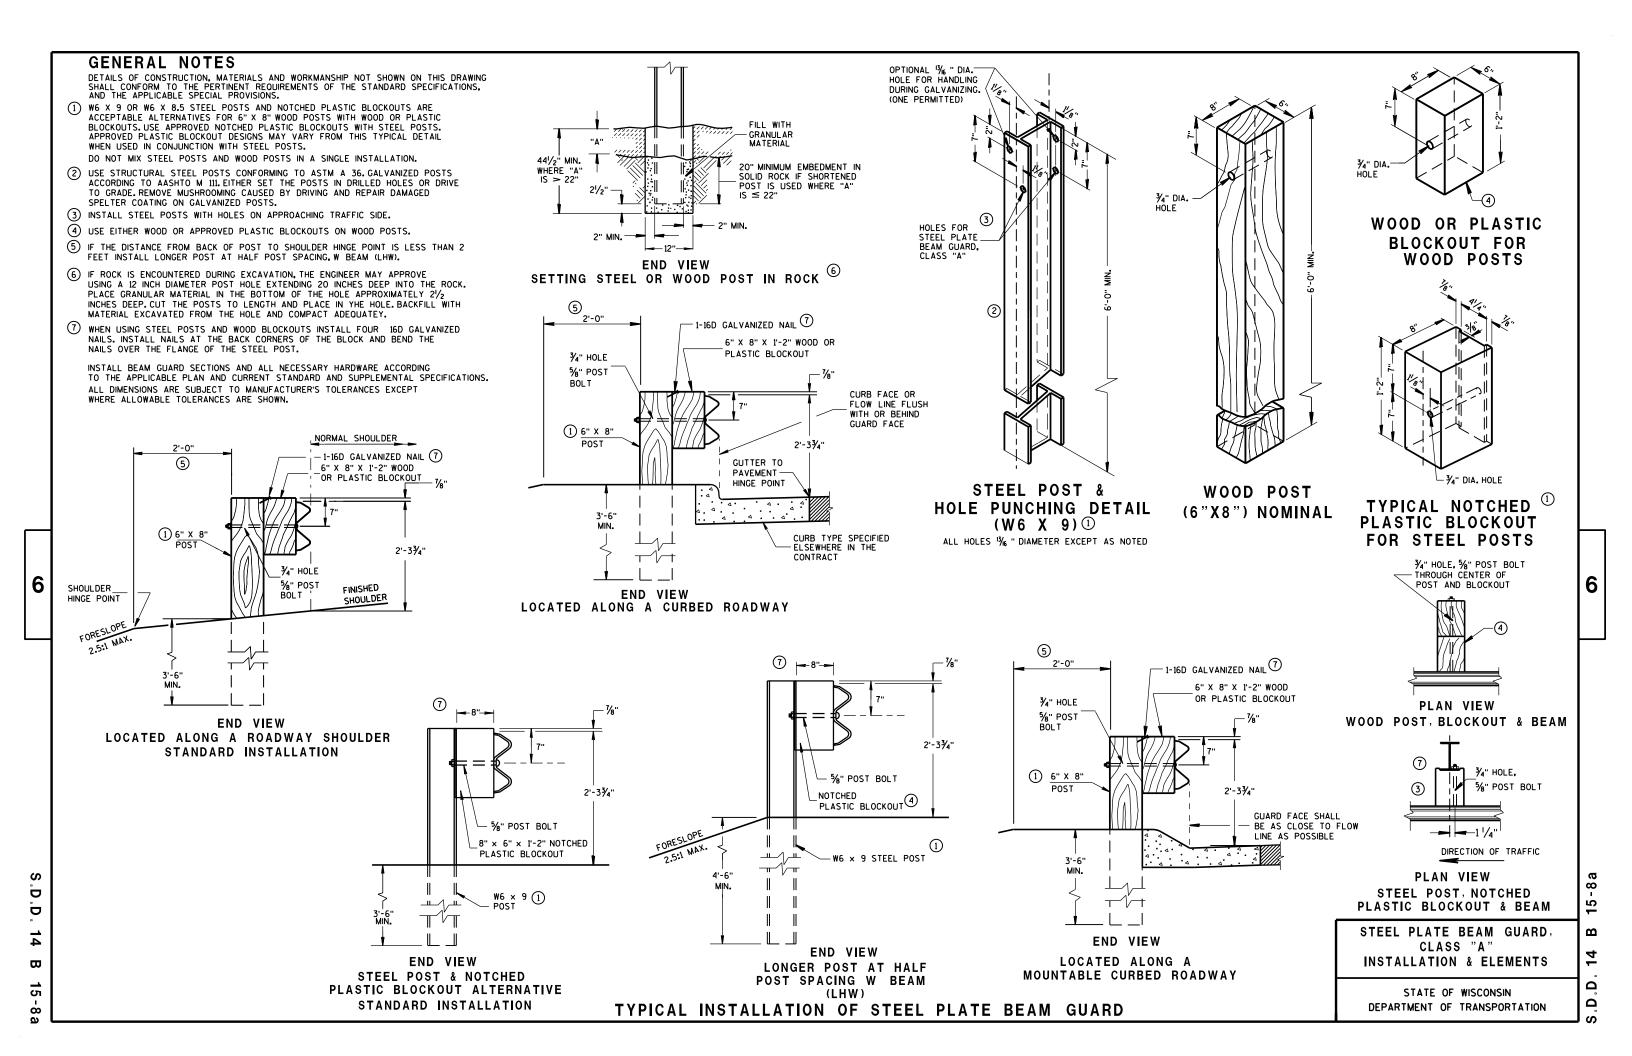SYMMETRICAL

∕-12 GAGE

BEAM

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BEAM SPLICE AT WOOD POST AND POST MOUNTING DETAIL

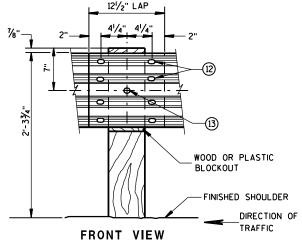
GENERAL NOTES

- (8) PROVIDE SILVER REFLECTIVE SHEETING ON ALL REFLECTORS EXCEPT THOSE LOCATED ALONG THE LEFT EDGE OF ONE-WAY ROADWAYS, WHICH SHALL BE PROVIDED WITH YELLOW REFLECTIVE SHEETING. SHEETING IS TYPE H. SEE STANDARD SPECIFICATION 637.
- (9) DO NOT INSTALL REFLECTORS ON THE FIRST 50 FEET OF THE APPROACH END OF THE ENERGY ABSORBING TERMINAL.
- (10) REVERSE EVERY OTHER REFLECTOR FOR 2-WAY VISIBILITY. THE CONTRACTOR MAY FURNISH TWO-SIDED REFLECTORS IN LIEU OF ONE-SIDED REFLECTORS.
- (11) PROVIDE AN ANGLE OF BEND OF 90° ± 1° FOR TWO-SIDED REFLECTORS.
- (12) 8 5%" * X 2" BUTTON HEAD BOLTS WITH OVAL SHOULDERS & RECESS NUTS.
- (3) %" DIA. BUTTON HEAD BOLT AND RECESS NUT WITH %" DIA. F844 FLAT WASHER UNDER NUT.

12'-6" OR 25'-0" EFFECTIVE LENGTH OF BEAM 3'-1\/2" C-C 3'-1\/2" C-C 3'-1\/2" C-C 3'-1\/2" C-C POST POST POST POST SPACING SPACING SPACING SPACING FINISHED DIRECTION OF TRAFFIC


FRONT VIEW

POST SPACING FOR LONGER POST AT HALF POST SPACING W BEAM (LHW)

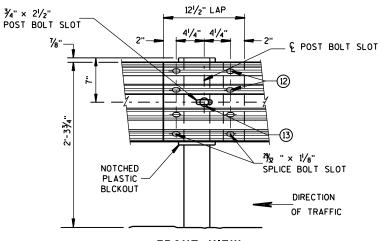

FRONT VIEW
BEAM SPLICE AT STEEL POST

TYPICAL SPLICING DETAILS OF STEEL PLATE BEAM GUARD

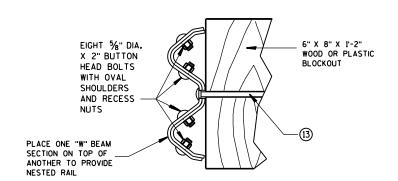



NESTED W BEAM (NW)

USE ALL OTHER STANDARD BEAM GUARD DETAILS FOR CONSTRUCTING NESTED W BEAM (NW)

	9
REFLECTOR	SPACING

	BEAM GUARD	REFLECTOR	NO. SURFACES	MIN. NO.
	LENGTH	SPACING	REFLECTORIZED	REFLECTORS
ONE WAY TRAFFIC	< 500,	50' C-C 100' C-C	1 1	3
TWO WAY TRAFFIC	> 500. < 500.	25' C-C 50' C-C	1 100	6
TWO WAY TRAFFIC	> 500, < 500,	50' C-C 100' C-C	2 11	3

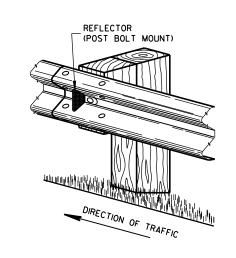

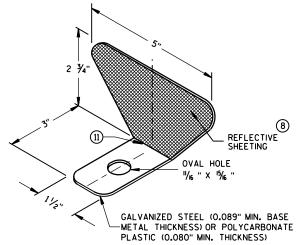

ONE SIDED REFLECTOR DETAIL AND TYPICAL INSTALLATION $^{\circ}$

STEEL PLATE BEAM GUARD, CLASS "A", INSTALLATION & ELEMENTS


STATE OF WISCONSIN
DEPARTMENT OF TRANSPORTATION


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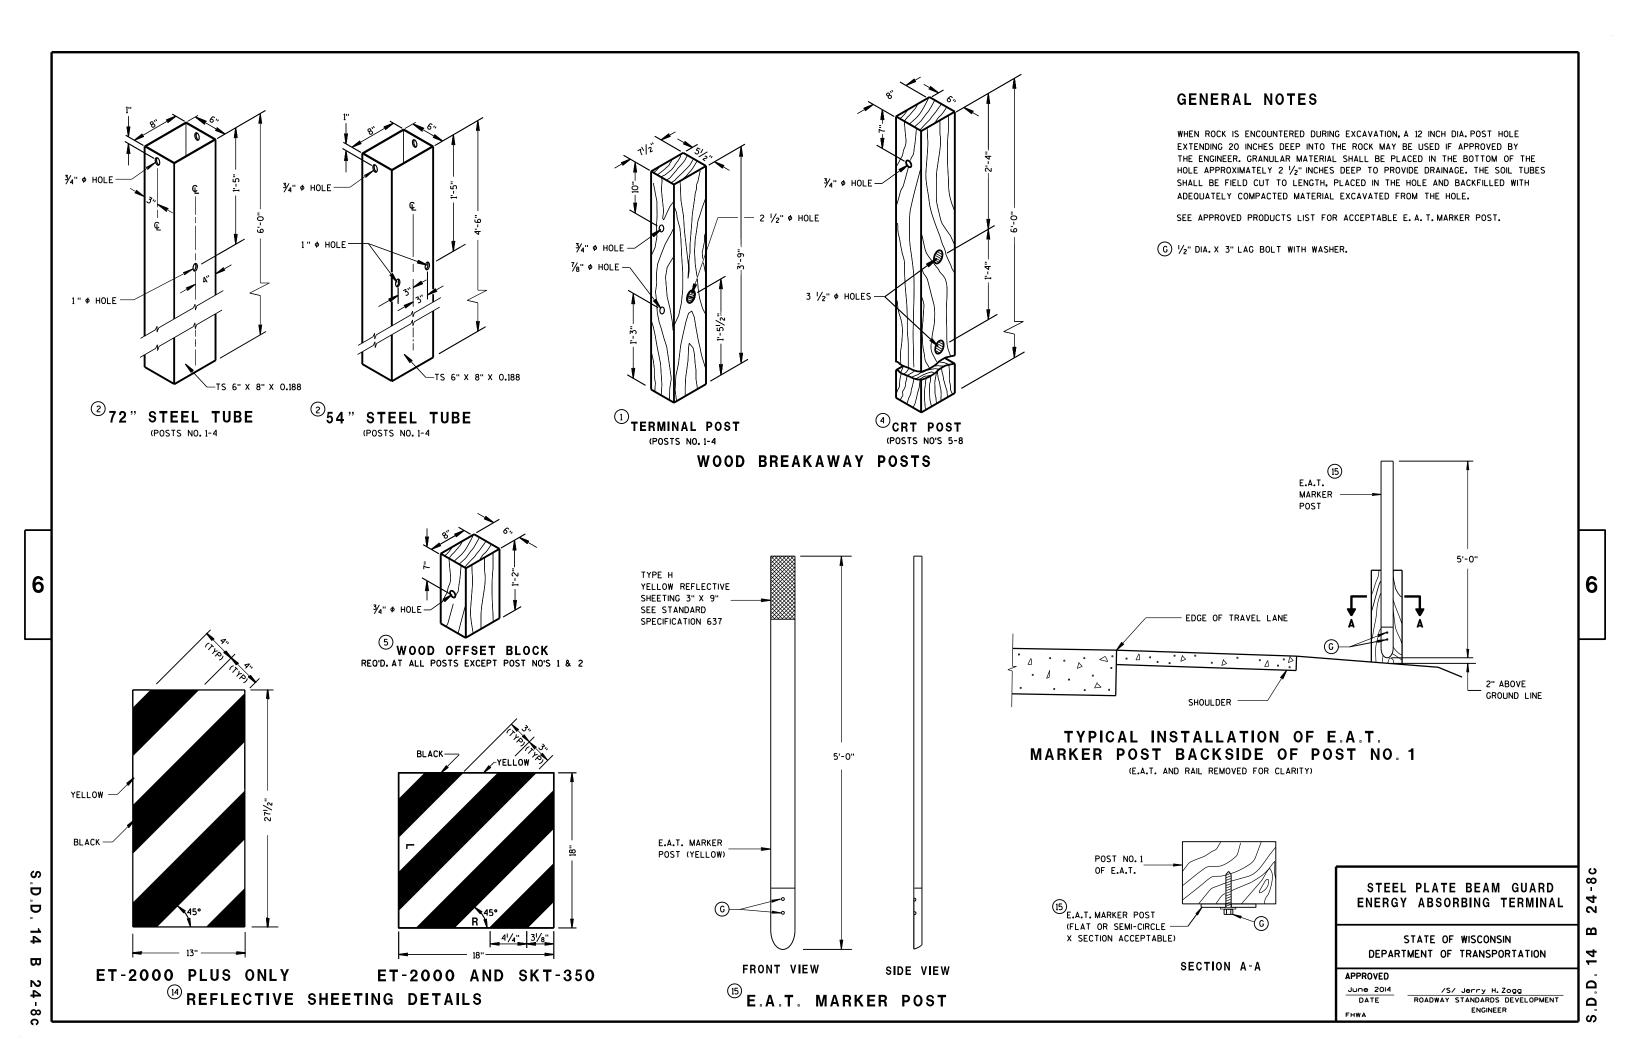




24-8b


STEEL PLATE BEAM GUARD **ENERGY ABSORBING TERMINAL**

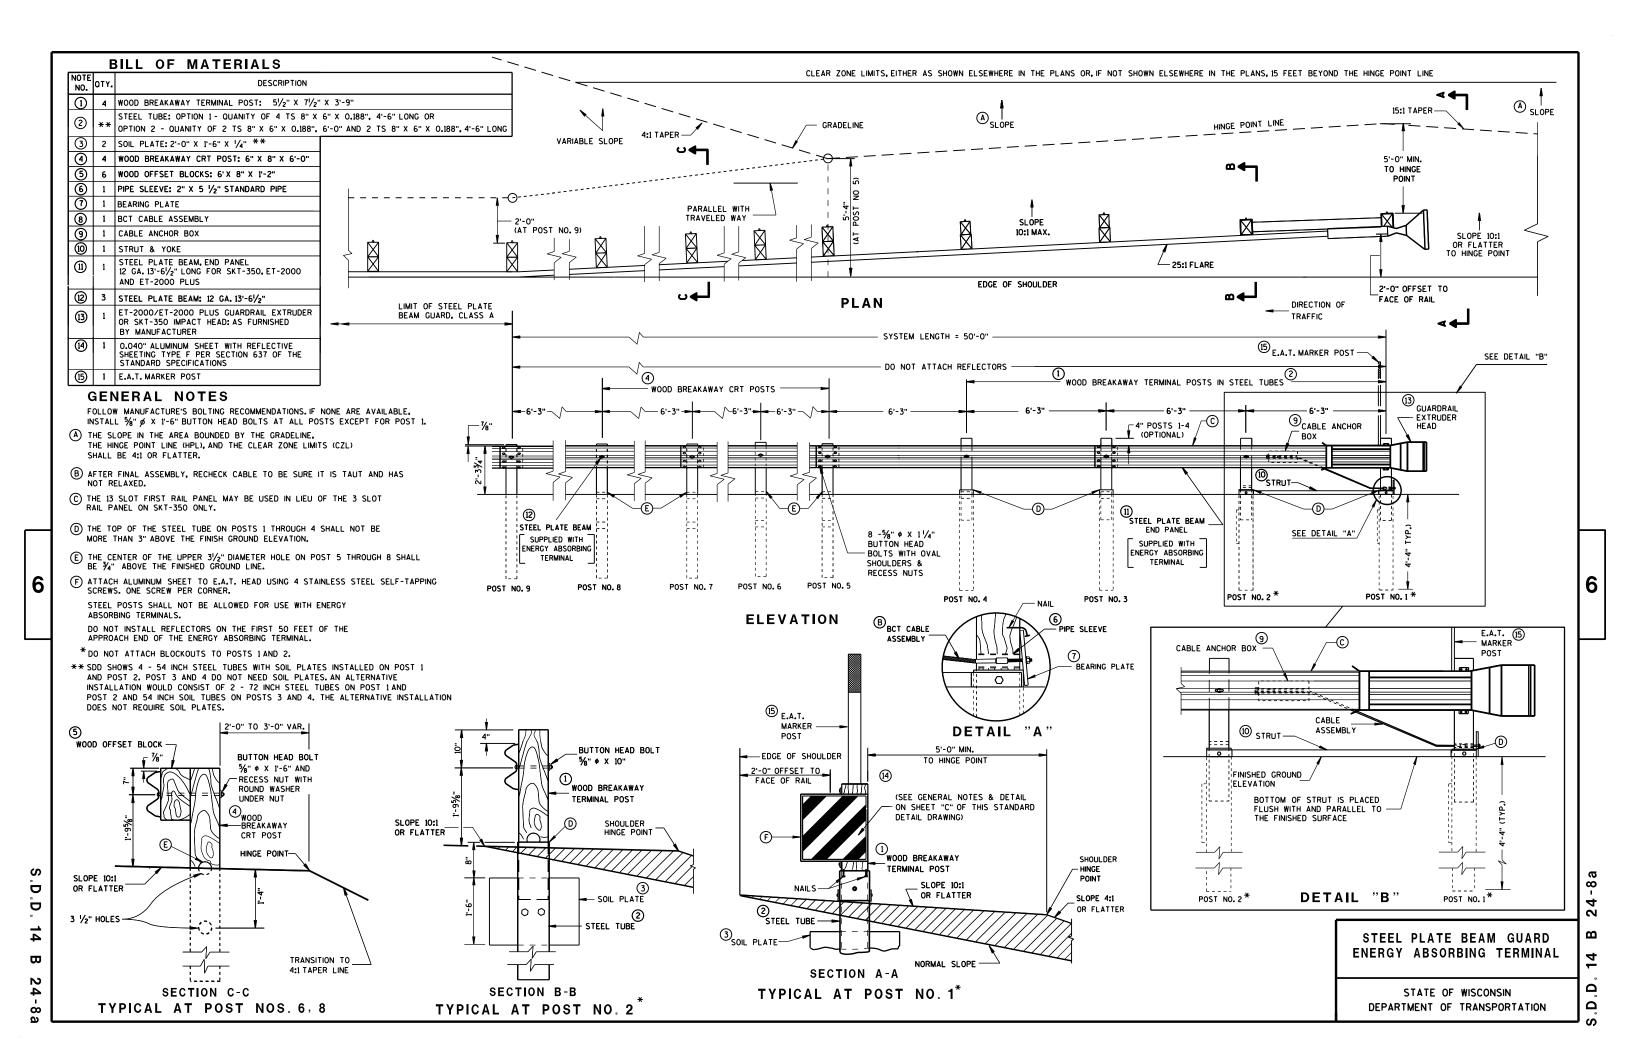STATE OF WISCONSIN DEPARTMENT OF TRANSPORTATION 14 أ يُ

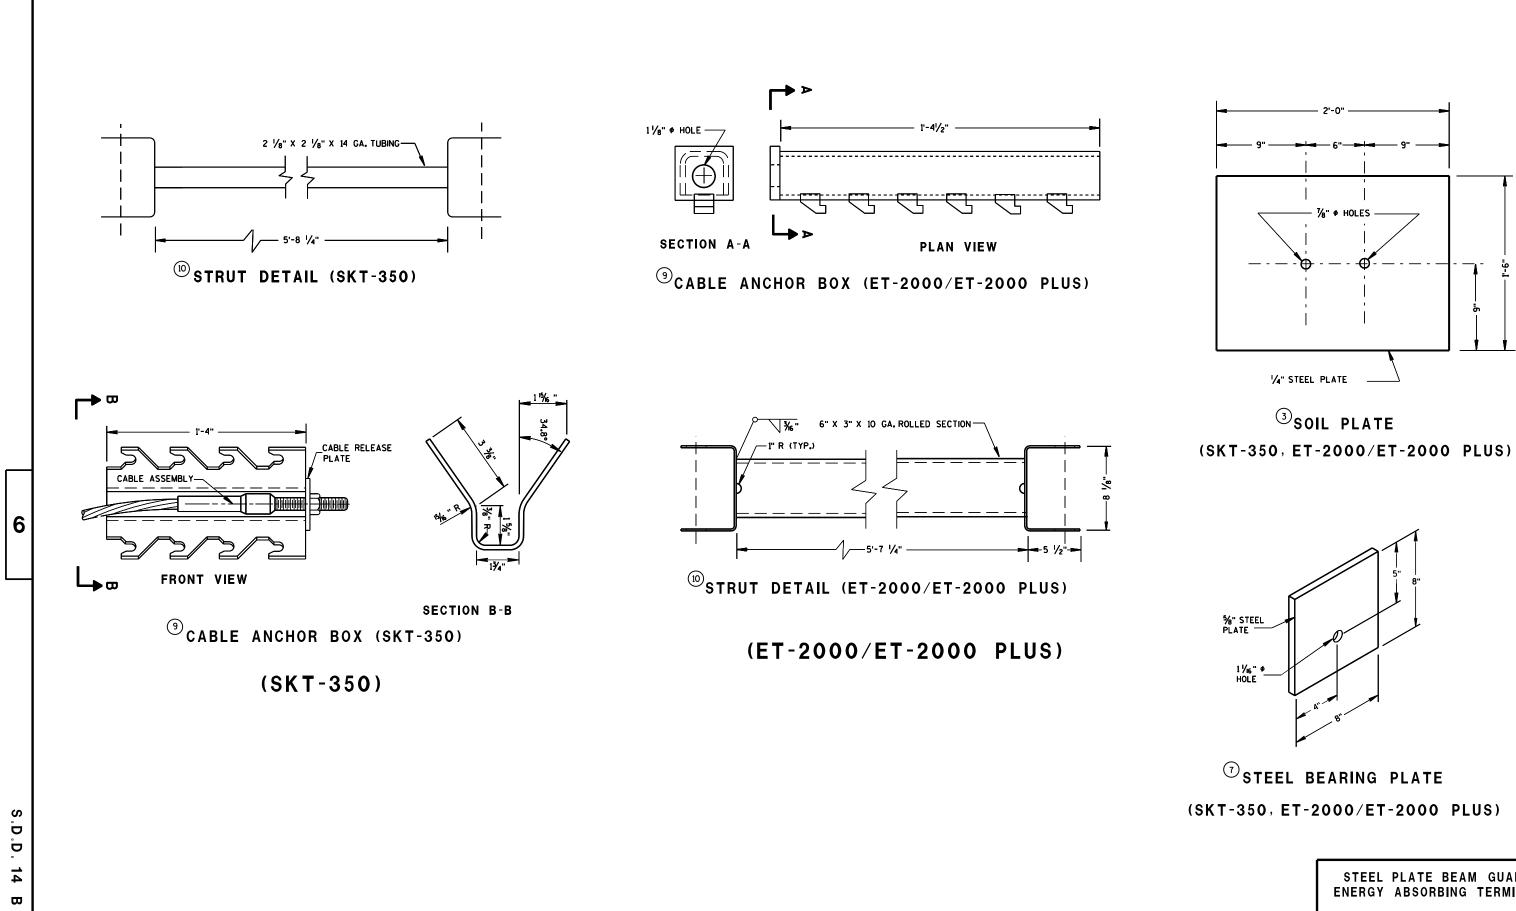


GENERAL NOTES

- (1) WOOD OR STEEL POSTS (W6X9 OR W6X8.5) MAY BE USED. DO NOT INTERMIX WOOD AND STEEL POSTS. INSTALL STEEL POSTS WITH HOLES ON APPROACHING TRAFFIC SIDE.
- 2 USE WOOD OR APPROVED PLASTIC BLOCKOUTS. WOOD BLOCKOUTS MAY BE CONSTRUCTED OUT OF TWO OR MORE WOOD BLOCKOUTS. SEE ALTERNATE WOOD BLOCKOUT DETAIL. DIMENSIONS OF APPROVED PLASTIC BLOCKOUTS MAY VARY.
- (3) IF ROCK IS ENCOUNTERED DURING EXCAVATION, PROVIDE A HOLE 12 INCHES IN DIAMETER EXTENDING 20 INCHES DEEP INTO THE ROCK. PLACE APPROXIMATELY 21/2 INCHES OF GRANULAR MATERIAL IN THE BOTTOM OF THE HOLE. CUT THE POSTS THE TO LENGTH AMD INSTALL. BACKFILL WITH EXCAVATED MATERIAL AND COMPACT. BACKFILL IS TO BE FREE OF LARGE ROCKS.
- (4) WHEN THE DISTANCE FROM BACK OF POST TO SHOULDER HINGE POINT IS LESS THAN 2 FEET INSTALL LONGER POST AT HALF POST SPACING (K).
- (5) FOR NEW MGS INSTALLATION TOP OF W-BEAM RAIL TOLERANCE IS ± 1". FOR EXISTING MGS INSTALLATION TOP OF W-BEAM IS BETWEEN 273/4" TO 32".
- (6) WHEN USING STEEL POST AND WOOD BLOCKOUTS INSTALL FOUR 16D GALVANIZED NAILS. INSTALL NAILS AT THE BACK CORNERS OF THE BLOCK AND BEND THE NAILS OVER THE FLANGE OF THE STEEL POST.

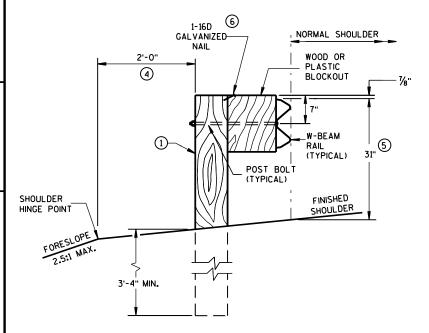

END VIEW


LOCATED ALONG A ROADWAY SHOULDER STANDARD INSTALLATION

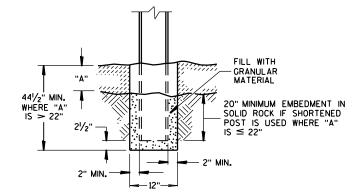


SETTING STEEL OR WOOD POST IN ROCK $^{\scriptsize{\textcircled{3}}}$




END VIEW
LOCATED ALONG A CURBED ROADWAY

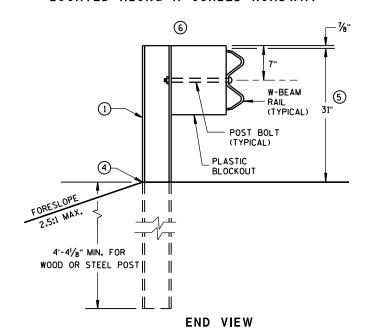


MGS LONGER POST AT HALFPOST SPACING W BEAM (K)

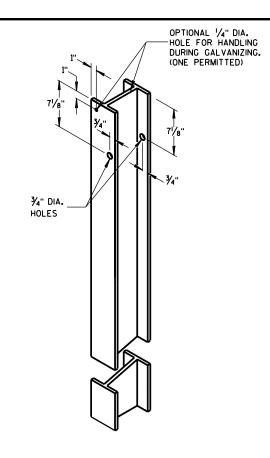


STEEL POST & HOLE PUNCHING DETAIL (w6X9)

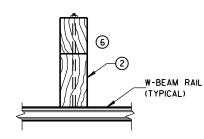


PLAN VIEW
WOOD POST,
BLOCKOUT & BEAM

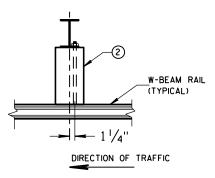

PLAN VIEW
STEEL POST,
PLASTIC BLOCKOUT & BEAM

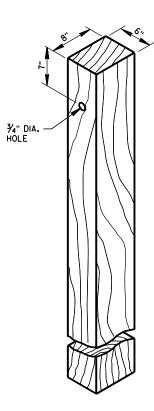

WOOD POST (6" X 8") NOMINAL $^{\scriptsize \textcircled{1}}$

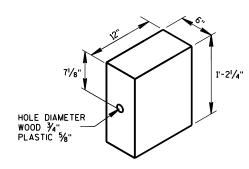

WOOD OR PLASTIC BLOCKOUT

MIDWEST GUARDRAIL SYSTEM (MGS) GUARDRAIL

STATE OF WISCONSIN
DEPARTMENT OF TRANSPORTATION

S.D.D. 14 B 4


6


.D.D. 14 B

3a

2

6

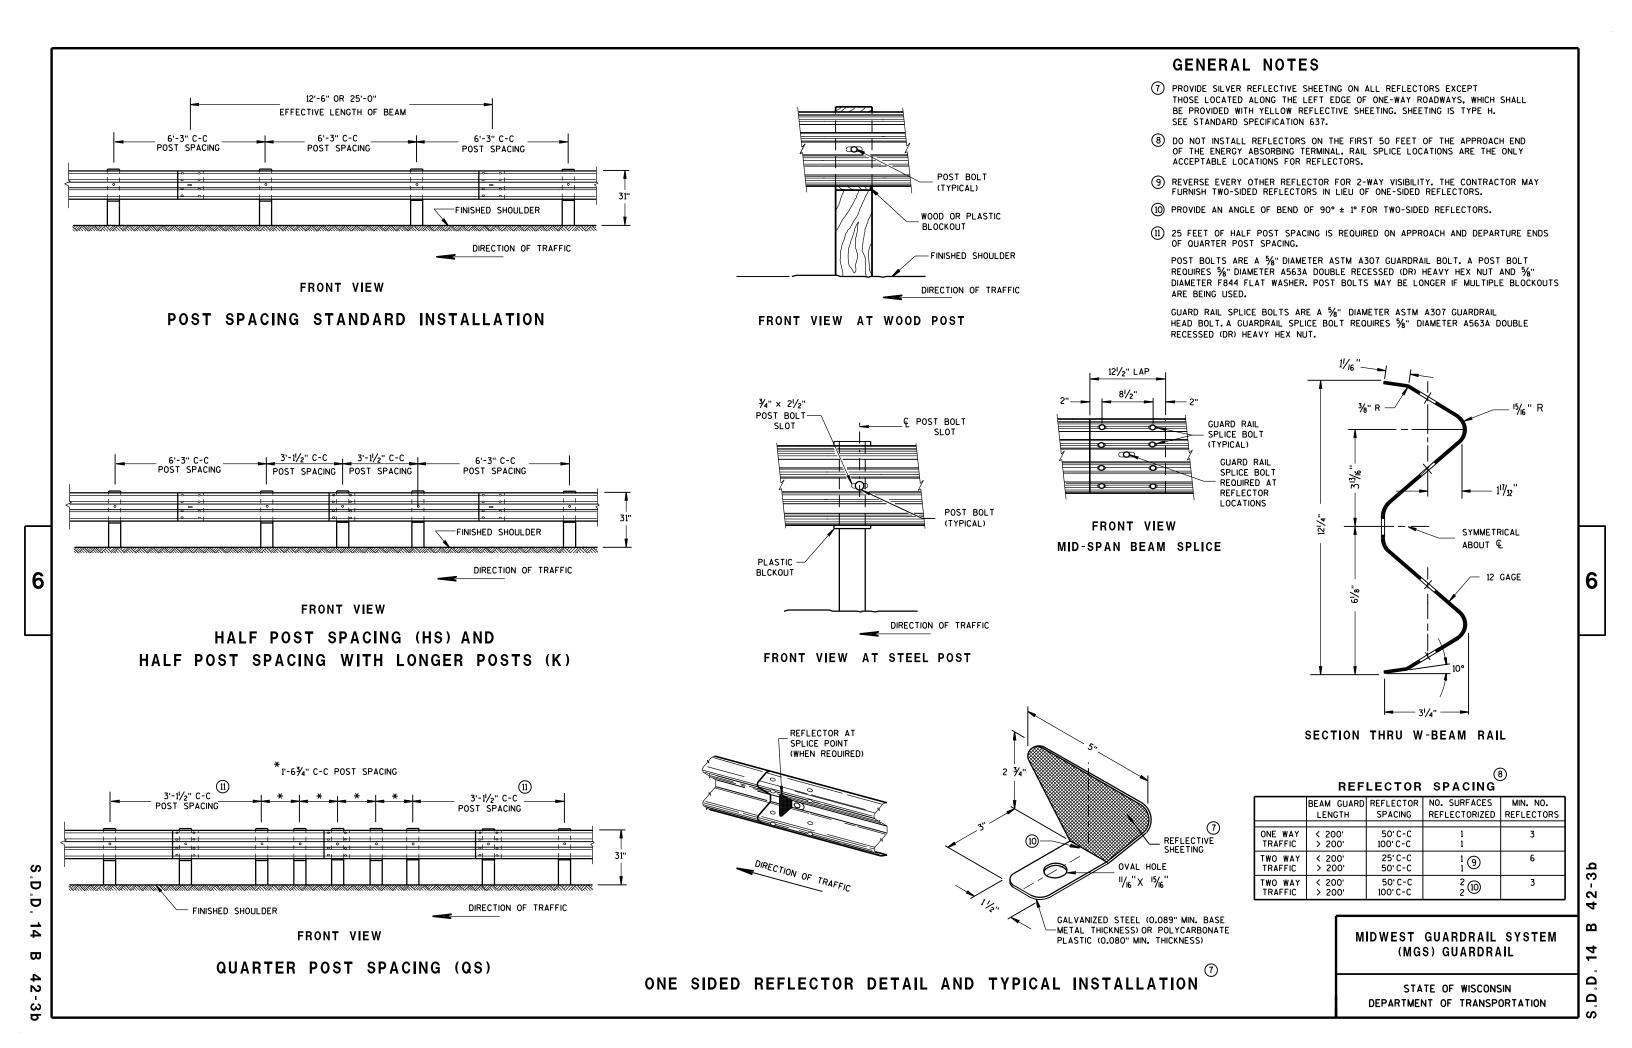

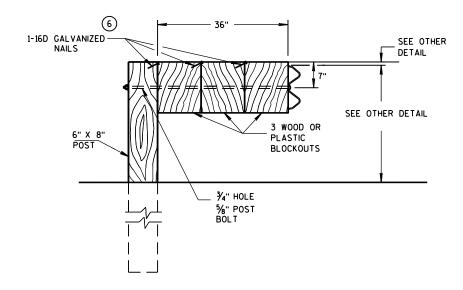


DETAIL FOR 36" BLOCKOUT DEPTH

NOTES: UNDER SPECIAL CIRCUMSTANCES, SUCH AS AVOIDING OBSTACLES THAT ARE NOT RELOCATED, IT IS ACCEPTABLE TO INSTALL ADDITIONAL BLOCKOUTS TO OBTAIN UP TO 36" DEPTH FOR ONE OR TWO POSTS IN A SECTION OF GUARDRAIL.


> DO NOT USE 16" OR 36" BLOCKOUTS IF IT CAUSES THE POST TO BE DRIVEN BEYOND SHOULDER HINGE POINT OR CAUSES A FIXED OBJECT TO BE WITHIN THE DEFLECTION DISTANCE OF THE BARRIER.

NOTE: 1. ALL FILLETS SHALL HAVE A MINIMUM RADIUS OF $\frac{1}{16}$ ". 2. IF THE BOLT EXTENDS MORE THAN 1/4" FROM THE NUT THE BOLT SHOULD BE TRIMMED BACK.

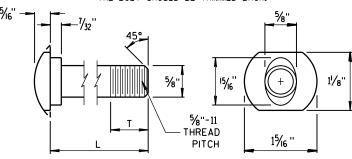


POST BOLT TABLE


11/8"
437
13/4"
4"
41/16"
4"
41/16"
4"

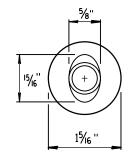

ALTERNATE BOLT HEAD

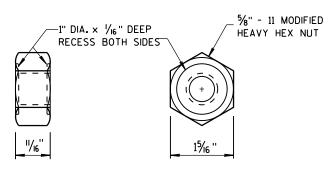


POST BOLT AND RECESS NUT

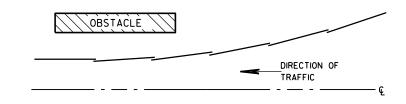


PLAN VIEW

BEAM LAPPING DETAIL

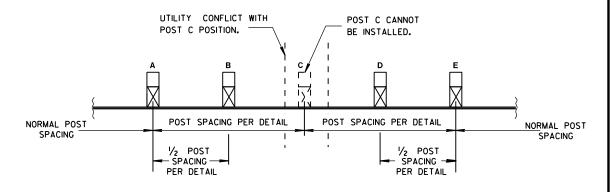

POST DRIVING FOR CONTINUOUS UNDERGROUND OBSTRUCTION



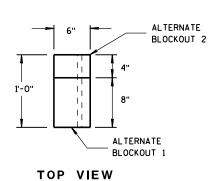

SIDE VIEW

ALTERNATE WOOD **BLOCKOUT DETAIL**

MIDWEST GUARDRAIL SYSTEM (MGS) GUARDRAIL

STATE OF WISCONSIN DEPARTMENT OF TRANSPORTATION

APPROVED

June 2014 /S/ Jerry H. Zogg ROADWAY STANDARDS DEVELOPMENT ENGINEER FHWA

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S.D.D.

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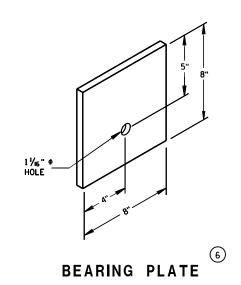
SECTION A-A SECTION B-B

9 H

PLAN VIEW

BILL OF MATERIALS

PART NO.	DESCRIPTION MATERIALS PROVIDED BY MGS EAT MANUFACTURER. SEE MANUFACTURER'S DETAILS FOR MORE INFORMATION.
1	WOOD BREAKAWAY POST
2	6" X 8" X 0.188", 6'-0" LONG FOUNDATION TUBE AT POSTS 1AND 2
3	WOOD CRT
4	WOOD BLOCKOUT
(5)	PIPE SLEEVE
6	BEARING PLATE
7	BCT CABLE ASSEMBLY
8	ANCHOR CABLE BOX
9	GROUND STRUT
10	PERFORATED W-BEAM RAIL END PANEL, 12'-6" LONG.
(11)	STANDARD W-BEAM RAIL.MULTIPLE SECTIONS REQUIRED. SECTIONS VARY IN LENGTH.
12	END SECTION EAT
(3)	0.040" ALUMINUM SHEET WITH REFLECTIVE SHEETING TYPE F PER SECTION 637 OF THE STANDARD SPECIFICATIONS
14)	EAT MARKER POST - YELLOW (SEE APPROVED PRODUCTS LIST)



MIDWEST GUARDRAIL SYSTEM ENERGY ABSORBING TERMINAL (MGS)

STATE OF WISCONSIN DEPARTMENT OF TRANSPORTATION

44-2b

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GENERAL NOTES

THE EXACT NUMBER, LOCATION, AND SPACING OF ALL SIGNS AND DEVICES SHALL BE ADJUSTED TO FIT FIELD CONDITIONS.


THE SPACING BETWEEN TRAFFIC CONTROL SIGNS SHOULD BE ADJUSTED TO NOT CONFLICT WITH AND SHOULD PROVIDE A DESIRABLE MINIMUM OF 200 FEET CLEARANCE TO EXISTING SIGNS THAT WILL REMAIN IN PLACE.

ALL SIGNS ARE 48"×48" UNLESS OTHERWISE NOTED. IF NECESSARY DUE TO SPACE CONSTRAINTS, 36"x36" SIGNS MAY BE USED INSTEAD OF 48"x48"

SIGNS THAT WILL BE IN PLACE LESS THAN 7 CONTINUOUS DAYS AND NIGHTS MAY BE MOUNTED ON PORTABLE SUPPORTS.

IF A "STOP" SIGN MUST BE REMOVED FOR A WORK OPERATION, A TEMPORARY "STOP" SIGN SHALL BE PLACED PRIOR TO THE SIGN REMOVAL, OR A FLAGGER SHALL BE PROVIDED UNTIL THE SIGN IS RE-ESTABLISHED.

* THE THIRD W20-1 SIGN IS REQUIRED ONLY IF THERE IS AN INTERSECTION BETWEEN THE "ROAD WORK 500 FT" SIGN AND THE WORK ZONE. ADJUST THE PLACEMENT OF THIS SIGN BASED ON INTERSECTION LOCATION AND OTHER FIELD CONDITIONS.

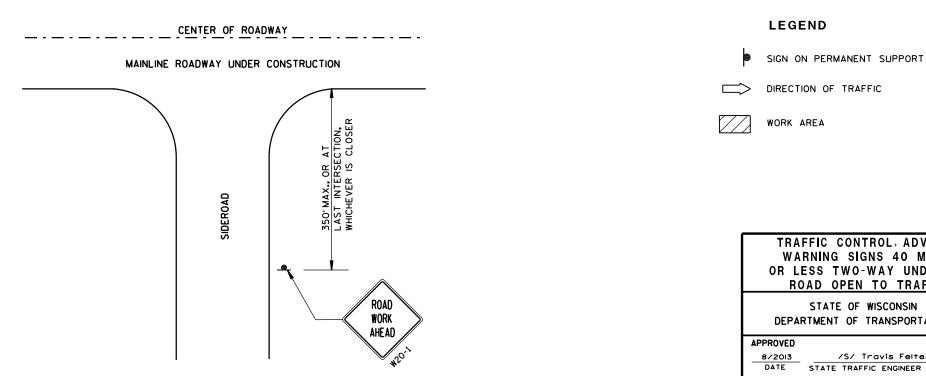

TRAFFIC CONTROL, ADVANCE WARNING SIGNS 40 M.P.H. OR LESS TWO-WAY UNDIVIDED ROAD OPEN TO TRAFFIC STATE OF WISCONSIN

DEPARTMENT OF TRANSPORTATION

/S/ Travis Feltes STATE TRAFFIC ENGINEER OF DESIGN

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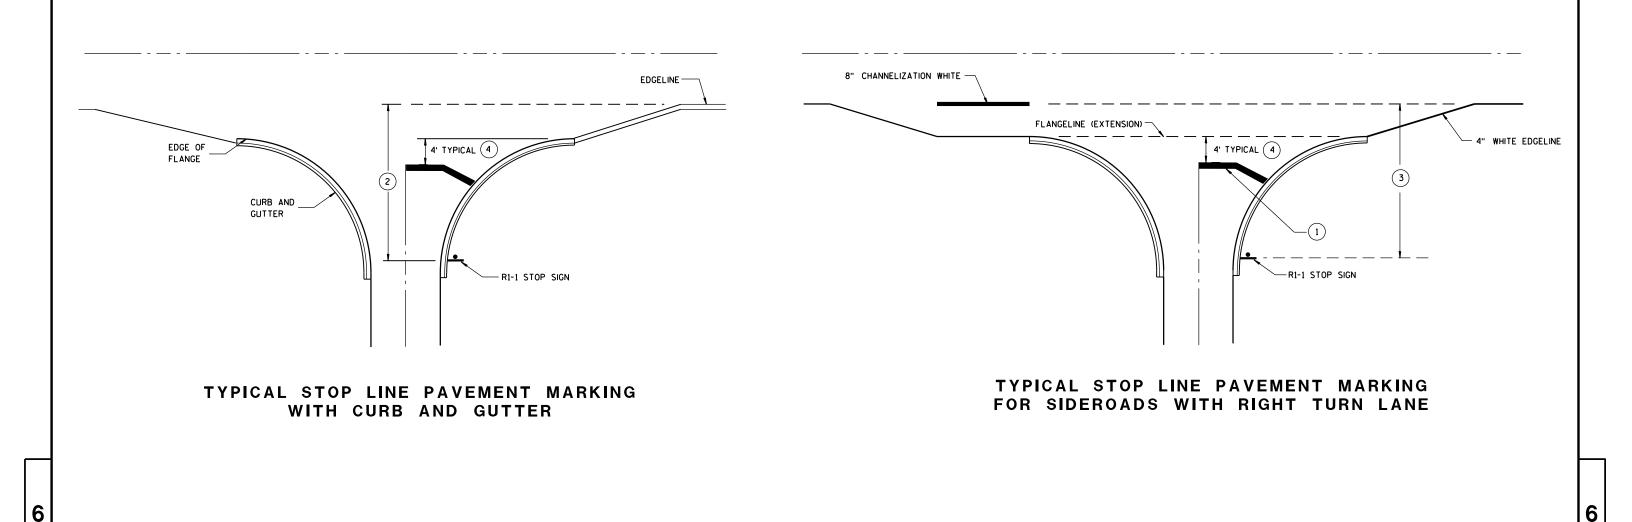
6


D Ö 15 C










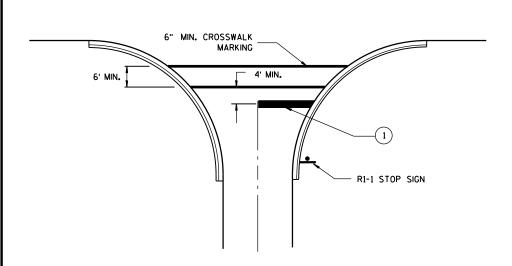

TYPICAL STOP LINE PAVEMENT MARKING FOR SIDEROADS WITH CROSSWALK MARKING

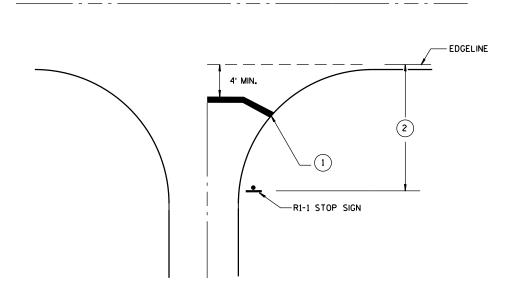

TYPICAL STOP LINE PAVEMENT MARKING WITHOUT CURB AND GUTTER

GENERAL NOTES

- 1 18-INCH STOP LINES MAY BE DELETED OR ADDED BY THE PROJECT ENGINEER BASED ON VISIBILITY AND SIGHT LINES.
- 2 IF STOP SIGN IS LESS THAN OR EQUAL TO 40 FEET FROM THE EDGELINE THAN NO STOP LINE IS REQUIRED.
- (3) IF STOP SIGN IS LESS THAN OR EQUAL TO 30 FEET FROM THE FLANGELINE EXTENSION THAN NO STOP LINE IS REQUIRED.
- MOVE CLOSER TO EDGE OF TRAVEL LANE AS NEEDED FOR VISIBILITY AND SIGHT LINES.

STOP LINE AND CROSSWALK PAVEMENT MARKING


STATE OF WISCONSIN DEPARTMENT OF TRANSPORTATION

APPROVED	
4/30/2013	/S/ Travis Feltes
DATE	STATE TRAFFIC ENGINEER
FHWA	

.D.D. 15 C 33-1

S.D.D.


33

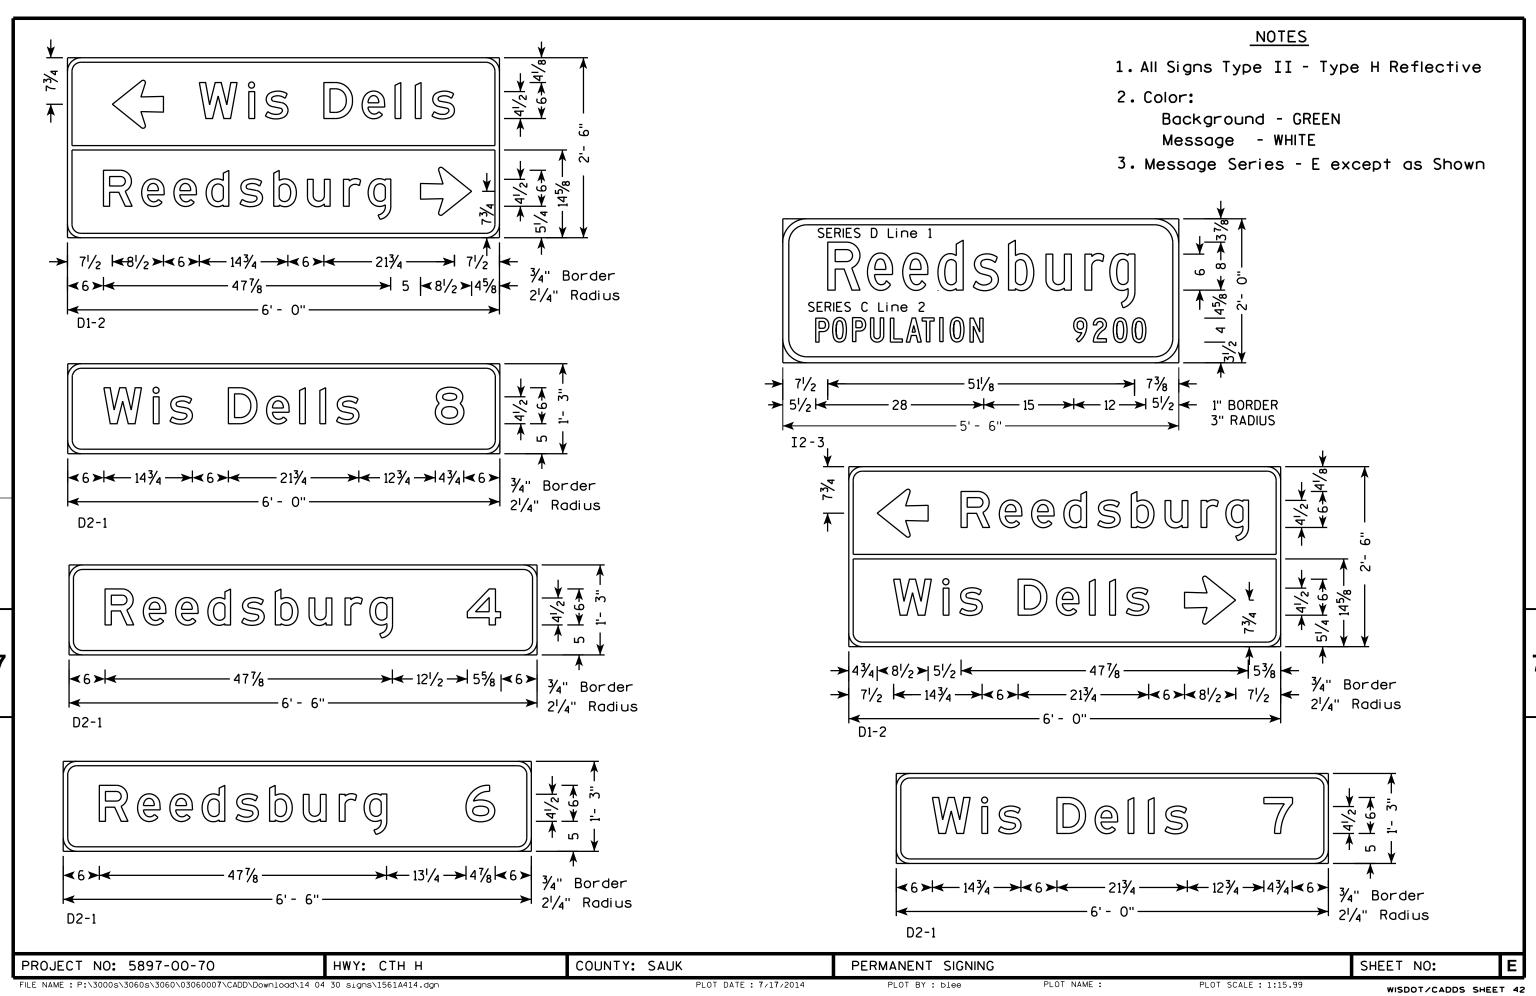



- 1. All Signs Type II Type H Reflective
- 2. Color:

Background - GREEN Message - WHITE


3. Message Series - E

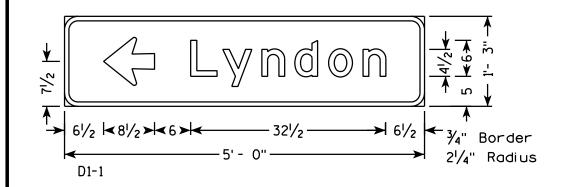

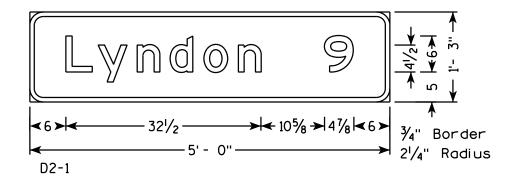

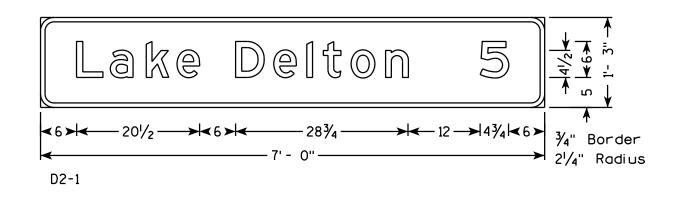

HWY: CTH H

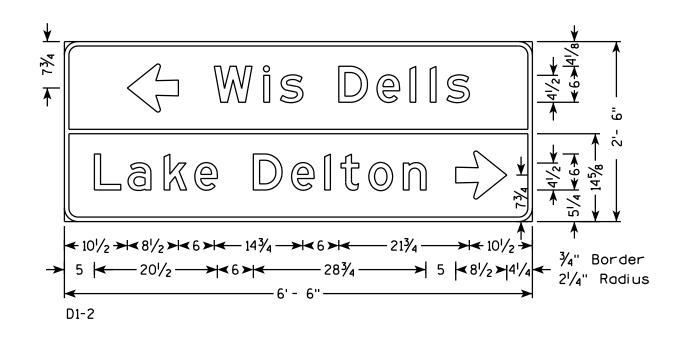

FILE NAME : P:\3000s\3060s\3060s\3060007\CADD\Download\14 04 30 signs\1561A414.dgn

PLOT DATE : 7/17/2014

COUNTY: SAUK

PERMANENT SIGNING

PLOT BY : blee

PLOT NAME :

WISDOT/CADDS SHEET 42


SHEET NO:

1561A414.dgn 7/17/2014 6:08:33 AM blee


PROJECT NO: 5897-00-70

PLOT SCALE: 1:15.99


urban area

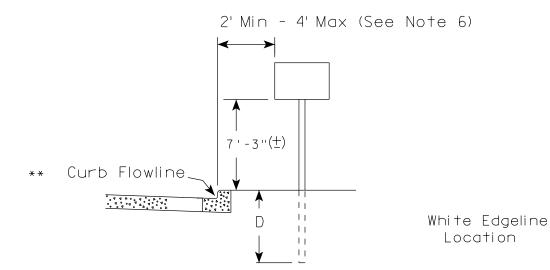

RURAL AREA (See Note 2)

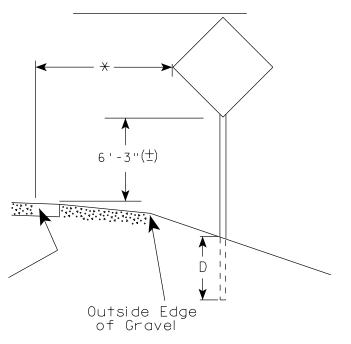

2' Min - 4' Max (See Note 6)

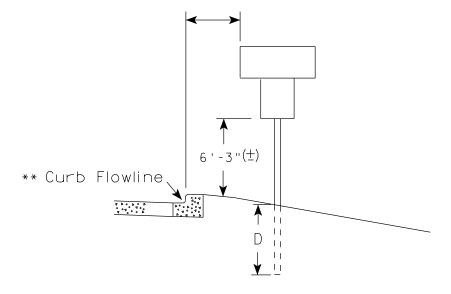

White Edgeline
Location

Outside Edge
of Gravel

** The existence of curb and gutter does not in itself mandate the vertical clearance illustrated.

That height is typically measured where

there is sidewalk adjacent to the roadway or parking is permitted. In the absence of sidewalk vertical clearance is measured from the top of the curb. Offset of signs is measured from the flow line.

HWY:

* 6 feet from edge of a paved shoulder or 12 feet from the edge of pavement (edge line location) or 2 feet from outside edge of gravel, whichever is greater unless directed by project engineer.

PLOT BY : mscj9h

GENERAL NOTES

- 1. Signs wider than 4 feet, 20 sq.ft or larger, shall be mounted on multiple posts. Refer to plate A4-4.
- 2. If signs are mounted on barrier wall, see A4-10 sign plate.
- 3. For expressways and freeways, mounting height is 7'- 3" (±) or 6'-3" (±) depending upon existence of a sub-sign.
- 4. Minimum mounting height for J assemblies (A4-5) is 7'-3'' (\pm) or 6'-3'' (\pm) per urban or rural detail respectively.
- 5. Minimum mounting height for signs mounted on traffic signal poles is $5'-3''(\underline{+})$.
- 6. Offset distance shall be consistent with existing signs or consistent throughout length of project.
- 7. The (\pm) tolerance for mounting height is 3 inches.
- 8. Folding stop signs (R1-1F) shall be mounted at a height of 5'-3" (\pm) or as directed by the Engineer.
- 9. The Double Arrow sign (W12-1) shall be mounted at a height of 2'-3" (±). The Chevron sign (W1-8), Roundabout Chevron panel (R6-4B), Enhanced Reference Markers, Clearance Markers (W5-52), Mile Markers (D10 series) & End of Rod Markers (W5-56 & W5-56A) shall be mounted at a height of 4'-3" (+).

POST EMBEDMENT DEPTH

Area of Sign	
Installation	D
(Sq. Ft.)	(Min)
20 or Less	4'
Greater than 20	5'

TYPICAL INSTALLATION
OF PERMANENT TYPE II
SIGNS ON SINGLE POSTS

WISCONSIN DEPT OF TRANSPORTATION

APPROVED

Matther & Rauh
For State Traffic Engineer

DATE 9/30/13

SHEET NO:

COUNTY:

JN I Y:

PLOT DATE: 30-SEP-2013 13:25

PLOT NAME :

PLOT SCALE: 99.237937:1.000000


WISDOT/CADDS SHEET 42


PROJECT NO:

GENERAL NOTES

- 1. For 3 or 4 post installations, individual post spacing shall be greater than 3'-6".
- 2. See tables below for required number of posts.
- 3. For expressways and freeways, mounting height is 7'-3'' (±) or 6'-3'' (±) depending upon existence of sub-sign.
- 4. The (±) tolerance for mounting height is 3 inches.
- 5. Minimum mounting height for J assemblies (A4-5) is 7'-3" (\pm) or 6'-3" (\pm) per urban or rural detail respectively.
- 6. Offset distance shall be consistent with existing signs or consistent throughout length of project.
- 7. Folding stop signs (R1-1F) shall be mounted at a height of 5'-3" (±) or as directed by the engineer.
- 8. The Double Arrow sign (W12-1) shall be mounted at a height of 2'-3" (±). The Chevron sign (W1-8), Roundabout Chevron panel (R6-4B). Clearance Markers (W5-52). Mile Markers (D10 series) & End of Road Markers (W5-56 & W5-56A) shall be mounted at a height of 4"-3" (\pm).
- * 6 feet from edge of a paved shoulder or 12 feet from the edge of pavement (edge line location) or 2 feet from outside edge of gravel, whichever is greater unless directed by project engineer.
- ** The existence of curb and gutter does not in itself mandate the vertical clearance illustrated. That height is typically measured where there is sidewalk adjacent to the roadway or parking is permitted. In the absence of sidewalk vertical clearance is measured from the top of the curb. Offset of signs is measured from the flow line.
- ** See A4-3 sign plate for signs 4' or less in width or 20 S.F. or less in area.

URBAN AREA RURAL AREA (See Note 3) 2' Min - 4' Max (See Note 6) ₩E# FF# 6'-3"(±) 6'-3"(±) 7'-3"(±) ** Curb ****\ Flowline D 700 M White Edgeline D 11 White Edgeline, Location Outside Edae Location Outside Edge of Gravel

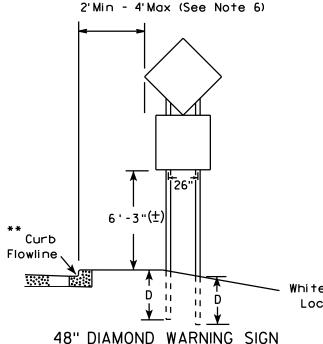

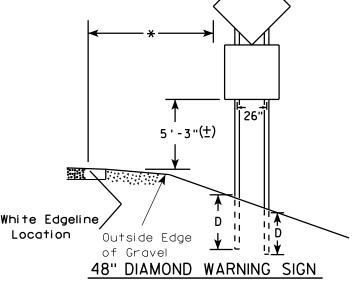

COUNTY:

of Gravel

	SIGN SHAPE OTHER THAN (TWO POSTS REQUIRED	
	L	E
* * *	Greater than 48" Less than 60"	12"
	60" to 120"	L/5

SIGN SHAPE OTHER THAN (THREE POSTS REQUIR	
L	E
Greater than 120" less than 168"	12"

HWY:

SIGN SHAPE OTHER THAN (FOUR POSTS REQUIRE	
L	E
168" and greater	12"

POST EMBEDMENT DEPTH

Area of Sign	
Installation	D
(Sq. Ft.)	(Min)
20 or Less	4'
Greater than 20	5'

TYPICAL INSTALLATION OF TYPE II SIGNS ON MULTIPLE POSTS


WISCONSIN DEPT OF TRANSPORTATION

APPROVED Matther For State Traffic Engineer

PLATE NO. A4-4.12 DATE 9/30/13

SHEET NO: PLOT BY: mscj9h

PROJECT NO:

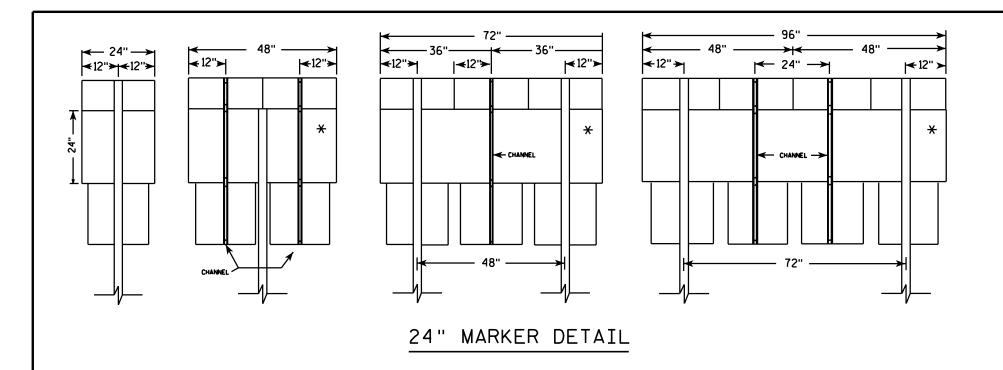


CHANNEL HARDWARE:

Aluminum Sign components: -1/4" x $\frac{3}{4}$ " bolt and $\frac{1}{4}$ " flat washers Plywood Sign Components: -1/4" x $1\frac{1}{4}$ " bolt and $\frac{1}{4}$ " flat washers

NOTES;

- 1. Post spacing shall be according to this detail but post embedment depth shall be in accordance with A4-4.
- 2. Channel material shall be as specified in Section 633 of Std. Specs. and weight shall be approx. 1.4 lbs/ft.
- 3. Base material for a multiple marker head panel (*) shall be one piece high density overlay plywood. All other materials within the assembly can be either plywood or aluminum.

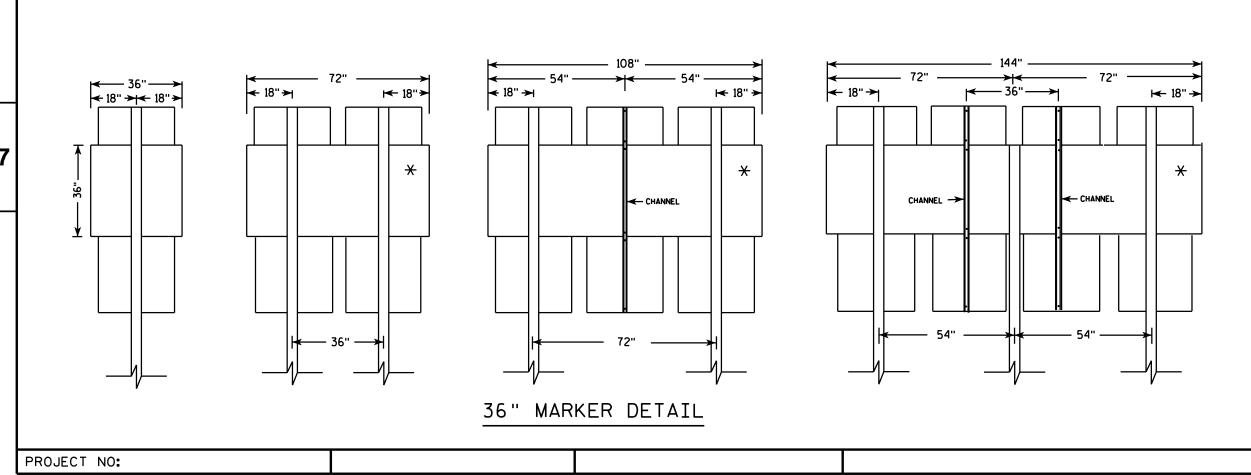

1/4" → 1 1/2

CHANNEL DETAIL

TYPICAL PANEL INSTALLATION
FOR ASSEMBLIES

WISCONSIN DEPT OF TRANSPORTATION


APPROVED

DATE 10/28/96


10/28/96 PLATE NO. A4-5.4

SHEET NO:

PLOT DATE: 18-OCT-2005 11:00 PLOT BY: DOTSJA

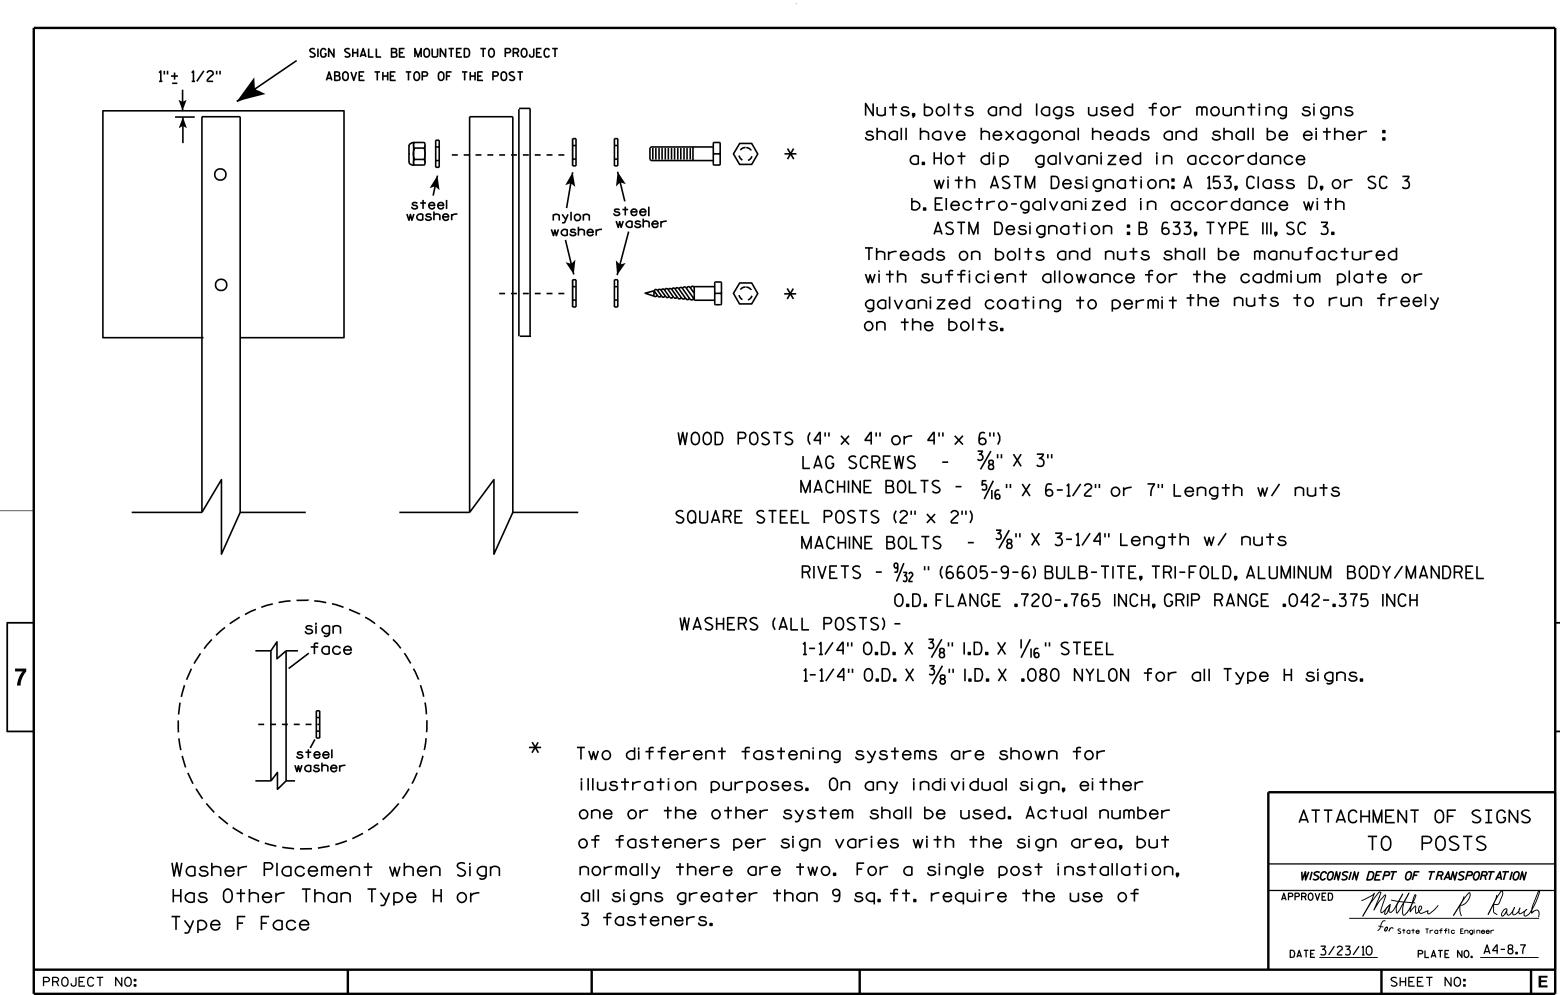



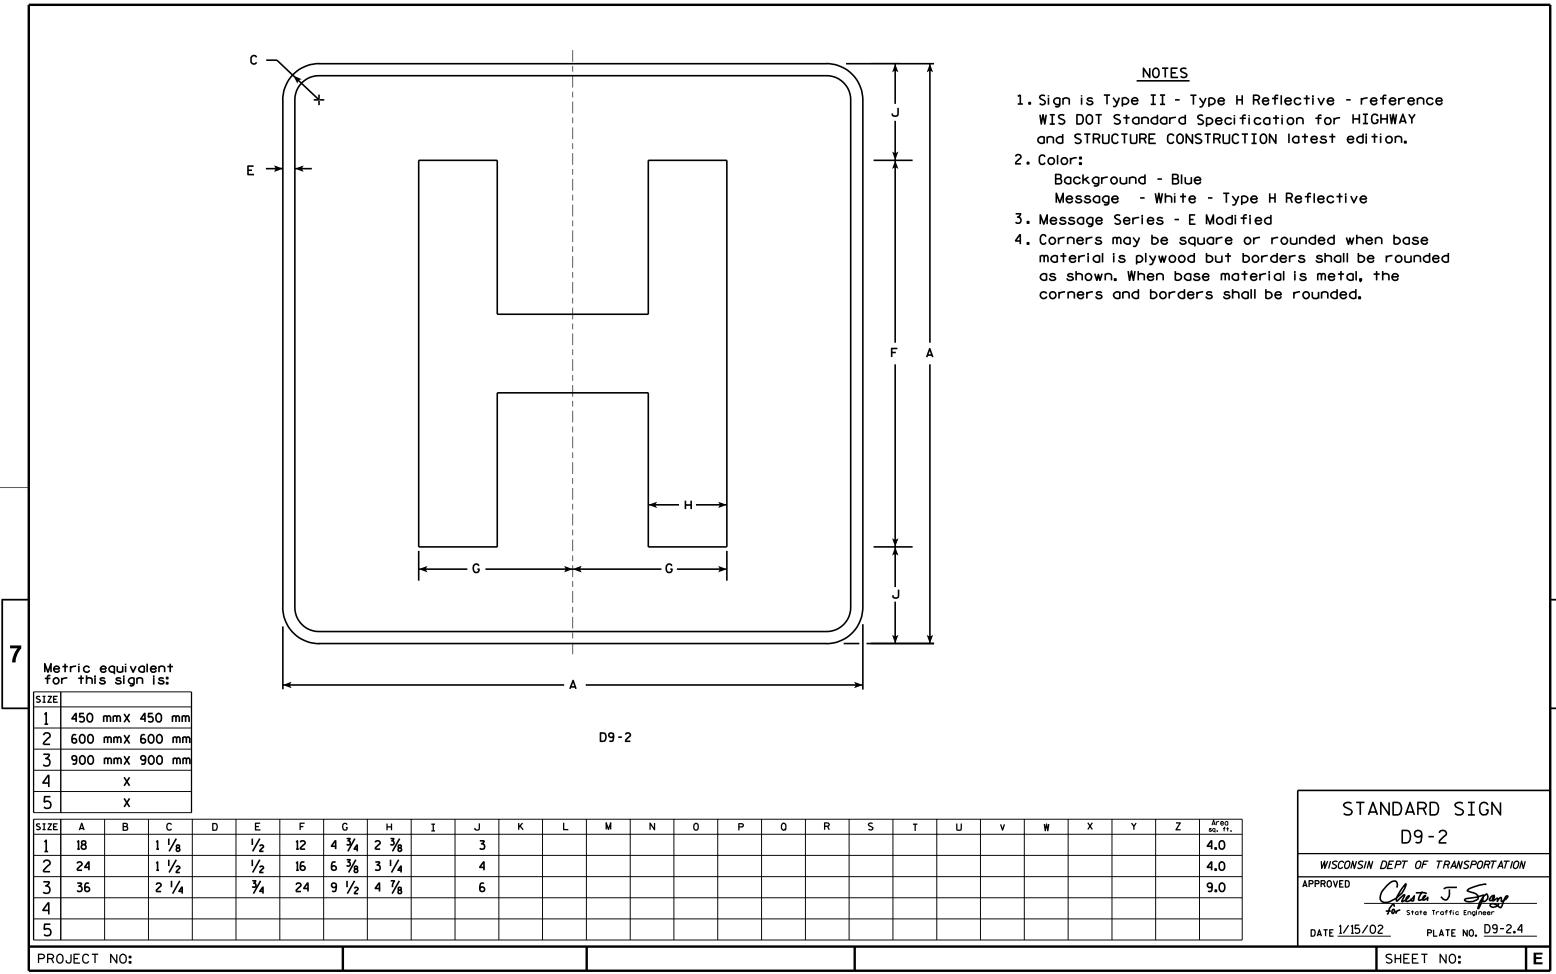



- 1. Sign is Type II see Note 7 reference WIS DOT Standard Specification for HIGHWAY and STRUCTURE CONSTRUCTION latest edition.
- 2. Color:


Background - White & Black - See Note 7 Message - Black

- 3. Message Series see Note 5
- 4. Corners may be square or rounded when base material is plywood but borders shall be rounded as shown. When base material is metal, the corners and borders shall be rounded.
- 5. Message Series E for 1 letter. Message Series D for 2 letters unless message is too big then Series C. Message Series C for 3 letters unless message is too big then Series B.
- 6. Substitute appropriate letters & optically center to achieve proper balance.
- 7. Permanent Signs

Background - Type H Reflective Detour or temporary Signs Background - Reflective

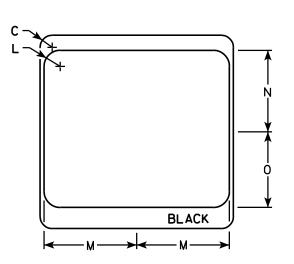

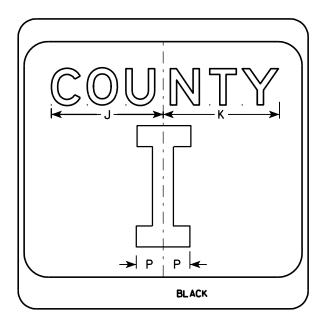

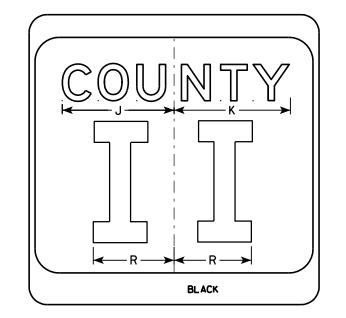

SIZE	Α	В	С	D	E	F	G	Н	I	J	K	L	M	N	0	Р	0	R	S	T	U	٧	W	X	Y	Z	Area sq. ft.
1																											
2	24		1 1/2			10	3	5 1/8	4 1/8	9 1/4	9 %	2	11 1/2	10 1/8	9 %	2 1/4		6 %									4.0
3	36		2 1/4			16	4	7 5/8	5 %	12 1/4	12 1/8	3	17 1/8	15 1/4	14	3 3/8		10									9.0
4	36		2 1/4			16	4	7 %	5 %	12 1/4	12 1/8	3	17 1/8	15 1/4	14	3 %		10									9.0
5	36		2 1/4			16	4	7 %	5 %	12 1/4	12 1/8	3	17 1/8	15 1/4	14	3 3/8		10									9.0
																			_								

COUNTY:

CTH MARKER M1-5A FOR ASSEMBLIES

WISCONSIN DEPT OF TRANSPORTATION

APPROVED

FerState Traffic Engineer PLATE NO. M1-5A.8 DATE 9/27/11

SHEET NO:

FILE NAME : C:\Users\PROJECTS\tr_stdplate\M15A.DGN

PROJECT NO:

BLACK

HWY:


M1-5A

PLOT DATE: 29-SEP-2011 11:25

PLOT NAME :

PLOT BY: mscsja

PLOT SCALE: 5.959043:1.000000

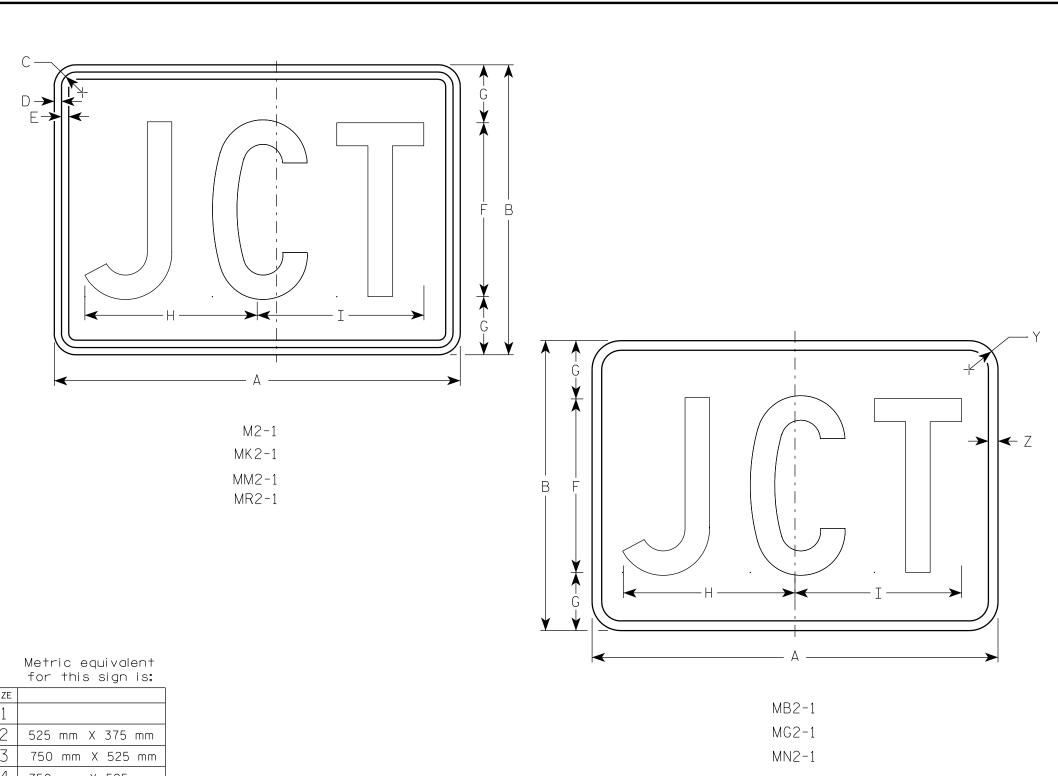

- 1. Sign is Type II See Note 5 reference WIS DOT Standard Specification for HIGHWAY and STRUCTURE CONSTRUCTION latest edition.
- 2. Color:

Background - See note 5 Message - See note 5

- 3. Message Series C
- 4. Corners may be square or rounded when base material is plywood but borders shall be rounded as shown. When base material is metal, the corners and borders shall be rounded.
- 5. M2-1 Background White Type H Reflective (Detour or temporary Signs - Reflective) Message - Black
 - MB2-1 Background Blue Message - White - Type H Reflective (Detour or temporary Signs - Reflective)
 - MG2-1 Background Green Message - White - Type H Reflective
 - MK2-1 Background Green Message - White - Type H Reflective
 - MM2-1 Background White Type H Reflective Message - Green
 - MN2-1 Background Brown Message - White - Type H Reflective
 - MR2-1 Background Brown Message - Yellow - Type H Reflective

SIZE					
1					
2	525	mm	Χ	375	mm
3	750	mm	Χ	525	mm
4	750	mm	Χ	525	mm
5	750	mm	Χ	525	mm

15

21

21

21

21

30

30

30

3

4

5

STANDARD SIGN M2 - 1

WISCONSIN DEPT OF TRANSPORTATION

APPROVED

Area Area sq. ft. m2

4.40 0.20

0.20

0.20

0.20

2.20

4.40

4.40

For State Traffic Engineer PLATE NO. M2-1.10 DATE 3/16/10

HWY: COUNTY: SHEET NO: PROJECT NO: PLOT BY: dotsja

0

FILE NAME : C:\Users\PROJECTS\tr_stdplate\M21.DGN

1 1/8

1 1/8

1 1/8

1 1/8

3/8

3/8

3/8

3/8

3/8

3/8

3/8

13

13

13

4

8 7/8 | 8 5/8

12 $\frac{7}{8}$ 12 $\frac{3}{8}$

12 $\frac{7}{8}$ 12 $\frac{3}{8}$

12 $\frac{7}{8}$ 12 $\frac{3}{8}$

PLOT DATE: 16-MAR-2010 09:49

PLOT NAME :

 $1 \frac{1}{2}$

 $1 \frac{1}{2}$

 $1 \frac{1}{2}$

 $1 \frac{1}{2}$

 $\frac{1}{2}$

 $\frac{1}{2}$


1/2

1/2

W

U

PLOT SCALE: 4.965868:1.000000

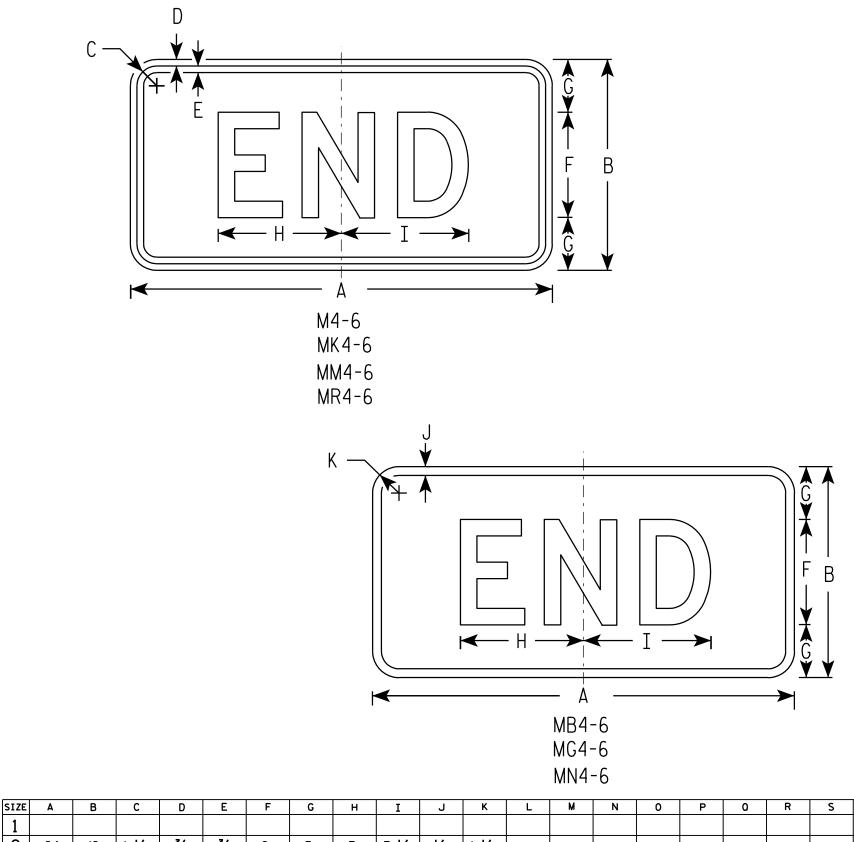

HWY:

NOTES

- 1. Sign is Type II See Note 5 reference WIS DOT Standard Specification for HIGHWAY and STRUCTURE CONSTRUCTION latest edition.
- 2. Color:

Background - See note 5 Message - See note 5

- 3. Message Series D
- 4. Corners may be square or rounded when base material is plywood but borders shall be rounded as shown. When base material is metal, the corners and borders shall be rounded.
- 5. M4-6 Background White Type H Reflective (Detour or temporary Signs Reflective)

Message - Black

- MB4-6 Background Blue
 Message White Type H Reflective
 (Detour or temporary Signs Reflective)
- MG4-6 Background Green Message - White - Type H Reflective
- MK4-6 Background Green

 Message White Type H Reflective
- MM4-6 Background White Type H Reflective Message Green
- MN4-6 Background Brown
 Message White Type H Reflective
- MR4-6 Background Brown
 Message Yellow Type H Reflective

SIZE	Α	В	С	D	E	F	G	Н	I	J	K	L	M	N	0	Р	0	R	S	T	U	٧	W	x	Y	Z	Area sq. ft.
1																											
2	24	12	1 1/8	3/8	3/8	6	3	7	7 1/4	1/2	1 1/2																2.00
3	36	18	1 1/8	3/8	1/2	9	4 1/2	12	11 %	1/2	1 1/2																4.5
4	36	18	1 1/8	3/8	1/2	9	4 1/2	12	11 1/8	1/2	1 1/2																4.5
5	36	18	1 1/8	3/8	1/2	9	4 1/2	12	11 1/8	1/2	1 1/2					·											4.5

COUNTY:

STANDARD SIGN M4-6

WISCONSIN DEPT OF TRANSPORTATION


APPROVED

Matther & Rauh
For State Traffic Engineer

DATE 11/10/10

PLOT NAME :

PROJECT NO:

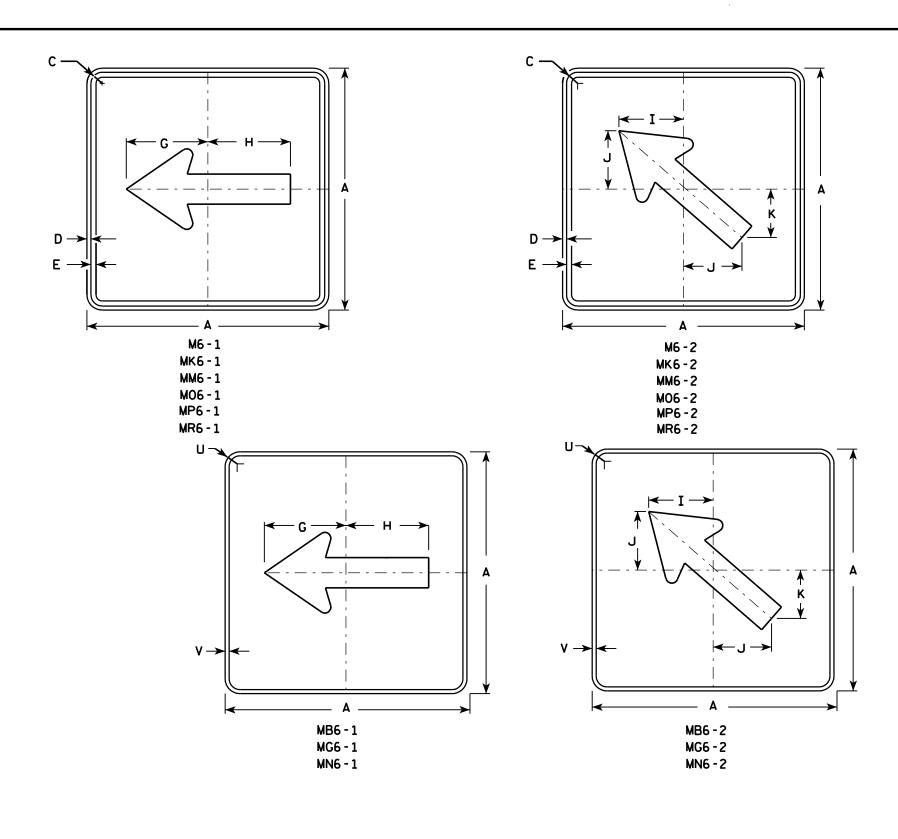

- 1. Signs are Type II See Note 4 reference WIS DOT Standard Specification for HIGHWAY and STRUCTURE CONSTRUCTION latest edition.
- 2. Color:


Background - See note 4 Message - See note 4

- 3. Corners may be square or rounded when base material is plywood but borders shall be rounded as shown. When base material is metal, the corners and borders shall be rounded.
- 4. M6-1 and M6-2 Background White Type H Reflective Message Black
 - MB6-1 and MB6-2 Background Blue Message - White - Type H Reflective
 - MG6-1 and MG6-2 Background Green
 Message White Type H Reflective
 - MK6-1 and MK6-2 Background Green

 Message White Type H Reflective
 - MM6-1 and MM6-2 Background White Type H Reflective Message Green
 - MN6-1 and MN6-2 Background Brown

 Message White Type H Reflective
- M06-1 and M06-2 Background Orange Type F Reflective Message - Black
- MP6-1 and MP6-2 Background White Type H Reflective Message Blue
- MR6-1 and MR6-2 Background Brown

 Message Yellow Type H Reflective

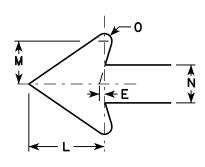

SIZE	Α	В	С	D	Ε	F	G	Ι	I	J	K	L	М	N	0	Р	0	R	S	T	U	٧	₩	X	Y	Z	Area sq. ft.
1 1																											
2	21		1 1/8	3/8	3/8		7 1/2	7 1/8	5 %	5	4 1/4	5 1/4	3	2 %	1/2						1 1/2	1/2					3.06
3	30		1 3/8	1/2	5/8		10 ¾	10 1/4	8	7 1/4	6	7 1/2	4 1/4	3 3/4	3/4						1 1/8	1/2					6.25
4	30		1 3/8	1/2	5/8		10 3/4	10 1/4	8	7 1/4	6	7 1/2	4 1/4	3 3/4	3/4						1 1/8	1/2					6.25
5	30		1 3/8	1/2	5/8		10 ¾	10 1/4	8	7 1/4	6	7 1/2	4 1/4	3 3/4	3/4						1 1/8	1/2					6.25

COUNTY:

STANDARD SIGN M6-1 & M6-2 SERIES

WISCONSIN DEPT OF TRANSPORTATION

APPROVED


Matther R Rauch
for State Traffic Engineer


DATE 7/29/13 PLATE NO. M6-1.13


SHEET NO:


HWY:

PROJECT NO:

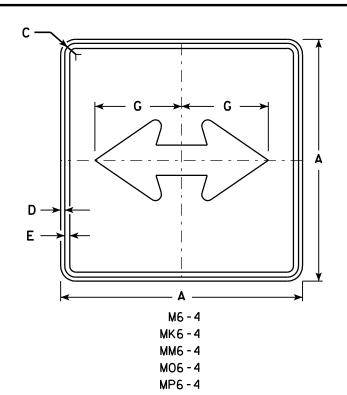

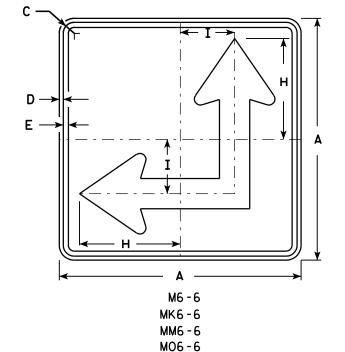

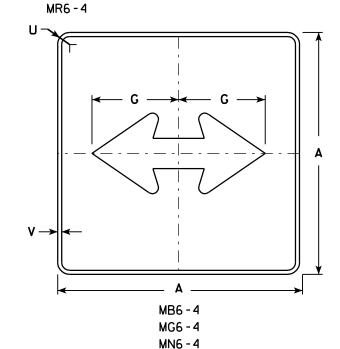

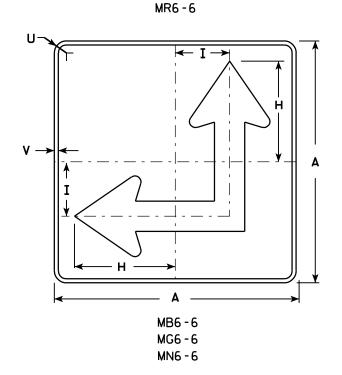

MP6-6

NOTES


- 1. Signs are Type II See Note 4 reference WIS DOT Standard Specification for HIGHWAY and STRUCTURE CONSTRUCTION latest edition.
- 2. Color:

Background - See Note 4 Message - See Note 4

- 3. Corners may be square or rounded when base material is plywood but borders shall be rounded as shown. When base material is metal, the corners and borders shall be rounded.
- 4. M6-4 and M6-6 Background White Type H Reflective Message - Black
 - and MB6-6 Background Blue MB6-4
 - Message White Type H Reflective
 - MG6-4 MG6-6 Background - Green and
 - Message White Type H Reflective MK6-4 and MK6-6 Background - Green
 - Message White Type H Reflective
 - MM6-4 and MM6-6 Background - White - Type H Reflective Message - Green
 - MN6-4 and MN6-6 Background - Brown
 - Message White Type H Reflective
 - M06-4 and M06-6 Background Orange Type F Reflective Message - Black
 - MP6-4 and MP6-6 Background - White - Type H Reflective
 - Message Blue MR6-4 and MR6-6 Background - Brown

Message - Yellow - Type H Reflective

5. M6-6R same as M6-6L except arrow points ahead and right.

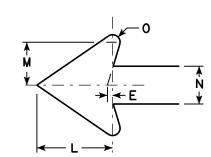

PLOT NAME :

SIZE	Α	В	С	D	E	F	G	Н	I	J	К	L	M	N	0	Р	0	R	S	T	U	٧	W	Х	Y	Z	Area sq. ft.
1																											
2	21		1 1/8	3/8	3/8		7 1/2	8 3/4	4 1/4			5 1/4	3	2 %	1/2						1 1/2	1/2					3.06
3	30		1 3/8	1/2	5/8		10 3/4	12 1/2	6 3/4			7 1/2	4 1/4	3 3/4	3/4						1 1/8	1/2					6.25
4	30		1 3/8	1/2	5/8		10 3/4	12 1/2	6 3/4			7 1/2	4 1/4	3 3/4	3/4						1 1/8	1/2					6.25
5	30		1 3/8	1/2	5/8		10 ¾	12 1/2	6 3/4			7 1/2	4 1/4	3 3/4	3/4						1 1/8	1/2					6.25
PRO	JECT	NO:					Н	WY:					СОП	NTY:													

STANDARD SIGN M6-4 & M6-6 **SERIES**


WISCONSIN DEPT OF TRANSPORTATION


APPROVED

PLATE NO. M6-4.8

DATE 7/29/13

SHEET NO:

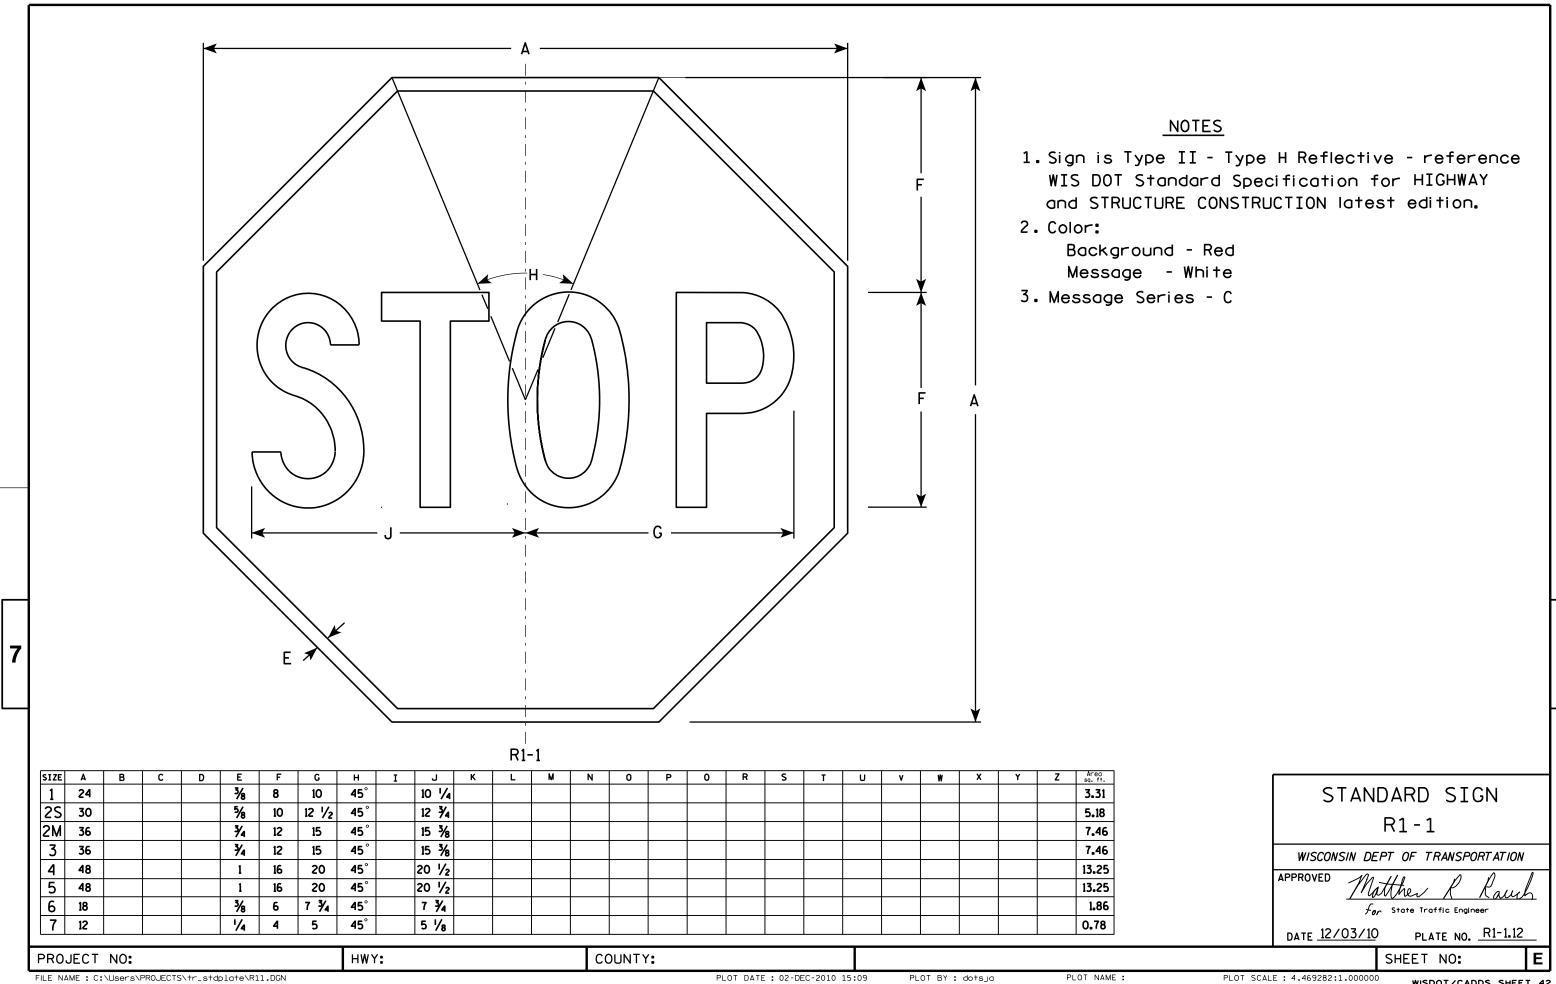

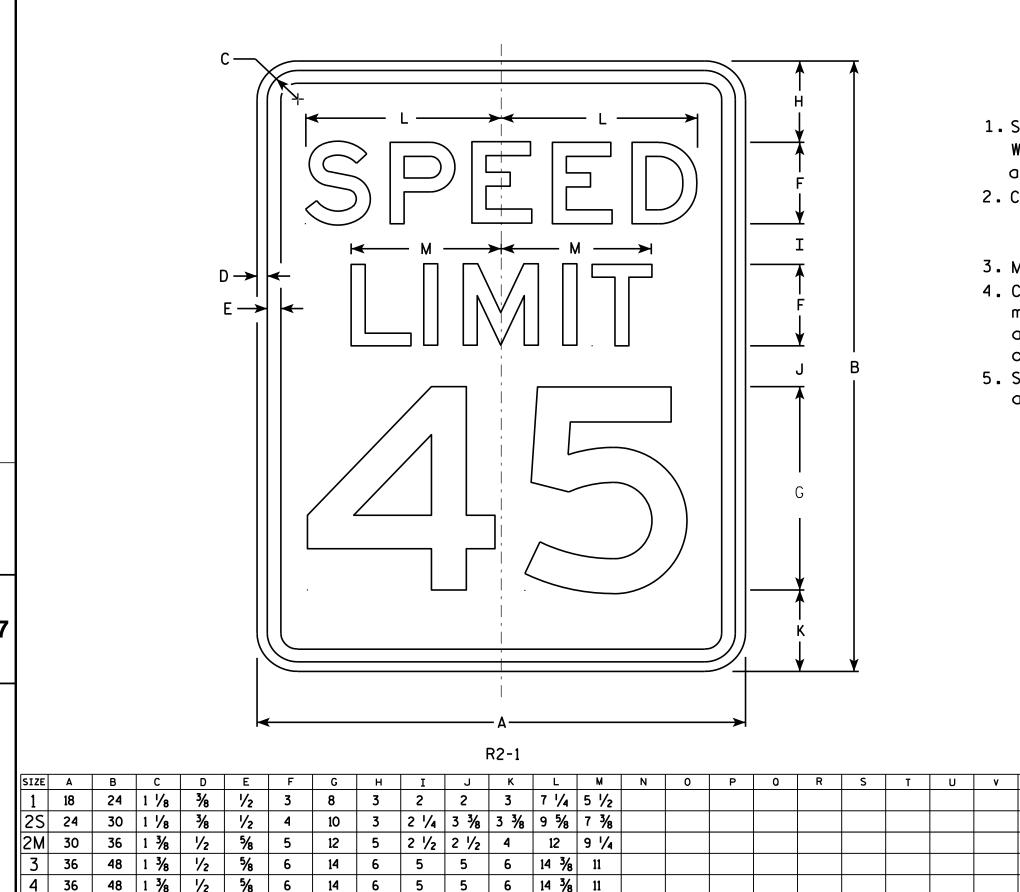

4 1/2 6 3/4 6 3/4 19 1/4 14 5/8

COUNTY:

20

HWY:

6

NOTES

- 1. Sign is Type II Type H Reflective reference WIS DOT Standard Specification for HIGHWAY and STRUCTURE CONSTRUCTION latest edition.
- 2. Color:

Background - White Message - Black

- 3. Message Series E
- 4. Corners may be square or rounded when base material is plywood but borders shall be rounded as shown. When base material is metal. the corners and borders shall be rounded.
- 5. Substitute appropriate numerals and optically adjust spacing to achieve proper balance.

3.0

5.0

7.5

12.0

12.0

20.0

STANDARD SIGN R2-1

WISCONSIN DEPT OF TRANSPORTATION APPROVED

Matther R Raus For State Traffic Engineer PLATE NO. R2-1.13

DATE <u>5/26/1</u>0

SHEET NO:

2 1/4

60

5

48


PROJECT NO:


PLOT NAME :

- 1. Sign is Type II Type H Reflective reference WIS DOT Standard Specification for HIGHWAY and STRUCTURE CONSTRUCTION latest edition.
- 2. Color:

Background - White Message - Black

- 3. Message Series Line 1 is Series B. Line 2 is Series C. Line 3 on plate R3-7R is Series B and Series C on plate R3-7L.
- 4. Corners may be square or rounded when base material is plywood but borders shall be rounded as shown. When base material is metal, the corners and borders shall be rounded.

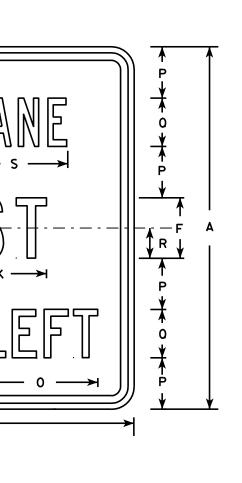

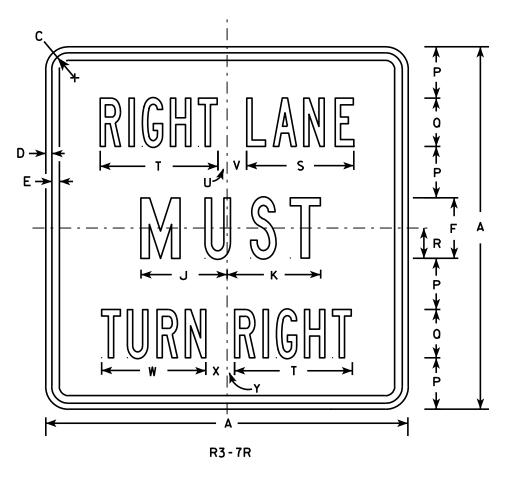

SIZE	Α	В	С	D	E	F	G	Н	I	J	К	L	М	N	0	Р	0	R	S	Т	U	V	w	X	Y	Z	Areo sq. ft.
1	30		1 3/8	1/2	5/8	5	7 3/4	1 3/4	5/8	7 1/8	7 3/4	11 1/4	2 3/8	3/4	9 %	4 1/4	4	2 1/2	8 %	9 3/4	3/4	1 %	8 %	1 %	5/8		6.25
25	30		1 3/8	1/2	5/8	5	7 3/4	1 3/4	5/8	7 1/8	7 3/4	11 1/4	2 3/8	3/4	9 %	4 1/4	4	2 1/2	8 1/8	9 3/4	3/4	1 %	8 %	1 %	5/8		6.25
2M	30		1 3/8	1/2	5/8	5	7 3/4	1 3/4	5/8	7 1/8	7 3/4	11 1/4	2 3/8	3/4	9 %	4 1/4	4	2 1/2	8 %	9 3/4	3/4	1 %	8 %	1 %	5/8		6.25
3	36		1 5/8	5/8	3/4	6	9 %	2	1 1/8	8 3/4	9	13 ½	3 %	1 1/2	12 1/2	5	5	3	10 %	12	7∕8	2 1/4	10 %	2 1/8	1		9.00
4	48		2 1/4	3/4	1	8	13 1/2	2 3/8	1 ½	11 1/2	11 1/8	17 3/4	3 %	2 1/2	16 3/8	6 1/2	7	4	14 3/8	16 1/8	5/8	3 1/4	15 1/8	2 3/4	1 1/8		16.00
5																											

COUNTY:

STANDARD SIGN R3-7L & R3-7R

WISCONSIN DEPT OF TRANSPORTATION

APPROVED

Matther R Rauch

DATE 3/18/2011

SHEET NO:

FILE NAME : C:\Users\PROJECTS\tr_stdplate\R37.DGN

PROJECT NO:

R3-7L

HWY:

PLOT DATE: 18-MAR-2011 09:43

PLOT BY: mscsja

PLOT NAME :

PLOT SCALE: 7.945391:1.000000

WISDOT/CADDS SHEET 42

PLATE NO. R3-7.3


00 S3-1

NOTES

- 1. All Signs Type II Type F Reflective reference WIS DOT Standard Specification for HIGHWAY and STRUCTURE CONSTRUCTION latest edition.
- 2. Color:

Background - YELLOW-GREEN Message - BLACK except as noted Circles except PEDS- RED BACKGROUND

3. Corners may be square or rounded when base material is plywood but borders shall be rounded as shown. When base material is metal, the corners and borders shall be rounded.

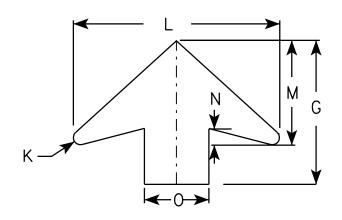

RROW	DFTAII

SIZE	Α	В	С	D	E	F	G	Н	I	J	K	L	М	N	0	Р	0	R	S	Т	U	٧	W	X	Y	Z	Area sq. ft.
1	30		1 3/8	1/2	5/8	6 1/4	11 1/4	12 1/2	5 1/4	5 ½	1/2	16	8	1 1/4	5	1 1/2		6 %	5 %	10 %							6.25
2	36		1 %	5/8	₹4	7 1/2	13 1/2	15 1/8	6 1/4	6 1/2	5/8	19 1/4	9 3/4	1 %	6	1 1/8		7 1/8	6 3/8	12 3/8							9.0
3	48		2 1/4	3/4	1	10	17 1/8	20 1/8	8 %	8 3/4	7 ⁄8	25 %	13	2	8	2 1/2		10 1/2	8 1/2	16 1/2							16.0
4	48		2 1/4	₹4	1	10	17 1/8	20 1/8	8 %	8 ¾	1 / ₈	25 %	13	2	8	2 1/2		10 1/2	8 1/2	16 1/2							16.0
5																											

STANDARD SIGN S3-1

WISCONSIN DEPT OF TRANSPORTATION

APPROVED

for State Traffic Engineer DATE <u>6/8/10</u>

SHEET NO:

FILE NAME : C:\Users\PROJECTS\tr_stdplate\S31.DGN


PROJECT NO:

PLATE NO. <u>\$3-1.6</u>

- 1. Sign is Type II Type F Reflective reference WIS DOT Standard Specification for HIGHWAY and STRUCTURE CONSTRUCTION latest edition.
- 2. Color:

Background - Yellow Message - Black

- 3. Corners may be square or rounded when base material is plywood but borders shall be rounded as shown. When base material is metal, the corners and borders shall be rounded.
- 4. W1-2L is the same as W1-2R except the arrow is reversed along the vertical centerline.

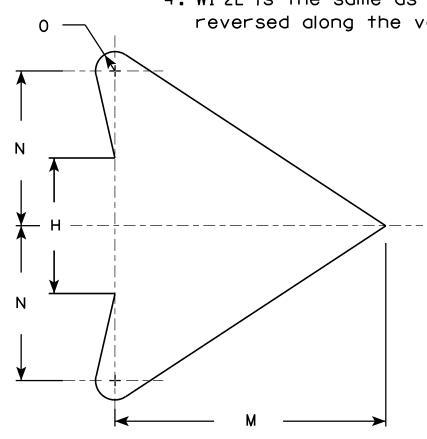

								W	1-2R													<u> </u>	11011	DLIA	<u></u>		
SIZE	Α	В	С	D	E	F	G	н	I	J	К	L	M	N	0	Р	0	R	S	Т	U	v	W	×	Y	Z	Area sq. ft.
1	24		1 1/8	3/8	1/2		8 1/4	3 1/2	4 1/2	1 3/4	2 3/8	7 1/4	7	4	1/2												4.0
25	30		1 3/8	1/2	5/8		10 1/4	4 3/8	5 %	2 1/4	3	9 1/8	8 3/4	5	5/8												6.25
2M	36		1 %	5/8	3/4		12 3/8	5 1/4	6 3/4	2 %	3 1/2	10 1/8	10 1/2	6	3/4												9.0
3	36		1 5/8	5/8	3/4		12 3/8	5 1/4	6 3/4	2 %	3 1/2	10 1/8	10 1/2	6	3/4												9.0
4	36		1 5/8	5/8	3/4		12 3/8	5 1/4	6 3/4	2 %	3 1/2	10 1/8	10 1/2	6	3/4												9.0
5	48		2 1/4	3/4	1		16 1/2	7	9	3 1/2	4 5/8	14 1/2	14	8	1												16.0
					•	·		•	•									•					•				•

COUNTY:

STANDARD SIGN W1-2

WISCONSIN DEPT OF TRANSPORTATION

APPROVED

Matther R Rauch For State Traffic Engineer

DATE <u>5/15/12</u>


PLATE NO. W1-2.10

SHEET NO:

PROJECT NO:

← H →

HWY:

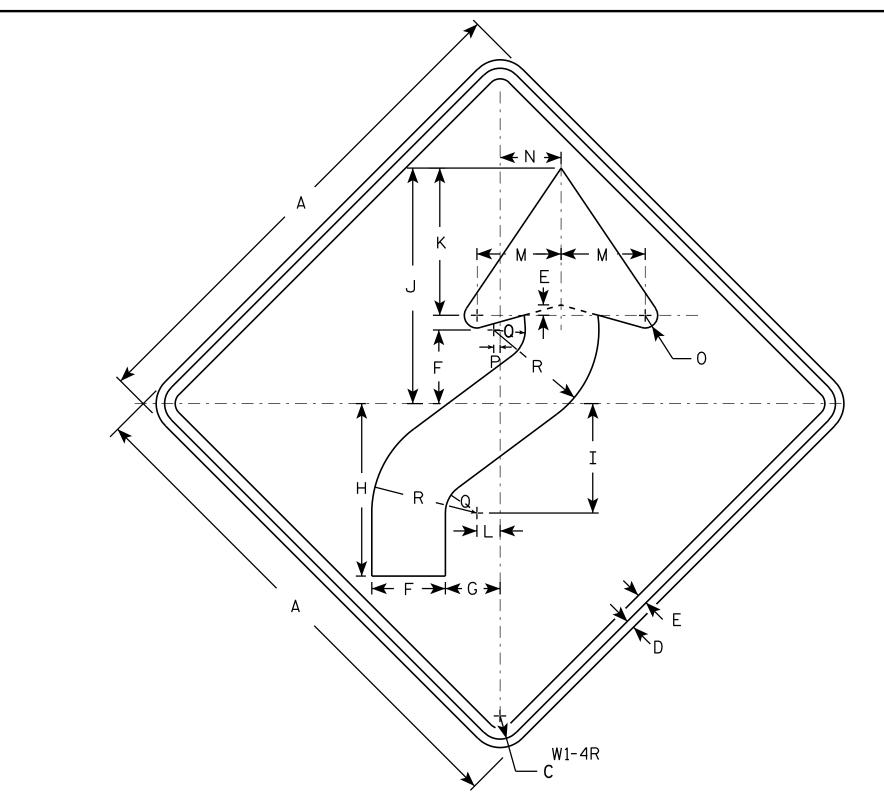

- 1. Sign is Type II Type F Reflective reference WIS DOT Standard Specification for HIGHWAY and STRUCTURE CONSTRUCTION latest edition.
- 2. Color:

Background - Yellow Message - Black

- 3. Corners may be square or rounded when base material is plywood but borders shall be rounded as shown. When base material is metal, the corners and borders shall be rounded.
- 4. W1-4L is the same as W1-4R except the arrow is reversed along the vertical centerline.

3 1/2 2 5/8 8 1/4 5 1/4 11 1/4 5/8 1/4 1 1/2 5 24 1 1/8 4.0 25 3 5/8 3/4 3/8 1 1/8 6 1/4 30 4 3/8 3 1/4 10 1/4 6 1/2 14 8 3/4 1 3/8 6.25 36 12 3/8 7 1/8 16 1/8 10 1/2 1 5/8 4 1/2 1 1/2 2 1/4 7 1/2 9.0 3 12 3/8 7 1/8 16 1/8 10 1/2 1 5/8 36 5 1/4 4 1/2 | 1 1/2 2 1/4 7 1/2 9.0 4 36 1 % 5 1/4 | 12 3/8 | 7 3/8 | 16 3/8 | 10 1/2 | 1 5/8 4 1/2 1 2 1/4 7 1/2 1/2 9.0 5 48 5 1/4 16 1/2 10 1/2 22 1/2 14 2 1/4 6 1 1/4 16.0

STANDARD SIGN W1-4

WISCONSIN DEPT OF TRANSPORTATION

APPROVED

Matthe R Raw
For State Traffic Engineer

SHEET NO:

DATE 5/17/12

PLATE NO. W1-4.11

HWY:

COUNTY:

PLOT DATE: 17-MAY-2012 13:20 PLOT BY: mscsja

PLOT NAME :

PLOT SCALE: 5.706180:1.000000

WISDOT/CADDS SHEET 42

PROJECT NO:

- 1. Sign is Type II Type F Reflective reference WIS DOT Standard Specification for HIGHWAY and STRUCTURE CONSTRUCTION latest edition.
- 2. Color:

Background - Yellow Message - Black

3. Corners may be square or rounded when base material is plywood but borders shall be rounded as shown. When base material is metal, the corners and borders shall be rounded.

c —	A A
	G
↑ ↑ ↑ ↑ ↑ ↑ ↑ ↑ ↑ ↑ ↑ ↑ ↑ ↑ ↑ ↑ ↑ ↑ ↑	_
$\begin{array}{c ccccccccccccccccccccccccccccccccccc$	
W1-6	

SIZE	Α	В	С	D	E	F	G	Н	I	J	К	L	М	N	0	Р	0	R	S	Т	U	٧	W	X	Y	Z	Area sq. ft.
1	36	18	1 1/8	3/8	3/8		9	10	3/4	5 %	4 3/4	2 3/8	14 %	29 1/4													4.5
2S	48	24	1 3/8	1/2	5/8		12	13 1/4	1	7 1/2	6 1/2	3 1/4	19 1/2	39													8.0
2M	48	24	1 3/8	1/2	5/8		12	13 1/4	1	7 1/2	6 1/2	3 1/4	19 1/2	39													8.0
3	60	30	1 3/8	1/2	5/8		15	16 1/4	1 1/4	9 1/4	8	4	24 3/8	48 3/4													12.5
4	60	30	1 3/8	1/2	5/8		15	16 1/4	1 1/4	9 1/4	8	4	24 3/8	48 3/4													12.5
5	96	48	2 1/4	3∕4	1		24	26 1/2	2	15	13	6 1/2	39	78													32.0

COUNTY:

STANDARD SIGN W1-6

WISCONSIN DEPT OF TRANSPORTATION

APPROVED

For

DATE 6/7/10 PLATE NO. W1-6.8

SHEET NO:

HWY:


PROJECT NO:

PLOT NAME :

- 1. Sign is Type II Type F Reflective reference WIS DOT Standard Specification for HIGHWAY and STRUCTURE CONSTRUCTION latest edition.
- 2. Color:

Background - Yellow Message - Black

3. Corners may be square or rounded when base material is plywood but borders shall be rounded as shown. When base material is metal, the corners and borders shall be rounded.

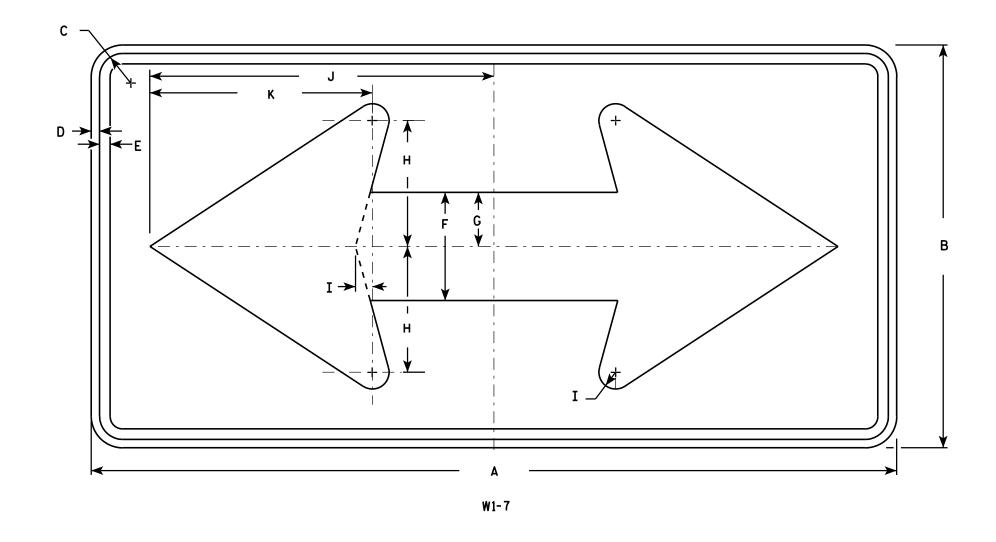

SIZE	Α	В	С	D	E	F	G	Н	I	J	K	L	М	N	0	Р	0	R	S	T	U	٧	₩	Х	Y	Z	Area sq. ft.
1	36	18	1 1/8	3⁄8	1/2	5	2 1/2	5 ¾	3/4	15 5/8	10 1/8																4.5
2S	48	24	1 3/8	1/2	5/8	6 1/2	3 1/4	7 1/2	1	20 1/2	13 1/4																8.0
2M	48	24	1 3/8	1/2	5/8	6 1/2	3 1/4	7 1/2	1	20 1/3	13 1/4																8.0
3	60	30	1 3/8	1/2	5/8	8	4	9 1/4	1 1/4	25 3/8	16 1/4																12.5
4	60	30	1 3/8	1/2	5/8	8	4	9 1/4	1 1/4	25 3/	16 1/4																12.5
5	96	48	2 1/4	3/4	1	13	6 1/2	15	2	41	26 1/2																32.0

COUNTY:

STANDARD SIGN W1-7

WISCONSIN DEPT OF TRANSPORTATION

APPROVED

Matthew R

For State Traffic Engineer

DATE 6/7/10 PLATE NO. W1-7.7

SHEET NO:

FILE NAME : C:\Users\PROJECTS\tr_stdplate\W17.DGN

PROJECT NO:


HWY:

PLOT DATE: 07-JUN-2010 12:35

PLOT BY : ditjph

PLOT NAME :

PLOT SCALE: 5.720679:1.000000

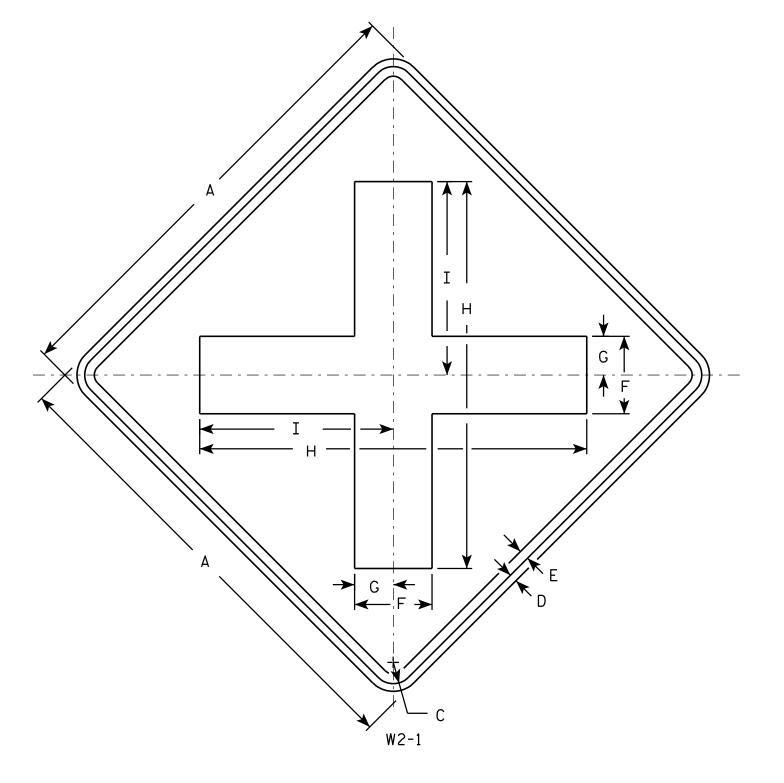

- 1. Sign is Type II Type F Reflective reference WIS DOT Standard Specification for HIGHWAY and STRUCTURE CONSTRUCTION latest edition.
- 2. Color:

Background - Yellow Message - Black

3. Corners may be square or rounded when base material is plywood but borders shall be rounded as shown. When base material is metal, the corners and borders shall be rounded.

SIZE	Α	В	С	D	E	F	G	Н	I	J	K	L	М	N	0	Р	0	R	S	Т	U	٧	W	Х	Y	Z	Areo sq. ft.
1	24		1 1/8	3/8	1/2	4	2	20	10																		4.0
25	30		1 3/8	1/2	5/8	5	2 1/2	25	12 1/2																		6.25
2M	30		1 3/8	1/2	5/8	5	2 1/2	25	12 1/2																		6.25
3	36		1 5/8	5/8	3/4	6	3	30	15																		9.0
4	48		2 1/4	3/4	1	8	4	40	20																		16.0
5																											

COUNTY:

STANDARD SIGN W2-1

WISCONSIN DEPT OF TRANSPORTATION

APPROVED

Matthew R Rauch
For State Traffic Engineer

DATE 5/29/12

PLATE NO. W2-1.9

SHEET NO:

FILE NAME : C:\CAEFiles\Projects\tr_stdplate\W21.DGN

PROJECT NO:

HWY:

PLOT DATE: 29-MAY-2012 10:10

PLOT NAM

PLOT BY: mscsja

PLOT SCALE: 6.202372:1.000000

- 1. Sign is Type II Type F Reflective reference WIS DOT Standard Specification for HIGHWAY and STRUCTURE CONSTRUCTION latest edition.
- 2. Color:

Background - Yellow Message - Black

3. Corners may be square or rounded when base material is plywood but borders shall be rounded as shown. When base material is metal, the corners and borders shall be rounded.

W2-2

SIZE	Α	В	С	D	E	F	G	Н	I	J	K	L	М	N	0	P	0	R	S	T	C	٧	W	X	Y	Z	Areo sq. 11.
1	24		1 1/8	3∕8	1/2	20	2	4	10	8																	4.0
25	30		1 3/8	1/2	5/8	25	2 1/2	5	12 1/2	10																	6.25
2M	30		1 3/8	1/2	5/8	25	2 1/2	5	12 1/2	10																	6.25
3	36		1 5/8	5/8	3/4	30	3	6	15	12																	9.0
4	48		2 1/4	3/4	1	40	4	8	20	16																	16.0
5																											

COUNTY:

STANDARD SIGN W2-2

WISCONSIN DEPT OF TRANSPORTATION

APPROVED

Matthew R Rauch For State Traffic Engineer

SHEET NO:

DATE 5/29/12

PLATE NO. <u>W2-2.6</u>

FILE NAME : C:\CAEFiles\Projects\tr_stdplate\W22.DGN

PROJECT NO:

HWY:

PLOT DATE: 29-MAY-2012 10:18

PLOT NAME :

PLOT BY: mscsja


PLOT SCALE: 6.202372:1.000000

- 1. Sign is Type II Type F Reflective reference WIS DOT Standard Specification for HIGHWAY and STRUCTURE CONSTRUCTION latest edition.
- 2. Color: *

 Background YELLOW*

 Message BLACK
- 3. Message Series C for numbers Series E for wording
- 4. Substitute appropriate numerals and optically adjust spacing to achieve proper balance

*Speed Limit Sign shall have a White Background

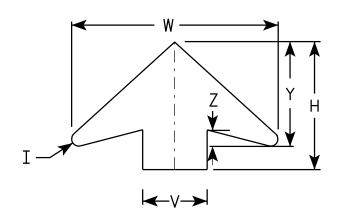

ARROW DETAIL

SIZE	A	В	С	D	E	F	G	н	I	J	K	L	М	N	0	Р	0	R	S	T	U	٧	W	×	Y	Z	Area sq. ft
1																											
25	36		1 1/8	5/8	3/4	14 1/2	9 1/2	11 1/2	5/8	24	2	3	1	12	7 1/8	1 1/2	3/8	5 3/4	7 1/4	7 1/8	9	6	19 1/4	3/8	9 3/4	1 %	9.0
2M	36		1 %	5/8	3/4	14 1/2	9 1/2	11 1/2	5/8	24	2	3	1	12	7 1/8	1 1/2	3/8	5 3/4	7 1/4	7 1/8	9	6	19 1/4	3/8	9 3/4	1 %	9.0
3	36		1 %	5/8	3/4	14 1/2	9 1/2	11 1/2	5/8	24	2	3	1	12	7 1/8	1 1/2	3∕8	5 3/4	7 1/4	7 1/8	9	6	19 1/4	3/8	9 3/4	1 %	9.0
4	48		2 1/4	3/4	1	19 1/4	10 3/4	17 3/8	1 /8	30	2 1/4	4	1 1/4	15	10	1 %	1/2	8	9 1/4	9 3/8	12	8	25 %	3/8	13	2	16.0
5	48		2 1/4	3/4	1	19 1/4	10 3/4	17 3/8	7 /8	30	2 1/4	4	1 1/4	15	10	1 5/8	1/2	8	9 1/4	9 3/8	12	8	25 %	3/8	13	2	16.0

STANDARD SIGN W3-5

WISCONSIN DEPT OF TRANSPORTATION

APPROVED

Matther R Rauch.

DATE 5/29/12 PLATE NO. W3-5.5

SHEET NO:


PROJECT NO:

<u>NOTES</u>

- 1. Sign is Type II Type F Reflective reference WIS DOT Standard Specification for HIGHWAY and STRUCTURE CONSTRUCTION latest edition.
- 2. Color:

Background - Yellow Message - Black

3. Corners may be square or rounded when base material is plywood but borders shall be rounded as shown. When base material is metal, the corners and borders shall be rounded.

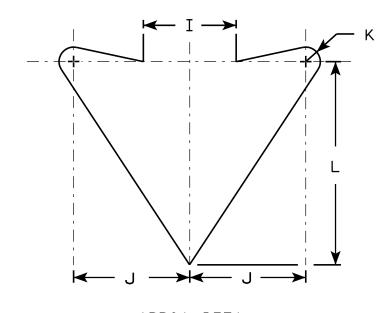

ARROW DETAIL

SIZE	Α	В	С	D	Ε	F	G	Н	I	J	К	L	М	N	0	Р	0	R	S	Т	U	٧	W	Х	Y	Z	Area sq. ft.
1	30		1 3/8	1/2	5/8	10 1/2	1	3 %	4	5	5/8	8 3/4	5 %														6.25
2S	36		1 %	5/8	3/4	12	1	4 1/4	5	6	3/4	10 1/2	6 3/4														9.0
2M	36		1 1/8	5/8	3/4	12	1	4 1/4	5	6	3/4	10 1/2	6 3/4														9.0
3																											
4	48		2 1/4	3/4	1	15 1/2	1	6	6	8	1	14	9														16.0
5	48		2 1/4	3/4	1	15 1/2	1	6	6	8	1	14	9														16.0

COUNTY:

W6-3

HWY:

STANDARD SIGN W6-3

WISCONSIN DEPT OF TRANSPORTATION

APPROVED _/

Matthe R Rauch

For State Traffic Engineer

DATE 03/12/13 PLATE NO. W6-3.10

SHEET NO:


FILE NAME : C:\CAEFiles\Projects\tr_stdplate\W63.DGN

PROJECT NO:

PLOT DATE: 12-MAR-2013 14:11

PLOT BY: mscsja

PLOT SCALE: 6.202372:1.000000

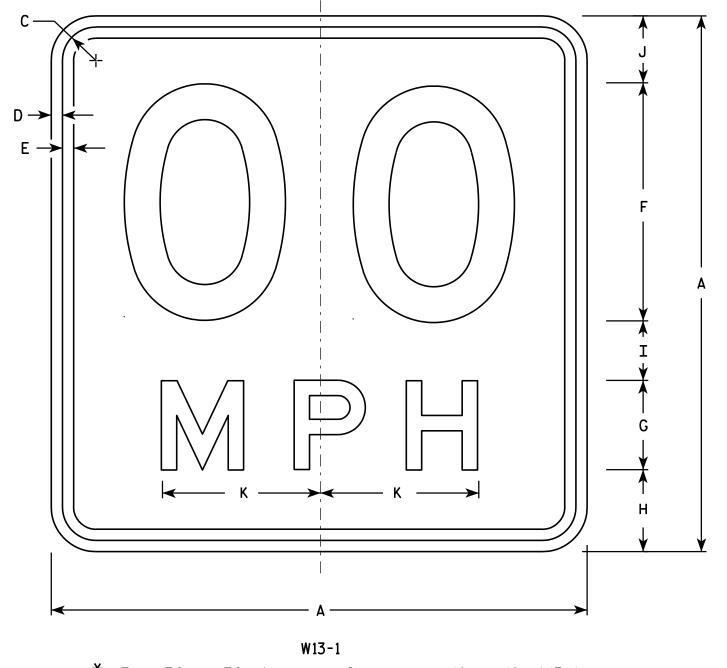

- 1. Sign is Type II Type F Reflective reference WIS DOT Standard Specification for HIGHWAY and STRUCTURE CONSTRUCTION latest edition.
- 2. Color:

Background - Yellow Message - Black

- 3. Message Series See Note 6
- 4. Corners may be square or rounded when base material is plywood but borders shall be rounded as shown. When base material is metal, the corners and borders shall be rounded.
- 5. Substitute appropriate numerals and optically space about centerline to achieve proper balance.
- 6. Line 1 is Series D Line 2 is Series E

* For 30" \times 30" Warning Signs, use 18" \times 18" W13-1 signs. For 36" \times 36" Warning Signs, use 24" \times 24" W13-1 signs.

SIZE	A	В	С	D	E	F	G	Н	I	J	K	L	М	N	0	Р	0	R	S	T	U	٧	W	X	Y	Z	Area sq. ft.
1	18		1 1/8	3∕8	3/8	8	3	2 3/4	2	2 1/4	5 3/8																2.25
* 2S	18		1 1/8	3∕8	3/8	8	3	2 3/4	2	2 1/4	5 %																2.25
* 2M	18		1 1/8	3/8	3/8	8	3	2 3/4	2	2 1/4	5 3/8																2.25
3	24		1 1/8	3/8	1/2	10	4	4	2 3/4	3 1/4	6 5/8																4.00
4	36		1 1/8	5/8	3/4	16	6	5 1/2	4	4 1/2	10 %																9.00
5	36		1 5/8	5/8	3/4	16	6	5 1/2	4	4 1/2	10 %																9.00

STANDARD SIGN W13-1

WISCONSIN DEPT OF TRANSPORTATION

APPROVED

Matthew & Ram

 f_{or} State Traffic Engineer S1/12 PLATE NO. W13-1.16

DATE <u>5/31/12</u>

SHEET NO:


FILE NAME : C:\CAEFiles\Projects\tr_stdplate\W131.DGN

PLOT DATE: 31-MAY-2012 10:57

PLOT NAME :

PLOT BY: mscsja

PLOT SCALE: 3.225232:1.000000

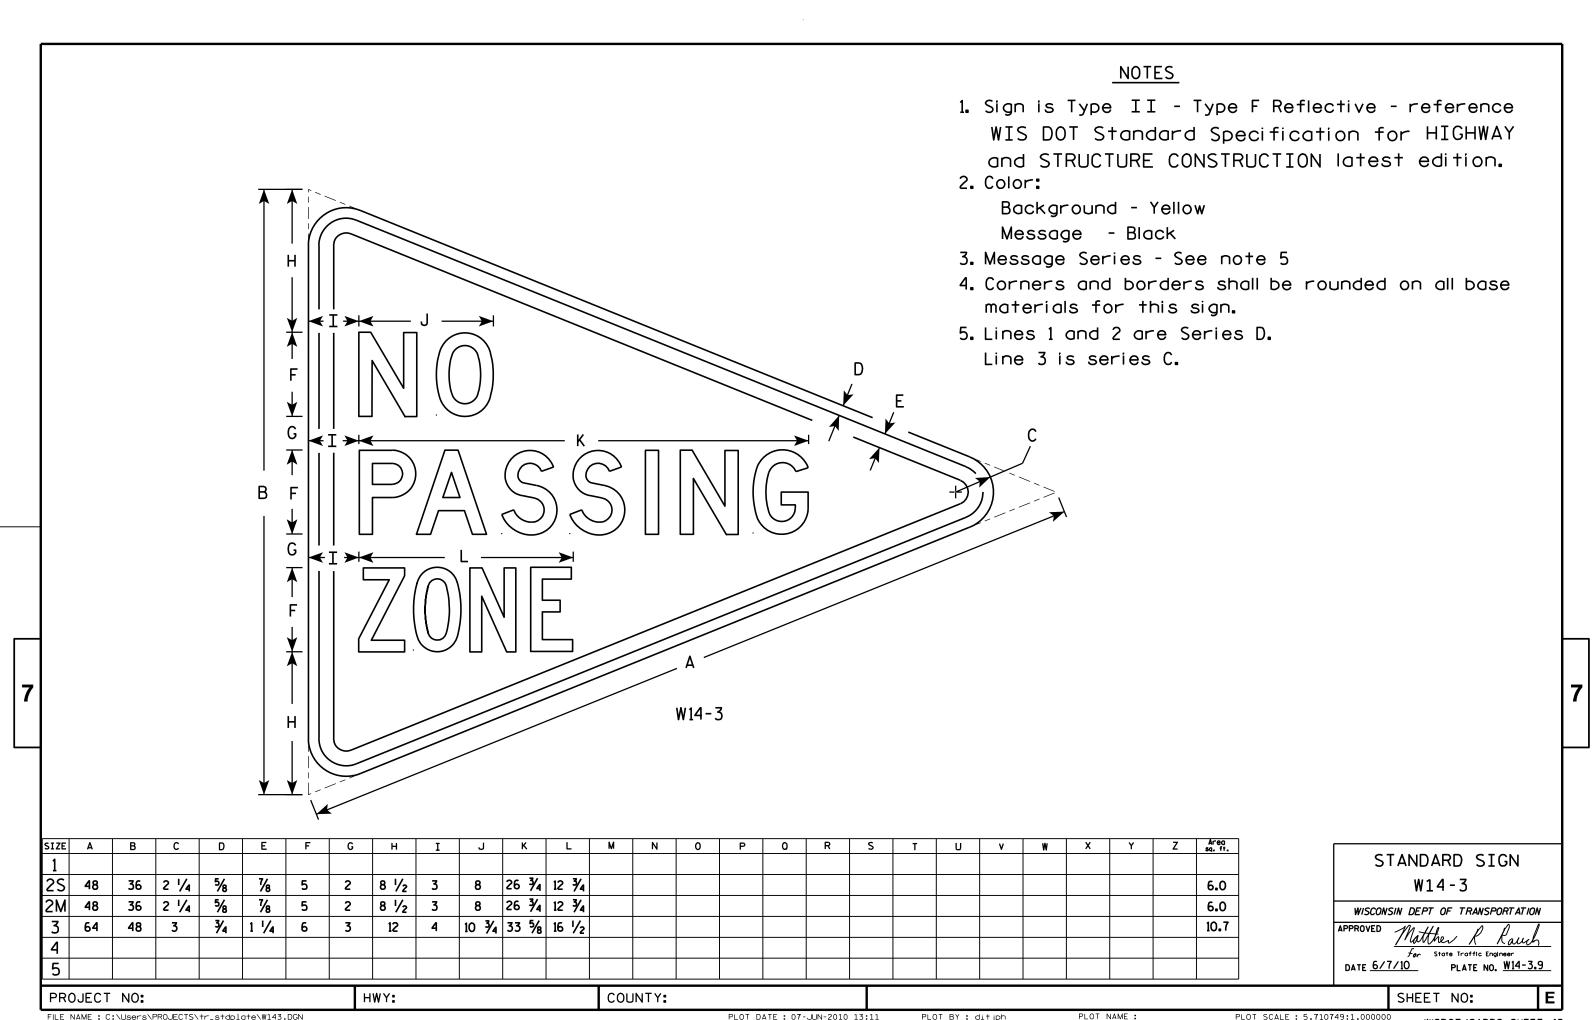

FILE NAME : C:\Users\PROJECTS\tr_stdplate\W143.DGN

PLOT DATE: 07-JUN-2010 13:11

PLOT BY: ditjph

PLOT SCALE: 5.710749:1.000000

Notes



Wisconsin Department of Transportation

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