MAD JUNE 2013 PROJE WITH: 9 3663-00-61 RO

ORDER OF SHEETS

Section No. 1

Section No. 2

Section No. 3

Section No. 3

Section No. 6

TOTAL SHEETS = 56

DESIGN DESIGNATION

CONVENTIONAL SYMBOLS

LIMITED HIGHWAY EASEMENT

PROPOSED OR NEW R/W LINE

EXISTING RIGHT OF WAY

CORPORATE LIMITS

PROPERTY LINE

SLOPE INTERCEPT

REFERENCE LINE

EXISTING CULVERT

PROPOSED CULVERT (Box or Pipe)

COMBUSTIBLE FLUIDS

WOODED OR SHRUÐ AREA

MARSH AREA

LOT LINE

A.A.D.T. (2010)

DESIGN SPEED

D.D.

A.A.D.T. (2030) DHV.

Title

Typical Sections and Details

Estimate of Quantities

Miscellaneous Quantitles

Standard Detail Drawings

STH 67

1.000

1,300

60/40 12.9

55 MPH 379,600

1//////

PROFILE

GRADE LINE

ORIGINAL GROUND

SPECIAL DITCH

UTILITIES

ELECTRIC

FIBER OPTIC

SANITARY SEWER

UTILITY PEDESTAL

TELEPHONE POLE

b

Ø

POWER POLE

STORM SEWER

TELEPHONE WATER

GRADE ELEVATION

	STATE	OF	WISCONSIN
DEPART	MENT	OF	TRANSPORTATION

PLAN OF PROPOSED IMPROVEMENT

STATE PROJECT	FEDERAL PR	OJECT
STATE PROJECT	PROJECT	CONTRACT
3663-00-61		_

END PROJECT

BELOIT - WALWORTH

STH 140 TO SALTBOX RD. **STH 67**

ROCK & WALWORTH COUNTY

STA. 367+50 STATE PROJECT NUMBER X=567645.06 3663-00-61 Y=205179.90 43 BEGIN PROJECT STA. 50+25 X=535931.73 Y=205443.59 (140) 01-N SHARON MISCONSIN MARSH OR ROCK PROFILE MISCONSIN (To be noted as such) ELINERS LUNOS CULVERT (Profile View) SHARON RO. -F0 ----R-15-E R-14-E LAYOUT SCALE L H TOTAL NET LENGTH OF CENTERLINE = 6.01 MI.

ORIGINAL PLANS PREPARED BY CONSULTING **ENGINEERS SCIENTISTS** & LAND SURVEYORS Bollinger, Lach & Associates, Inc. N 1977 SCHAITEL ROAD - UNIT 300 LAKE GENEVA, WI 53147 P(262) 249-0900 F(262) 249-5670 www.bollingerlo SCONSIA CYNTHIA R. **FLOWER** E-38446 LAKE GENEVA. STATE OF WISCONSIN DEPARTMENT OF TRANSPORTATION REPARED BY BOLLINGER, LACH & ASSOCIATES BOLLINGER, LACH & ASSOCIATES les çner Regional Supervisor ___ORIS_HOSSES CO. Exeminer

"COORDINATES ON THIS PLAN ARE REFERENCED TO THE WISCONSIN COUNTY COORDINATE SYSTEM (WCCS), 'ROCK' COUNTY,

ALLIANT ENERGY (ELECTRICITY)
JASON HOGAN
SUITE 1000
4902 N. Baltimore Lane
MADISON, WI 53718
p: 608-458-4871
iasonhogan@alliantenergy.com

BERGEN/SHARON TELEPHONE COMPANY-COMMUNCATION LINE BRAD ELLEFSON/JOHN COWGER
105 PLAIN ST.
P.O. BOX 400
SHARON, WI 53585-0400
p: 262-736-9981
bellef@elknet.net
P: 262-215-6206
john@sharontelephone.com

VILLAGE OF SHARON KEVIN DAY P.O. BOX 379 SHARON, WI 53589 p: 262-736-4888 info@villageofsharon.com

We ENERGIES - GAS/PETROLEUM DAN SANDE 333 W. EVERETT ST, A299 MILWAUKEE, WI 53203 p: 414-221-4578 Dan.Sande@we-energies.com

Rock Energy Coop Lynn Maier Janesville, WI 53545 P: 608-752-4550 lynnm@rock.coop

GENERAL NOTES

HMA PAVEMENT WEIGHT CALCULATIONS ARE BASED ON 112 LB/SY/IN

12.5 mm MIX GRADATION TO BE USED IN BOTH SCRATCH AND UPPER LAYERS.

THE CONTRACTOR'S PAVING OPERATIONS SHALL BE CONSISTENT WITH THE PLAN TYPICAL SECTIONS AND CONSTRUCTED TO PREVENT HMA LONGITUDINAL JOINTS FROM BEING LOCATED WITHIN A DRIVING, TURNING, PASSING OR PARKING LANE.

ALL CONSTRUCTION SHALL BE DONE IN ACCORDANCE WITH THE "STATE OF WISCONSIN STANDARD SPECIFICATIONS FOR HIGHWAY AND STRUCTURE CONSTRUCTION" CURRENT EDITION, THE DETAILS IN THE PLANS, AND THE SPECIAL PROVISIONS INCLUDED IN THE CONTRACT DOCUMENTS.

PRIOR TO THE INSTALLATION OF TRAFFIC CONTROL DEVICES THE CONTRACTOR SHALL PROVIDE THE ENGINEER AND THE STATE HIGHWAY PATROL WITH THE NAME AND TELEPHONE NUMBER OF A LOCAL PERSON RESPONSIBLE FOR THE EMERGENCY MAINTENANCE OF TRAFFIC CONTROL.

THE EXACT LOCATION AND SPACING OF ALL SIGNS AND TRAFFIC CONTROL DEVICES SHALL BE ADJUSTED TO FIT FIELD CONDITIONS AS APPROVED BY THE ENGINEER.

THE CONTRACTOR SHALL PLACE ALL TRAFFIC CONTROL SIGNS IN ADVANCE OF THE PROJECT TERMINI BEFORE BEGINNING ANY WORK ON THE ROADWAY. THESE SIGNS SHALL REMAIN IN PLACE UNTIL ALL WORK IS COMPLETED AND PERMANENT SIGNING IS IN PLACE.

ALL EXISTING SIGNS SHALL REMAIN IN PLACE UNTIL PROPOSED SIGNS ARE INSTALLED UNLESS THE ENGINEER APPROVES THEIR REMOVAL.

THE LOCATION OF STOP LINES SHALL BE DETERMINED IN THE FIELD BY THE ENGINEER.

FLAGGERS SHALL BE IN SIGHT OF EACH OTHER OR IN DIRECT COMMUNICATION AT ALL TIMES. THEY SHALL BE EQUIPPED WITH STOP/SLOW PADDLES FASTENED ON SUPPORT STAFFS. WHEN THE FLAGGING OPERATION IS NOT IN EFFECT, ALL SIGNS RELATING TO THE OPERATION SHALL BE COVERED OR REMOVED AND FACILITY RESTORED TO NORMAL OPERATION.

THE EXACT LOCATION AND LIMITS OF PRIVATE ENTRANCES AND FIELD ENTRANCES SHALL BE DETERMINED BY THE ENGINEER IN THE FIELD.

WHEN THE QUANTITY OF THE ITEM OF AGGREGATE BASE DENSE IS MEASURED BY PAYMENT OF THE TON, THE DEPTH OR THICKNESS OF THE COURSE IS APPROXIMATE AND THE ACTUAL THICKNESS WILL DEPEND ON DISTRIBUTION OF MATERIAL AS DIRECTED BY THE ENGINEER.

REMOVE AND REPLACE ALL SIGNS AND POSTS WITH THE NEW SIGNS AND POSTS IN THE SAME GENERAL LOCATION UNLESS OTHERWISE NOTED IN THE PLANS.

THERE ARE UTILITY FACILITIES WITHIN THE PROJECT LIMITS THAT MAY NEED TO BE RELOCATED. THE CONTRACTOR SHALL COORDINATE CONSTRUCTION ACTIVITIES WITH A CALL TO DIGGERS HOTLINE AND A DIRECT CALL TO THE UTILITIES THAT HAVE FACILITIES IN THE AREA. NOT ALL UTILITIES ARE MEMBERS OF DIGGERS HOTLINE.

CONTRACTOR SHALL VERIFY LOCATION OF EXISTING UTILITIES IN THE PROJECT AREA PRIOR TO CONSTRUCTION.

NO TREES OR SHRUBS ARE TO BE REMOVED WITHOUT THE APPROVAL OF THE ENGINEER.

TRAFFIC CONTROL DEVICES SHALL BE ADJUSTED TO FIT FIELD CONDITIONS AS DIRECTED BY THE ENGINEER.

A SAWED JOINT IS REQUIRED WHERE NEW HMA PAVEMENT MEETS EXISTING PAVEMENT.

CONTRACTOR IS RESPONSIBLE FOR RESHAPING AND FINISHING ANY PREVIOUSLY GRASSED AREAS WHICH ARE DISTURBED BY CONSTRUCTION OPERATIONS OUTSIDE THE NORMAL CONSTRUCTION LIMITS.

LOCAL CONTACTS

DESIGN CONTACT

BOLLINGER, LACH & ASSOCIATES, INC. CINDY FLOWER, P.E. N 1977 SCHAITEL RD. - UNIT 300 LAKE GENEVA, WI 53147 p: 262-249-0900 C: 262-378-2200 cflower@bollingerlach.com

WDN

AMANDA CUSHMAN
DNR SOUTH REGION HO.
3911 FISH HATCHERY ROAD
FITCHBURG, WI 53711
amanda.cushman@dnr.wi.gov

PLOT NAME : _____

WISDOT CONTACT

WISCONSIN DEPARTMENT OF TRANSPORTATION
WISDOT SOUTHWEST REGION
WILLIAM STROBEL
2101 WRIGHT ST.
MADISON, WI 53704
p: 608-242-8009
william1.strobel@dot.wi.gov

<u>ACOE</u>

STACY MARSHALL
U.S. ARMY CORPS OF ENGINEERS
20711 WATERTOWN ROAD, SUITE F
WAUKESHA, WI 53186
P: 262-717-9540, EXT. 5
stacy.l.marshall@usace.army.mil



Call 811 3 Work Days Before You Dig Or Toll Free (800) 242-8511 Hearing Impaired TDD (800) 542-2289 www.DiggersHotline.com

__PLOT SCALE : N.T.S

PROJECT NO: 3663-00-61

HWY:STH 67


COUNTY: ROCK & WALWORTH


GENERAL NOTES

SHEET

2

Ε

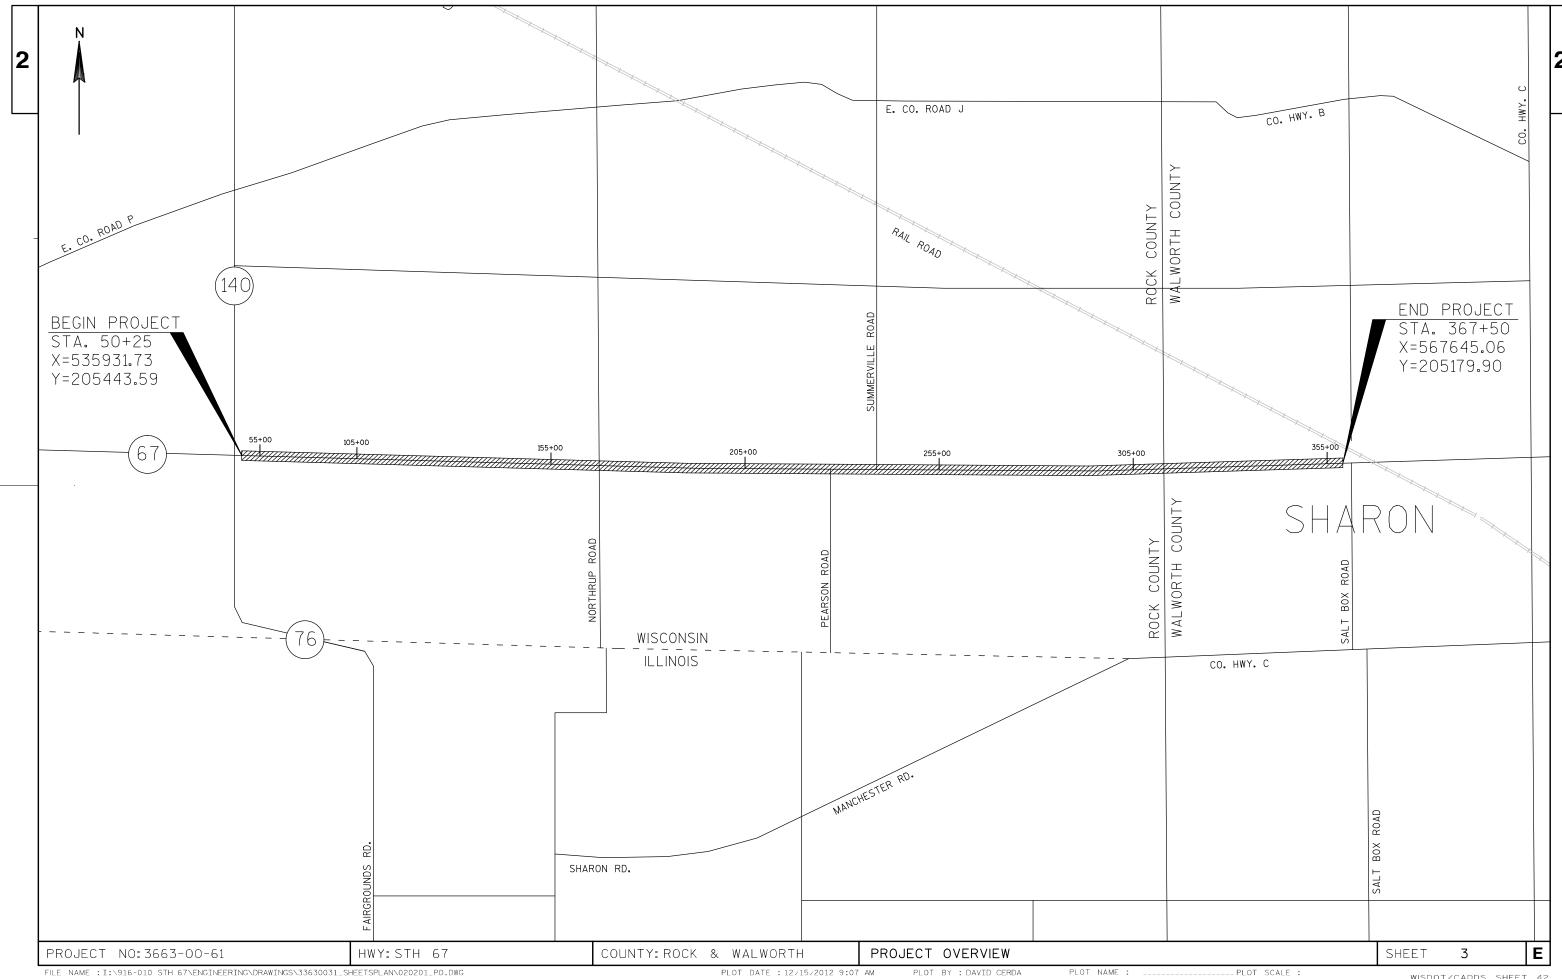


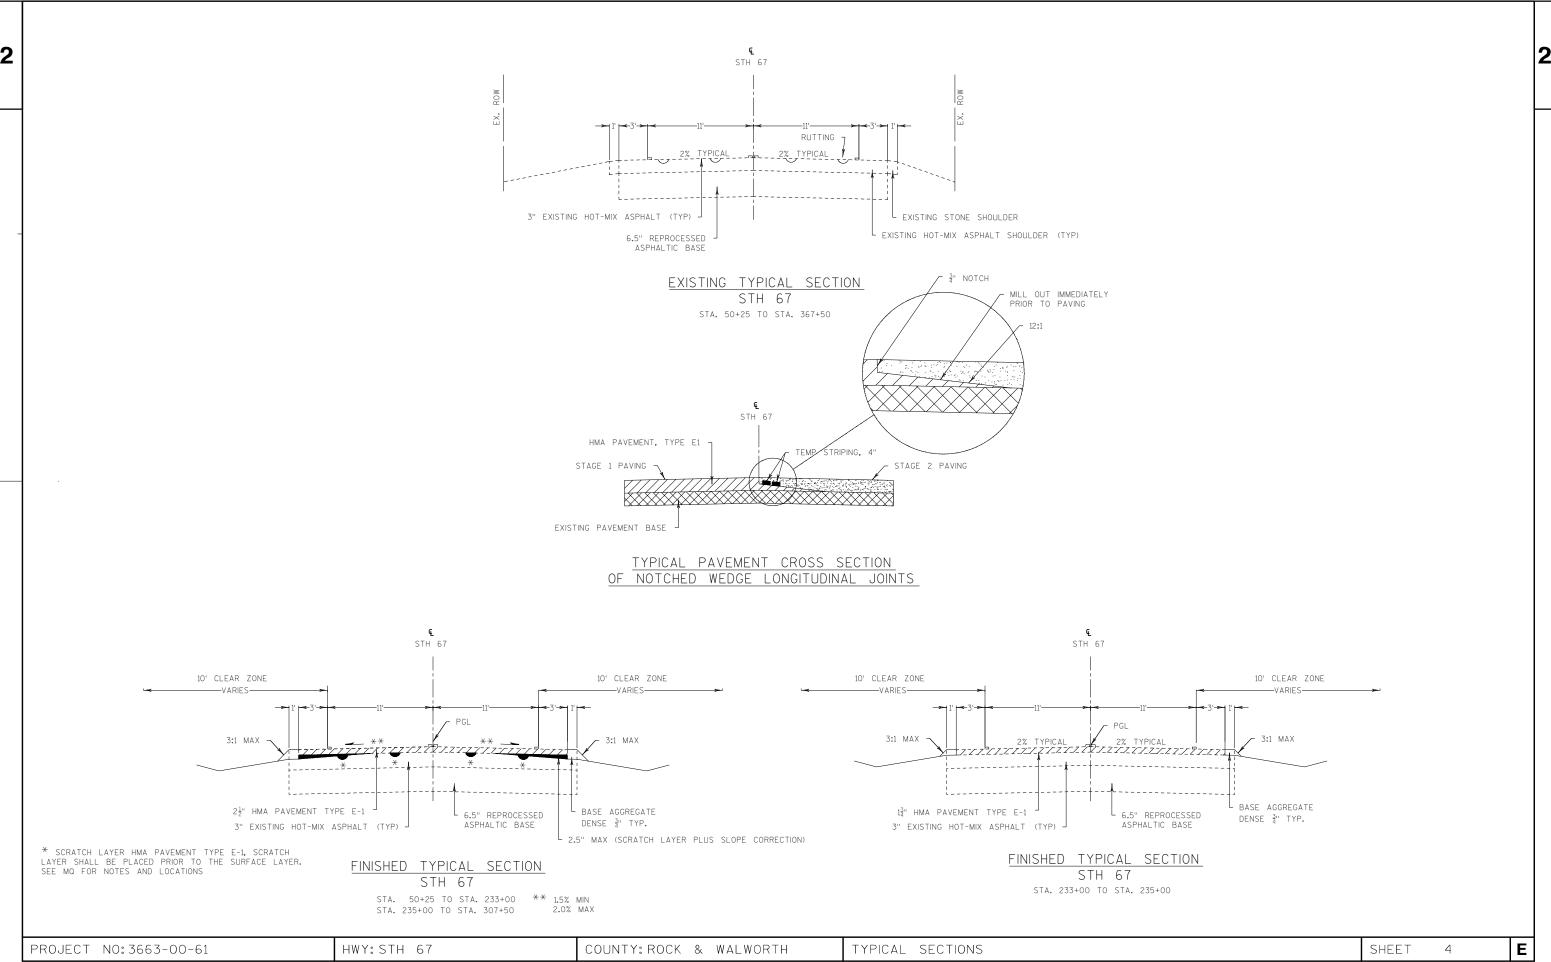



20' SIDE ROADS 75' MAINLINE _2½" MILL REMOVE AT TERMINI TAPER FROM $\frac{1}{4}$ " TO $2\frac{1}{2}$ " -----2 ½" HMA PAVEMENT TYPE E-1

REMOVE ASPHALTIC SURFACE BUTT JOINTS

BUTT JOINT DETAIL

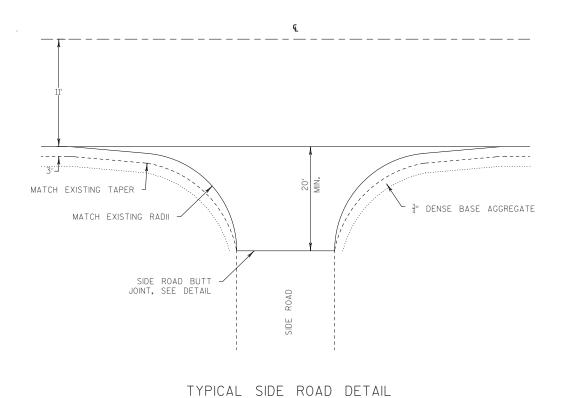


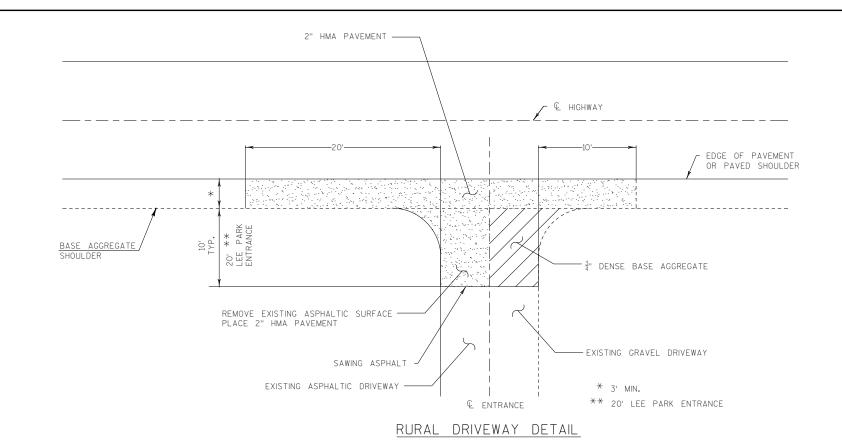

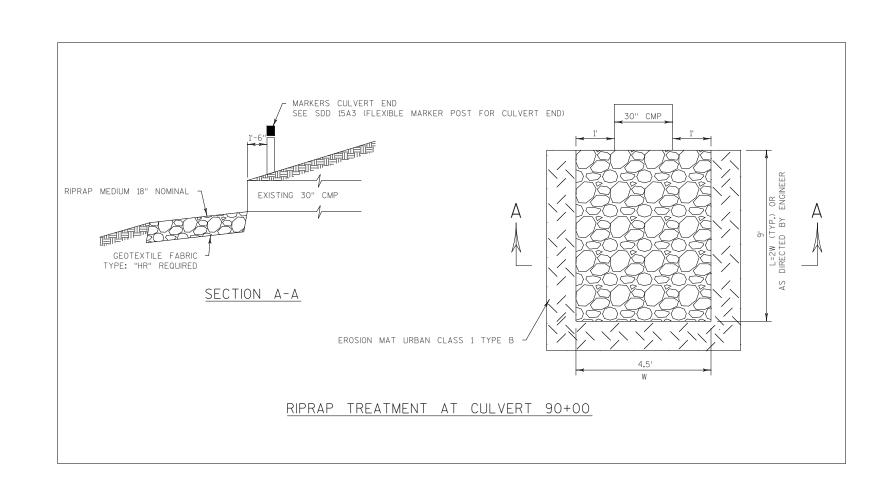


COUNTY: ROCK & WALWORTH

SHEET

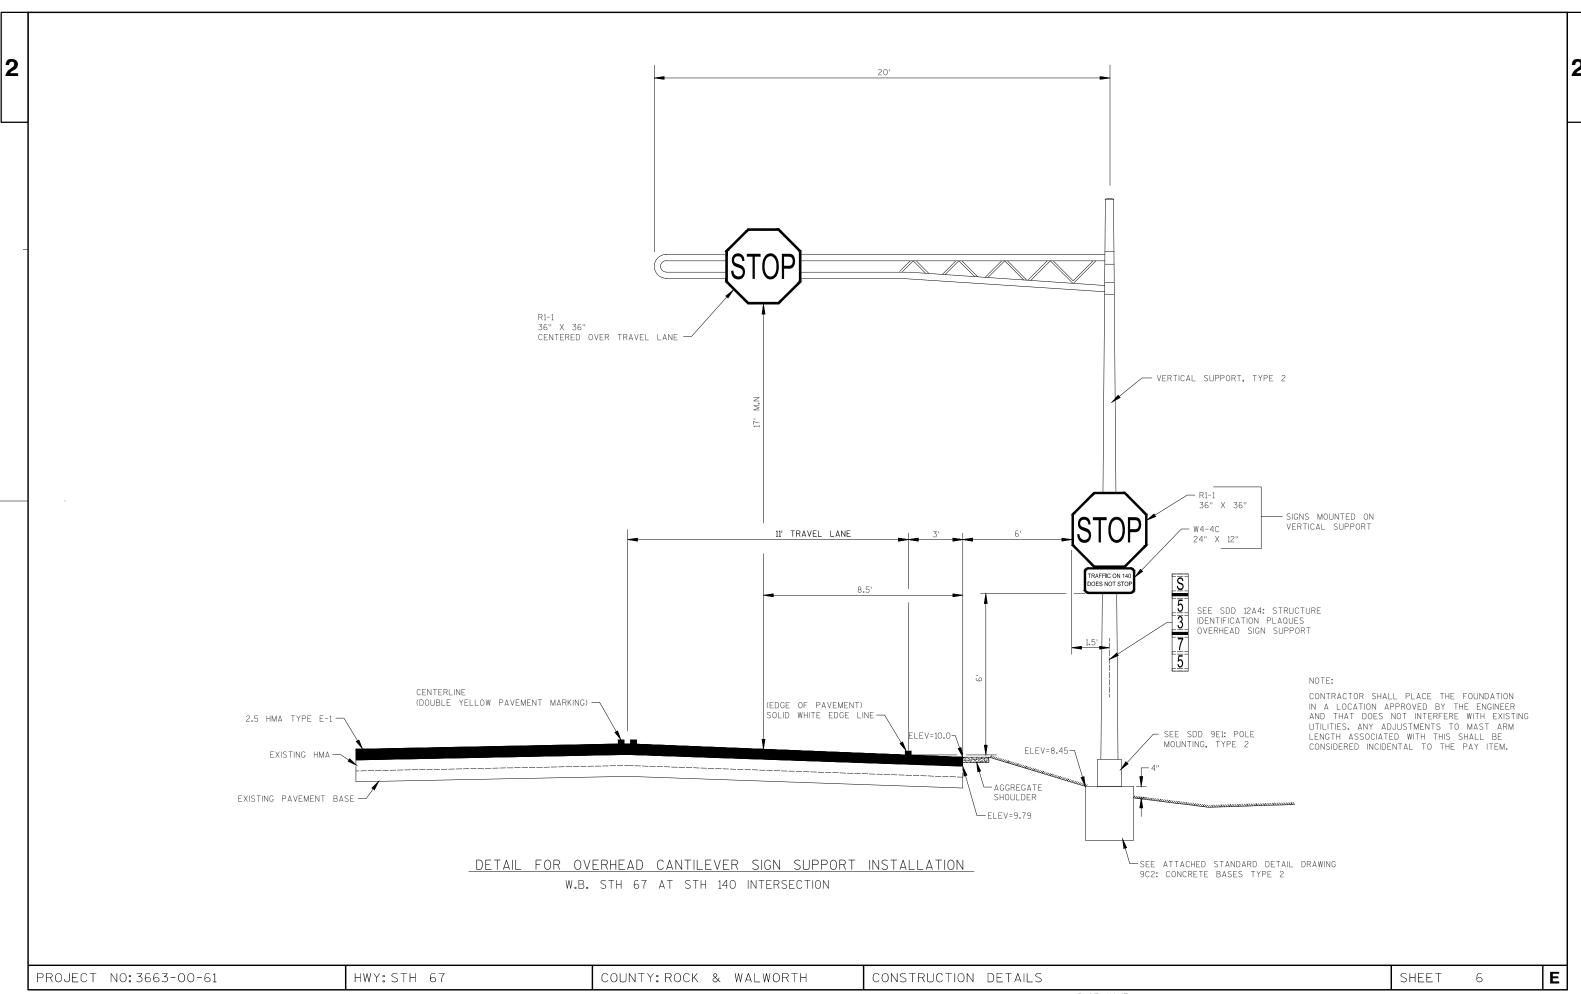



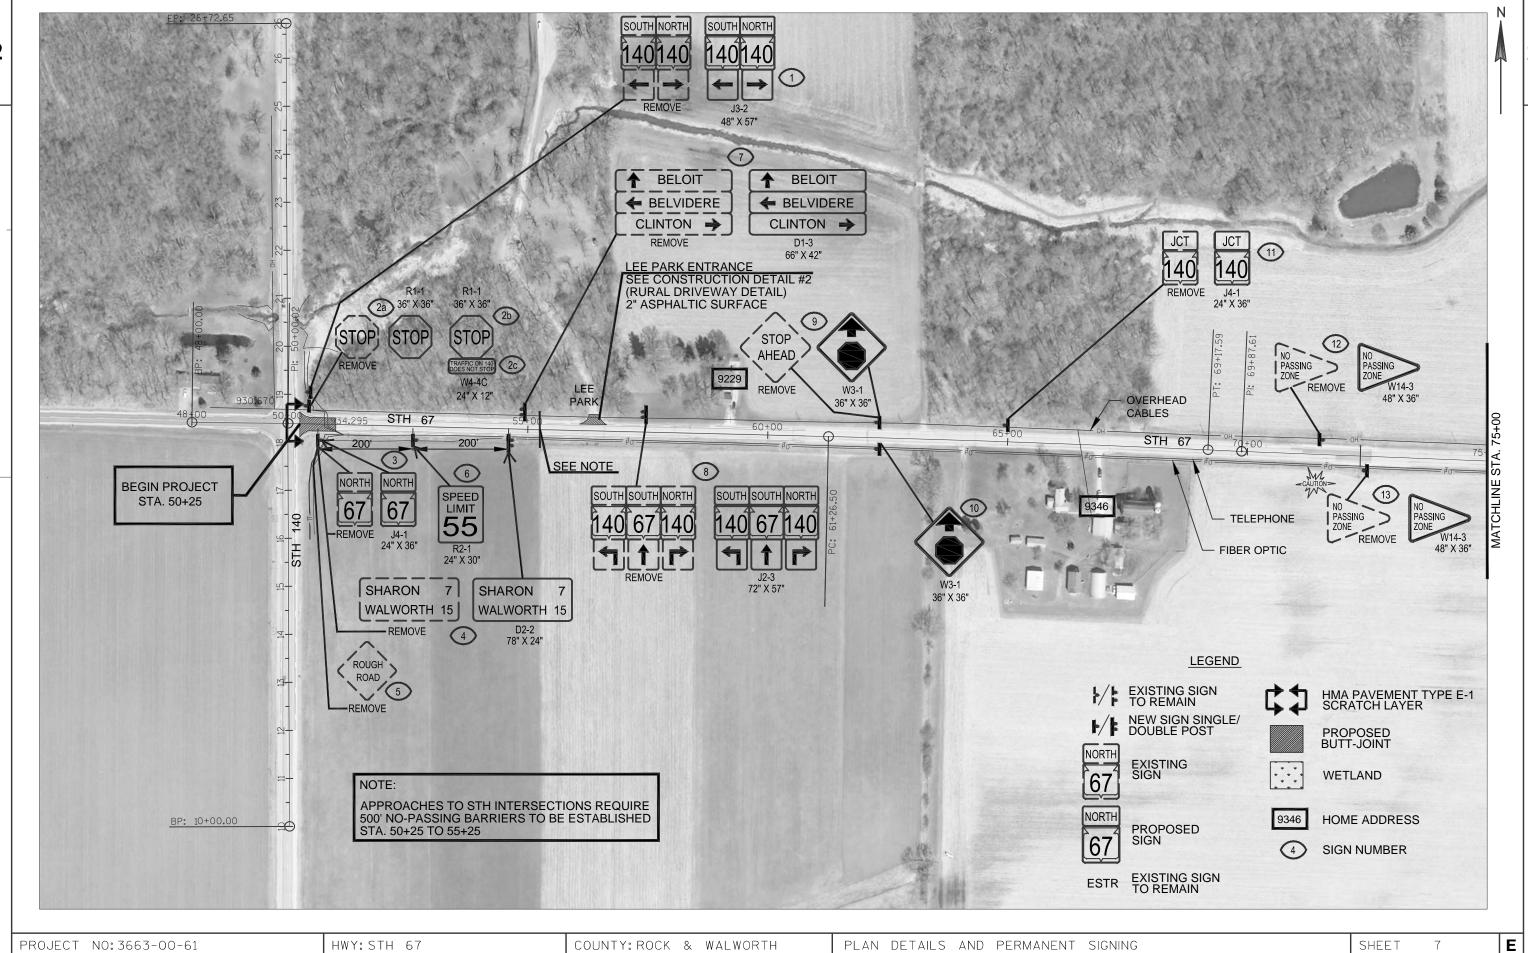


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PLOT DATE : 12/15/2012 9:07 AM

PLOT BY : DAVID CERDA

PLOT NAME : _____PLOT SCALE :



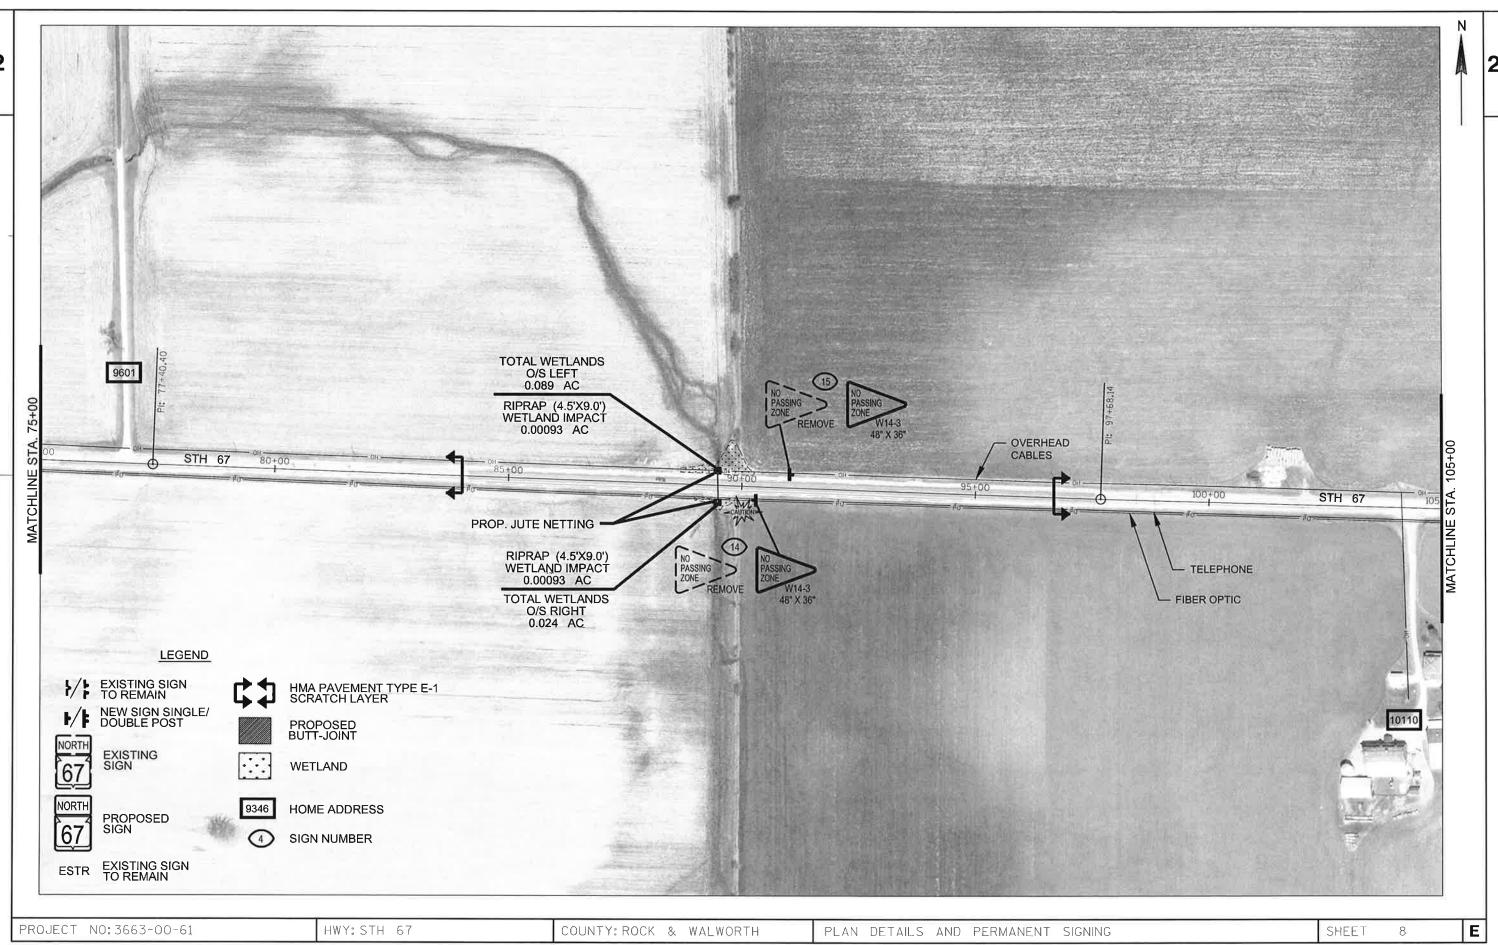


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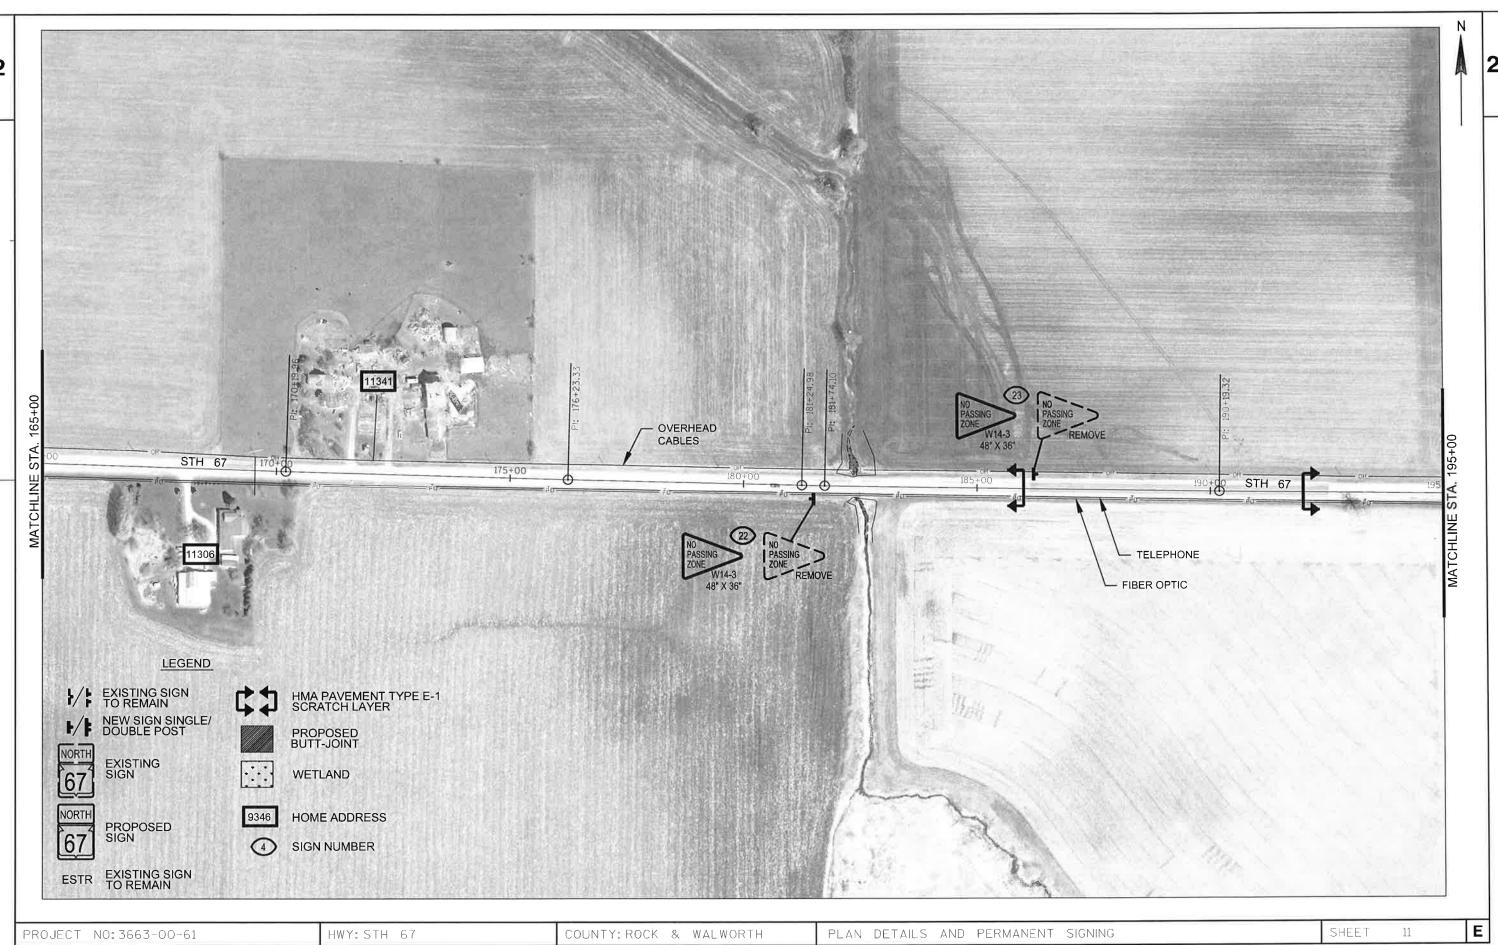
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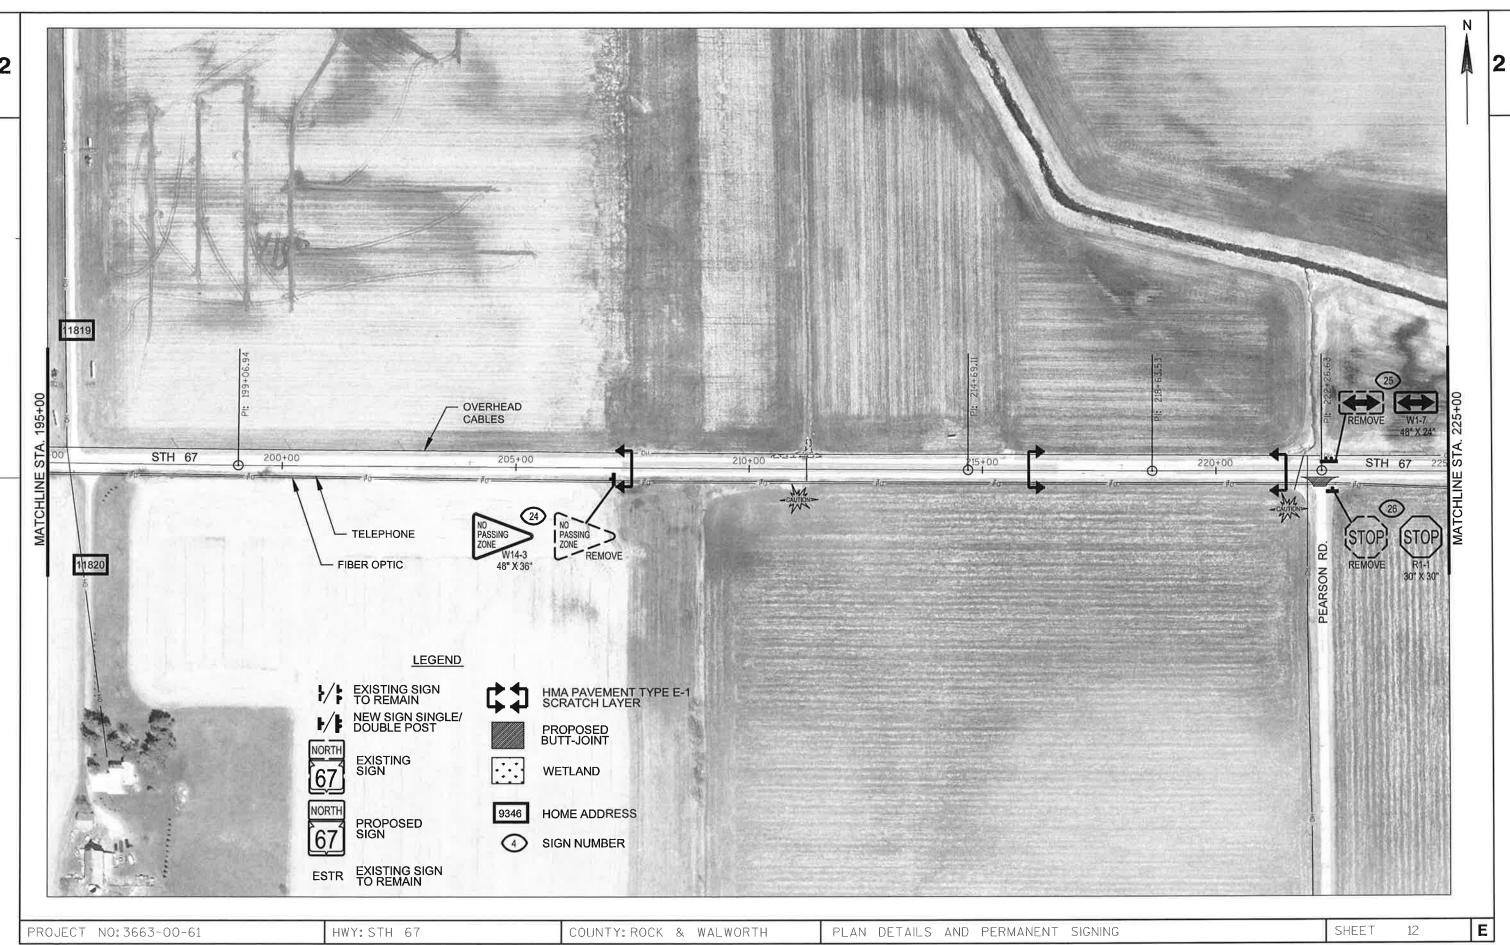
PLOT BY : DAVE BOTTCHER

PLOT NAME : _____PLOT SCALE :









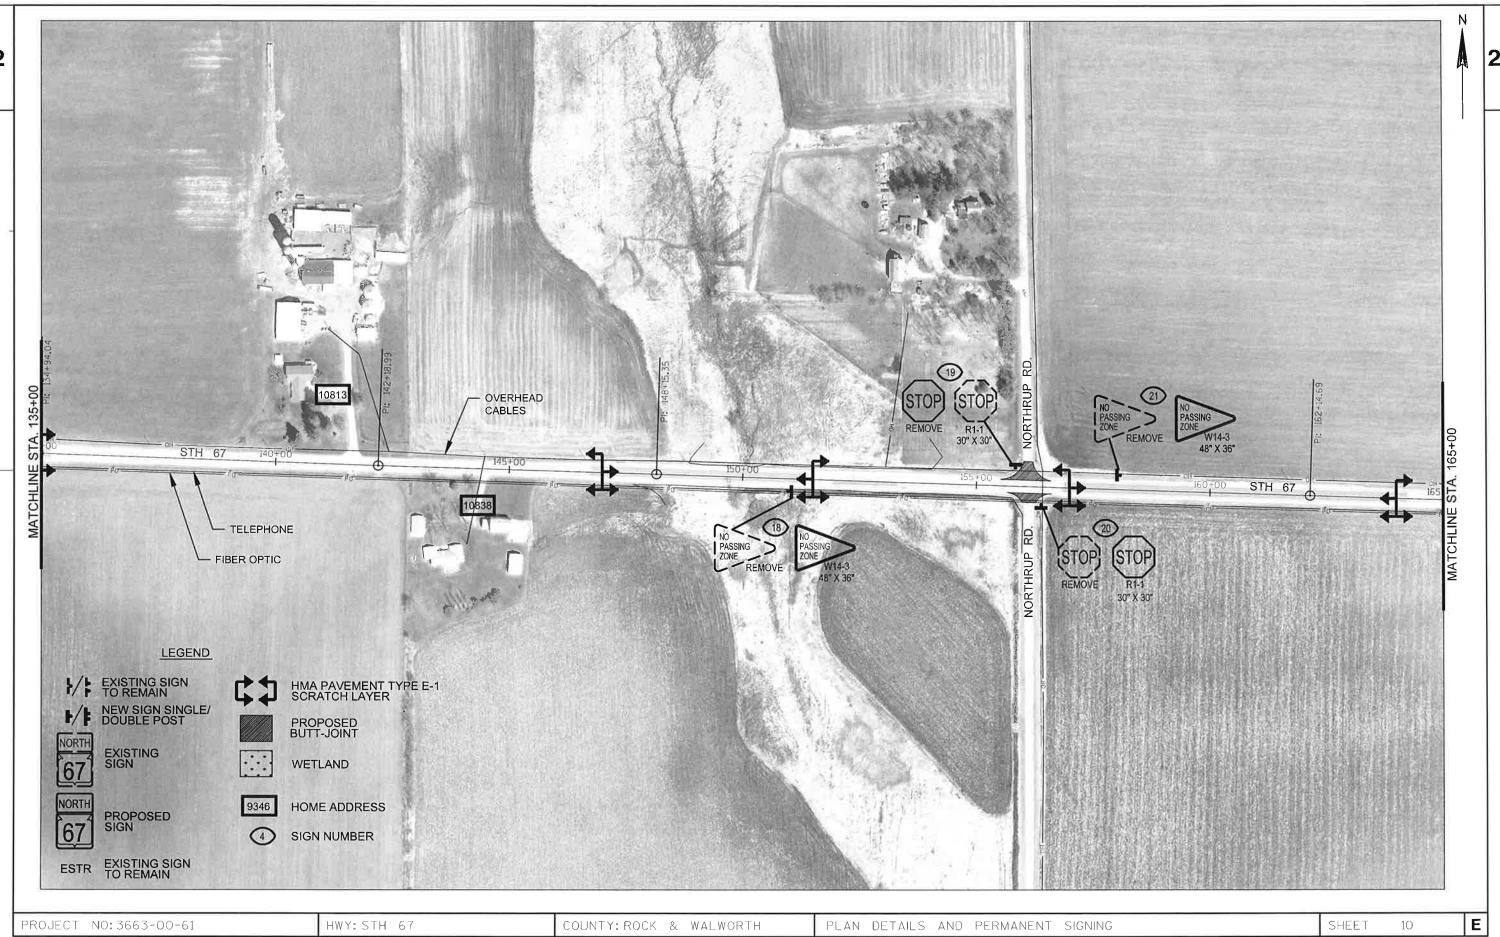





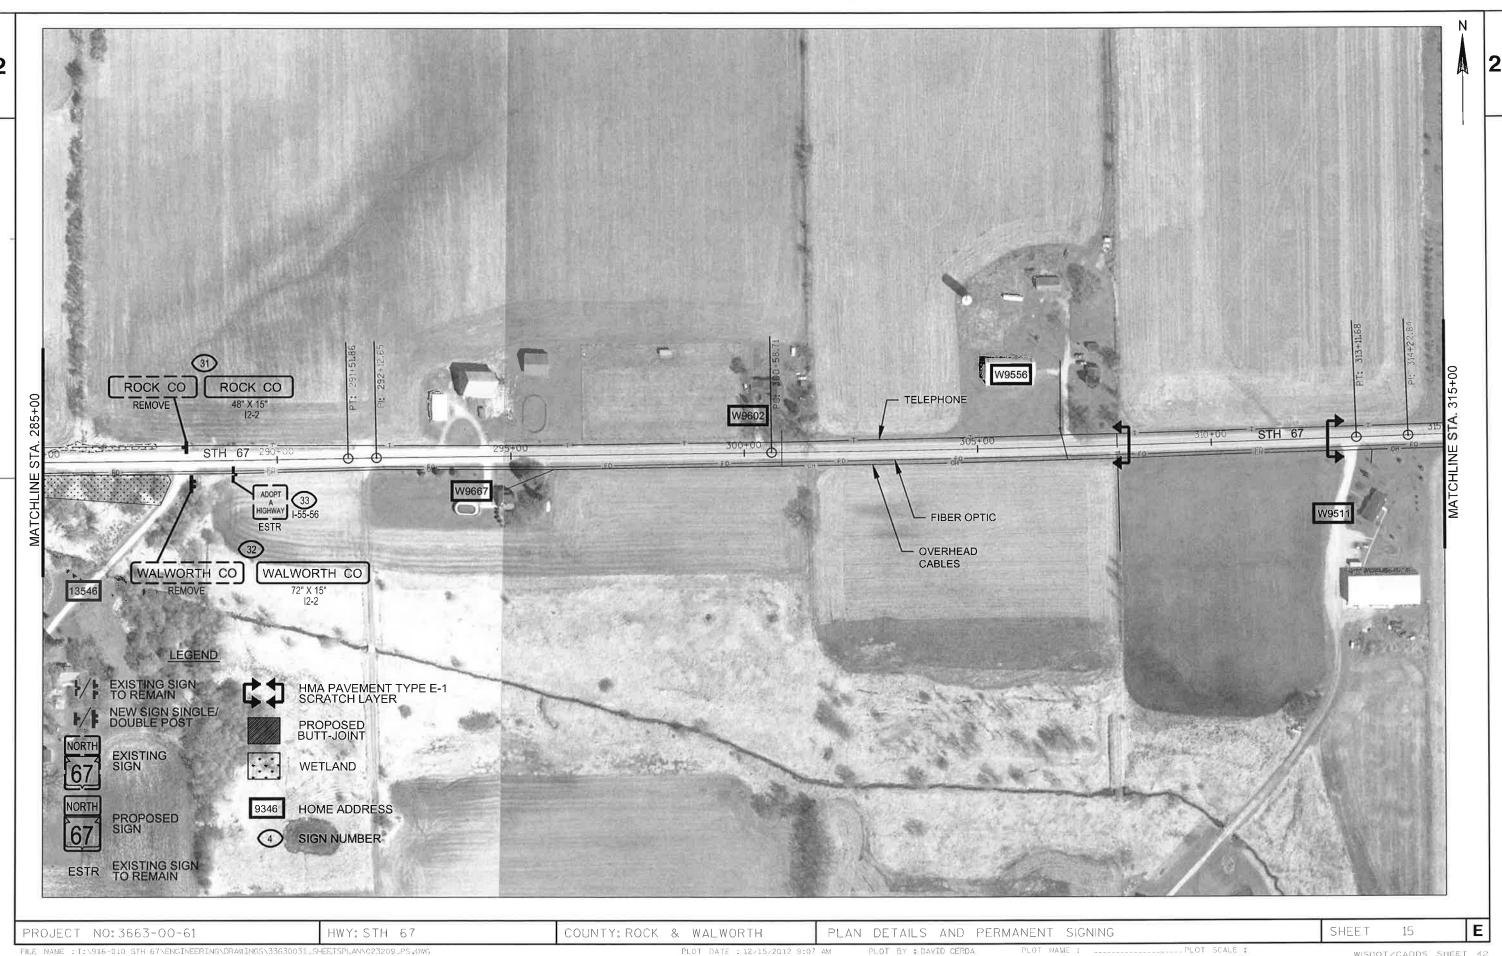

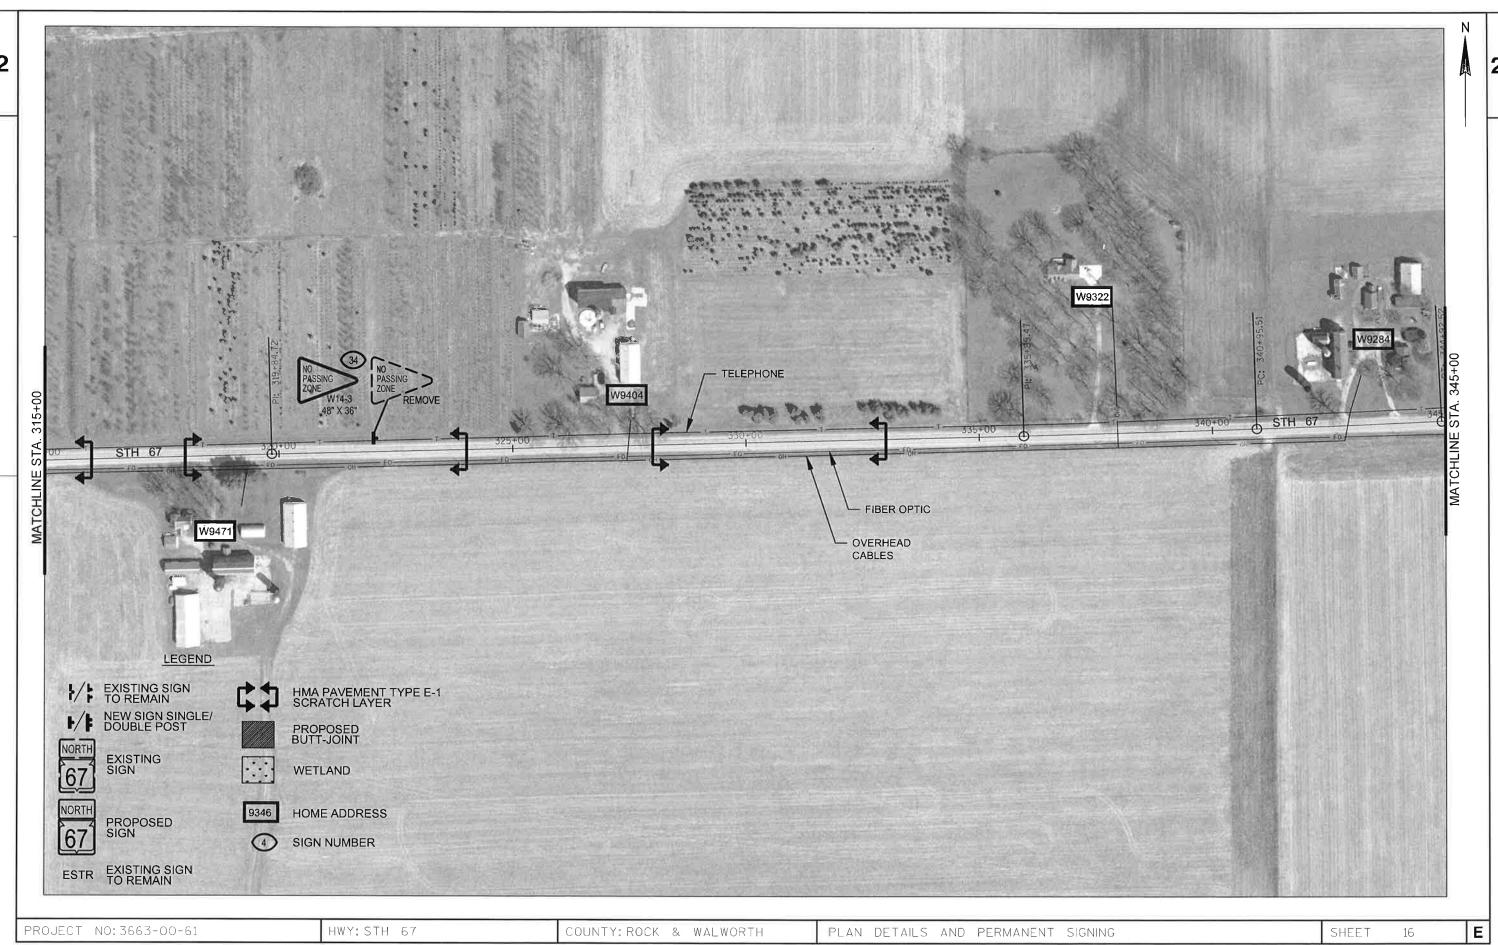




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PLOT DATE : 12/15/2012 9:07 AM

PLOT BY : DAVE BOTTCHER

PLOT NAME : _____PLOT SCALE :

WISDOT/CADDS SHEET 42

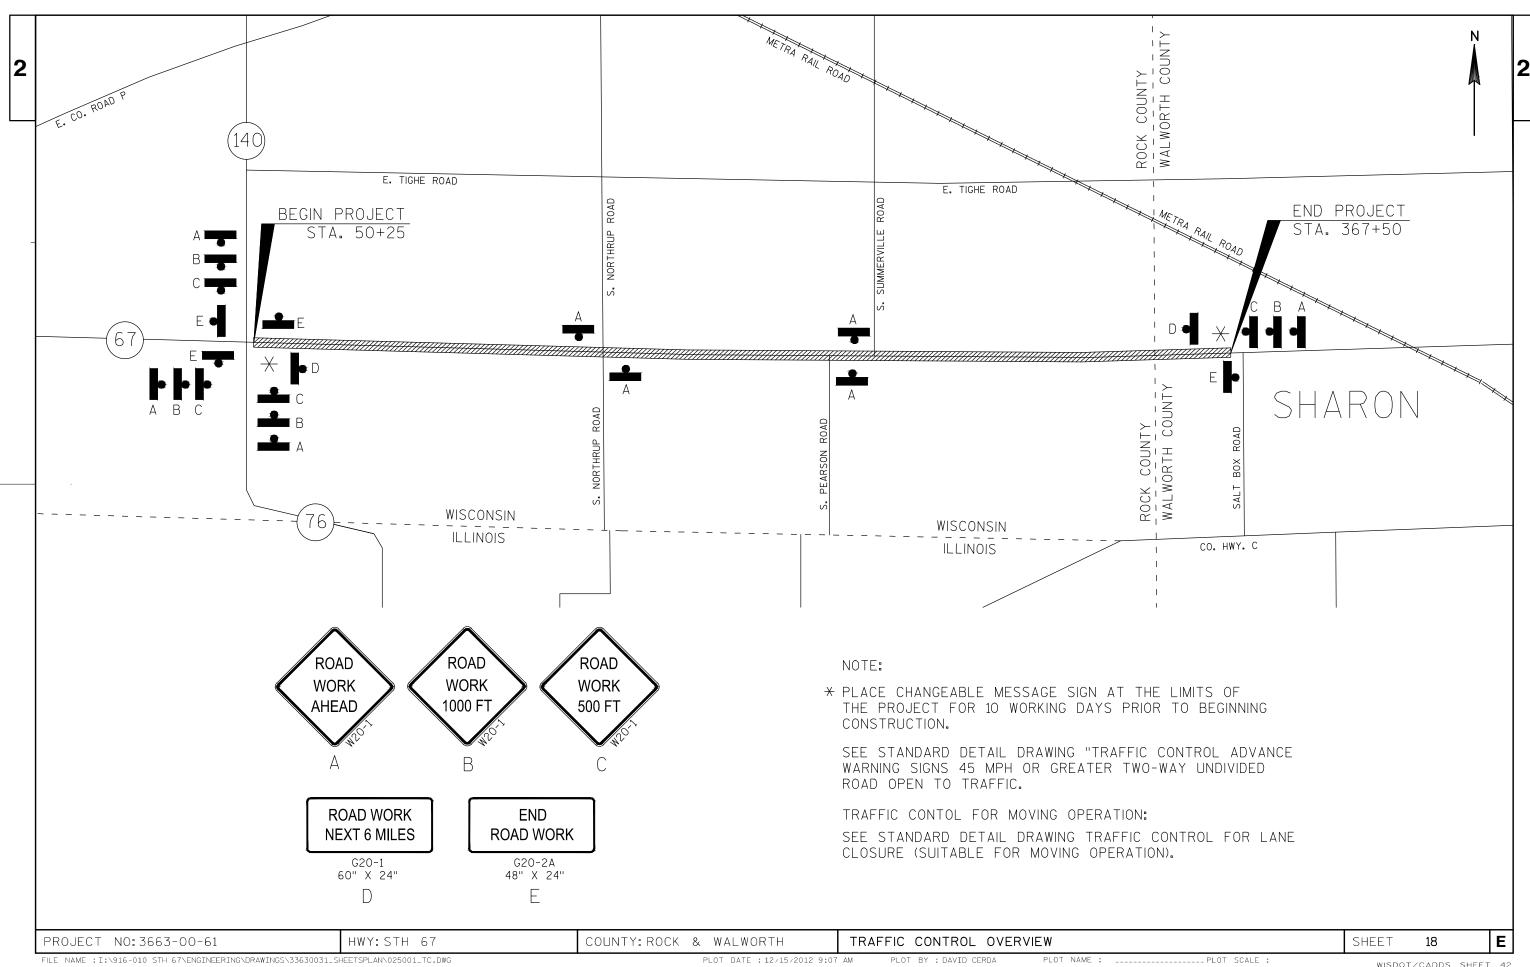

DATE 27	MAR13	EST	IMAT	E O F Q U A N	
LI NE NUMBER	ITEM	ITEM DESCRIPTION	UNI T	TOTAL	3663-00-61 QUANTI TY
0010	204. 0115	REMOVING ASPHALTIC SURFACE BUTT JOINTS	SY	1, 020. 000	1, 020. 000
0020	213. 0100	FINISHING ROADWAY (PROJECT) 01. 3663-00-61	EACH	1. 000	1. 000
0030	305.0110	BASE AGGREGATE DENSE 3/4-INCH	TON	2,000.000	2,000.000
0040		INCENTIVE IRI RIDE	DOL	24, 040. 000	24, 040. 000
0050	455. 0140	ASPHALTIC MATERIAL PG64-28P	TON	980. 000	980. 000
0060	455. 0605	TACK COAT	GAL	4, 200. 000	4, 200. 000
0070	460. 1101	HMA PAVEMENT TYPE E-1	TON	17, 850. 000	17, 850. 000
0800	460. 2000	INCENTIVE DENSITY HMA PAVEMENT	DOL	11, 430. 000	11, 430. 000
0090	606. 0200	RI PRAP MEDI UM	CY	5. 000	5. 000
0100	618. 0100	MAINTENANCE AND REPAIR OF HAUL ROADS (PROJECT) 01.3663-00-61	EACH	1. 000	1. 000
0110	619. 1000	MOBI LI ZATI ON	EACH	1. 000	1. 000
0120	628. 1905	MOBILIZATIONS EROSION CONTROL	EACH	1. 000	1. 000
0130	628. 1910	MOBILIZATIONS EMERGENCY EROSION CONTROL	EACH	1. 000	1. 000
0140	628. 2008	EROSION MAT URBAN CLASS I TYPE B	SY	70.000	70.000
0150	633. 5200	MARKERS CULVERT END	EACH	2. 000	2. 000
0160	634. 0612	POSTS WOOD 4X6-INCH X 12-FT	EACH	1. 000	1. 000
0170	634. 0614	POSTS WOOD 4X6-INCH X 14-FT	EACH	7. 000	7. 000
0180	634. 0616	POSTS WOOD 4X6-INCH X 16-FT	EACH	26. 000	26. 000
0190	634. 0618	POSTS WOOD 4X6-INCH X 18-FT	EACH	5. 000	5. 000
0200	637. 0202	SIGNS REFLECTIVE TYPE II	SF	293. 320	293. 320
0210	638. 2602	REMOVING SIGNS TYPE II	EACH	36. 000	36.000
0220	638. 3000	REMOVING SMALL SIGN SUPPORTS	EACH	40.000	40.000
0230	642. 5001	FIELD OFFICE TYPE B	EACH	1. 000	1. 000
0240	643. 0100	TRAFFIC CONTROL (PROJECT) 01.3663-00-61	EACH	1.000	1.000
0250	643. 0900	TRAFFIC CONTROL SIGNS	DAY	1, 188. 000	1, 188. 000
0260	643. 1050	TRAFFIC CONTROL SIGNS PCMS	DAY	136.000	136.000
0270	645. 0120	GEOTEXTILE FABRIC TYPE HR	SY	9.000	9.000
0280 0290	646. 0106	PAVEMENT MARKING EPOXY 4-INCH PAVEMENT MARKING SAME DAY EPOXY 4-INCH	LF LF	63, 450. 000	63, 450. 000
0300	646. 0406 647. 0566	PAVEMENT MARKING SAME DAY EPOXY 4-INCH PAVEMENT MARKING STOP LINE EPOXY 18-INCH		30, 750. 000 55. 000	30, 750. 000 55. 000
0310	648. 0100	LOCATING NO-PASSING ZONES	MI	6. 010	6. 010
0320 0330	649. 0100 649. 1100	TEMPORARY PAVEMENT MARKING 4-INCH TEMPORARY PAVEMENT MARKING STOP LINE	LF LF	42, 400. 000 55. 000	42, 400. 000 55. 000
		18-I NCH			
0340	654. 0102	CONCRETE BASES TYPE 2	EACH	1.000	1.000
0350	657. 0255	TRANSFORMER BASES BREAKAWAY 11 1/2-INCH BOLT CIRCLE	EACH	1. 000	1. 000
0360	657. 0305	POLES TYPE 2	EACH	1. 000	1. 000
0360	657. 0305 657. 0590	TROMBONE ARMS 20-FT	EACH	1. 000	1. 000
0370	690. 0150	SAWING ASPHALT	LF	200. 000	200. 000
0390	SPV. 0090	SPECIAL 01. REMOVING HMA PAVEMENT	LF	31, 725. 000	31, 725. 000
		NOTCHED WEDGE LONGITUDINAL JOINT MILLING			•

<u>REMOVAL ITEMS</u>						
(204.01 REMOVING ASPHA BUTT JO	(690.0150) SAWING ASPHALT					
LOCATION	(SY)	(LF)				
50+25 TO 51+00	255	76				
N. NORTHRUP	190	24				
S. NORTHRUP	105	24				
S. PEARSON	95	24				
N. SUMMERVILLE	140	24				
366+75 TO 367+50	235	28				
TOTAL	1,020	200				

BASE AGGRE	GATE DENSE	3/4 - INCH
STATION	LOCATION	305.0110 BASE AGGREGATE DENSE 3/4-INCH (TON)
50+25 TO 367+50	LT	750
50+25 TO 367+50	RT	750
DRIVEWAYS		500
	TOTA	AL 2,000

			HMA PAVEME	ENT ITEMS		
	(440.4410.S)	(455.0140)	(455.0605)	(460.1101)	(460.2000)	(SPV.0090.01)
	INCENTIVE DENSITY	ASPHALTIC MATERIAL	TACK	HMA PAVEMENT	INCENTIVE DENSITY	REMOVING HMA PAVEMENT NOTCHED
	HMA PAVEMENT	PG 58-28	COAT	TYPE E-1	HMA PAVEMENT	WEDGE LONGITUDINAL JOINT MILLING
DESCRIPTION	(DOL)	(TON)	(GAL)	(TON)	(DOL)	(LF)
SCRATCH LAYER	-	160	1 710	2,865	1,840	=
1% SLOPE CORRECTION	-	45	1,710	805	510	-
2.5" OVERLAY	-	760	2 400	13,875	8,890	-
NOTCHED WEDGE	-	15	2,490	305	190	31,725
TOTAL	24,040	980	4,200	17,850	11,430	31,725

	PAVEMENT MARKING										
LOCATION	(646.0106) PAVEMENT MARKING EPOXY 4-INCH (EDGELINE) (LF)	(647.0406) PAVEMENT MARKING SAME DAY EPOXY 4-INCH (LF)	(647.0566) PAVEMENT MARKING STOP LINE EPOXY 18-INCH (LF)	(649.0100) TEMPORARY PAVEMENT MARKING 4-INCH (LF)	(649.1100) TEMPORARY PAVEMENT MARKING STOP LINE 18-INCH (LF)						
SCRATCH LAYER/SLOPE CORRECTION	=	=	=	16,230	-						
2.5' OVERLAY - 1st PASS	-	-	-	26,170	55						
2.5' OVERLAY - 1st PASS	63,450	30,750	55	-	-						
TOTAL	L 63,450	30,750	55	42,400	55						

			EROSION CONTROL		
STATION	(606.0200) RIPRAP MEDIUM (CY)	(628.1905) MOBILIZATIONS EROSION CONTROL (EACH)	(628.1910) MOBILIZATIONS EMERGENCY EROSION CONTROL (EACH)	(628.2008) EROSION MAT URBAN CLASS I TYPE B (SY)	(645.0120) GEOTEXTILE FABRIC TYPE HR (SY)
90+00	5	1	1	70	9
TOTAL	5	1	1	70	9

	-	TRAFFIC CONTROL	
	PROJECT	(643.0900) TRAFFIC CONTROL SIGNS	PCMS
DAYS	(EACH)	(DAY)	(DAY)
68	1	-	136
54	=	1,188	-
TOTA	L 1	1,188	136

Ε PROJECT NO: 3663-00-61 HWY:STH 67 COUNTY: ROCK & WALWORTH MISCELLANEOUS QUANTITIES SHEET 20

				(634.0612) Post Wood 4x6-INCH x 12-FT	(634.0614) Post Wood 4x6-INCH x 14-FT	(634.0616) Post Wood 4x6-INCH x 16-FT	(634.0618) Post Wood 4x6-INCH x 18-FT	S	637.020) IGN REFLE TYPE I	CTIVE	(638.2602) REMOVING SIGNS TYPE II	(638.3000) REMOVING SMALL SIGN SUPPORTS	(657.0305) POLES TYPE 2	(654.0102) CONCRETE BASES TYPE II 1	(657.0255) TRANSFORMER BASES BREAKAWAY 1 1/2 - INCH BOLT CIRCLE	(657.0590) TROMBONE ARM 20-FT	MS
GN NO.	LOCATION	SIGN CODE	SIGN DESCRIPTION	(EACH)	(EACH)	(EACH)	(EACH)	SIZE	(IN)	AREA (SF)	(EACH)	(EACH)	(EACH)	(EACH)	(EACH)	(EACH)	REMARKS
1	LT	J3-2	DIRECTIONAL ASSEMBLY (2 HEAD ROUTE PANEL)				1	48	57	19.00	1	1					
2a	LT	R1-1	STOP					36	36	7.46							
2b	LT	R1-1	STOP					24	12	2.00	1	1	1	1	1	1	
2c	LT	W4-4C	TRAFFIC ON 140 DOES NOT STOP					36	36	7.46							
3	RT	J4-1	REASSURANCE ASSEMBLY (1 HEADED ROUTE PANEL)		1			24	36	6.00	1	_					
4	RT	D2-2	DESTINATION/DISTANCE (TWO) WITH DIE CUT LETTERS		2			78	24	13.00	1	2					
5	RT	W8-8	ROUGH ROAD					00	00	0.00	1						
6	RT	R2-1	SPEED LIMIT 55 MPH		1			24	30	5.00							
7	LT	D1-3	TRIPLE DESTINATION/ARROW			2		66	42	19.25	1	2					
8	LT	J2-3	ROUTE TURN ASSEMBLY (3 HEAD ROUTE PANEL)				2	72	57	28.50	1	2					
9	LT	W3-1	STOP AHEAD			1		36	36	9.00	1	1					
10	RT	W3-1	STOP AHEAD			1		36	36	9.00							
11	LT	J4-1	REASSURANCE ASSEMBLY (1 HEADED ROUTE PANEL)			1		24	36	6.00	1	1					
12	LT	W14-3	NO PASSING ZONE			1		48	36	6.00	1	1					
13	RT	W14-3	NO PASSING ZONE			1		48	36	6.00	1	1					
14	RT	W14-3	NO PASSING ZONE			1		48	36	6.00	1	1					
15	LT	W14-3	NO PASSING ZONE			1		48	36	6.00	1	1					
16	RT	W14-3	NO PASSING ZONE			1		48	36	6.00	1	1				1	
17	LT	W14-3	NO PASSING ZONE			1		48	36	6.00	1	1		+			
18	RT	W14-3	NO PASSING ZONE			1		48	36	6.00	1	1					
19	LT	R1-1	STOP			1		30	30	5.18	1	1		+		+	
20	RT	R1-1	STOP			1		30	30	5.18	1	1					
21	LT	W14-3	NO PASSING ZONE			1		48	36	6.00	1	1					
22	RT	W14-3	NO PASSING ZONE			-	1	48	36	6.00	1	1					
23	LT	W14-3	NO PASSING ZONE			1	1	48	36	6.00	1	1				1	
24	RT	W14-3	NO PASSING ZONE		1	1		48	36	6.00	1	1		+		1	
25	LT	W1-7	NIGHT ARROW (DOUBLE)		-	1		48	24	8.00	1	2					
26	RT	R1-1	STOP			1		30	30	5.18	1	1					
27	LT	R1-1	STOP			1		30	30	5.18	1	1					
28	RT	W1-7	NIGHT ARROW (DOUBLE)			1		48	24	8.00	1	2					
29	LT	W14-3	NO PASSING ZONE			1		48	36	6.00	1	1				1	
30	RT	W14-3	NO PASSING ZONE				1	48	36	6.00	1	1					
31	LT	12-2	INFORMATION (ONE) WITH DIE CUT LETTERS			1		48	15	5.00	1	1					ROCK CO
32	RT	12-2	INFORMATION (ONE) WITH DIE CUT LETTERS		2			72	15	7.50	1	2					WALWORTH (
33	RT	I-55-56	ADOPT-A-HIGHWAY [SPONSOR]					00	00	0.00	0	0					
34	LT	W14-3	NO PASSING ZONE			1		48	36	6.00	1	1					
35a	LT	S3-1	SCHOOL BUS STOP AHEAD			1		36	36	9.00	1	1					
35b	LT	W8-8	ROUGH ROAD					00	00	0.00	1						
36	RT	W2-2	SIDE ROAD (90 DEGREES)			1		30	30	6.25	1	1					
37	LT	W1-7	NIGHT ARROW (DOUBLE)	1				48	24	8.00	1	2					
38	RT	R1-1	STOP			1		30	30	5.18	1	1					
		 				1	1		 	 	+ -			+	1	+	

SIGN REPAIRS

FILE NAME : I:\916-010 STH 67\ENGINEERING\DRAWINGS\33630031_SHEETSPLAN\030202_MQ.DWG

HWY:STH 67

PROJECT NO: 3663-00-61

PLOT DATE : 12/15/2012 9:07 AM

COUNTY:ROCK & WALWORTH

MISCELLANEOUS QUANTITIES

PLOT BY : DAVE BOTTCHER PLOT NAME : _____PLOT SCALE :

Ε

SHEET

Standard Detail Drawing List

09C02-06	CONCRETE BASES. TYPES 1. 2 & 5
09E01-11A	POLE MOUNTINGS FOR TRAFFIC SIGNALS TYPE 2
12A04-03	STRUCTURE IDENTIFICATION PLAQUES, RAMP GATES, SIGN BRIDGES & OVERHEAD SIGN SUPPORTS & TRAFFIC SIGNALS
15A03-02A	FLEXIBLE MARKER POST FOR CULVERT END
15A03-02B	FLEXIBLE MARKER POST FOR CULVERT END
15C04-01	TRAFFIC CONTROL, ADVANCE WARNING SIGNS 45 M.P.H. OR GREATER TWO-WAY UNDIVIDED ROAD OPEN TO TRAFFIC
15C08-15A	PAVEMENT MARKING (MAINLINE)
15C12-03	TRAFFIC CONTROL FOR LANE CLOSURE (SUITABLE FOR MOVING OPERATIONS)
15C19-01A	MOVING PAVEMENT MARKING OPERATION TWO-LANE TWO-WAY ROADWAY

6

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Standard Detail Drawing List

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15C19-01A	MOVING PAVEMENT MARKING OPERATION TWO-LANE TWO-WAY ROADWAY

6

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CONDUIT WITHIN

6" DIA.

ANCHOR RODS SHALL BE


ORIENTED PARALLEL TO

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QUANTITY	CONCRETE BASE TYP				
REQUIREMENTS	1	2	5		
APPROX. CUBIC YARDS OF CONCRETE	0.40	0.57	0.40		
LBS. OF HOOP BAR STEEL	NONE	23	16		
LBS. OF VERTICAL BAR STEEL	NONE	60	18		

FORMING DETAIL

1'-8"

-CONDUIT

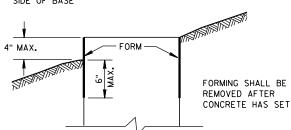123/4" BOLT

CIRCLE

GENERAL NOTES

DETAILS OF CONSTRUCTION, MATERIALS AND WORKMANSHIP NOT SHOWN ON THIS DRAWING SHALL CONFORM TO THE PERTINENT REQUIREMENTS OF

BASES SHALL BE EXCAVATED BY USE OF A CIRCULAR AUGER.

TOP SURFACES OF CONCRETE BASES SHALL BE TROWEL FINISHED SMOOTH AND LEVEL.

CONDUIT SIZES AND LOCATIONS SHALL BE AS SHOWN ON THE PLANS.


THE FINAL OR TERMINATING CONCRETE BASE IN A CONDUIT RUN SHALL HAVE A 6" EXIT STUB INSTALLED FOR FUTURE CABLING USE. THE EXIT STUB SHALL BE SIZED AS USED THROUGHOUT THE CONDUIT RUN AS SHOWN AT THE ENTRANCE OF THE BASE.


MINIMUM BENDING RADIUS OF CONDUIT IS EQUAL TO 6 X THE DIAMETER.

CONDUIT HEIGHT ABOVE CONCRETE BASES SHALL BE 1 INCH. ALL METALLIC CONDUIT ENDS SHALL BE REAMED AND THREADED.

ALL CONDUIT ENDS AT THE TOP OF CONCRETE BASES SHALL BE CAPPED IF METALLIC OR PLUGGED IF NONMETALLIC IMMEDIATELY AFTER PLACEMENT AND BEFORE CONCRETE IS POURED. CONDUITS IN WHICH WIRE OR CABLE IS NOT INSTALLED SHALL REMAIN CAPPED OR PLUGGED.

1" CONDUIT FOR GROUNDING -CONDUIT PURPOSES 111/2" BOLT CIRCLE CONDUIT WITHIN 6" DIA. THE ROADWAY

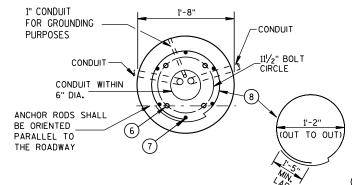

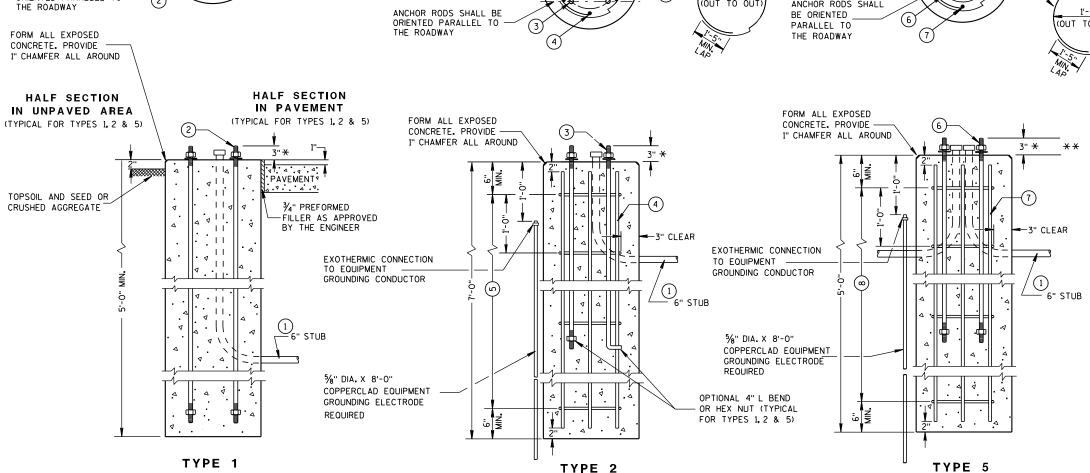

CONCRETE BASES

GENERAL NOTES (CONTINUED)

BELL ENDS SHALL BE INSTALLED ON ALL PVC CONDUIT EXPOSED AT THE TOP OF CONCRETE BASES BEFORE INSTALLATION OF CABLE OR WIRE.

ENDS OF CONDUIT INSTALLED BELOW GRADE FOR FUTURE USE SHALL BE CAPPED IF METALLIC OR PLUGGED IF NONMETALLIC.

WHEN REQUIRED TO CONNECT NONMETALLIC CONDUIT TO METALLIC CONDUIT, ONLY ADAPTER FITTINGS, U.L. LISTED FOR ELECTRICAL USE, SHALL BE USFD.

IF A BASE REQUIRES A DEEP FORM BECAUSE OF LOOSE DIRT OR FILL, THE FORM SHALL BE REMOVED BEFORE BACKFILLING AROUND THE BASE. BACKFILL SHALL BE TAMPED TIGHT AGAINST THE BARE CONCRETE BASE IN LAYERS OF 1FOOT OR LESS.

A NO. 4 AWG. STRANDED COPPER EQUIPMENT GROUNDING CONDUCTOR SHALL BE EXOTHERMICALLY WELDED TO THE EQUIPMENT GROUNDING ELECTRODE (GROUND ROD) FOR TYPE 2 AND TYPE 5 BASES.

THE EQUIPMENT GROUNDING CONDUCTOR SHALL BE FURNISHED AND INSTALLED TO ENTER THE BASE OF THE TYPE 2 AND TYPE 5 BASES THROUGH A 1 INCH CONDUIT INSTALLED FOR GROUNDING PURPOSES, LEAVING A 4 FOOT COIL OF WIRE ABOVE THE CONCRETE BASE. THE EQUIPMENT GROUNDING CONDUCTOR SHALL BE NEATLY COILED AND THE COILS TIED TOGETHER.

ANCHOR RODS SHALL BE THREADED 12" IN LENGTH ON EACH END OF THE ROD, ANCHOR RODS SHALL BE MANUFACTURED IN ACCORDANCE WITH SECTION 654.2.1 AND 641.2.2 OF THE STANDARD SPECIFICATIONS, ASTM A-449, OR ASTM A-687 (GRADE 105).

WASHERS AND LOCK WASHERS ARE REQUIRED ON ALL ANCHOR RODS.

WHEN ANCHOR RODS USING THE ALTERNATE "L" BEND ARE FURNISHED. THE 4" "L" BEND SHALL BE IN ADDITION TO THE SPECIFIED ANCHOR ROD BAR LENGTH, THE "L" BEND END SHALL NOT BE THREADED.

ANCHOR RODS SHALL BE INSTALLED WITH MISALIGNMENTS OF LESS THAN 1:40 FROM VERTICAL.

WELDING OF THE ANCHOR RODS TO THE CAGE IS UNACCEPTABLE. TIE WIRES SHALL BE USED.

BAR STEEL REINFORCEMENT SHALL BE COATED WITH POWDERED EPOXY RESIN IN ACCORDANCE WITH SECTION 505 OF THE STANDARD SPECIFICATIONS (LATEST EDITION).

- 1) THE MINIMUM DEPTH OF CONDUIT EXITING THE CONCRETE BASE AND INSTALLED BELOW THE TRAVELED WAY SHALL BE 24 INCHES. THE MINIMUM DEPTH OF CONDUIT EXITING THE CONCRETE BASE THAT IS NOT INSTALLED BELOW THE TRAVELED WAY SHALL BE 18 INCHES, THE MAXIMUM DEPTH OF ALL CONDUIT SHALL BE 36 INCHES EXCEPT WITH WRITTEN APPROVAL BY THE ENGINEER.
- (2) (4) 1" DIA. X 3'-6" ANCHOR RODS.
- (3) (4) 1" DIA. X 5'-0" ANCHOR RODS.
- (4) (6) NO. 6 X 6'-8" BAR STEEL REINFORCEMENT.
- (5) (7) NO. 4 X 5'-1" BAR STEEL REINFORCEMENT @ 1'-0" C-C.
- (6) (4) 1" DIA. X 3'-6" ANCHOR RODS.
- (7) (6) NO.4 X 4'-8" BAR STEEL REINFORCEMENT.
- (8) (5) NO. 4 X 5'-1" BAR STEEL REINFORCEMENT @ 1'-0" C-C.

CONCRETE BASES, TYPES 1, 2 & 5

STATE OF WISCONSIN DEPARTMENT OF TRANSPORTATION

APPROVED 3/3/10 /S/ Joanna L. Bush

STATE ELECTRICAL ENGINEER FOR HWYS

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^{*} ANY ANCHOR ROD PROJECTION SHORTER THAN 23/4" OR LONGER THAN 31/4" SHALL REQUIRE THE BASE TO BE REMOVED AND REPLACED AT THE CONTRACTORS EXPENSE.

 $^{^{\}star\star}$ for nonbreakaway installations, 4 $^{\prime}\!\!/_2$ " * anchor rod projection with the USE OF LEVELING NUTS. RODENT SCREEN REQUIRED.

TYPE 2 POLE MOUNTING CONFIGURATION

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S.D.D. 9 E 1-11a

TRAFFIC SIGNALS


TYPE 2

STATE OF WISCONSIN

DEPARTMENT OF TRANSPORTATION



3.D.D. 12 A 4-3

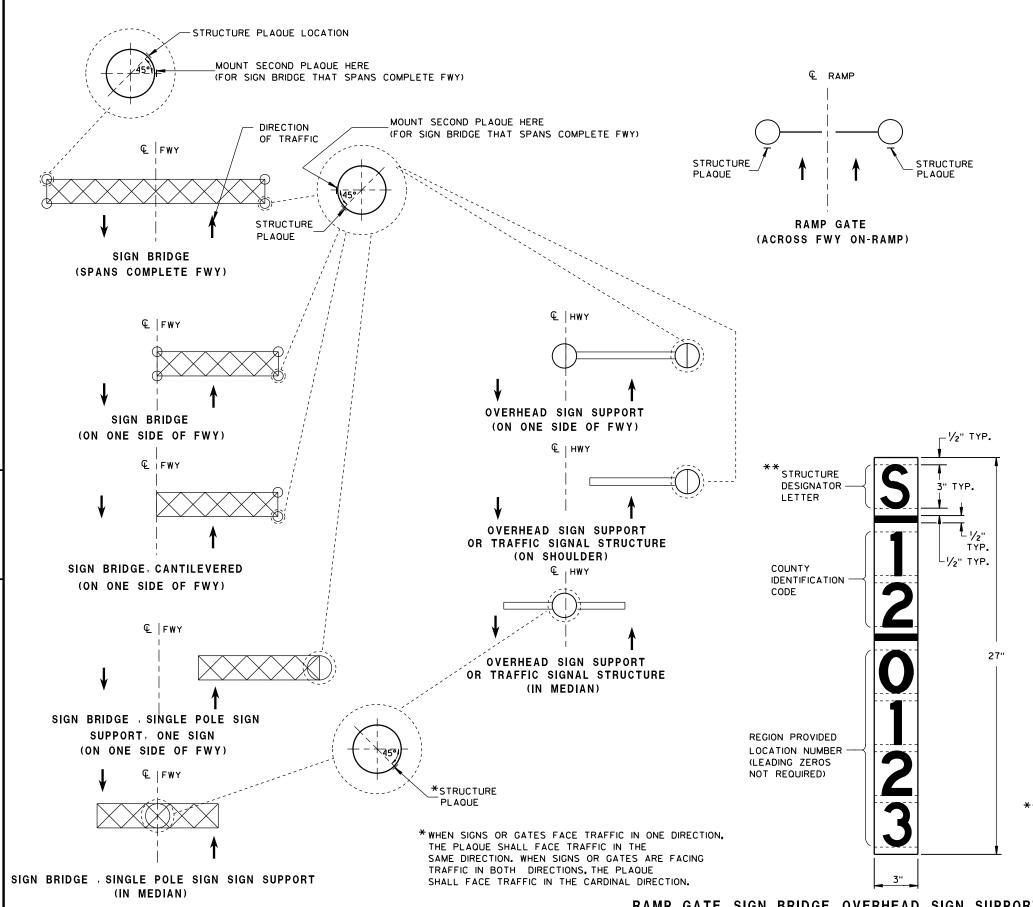

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12

 \triangleright

LOCATION OF RAMP GATE, SIGN BRIDGE, OVERHEAD

SIGN SUPPORT & TRAFFIC SIGNAL STRUCTURE PLAQUES

GENERAL NOTES

DETAILS OF CONSTRUCTION AND WORKMANSHIP NOT SHOWN IN THIS DRAWING SHALL CONFORM TO THE PERTINENT REQUIREMENTS OF THE CONTRACT.

PLAQUES SHALL BE INCIDENTAL TO ALL NEW INSTALLATIONS.

IF THE PROPOSED SIGN BRIDGE OR OVERHEAD SIGN SUPPORT IS REPLACING AN EXISTING SIGN BRIDGE OR OVERHEAD SIGN SUPPORT, A NEW IDENTIFICATION PLAQUE WILL BE REQUIRED.

FASTEN TOP, CENTER AND BOTTOM OF PLAQUE TO POLE OR OTHER LOCATION AS FOLLOWS:

GALVANIZED STEEL SHAFT - 3 STAINLESS STEEL POP RIVETS

A588 STEEL SHAFT - SHIM FOR DRAINAGE WITH STAINLESS WASHERS; FASTEN WITH STAINLESS SELF-TAPPING SCREWS

ALUMINUM SHAFTS - 3 ALUMINUM POP RIVETS

MOUNTING HEIGHT SHALL BE APPROXIMATELY 5.0' ABOVE CURB OR SHOULDER. ADJUST IF IT IS KNOWN THAT REQUIRED TRAFFIC SIGNS WILL OBSTRUCT.

PLAQUE MATERIALS:

BASE - SHEET ALUMINUM, 0.060" THICK.


FACE - WHITE, SELF-ADHESIVE VINYL SHEETING, NON-RETROREFLECTIVE

LINES - BLACK, 1/2" WIDE, SELF-ADHESIVE

CHARACTERS:- BLACK, SELF ADHESIVE, SERIES "D", SIZE AS SHOWN.

FOR SIGN BRIDGES, STRUCTURE MOUNTED, THE STRUCTURE PLAQUE SHALL BE MOUNTED HORIZONTALLY AS SHOWN ON THE DRAWING. THE STRUCTURE PLAQUE SHALL BE MOUNTED HORIZONTALLY TO THE BACK OF THE SIGN, BETWEEN THE ALUMINUM EXTRUSIONS, NEAR THE TOP LEFT HAND CORNER OF THE SIGN. THE BASE MATERIAL SHALL BE OMITTED AND THE FACE ADHERED DIRECTLY TO THE ALUMINUM SURFACE. PRIOR TO ADHERING THE MATERIAL, THE ALUMINUM SURFACE SHALL BE SMOOTH, CLEAN AND DRY.

WHERE SIGN BRIDGE ILLUMINATION IS PROVIDED, THE STRUCTURE MUST ALSO HAVE A SIGN BRIDGE CIRCUIT PLAQUE AS SHOWN IN THE ELECTRICAL DETAILS.

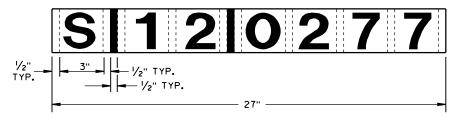

IDENTIFICATION PLAQUE FOR SIGN BRIDGE, STRUCTURE MOUNTED

** LETTER "G" UTILIZED FOR RAMP GATES. LETTER "S" UTILIZED FOR SIGN BRIDGES, OVERHEAD SIGN SUPPORTS, AND TRAFFIC SIGNALS.

STRUCTURE IDENTIFICATION PLAQUES, RAMP GATES, SIGN BRIDGES, OVERHEAD SIGN SUPPORTS, & TRAFFIC SIGNALS

STATE OF WISCONSIN
DEPARTMENT OF TRANSPORTATION


APPROVED

DATE STATE TRAFFIC ENGINEER OF DESIGN

RAMP GATE, SIGN BRIDGE, OVERHEAD SIGN SUPPORT AND TRAFFIC SIGNAL STRUCTURE PLAQUE FOR SIGN BRIDGES AND OVERHEAD SIGN SUPPORT WHICH ARE NOT STRUCTURE MOUNTED





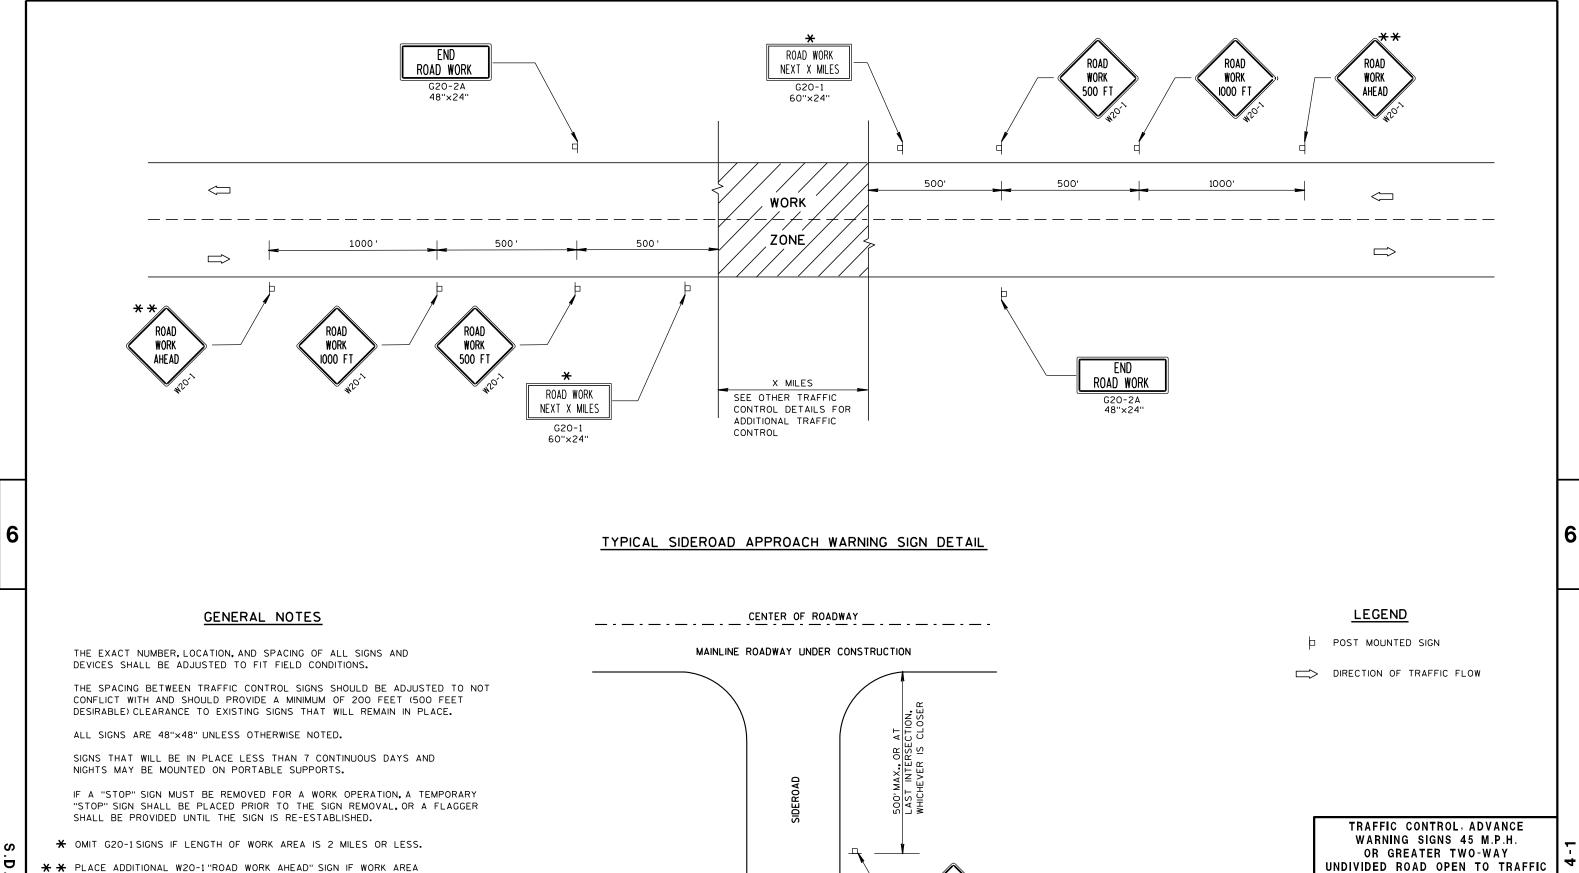

STATE OF WISCONSIN

DEPARTMENT OF TRANSPORTATION

/S/ Chester J. Spang
CHIEF SIGNS AND MARKING ENGINEER

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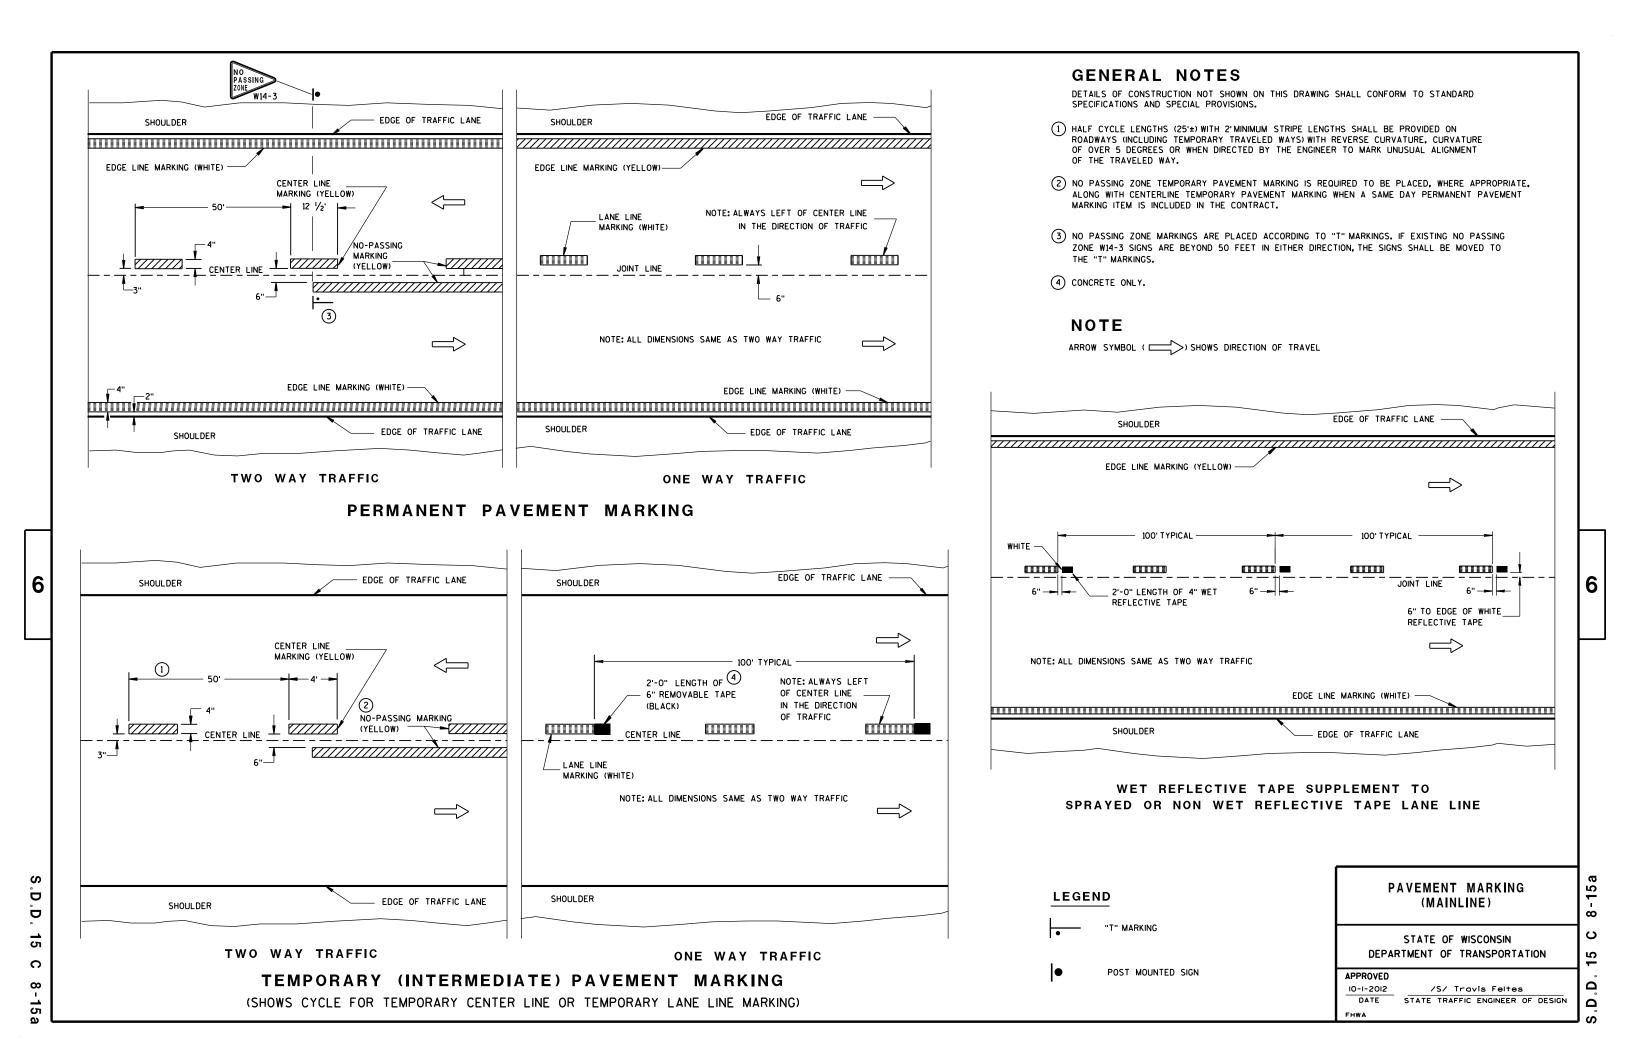
APPROVED


5/23/00


S.D.D. 15 C 4-1


WITHIN THE PROJECT IS SEPARATED BY MORE THAN 2 MILES FROM


PREVIOUS WORK AREA OR SIGNING.




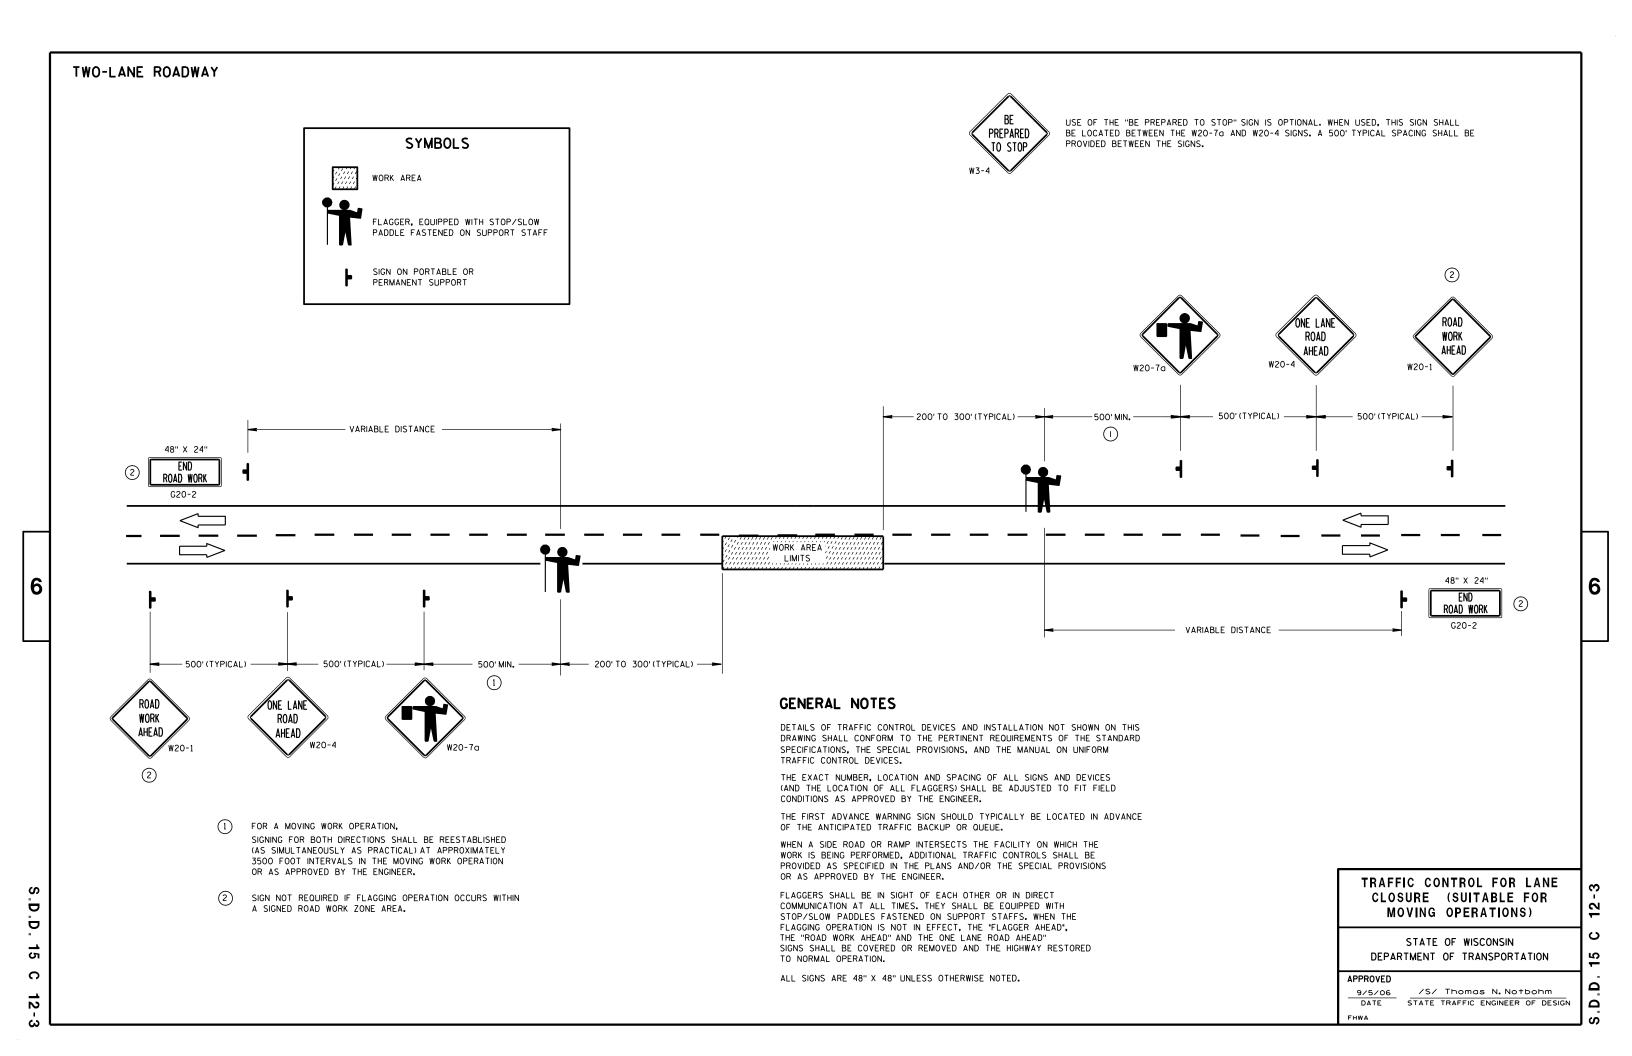

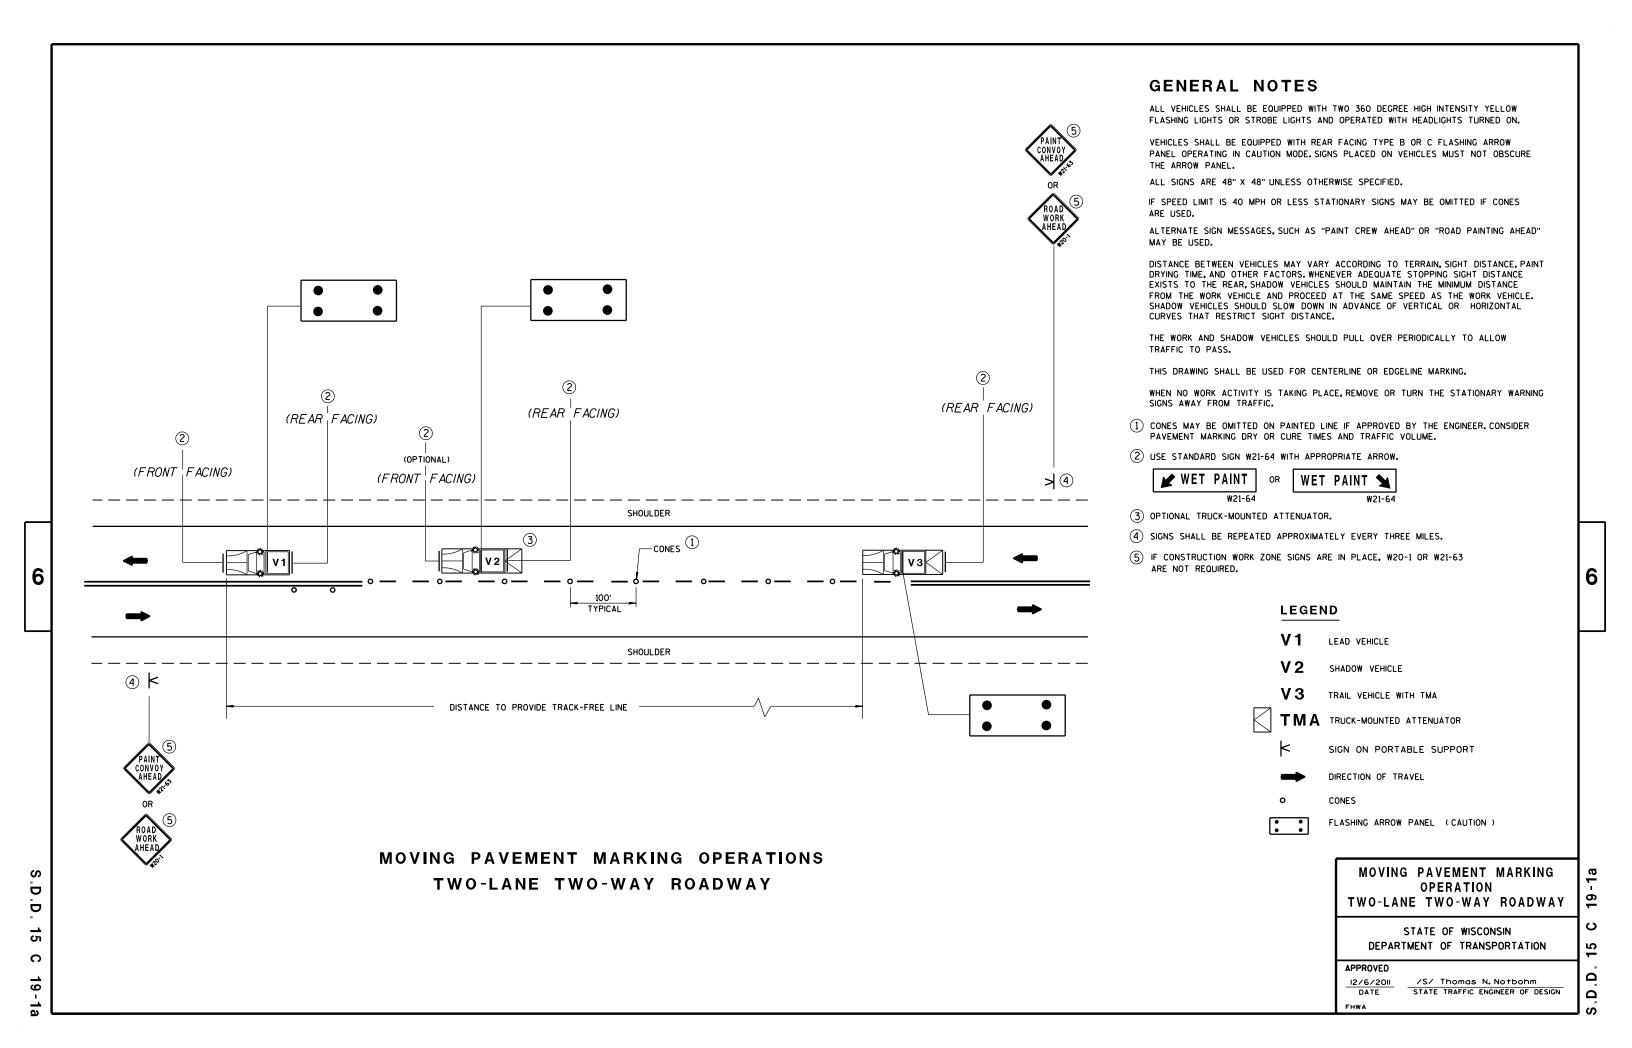

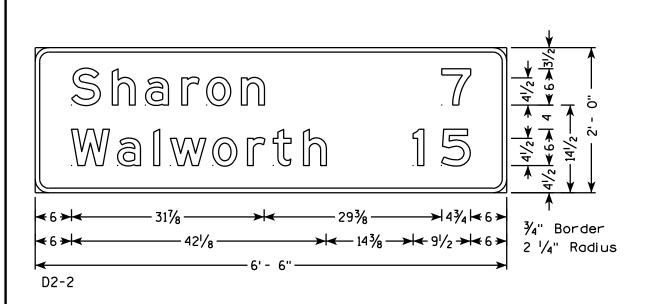

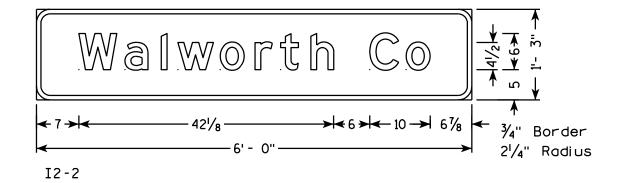

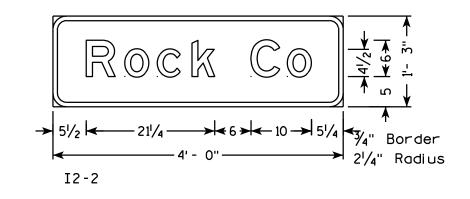


NOTES

- 1. All Signs Type II Type H Reflective reference WIS DOT Standard Specification for HIGHWAY and STRUCTURE CONSTRUCTION latest edition.
- 2. Color:


 Background GREEN


 Message WHITE
- 3. Message Series E

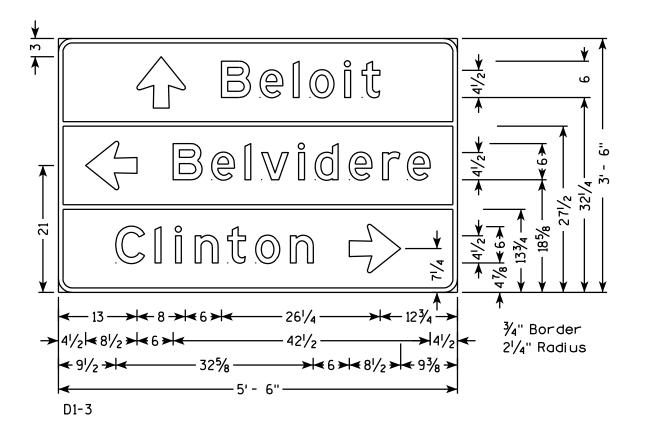



PROJECT NO: 3663-01-31 HWY: STH 67 COUNTY: ROCK PERMANENT SIGNING SHEET NO:

PLOT NAME :

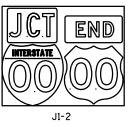

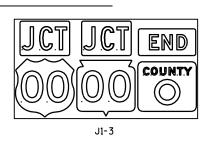

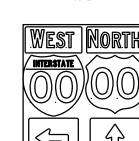

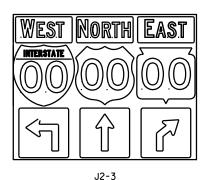





(Typical Vertical J-Assembly See Note 10)


North IMTERSTATE


J2-1 J2-2

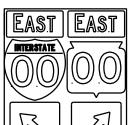


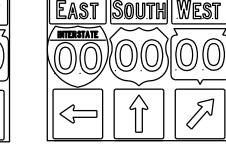

J3-2

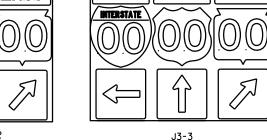

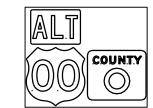

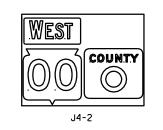


J4-1

J3-1







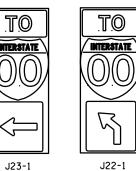




NOTES

- 1. Signs are Type II Type H Reflective reference WIS DOT Standard Specification for HIGHWAY and STRUCTURE CONSTRUCTION latest edition.
- 2. Color:

Background - Black Non-reflective Message - see Note 5

- 3. Message Series See Note 5
- 4. Corners shall be square or rounded if base material is plywood. If base material is metal the corners shall be rounded.
- 5. The colors and message spacing on each marker shall be according to the applicable route marker panel specifications.
- 6. Certain marker heads require the component pieces to be the same color. As an example, all the components used with an M1-1 Interstate marker shall be blue.
- 7. Single panel j-assemblies shall only be used with route marker shields that are same size. If the route marker shields are different size use multiple piece component.
- 8. Route assemblies that have 24 inch route shields and have dimensions greater than 48 inches (both vertical and horizontal) shall have one horizontal splice between the arrows and route shields. Vertical splices shall not be used on route assemblies with a horizontal dimension of 144 inches or less. The contractor shall not use more than one vertical joint per sign and the joint shall be between route shields.
- 9. Route assemblies that have 36 inch shields and have dimensions greater than 48 inchs (both vertical and horizontal) shall have two horizontal splices. One horizontal splice shall be between the cardinal direction and route shields and the other horizontal splice shall be between the arrows and route shields. Vertical splices shall not be used on route assemblies with a horizontal dimension of 144 or less. The contractor shall not use more than one vertical joint per sign and the joint shall be between route shields.
- 10. All Vertical J Assemblies are given a Sign Code of JV

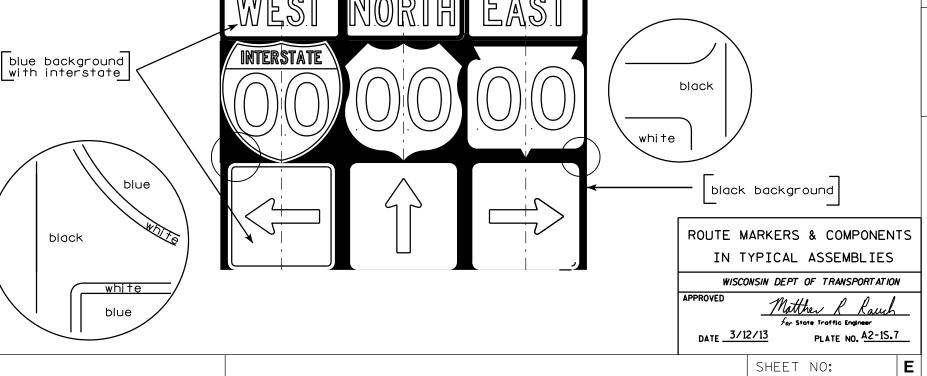

COUNTY

J13-1

PROJECT NO:




























urban area

2' Min - 4' Max (See Note 5)


** Curb Flowline


D | White Edgeline Location

RURAL AREA (See Note 2)

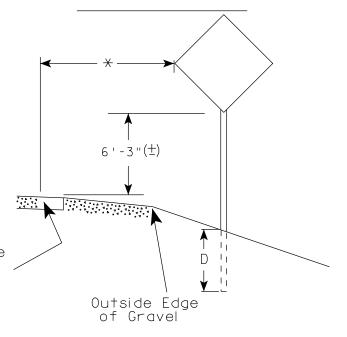

2' Min - 4' Max (See Note 5)

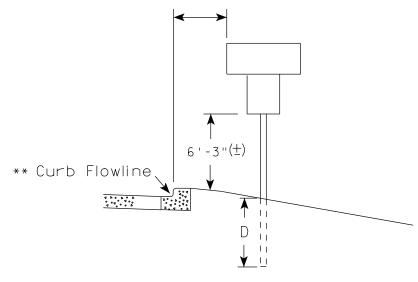

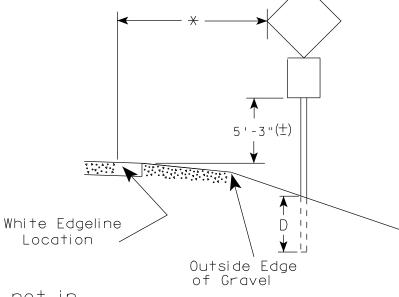

- ** The existence of curb and gutter does not in itself mandate the vertical clearance illustrated. That height is typically measured where there is sidewalk adjacent to the roadway or parking is permitted. In the absence of sidewalk vertical clearance is measured from the top of the curb. Offset of signs is measured from the flow line.
- * 6 feet from edge of a paved shoulder or 12 feet from the edge of pavement (edge line location) or 2 feet from outside edge of gravel, whichever is greater unless directed by project engineer.

PLOT BY: mscsia

GENERAL NOTES

- 1. Signs wider than 4 feet or larger than 20 sq. ft. shall be mounted on multiple posts. Refer to plate A4-4.
- 2. If signs are mounted on barrier wall, see A4-10 sign plate.
- 3. For expressways and freeways, mounting height is 7'- 3" (±) or 6'-3" (±) depending upon existence of a sub-sign.
- 4. Minimum mounting height for J assemblies (A4-5) is 7'-3'' (\pm) or 6'-3'' (\pm) per urban or rural detail respectively.
- 5. Minimum mounting height for signs mounted on traffic signal poles is 5' 3" (\pm) .
- 6. Offset distance shall be consistent with existing signs or consistent throughout length of project.
- 7. The (\pm) tolerance for mounting height is 3 inches.
- 8. Folding stop signs (R1-1F) shall be mounted at a height of 5'-3" (\pm) or as directed by the Engineer.
- 9. The Double Arrow sign (W12-1) shall be mounted at a height of 2'-3" (±). The Chevron sign (W1-8), Roundabout Chevron panel (R6-4B), Clearance Markers (W5-52), Mile Markers (D10 series) & End of Road Markers (W5-56 & W5-56A) shall be mounted at a height of 4'-3" (±).

POST EMBEDMENT DEPTH

Area of Sign	
Installation	D
(Sq.Ft.)	(Min)
20 or Less	4'
Greater than 20	5'

TYPICAL INSTALLATION
OF PERMANENT TYPE II
SIGNS ON SINGLE POSTS

WISCONSIN DEPT OF TRANSPORTATION

SHEET NO:

APPROVED

Matther R Rauch

DATE <u>9/21/2011</u>

PLATE NO. <u>A4-3.16</u>

PROJECT NO:

HWY:

COUNTY:

PLOT DATE : 21-SEP-2011 13:33


PLOT NAME :


PLOT SCALE: 101.303739:1.000000


WISDOT/CADDS SHEET 42

URBAN AREA


RURAL AREA (See Note 3)

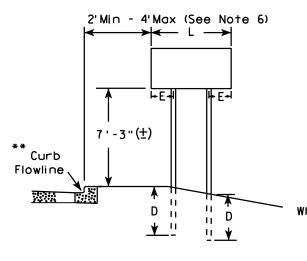

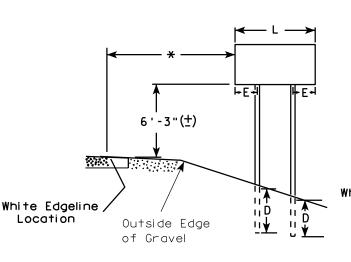

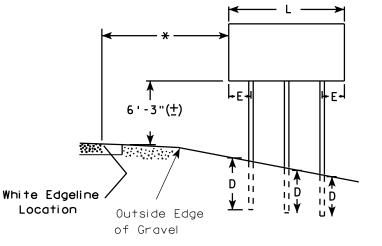

2' Min - 4' Max (See Note 6)

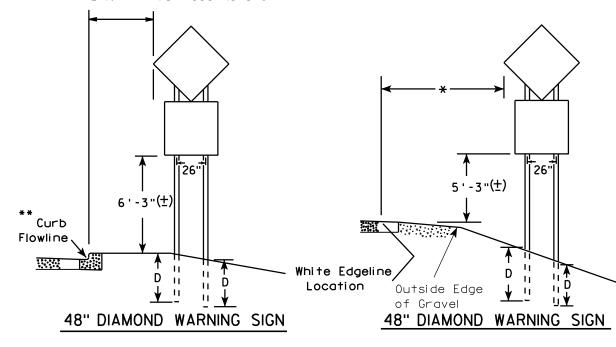

SIGN SHAPE OTHER THAN (THREE POSTS REQUIR	
L	E
Greater than 120" less than 168"	12"

COUNTY:

SIGN SHAPE OTHER THAN (FOUR POSTS REQUIRE	
L	E
168" and greater	12"

GENERAL NOTES

- 1. For multiple post installations, individual post spacing shall be greater than 3'-6".
- 2. See tables below for required number of posts.
- 3. For expressways and freeways. mounting height is 7'-3'' (±) or 6'-3'' (±) depending upon existence of sub-sign.
- 4. The (±) tolerance for mounting height is 3 inches.
- 5. Minimum mounting height for J assemblies (A4-5) is 7'-3'' (±) or 6'-3'' (±) per urban or rural detail respectively.
- 6. Offset distance shall be consistent with existing signs or consistent throughout length of project.
- 7. Folding stop signs (R1-1F) shall be mounted at a height of 5'-3" (±) or as directed by the engineer.
- 8. The Double Arrow sign (W12-1) shall be mounted at a height of 2'-3" (±). The Chevron sign (W1-8), Roundabout Chevron panel (R6-4B). Clearance Markers (W5-52). Mile Markers (D10 series) & End of Road Markers (W5-56 & W5-56A) shall be mounted at a height of 4"-3" (\pm).
- * 6 feet from edge of a paved shoulder or 12 feet from the edge of pavement (edge line location) or 2 feet from outside edge of gravel, whichever is greater unless directed by project engineer.
- ** The existence of curb and gutter does not in itself mandate the vertical clearance illustrated. That height is typically measured where there is sidewalk adjacent to the roadway or parking is permitted. In the absence of sidewalk vertical clearance is measured from the top of the curb. Offset of signs is measured from the flow line.
- *** See A4-3 sign plate for signs 4' or less in width or 20 S.F. or less in area.

POST EMBEDMENT DEPTH

Area of Sign Installation	D
(Sq. Ft.)	(Min)
20 or Less	4'
Greater than 20	5'

PLOT NAME :

TYPICAL INSTALLATION OF TYPE II SIGNS ON MULTIPLE POSTS WISCONSIN DEPT OF TRANSPORTATION

APPROVED

For State Traffic Engineer

PLATE NO. 44-4.11 DATE 9/21/2011

SHEET NO:

FILE NAME : C:\Users\PROJECTS\tr_stdplate\A44.DGN

Greater than 48"

Less than 60"

60" to 120"

* * *

PROJECT NO:

SIGN SHAPE OTHER THAN DIAMOND

Ε

12"

L/5


HWY:


(TWO POSTS REQUIRED)

PLOT DATE: 21-SEP-2011 13:36

PLOT BY: mscsia

PLOT SCALE: 109.249131:1.000000

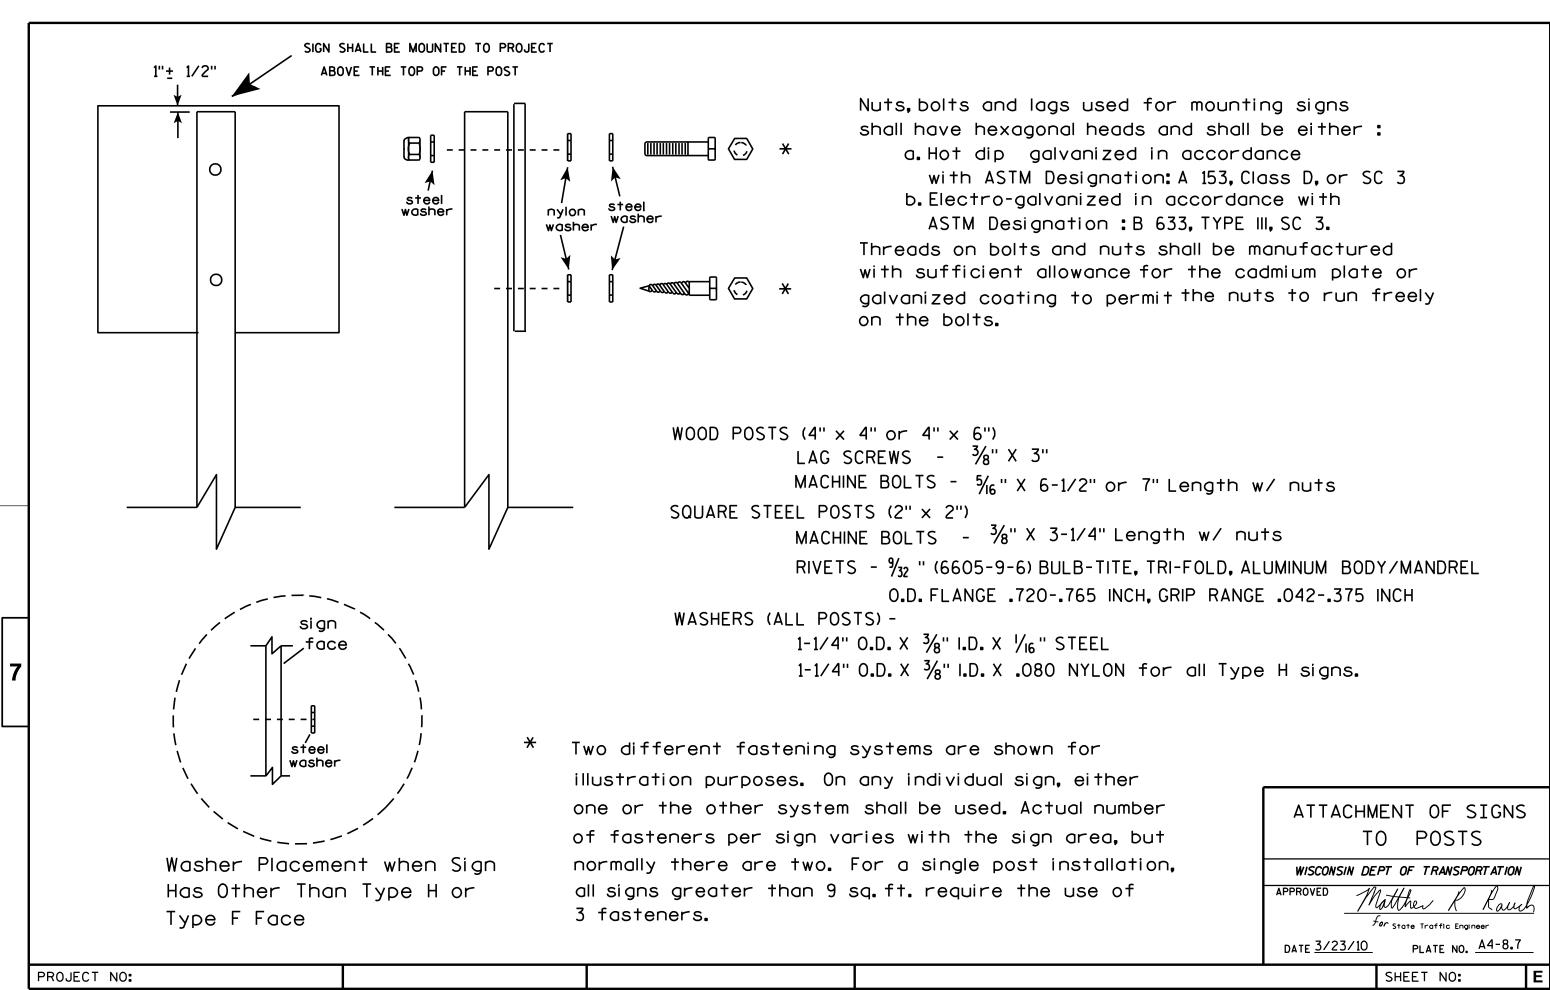

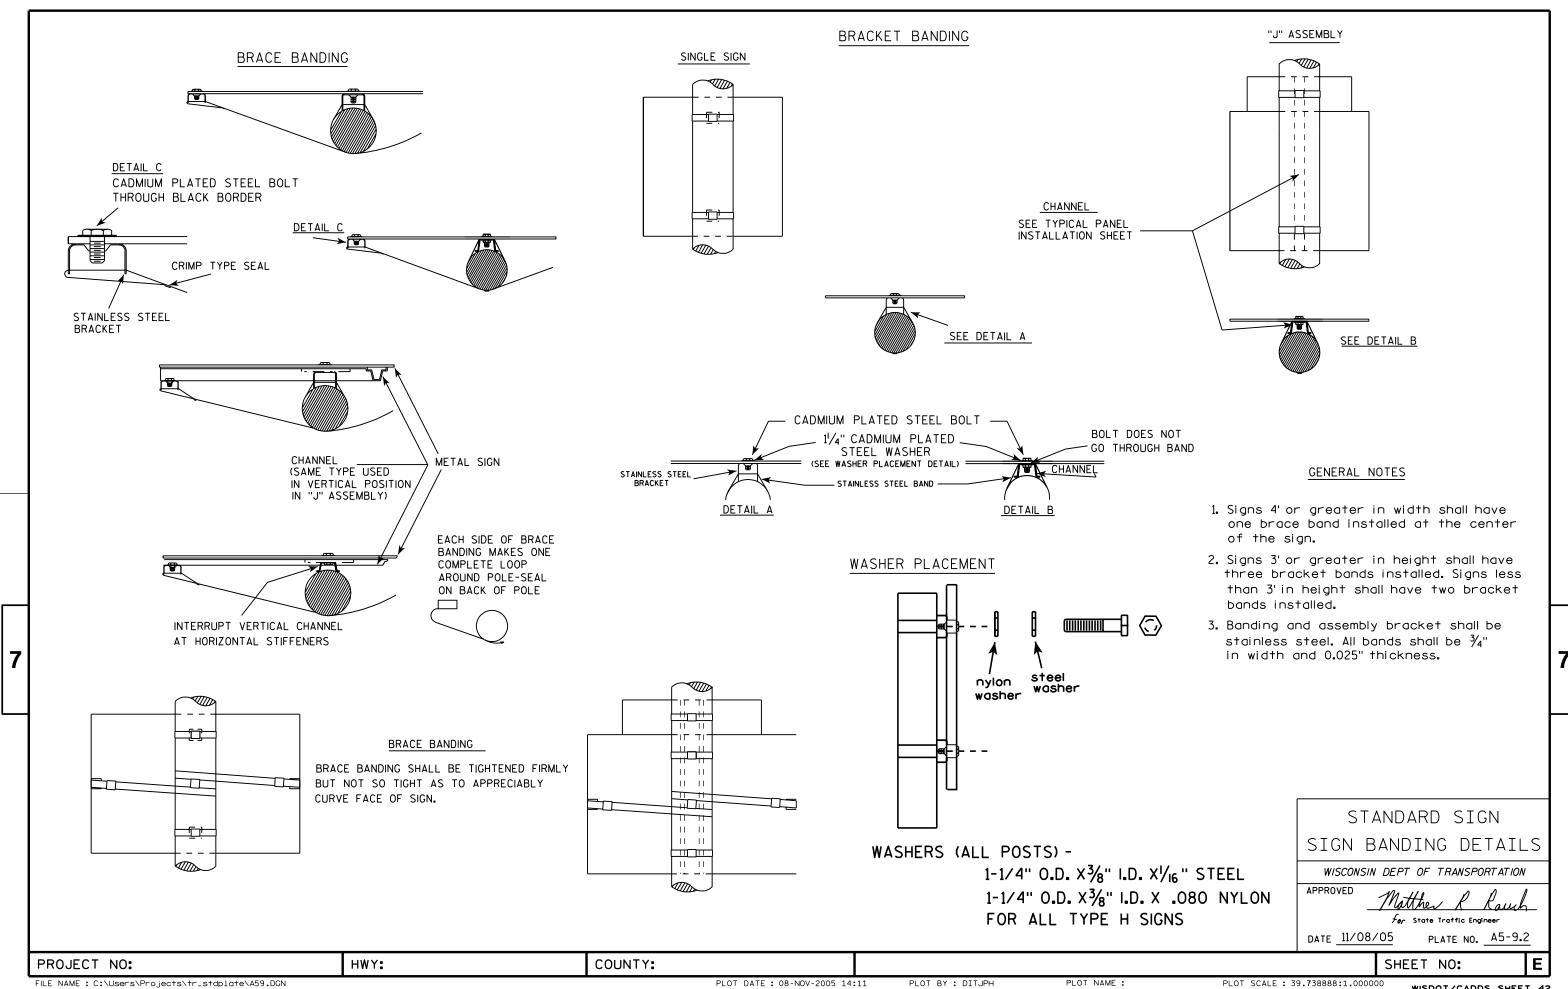

E → SPONSOR A F Y G Z F Z AF XA

HWY:

Background Colors of Symbol*

₽ 4

* VARIES

White Black Green Orange

 * $\!\!\!/_4$ " Black Border between each color of rainbow and border of rainbow

I 2 36 | 1 1/2 | 1/2 5/8 3 1/2 2 7/8 | 2 1/8 | 11 1/4 | 11 1/8 | 9 3/8 | 1 1/4 3/4 12 % 7 1/2 30 7.5 3 4 5

COUNTY:

NOTES

- 1. Sign is Type II Type H Reflective reference WIS DOT Standard Specification for HIGHWAY and STRUCTURE CONSTRUCTION latest edition.
- 2. Color:

Background - White Message - (See Note 5)

- 3. Message Series (See Note 6)
- 4. Corners may be square or rounded when base material is plywood but borders shall be rounded as shown. When base material is metal, the corners and borders shall be rounded.
- 5. Border Blue

Line 1 - Red

Line 2 - Black

Line 3-5 - Blue

6. Line 1 - Dutch 8011L

Line 2 - Series E

Line 3-5 - Series C

7. Contractor shall provide and install a new post bracket in accordance with the I55-56B sign detail.

> STANDARD SIGN I55-56

WISCONSIN DEPT OF TRANSPORTATION

APPROVED for State Traffic Engineer

DATE 4/27/11 PLATE NO. 155-56.3

SHEET NO:

FILE NAME : C:\Users\PROJECTS\tr_stdplate\I5556.DGN

PROJECT NO:


PLOT DATE: 27-APR-2011 10:05

PLOT BY: mscj9h

PLOT NAME :


PLOT SCALE: 7.945391:1.000000

ISOMETRIC VIEW

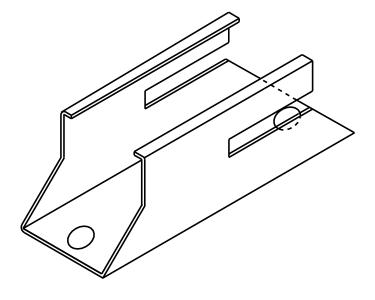


TOP VIEW

HWY:

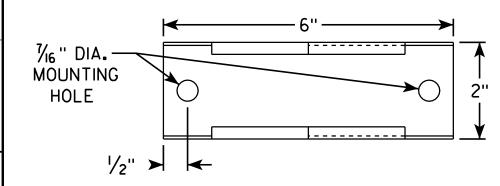

SIDE VIEW

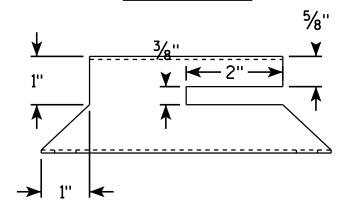


END VIEW **←** 2" →

COUNTY:

NOTES

- 1. Must be capable of permanent attachment to a wood or steel channel sign post utilizing the fastening hardware specified on the A4-8 sign plate.
- 2. Shall be entirely primed and painted with two coats of a black powder coated enamel paint.
- 3. Shall be made with 12 gauge steel, and incorporate no welds, no hinged components, no threaded lock-type components, and no parts which are loose or can be separated from the main body.
- 4. Shall have rounded edges with at least $\frac{1}{8}$ " radii.
- 5. Shall not have unrounded and uncoated metaledges which can contact the back surface of the roll-up sign.
- 6. Top of bracket shall be mounted 2' below the bottom of the 155-56 sign.
- 7. Cost of bracket and fastening hardware shall be incidental to the 155-56 sign.

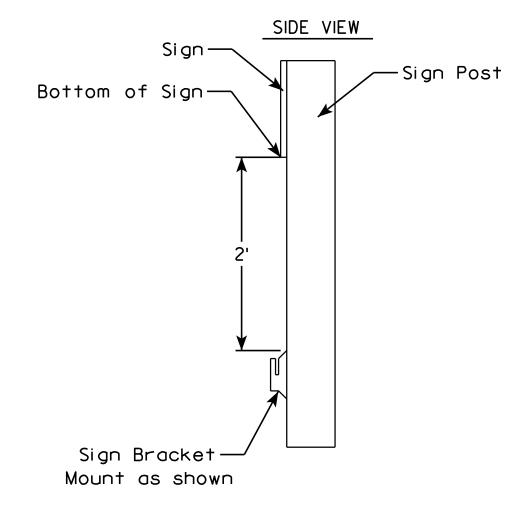

ROLLUP SIGN BRACKET I55-56B

WISCONSIN DEPT OF TRANSPORTATION APPROVED

SHEET NO:

for State Traffic Engineer DATE 2/5/10 PLATE NO. 155-56B.1

PLOT NAME :

PLOT SCALE: 1.986348:1.000000

FILE NAME : C:\Users\PROJECTS\tr_stdplate\I5556B.DGN

PROJECT NO:

PLOT DATE: 01-MAR-2010 15:34

PLOT BY : ditjph

- 1. Sign is Type II See Note 6 reference WIS DOT Standard Specification for HIGHWAY and STRUCTURE CONSTRUCTION latest edition.
- 2. Color:

Background - White & Black - See Note 6 Message - Black

- 3. Message Series See note 5
- 4. Corners may be square or rounded when base material is plywood but borders shall be rounded as shown. When base material is metal, the corners and borders shall be rounded.
- 5. Substitute appropriate Series numerals and adjust spacing as per plate A10-1.
- 6. Permanent Signs
 Background Type H Reflective
 Detour or temporary Signs
 Background Reflective

BLACK	↑ G → ↑ F → → ↑ → → → → → → → → → →
Metric equivalent for this sign is:	

HWY:

900 mm X 900 mm

5 900 mm X 900 mm

PROJECT NO:

SIZE	Α	В	С	D	E	F	G	Н	I	J	К	L	М	N	0	Р	Q	R	S	Т	U	٧	W	Х	Y	Z	Area sq. ft.	Area m2
1																												
2	24		1 1/2			12	5 1/2	6 1/2	10 1/4	2 1/2	8 %	11 1/2	1	1 1/8	11 1/4	21 1/8											4.0	. 36
3	36		2 1/4			18	8 3/4	9 1/4	15 3/8	5 3/8	12 5/8	17 1/8	1 1/2	2 1/8	16 1/8	33											9.0	. 81
4	36		2 1/4			18	8 3/4	9 1/4	15 3/8	5 3/8	12 5/8	17 1/8	1 1/2	2 1/8	16 1/8	33											9.0	.81
5	36		2 1/4			18	8 3/4	9 1/4	15 3/8	5 3/8	12 5/8	17 1/8	1 1/2	2 1/8	16 1/8	33											9.0	.81
ט ן	26		2 /4			10	0 74	J /4	12 78	3 78	12 78	11 /8	1 /2	² /8	10 /8	33		<u> </u>										9.0

COUNTY:

STATE ROUTE MARKER
M1-6 FOR ASSEMBLIES

WISCONSIN DEPT OF TRANSPORTATION


APPROVED

The state Traffic Engineer

DATE 3/20/02 PLATE NO. M1-6.9

SHEET NO:

PLOT NAME :

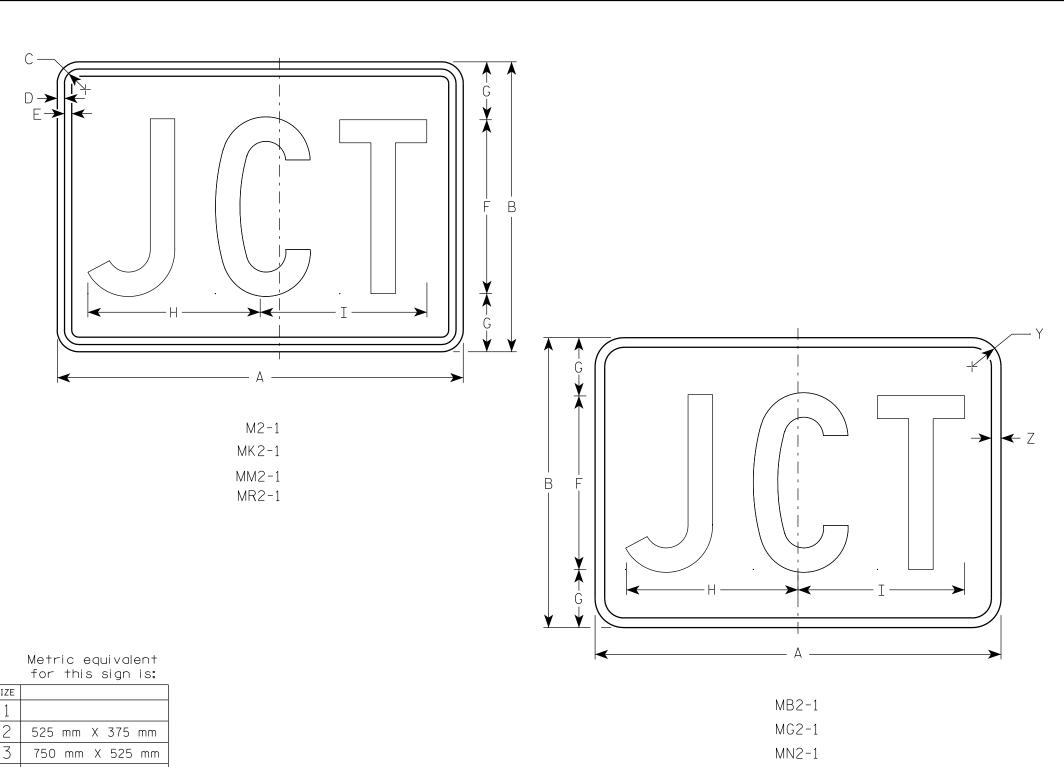

- 1. Sign is Type II See Note 5 reference WIS DOT Standard Specification for HIGHWAY and STRUCTURE CONSTRUCTION latest edition.
- 2. Color:

Background - See note 5 Message - See note 5

- 3. Message Series C
- 4. Corners may be square or rounded when base material is plywood but borders shall be rounded as shown. When base material is metal, the corners and borders shall be rounded.
- 5. M2-1 Background White Type H Reflective (Detour or temporary Signs - Reflective) Message - Black
 - MB2-1 Background Blue Message - White - Type H Reflective (Detour or temporary Signs - Reflective)
 - MG2-1 Background Green Message - White - Type H Reflective
 - MK2-1 Background Green Message - White - Type H Reflective
 - MM2-1 Background White Type H Reflective Message - Green
 - MN2-1 Background Brown Message - White - Type H Reflective
 - MR2-1 Background Brown Message - Yellow - Type H Reflective

750 mm X 525 mm 750 mm X 525 mm

PROJECT NO:

SIZE	Ξ.	А	В	С	D	E	F	G	Н	I	J	K	L	М	N	0	Р	Q	R	S	Т	U	٧	W	X	Y	Z	Area sq. ft.	Area m2
1																													
2	2	21	15	1 1/8	3/8	3/8	9	3	8 7/8	8 %																1 1/2	1/2	2.20	0.20
3	3	30	21	1 1/8	3/8	3/8	13	4	12 1/8	12 3/8																1 1/2	1/2	4.40	0.20
4	-	30	21	1 1/8	3/8	3/8	13	4	12 1/8	12 3/8																1 1/2	1/2	4.40	0.20
5	-	30	21	1 1/8	3/8	3/8	13	4	12 1/8	12 3/8																1 1/2	1/2	4.40	0.20

COUNTY:

STANDARD SIGN

M2 - 1

WISCONSIN DEPT OF TRANSPORTATION

APPROVED

 f_{or} State Traffic Engineer


DATE 3/16/10


PLATE NO. M2-1.10 SHEET NO:

WISDOT/CADDS SHEET 42


PLOT NAME : PLOT DATE: 16-MAR-2010 09:49 PLOT SCALE: 4.965868:1.000000 PLOT BY: dotsja


HWY:

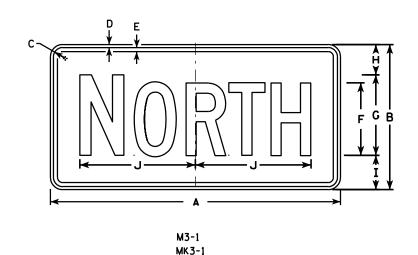

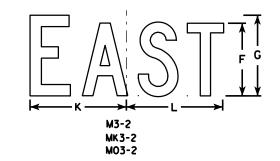



MO3-1

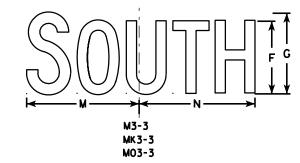

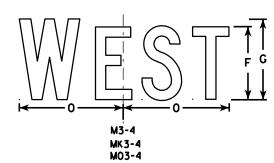


HWY:

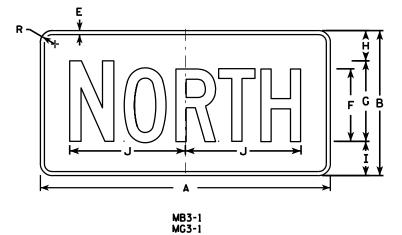


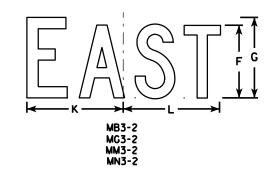

MM3-1

MN3-1

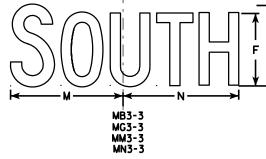

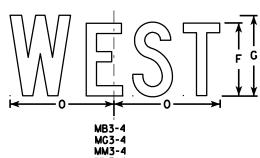

<u>NOTES</u>

- 1. All Signs Type II See Note 5 reference WIS DOT Standard Specification for HIGHWAY and STRUCTURE CONSTRUCTION latest edition.
- 2. Color:

Background - See note 5 Message - See note 5

- 3. Message Series C
- 4. Corners may be square or rounded when base material is plywood but borders shall be rounded as shown. When base material is metal, the corners and borders shall be rounded.
- 5. M3-1 thru M3-4 Background White Type H Reflective (Detour or temporary signs Reflective) Message Black
 - MB3-1 thru MB3-4 Background Blue Message - White - Type H Reflective (Detour or temporary signs - Reflective)
 - MG3-1 thru MG3-4 Background Green

 Message White Type H Reflective
 - MK3-1 thru MK3-4 Background Green

 Message White Type H Reflective
 - MM3-1 thru MM3-4 Background White Type H Reflective Message Green
 - MN3-1 thru MN3-4 Background Brown
 Message White Type H Reflective
 - M03-1 thru M03-4 Background Orange Reflective Message Black
- 6. Note the first letter of each direction is larger than the remainder of the message.

SIZE	Α	В	С	D	E	F	G	Н	I	J	K	L	М	N	0	Р	0	R	S	Т	כ	٧	W	X	Y	Z	Area sq. ft.
1																											
2	24	12	1 1/8	3/8	3⁄8	6	7	2 1/4	2 3/4	10 1/4	7 1/8	8 3/8	10 1/4	9 ¾	8 ¾			1 1/2									2.00
3	36	18	1 1/8	3/8	1/2	9	10	3 3/4	4 1/4	14 3/8	12	12 1/8	14	14 1/8	13			1 1/2									4.5
4	36	18	1 1/8	3/8	1/2	9	10	3 3/4	4 1/4	14 3/8	12	12 1/8	14	14 1/8	13			1 1/2									4.5
5	36	18	1 1/8	3/8	1/2	9	10	3 3/4	4 1/4	14 3/8	12	12 1/8	14	14 1/8	13			1 1/2									4.5

COUNTY:

STANDARD SIGNS M3-1 thur M3-4 SERIES

WISCONSIN DEPT OF TRANSPORTATION

APPROVED


For State Traffic Engineer

DATE 11/10/10 PLATE NO. M3-1.12

SHEET NO: E

PROJECT NO:

PLOT NAME :

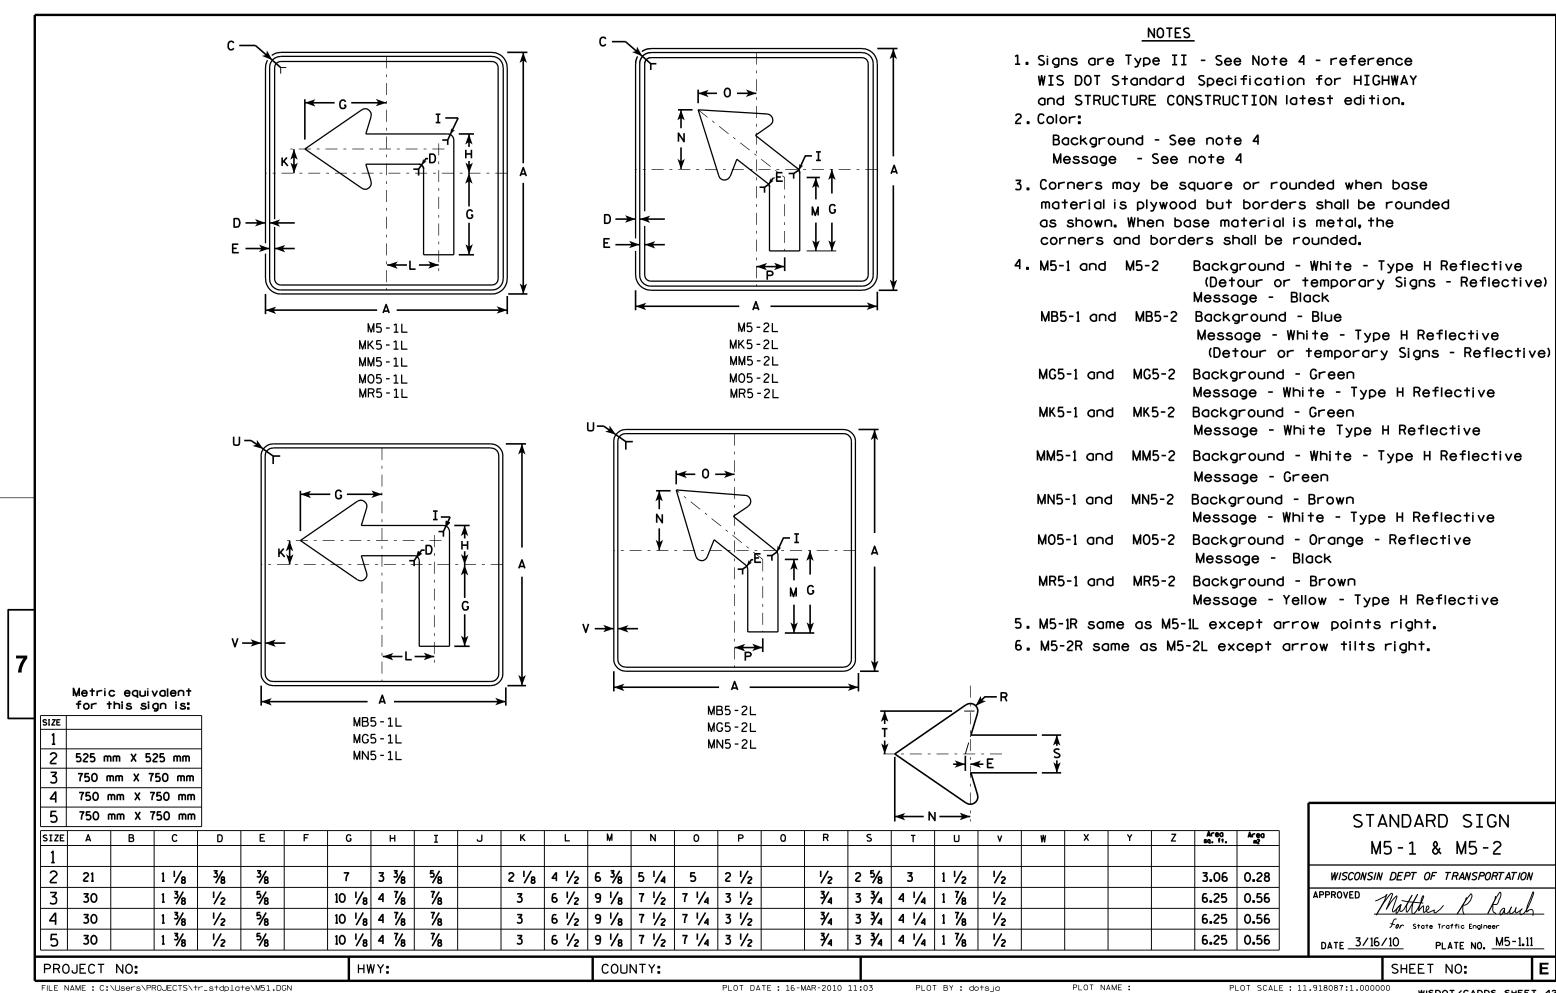


FILE NAME : C:\Users\PROJECTS\tr_stdplate\M51.DGN

PLOT DATE: 16-MAR-2010 11:03

PLOT NAME :

PLOT SCALE: 11.918087:1.000000

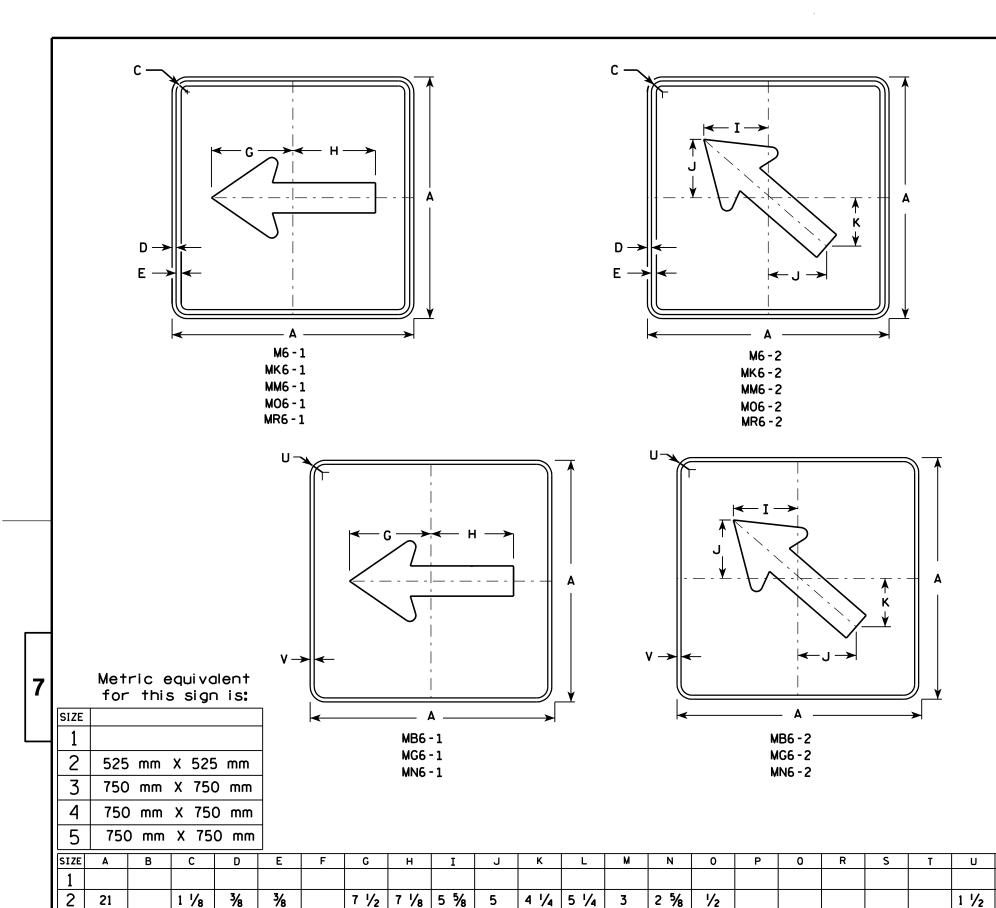

- 1. Signs are Type II See Note 4 reference WIS DOT Standard Specification for HIGHWAY and STRUCTURE CONSTRUCTION latest edition.
- 2. Color:

Background - See note 4 Message - See note 4

- 3. Corners may be square or rounded when base material is plywood but borders shall be rounded as shown. When base material is metal, the corners and borders shall be rounded.
- 4. M6-1 and M6-2 Background White Type H Reflective
 (Detour or temporary Signs Reflective)
 Message Black
 - MB6-1 and MB6-2 Background Blue

 Message White Type H Reflective

 (Detour or temporary Signs Reflective)
 - MG6-1 and MG6-2 Background Green

 Message White Type H Reflective
 - MK6-1 and MK6-2 Background Green

 Message White Type H Reflective
 - MM6-1 and MM6-2 Background White Type H Reflective Message Green
 - MN6-1 and MN6-2 Background Brown

 Message White Type H Reflective
- M06-1 and M06-2 Background Orange Reflective Message - Black

Area Area sq. ft. m2

6.25 0.56

0.28

0.56

0.56


3.06

6.25

6.25

MR6-1 and MR6-2 Background - Brown

Message - Yellow - Type H Reflective

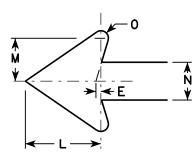

1/2

1/2

1/2

1 1/8

1 %

1 %

PLOT BY: dotsja

STANDARD	SIGN
M6-1 & N	16 - 2
SERIE	ES

WISCONSIN DEPT OF TRANSPORTATION

APPROVED

for State Traffic Engineer

DATE 3/16/10 PLATE NO. M6-1.12

SHEET NO:

FILE NAME : C:\Users\PROJECTS\tr_stdplate\M61.DGN

1 3/8

1 3/8

1 3/8

1/2

1/2

1/2

5/8

5/8

10 3/4 10 1/4 8

10 3/4 10 1/4 8

10 3/4 10 1/4 8

HWY:

7 1/4

7 1/4

7 1/4

6

6

7 1/2

7 1/2

4 1/4 3 3/4

4 1/4 3 3/4

COUNTY:

7 1/2 4 1/4 3 3/4

3

4

5

30

30

30

PROJECT NO:


PLOT DATE: 16-MAR-2010 09:58


3/4

3/4

PLOT NAME :

PLOT SCALE: 11.918087:1.000000

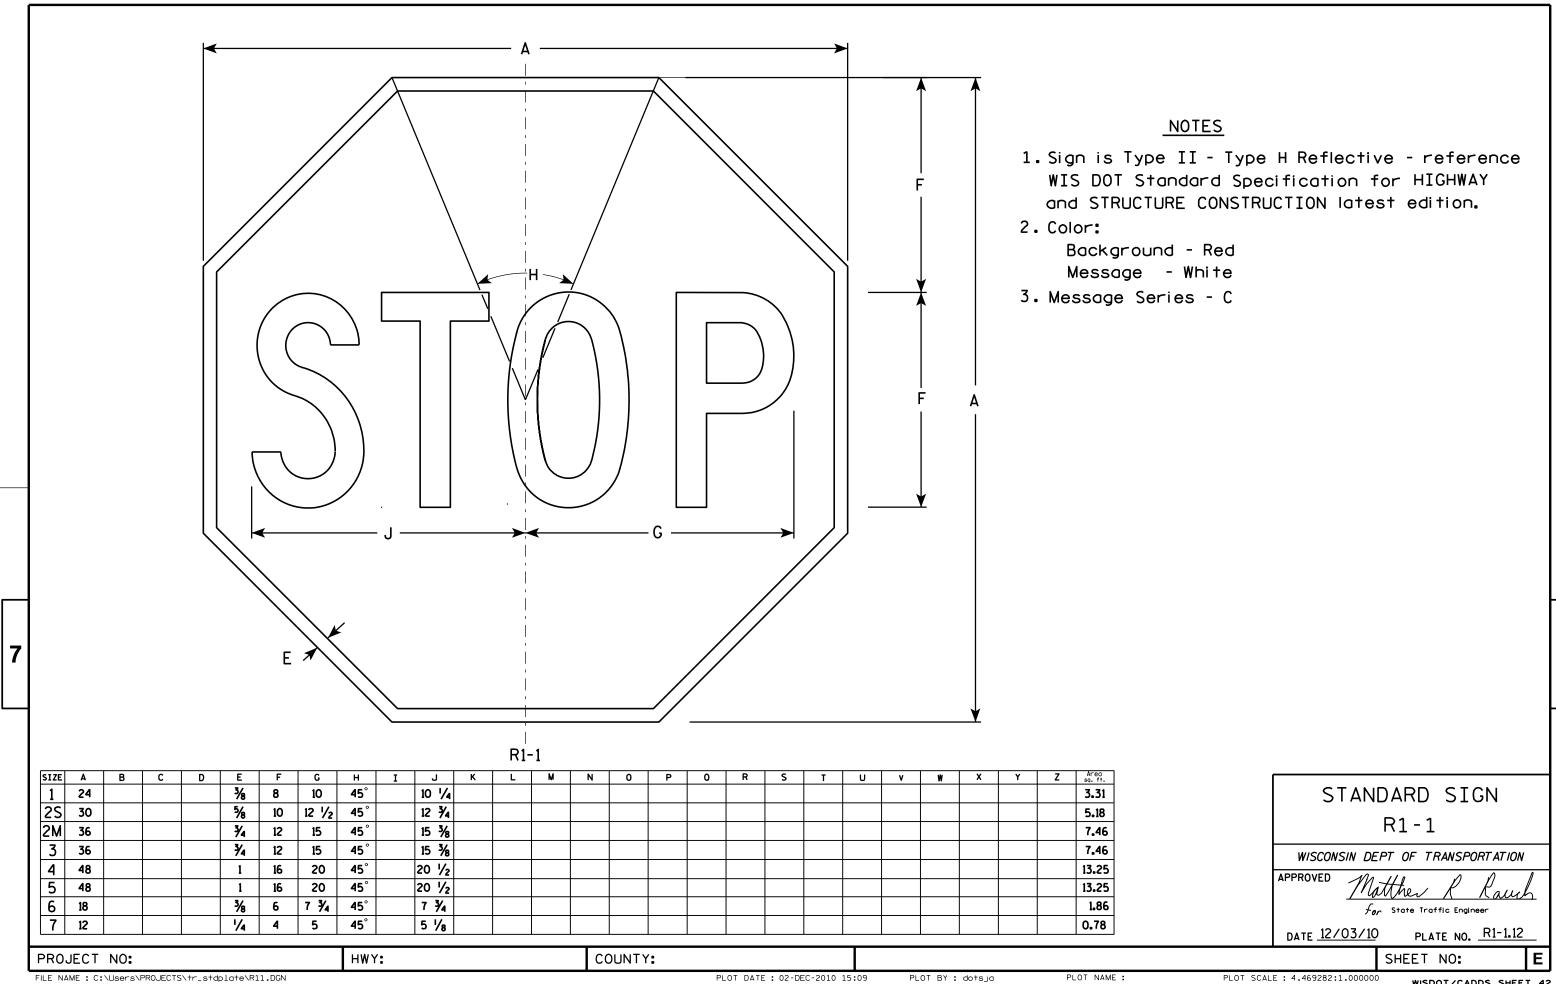

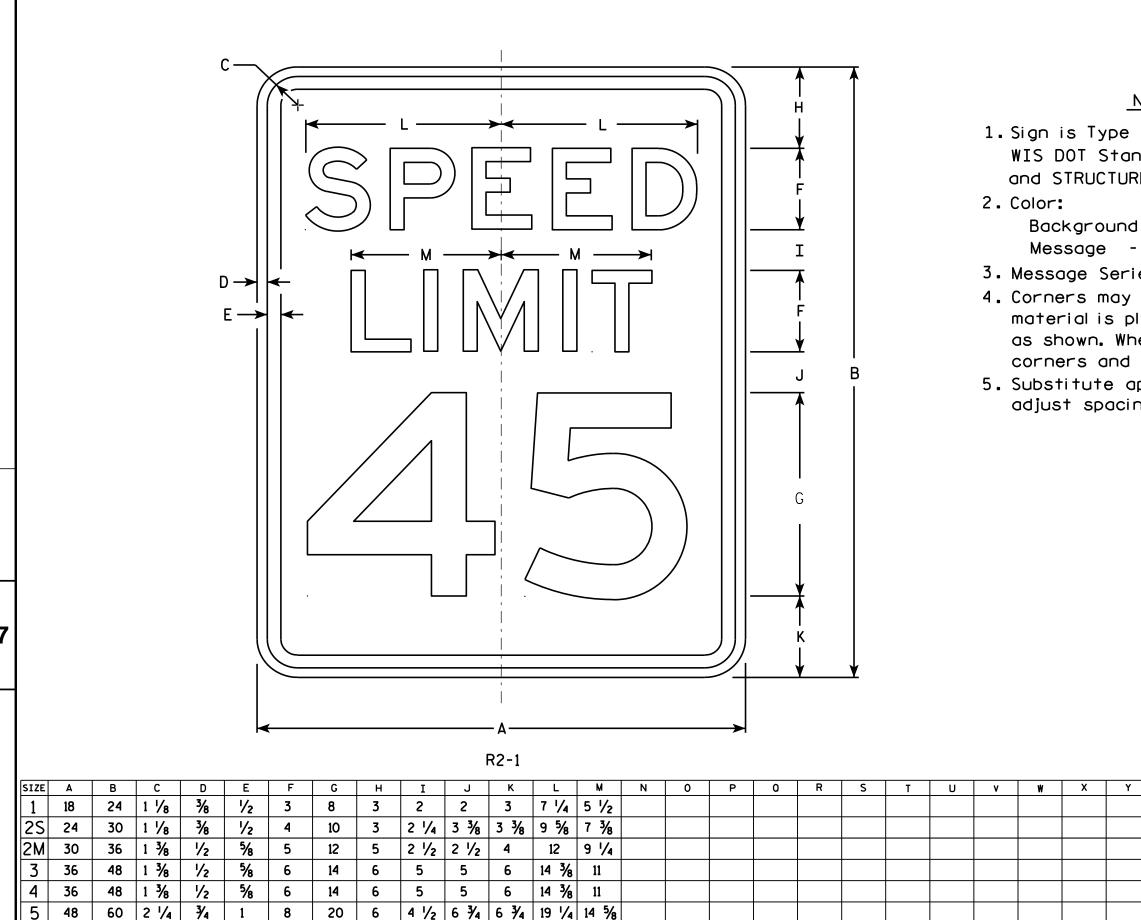

COUNTY:

NOTES

1. Sign is Type II - Type H Reflective - reference WIS DOT Standard Specification for HIGHWAY and STRUCTURE CONSTRUCTION latest edition.

Background - White Message - Black

- 3. Message Series E
- 4. Corners may be square or rounded when base material is plywood but borders shall be rounded as shown. When base material is metal. the corners and borders shall be rounded.
- 5. Substitute appropriate numerals and optically adjust spacing to achieve proper balance.

3.0

5.0

7.5

12.0

12.0

20.0

STANDARD SIGN R2-1

WISCONSIN DEPT OF TRANSPORTATION

APPROVED Matther R Raus

For State Traffic Engineer DATE <u>5/26/1</u>0 PLATE NO. R2-1.13

SHEET NO:

FILE NAME : C:\Users\PROJECTS\tr_stdplate\R21.DGN

PROJECT NO:

HWY:

PLOT DATE: 28-MAY-2010 08:32

PLOT BY : ditjph

PLOT NAME :

PLOT SCALE: 4.717577:1.000000


00 S3-1

NOTES

- 1. All Signs Type II Type F Reflective reference WIS DOT Standard Specification for HIGHWAY and STRUCTURE CONSTRUCTION latest edition.
- 2. Color:

Background - YELLOW-GREEN Message - BLACK except as noted Circles except PEDS- RED BACKGROUND

3. Corners may be square or rounded when base material is plywood but borders shall be rounded as shown. When base material is metal, the corners and borders shall be rounded.

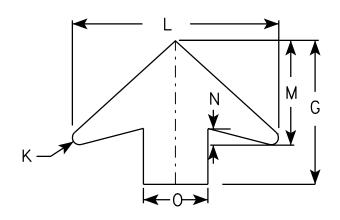

A DDOW	
ARROW	DETAIL

SIZE	Α	В	С	D	E	F	G	н	I	J	K	L	М	N	0	Р	0	R	S	Т	U	٧	W	Х	Y	Z	Area sq. ft.
1	30		1 3/8	1/2	5/8	6 1/4	11 1/4	12 1/2	5 1/4	5 ½	1/2	16	8	1 1/4	5	1 1/2		6 %	5 %	10 %							6.25
2	36		1 %	5/8	3/4	7 1/2	13 1/2	15 1/8	6 1/4	6 1/2	5/8	19 1/4	9 3/4	1 %	6	1 1/8		7 1/8	6 3/8	12 3/8							9.0
3	48		2 1/4	3/4	1	10	17 1/8	20 1/8	8 %	8 ¾	7 ⁄8	25 %	13	2	8	2 1/2		10 1/2	8 1/2	16 1/2							16.0
4	48		2 1/4	3/4	1	10	17 1/8	20 1/8	8 3/8	8 3/4	7/8	25 %	13	2	8	2 1/2		10 1/2	8 1/2	16 1/2							16.0
5																											

STANDARD SIGN S3-1

WISCONSIN DEPT OF TRANSPORTATION

APPROVED

for State Traffic Engineer DATE <u>6/8/10</u>

SHEET NO:

FILE NAME : C:\Users\PROJECTS\tr_stdplate\S31.DGN


PROJECT NO:

PLOT DATE: 08-JUN-2010 15:30

PLOT BY: ditjph

WISDOT/CADDS SHEET 42

PLATE NO. <u>\$3-1.6</u>

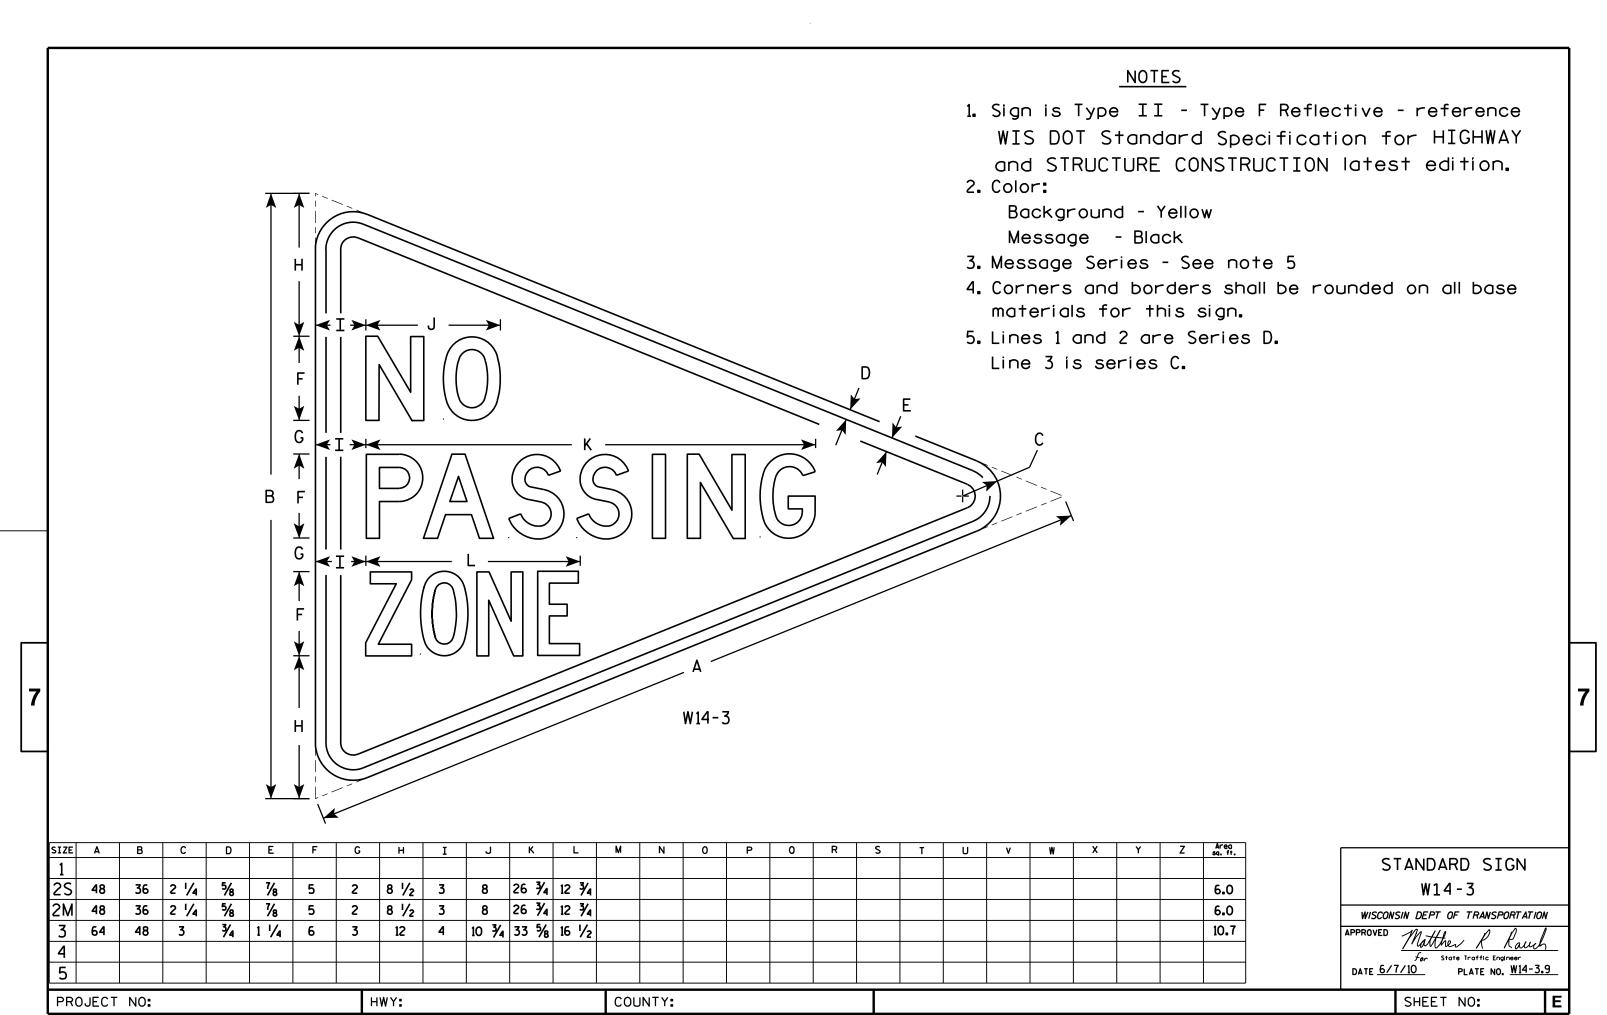

FILE NAME : C:\Users\PROJECTS\tr_stdplate\W143.DGN

PLOT DATE: 07-JUN-2010 13:11

PLOT BY : ditjph


PLOT NAME :

PLOT SCALE: 5.710749:1.000000

- 1. Sign is Type II Type F Reflective reference WIS DOT Standard Specification for HIGHWAY and STRUCTURE CONSTRUCTION latest edition.
- 2. Color:

Background - Yellow Message - Black

3. Corners may be square or rounded when base material is plywood but borders shall be rounded as shown. When base material is metal, the corners and borders shall be rounded.

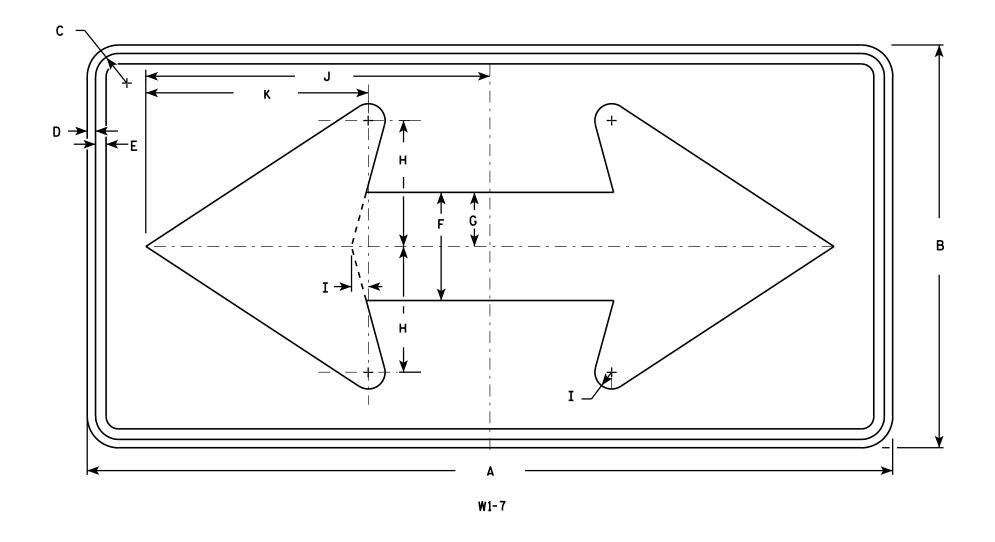

SIZE	Α	В	С	D	Е	F	G	Н	I	J	K	L	M	N	0	Р	0	R	S	T	-	٧	W	X	Y	Z	Areg sq. ft.
1	36	18	1 1/8	3⁄8	1/2	5	2 1/2	5 ¾	₹4	15 %	10 1/8																4.5
2S	48	24	1 3/8	1/2	5/8	6 1/2	3 1/4	7 1/2	1	20 1/2	13 1/4																8.0
2M	48	24	1 3/8	1/2	5/8	6 1/2	3 1/4	7 1/2	1	20 1/2	13 1/4																8.0
3	60	30	1 3/8	1/2	5/8	8	4	9 1/4	1 1/4	25	16 1/4																12.5
4	60	30	1 3/8	1/2	5/8	8	4	9 1/4	1 1/4	25 %	16 1/4																12.5
5	96	48	2 1/4	3/4	1	13	6 1/2	15	2	41	26 1/2																32.0

COUNTY:

STANDARD SIGN W1-7

WISCONSIN DEPT OF TRANSPORTATION

APPROVED Matthew R Raw

For State Traffic Engineer

DATE 6/7/10 PLATE NO. W1-7.7

SHEET NO:

FILE NAME : C:\Users\PROJECTS\tr_stdplate\W17.DGN

PROJECT NO:

HWY:

PLOT DATE: 07-JUN-2010 12:35

PLOT BY : ditjph

PLOT NAME :

PLOT SCALE: 5.720679:1.000000

- 1. Sign is Type II Type F Reflective reference WIS DOT Standard Specification for HIGHWAY and STRUCTURE CONSTRUCTION latest edition.
- 2. Color:

Background - Yellow Message - Black

3. Corners may be square or rounded when base material is plywood but borders shall be rounded as shown. When base material is metal, the corners and borders shall be rounded.

A G H H D E D D W2-2

SIZE	Α	В	С	D	E	F	G	Н	I	J	K	L	M	N	0	Р	0	R	S	T	U	٧	₩	Х	Y	Z	Areo sq. fi.
1	24		1 1/8	3∕8	1/2	20	2	4	10	8																	4.0
25	30		1 3/8	1/2	5/8	25	2 1/2	5	12 1/2	10																	6.25
2M	30		1 3/8	1/2	5/8	25	2 1/2	5	12 1/2	10																	6.25
3	36		1 %	5/8	3/4	30	3	6	15	12																	9.0
4	48		2 1/4	3/4	1	40	4	8	20	16																	16.0
5																											

COUNTY:

STANDARD SIGN W2-2

WISCONSIN DEPT OF TRANSPORTATION

APPROVED

Matthew R Rauch For State Traffic Engineer

DATE 5/29/12

PLATE NO. <u>W2-2.6</u>

SHEET NO:

FILE NAME : C:\CAEFiles\Projects\tr_stdplate\W22.DGN

PROJECT NO:


HWY:

PLOT DATE: 29-MAY-2012 10:18

PLOT BY: mscsja

PLOT NAME :

PLOT SCALE: 6.202372:1.000000

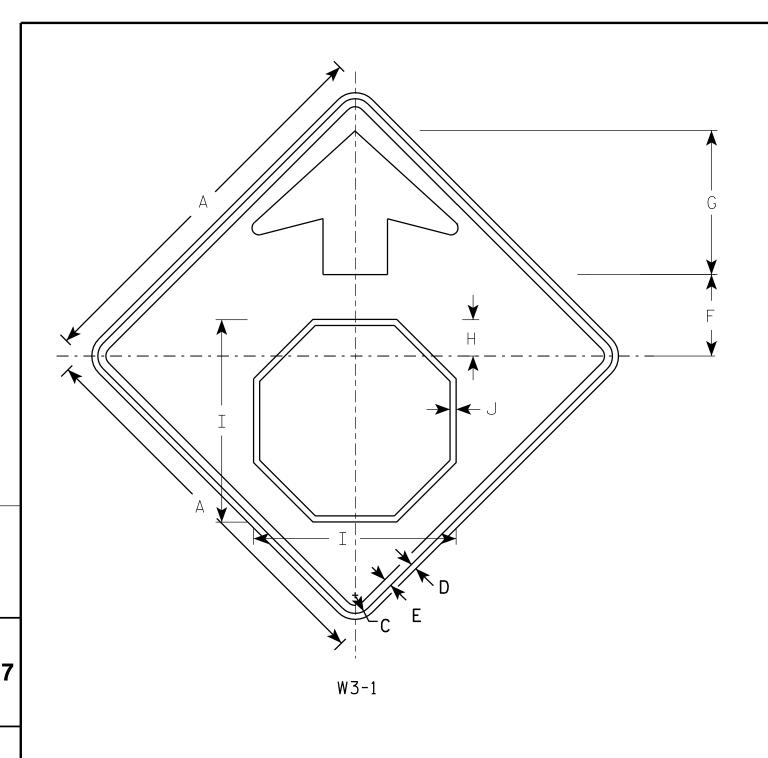


- 1. All Signs Type II Type F Reflective reference WIS DOT Standard Specification for HIGHWAY and STRUCTURE CONSTRUCTION latest edition.
- 2. Color:

Background - YELLOW

Arrow & Border - BLACK

Stop Symbol - WHITE BORDER ON RED BACKGROUND

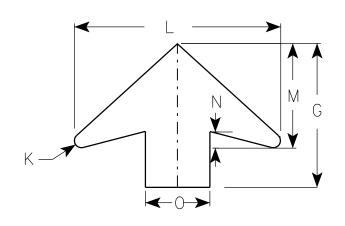

ARROW	DFTAII
AININOW	DLIAL

SIZE	Α	В	С	D	E	F	G	Н	I	J	K	L	М	N	0	P	0	R	S	Т	U	٧	W	X	Y	Z	Area sq. ft.
1	30		1 3/8	1/2	5/8	6 1/4	11 1/4	2 %	15 3/4	1/2	1/2	16	8	1 1/4	5												6.25
2S	36		1 %	5/8	3/4	7 1/2	13 1/2	3 1/2	19	5/8	5/8	19 1/4	9 3/4	1 %	6												9.0
2M	36		1 %	5/8	3/4	7 1/2	13 1/2	3 1/2	19	5/8	5/8	19 1/4	9 3/4	1 5/8	6												9.0
3	36		1 %	5/8	3/4	7 1/2	13 1/2	3 1/2	19	5/8	5/8	19 1/4	9 3/4	1 %	6												9.0
4	48		2 1/4	3/4	1	10	17 1/8	4 1/2	25 1/8	3/4	7 /8	25 %	13	2	8												16.0
5	48		2 1/4	3/4	1	10	17 1/8	4 1/2	25 1/8	3/4	½	25 %	13	2	8												16.0

STANDARD SIGN W3-1

WISCONSIN DEPT OF TRANSPORTATION

APPROVED Matthew R Ra

For State Traffic Engineer

DATE 6/7/10 PLATE NO. W3-1.12

SHEET NO:

FILE NAME : C:\Users\PROJECTS\tr_stdplate\W31.DGN

PROJECT NO:

- 1. Sign is Type II Type F Reflective reference WIS DOT Standard Specification for HIGHWAY and STRUCTURE CONSTRUCTION latest edition.
- 2. Color:

Background - Yellow Message - Black

- 3. Message Series B (See note 5)
- 4. Corners may be square or rounded when base material is plywood but borders shall be rounded as shown. When base material is metal, the corners and borders shall be rounded.
- 5. Highway Number usually Series D. Substitute appropriate numerals and optically adjust spacing to achieve proper balance.

	G + F + B + B
$\begin{array}{c ccccccccccccccccccccccccccccccccccc$	F G G
	
W4-4C	* VARIES

SIZE	Α	В	С	D	Е	F	G	Н	I	J	K	L	М	N	0	Р	0	R	S	Т	U	٧	W	X	Y	Z	Areg sq. fi.
1																											
2S	24	12	1 1/8	3/8	3/8	3	2 1/4	1 1/2	10 3/8	1 1/2	3 1/8	6 1/4	2 1/4	2 1/4	6 1/4												2.0
2M	24	12	1 1/8	3/8	3/8	3	2 1/4	1 1/2	10 3/8	1 1/2	3 1/8	6 1/4	2 1/4	2 1/4	6 1/4												2.0
3	36	15	1 1/8	3/8	1/2	4	2 5/8	1 3/4	13 1/8	2 3/8	4 1/4	8 3/8	3 1/8	3 1/8	8 %												3.75
4	42	18	1 1/8	3/8	1/2	5	3	2	17 1/4	3 1/8	5 1/8	10 1/2	3 %	3 %	10 3/8												5.25
5																											

COUNTY:

STANDARD SIGN W4-4C

WISCONSIN DEPT OF TRANSPORTATION

For State Traffic Engineer

DATE 03/12/13 PLATE NO. W4-4.2

SHEET NO:

FILE NAME : C:\CAEFiles\Projects\tr_stdplate\W44C.DGN

PROJECT NO:


HWY:

PLOT DATE: 12-MAR-2013 11:39

PLOT BY: mscsja

PLOT NAME :

PLOT SCALE: 5.334037:1.000000

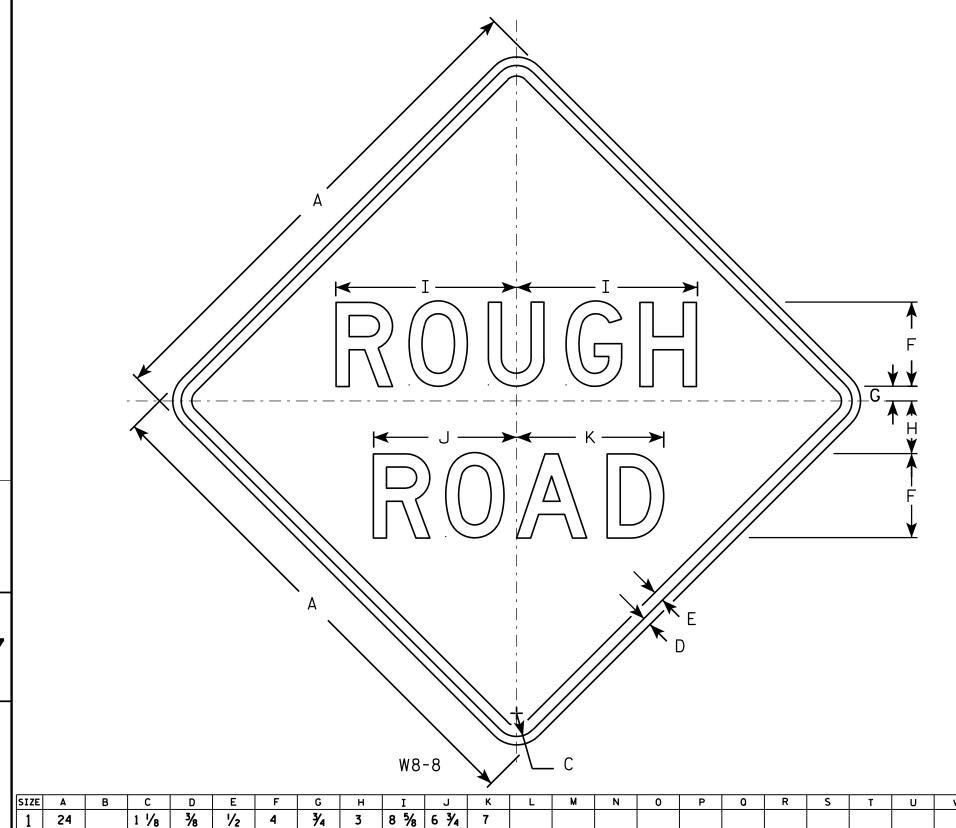

5 | 12 1/8 | 10 1/8 | 10 1/2

12 1/8 10 1/8 10 1/2

12 1/8 10 1/8 10 1/2

12 1/8 10 1/8 10 1/2

17 1/8 13 1/2 14

NOTES

- 1. Sign is Type II Type F Reflective reference WIS DOT Standard Specification for HIGHWAY and STRUCTURE CONSTRUCTION latest edition.
- 2. Color:

Background - Yellow Message - Black

- 3. Message Series D
- 4. Corners may be square or rounded when base material is plywood but borders shall be rounded as shown. When base material is metal, the corners and borders shall be rounded.

9.0 9.0 9.0 9.0 9.0 16.0 STANDARD SIGN W8-8

WISCONSIN DEPT OF TRANSPORTATION

APPROVED

Matthew

For State 1

DATE 03/14/13

PLATE NO. <u>W8-8.9</u>

SHEET NO:

FILE NAME : C:\CAEFiles\Projects\tr_stdplate\W88.DGN

1 1/8

1 %

1 %

2 1/4

36

36

36

36

48

PROJECT NO:

3

4

5

5/8

5/8

5/8

5/8

3/4

3/4

3/4

3/4

1 1/2

6

HWY:

PLOT DATE: 14-MAR-2013 09:59

COUNTY:

PLOT NAME :

PLOT BY: mscsja

PLOT SCALE: 5.706180:1.000000



Wisconsin Department of Transportation

Dedicated people creating transportation solutions through innovation and exceptional service.

http://www.dot.wisconsin.gov